

MWE - MINISTRY OF WATER AND ENVIRONMENT DIRECTORATE OF WATER DEVELOPMENT

RURAL WATER SUPPLY AND SANITATION DEPARTMENT

Bidding Document for the Procurement of Works

Consultancy Services for the Feability Study, Detailed Engineering Design and Construction Supervision of Solar Powered Piped Water Supply Systems and Sanitation Facilities In Refugee Settlements and Host Districts In West Nile and Northern Uganda

- LOT 1 - MADI OKOLLO, TEREGO AND MOYO DISTRICTS -

CONSTRUCTION OF GWERE RGC WATER SUPPLY AND SANITATION SYSTEM

VOLUME IV - BOOK OF DRAWINGS

September, 2023



List of Drawings				
Drg No	Drawing Tittle			
General Layout				
MWE/GWE/0.0.0	Transmission and Distribution Network			
Water Treatment	Plant: Water Treatment Plant			
MWE/GWE/1.0.1	General Site Layout			
MWE/GWE/1.0.2	Hydraulic Profile			
MWE/GWE/1.0.3	Plan view (DWD 89709)			
MWE/GWE/1.0.4	Section view (DWD 89709)			
MWE/GWE/1.0.5	Plan view (BH2)			
MWE/GWE/1.0.6	Section view (BH2)			
MWE/GWE/1.0.7	Riser main details			
Water Treatment	Plant: Aerator and Sedimentation Tank			
MWE/GWE/1.1.1	Top Plan			
MWE/GWE/1.1.2	Sectional Plan			
MWE/GWE/1.1.3	Section A-A			
MWE/GWE/1.1.4	Section B-B_C-C and Section D-D			
Water Treatment	Plant: Rapid Gravity Filters			
MWE/GWE/1.2.1	Top Plan			
MWE/GWE/1.2.2	Sectional Plan			
MWE/GWE/1.2.3	Section A-A			
MWE/GWE/1.2.4	Section B-B			
MWE/GWE/1.2.5	Section C-C			
Water Treatment	Plant: Treated Water Tank and Pump House			
MWE/GWE/1.3.1	Sectional Plan			
MWE/GWE/1.3.2	Section A-A			
MWE/GWE/1.3.3	Section B-B and Section B-B			
Water Treatment	Plant: Chemical House and Office Block			
MWE/GWE/1.4.1	Ground Floor Plan			
MWE/GWE/1.4.2	Roof Plan			
MWE/GWE/1.4.3	Section S[01]			
MWE/GWE/1.4.4	Elevation_[L01] and Elevation L[02]			
MWE/GWE/1.4.5	Elevation_[L03] and Elevation L[04]			
Water Treatment	Plant: 62.3m³ Backwash and Service Tank			
MWE/GWE/1.5.1	Top Plan			
MWE/GWE/1.5.2	Sections and Details			
MWE/GWE/1.5.3	Foundation layout and Details			
Water Treatment	Plant: Staff House			
MWE/GWE/1.6.1	Ground Floor Plan			
MWE/GWE/1.6.2	Roof Plan			
MWE/GWE/1.6.3	Section S[01]			
MWE/GWE/1.6.4	Elevation_[L01] and Elevation L[02]			
MWE/GWE/1.6.5	Elevation_[L03] and Elevation L[04]			
Water Treatment	Plant: Guard House			
MWE/GWE/1.7.1	Plan and Sections			
Water Treatment F	Plant: Manhole Details			
MWE/GWE/1.8.1	Plan and Sections			
Solar Drawings				
MWE/GWE/1.9.1	DWD BH2 Solar Panel Array (Layout & Elevations)			

List of Drawings				
Drg No	Drawing Tittle			
MWE/GWE/1.9.2	DWD BH2 Solar Panel Array (Electrical layout)			
MWE/GWE/1.9.3	DWD 89709 Solar Panel Array(Layout &Elevations			
MWE/GWE/1.9.4	DWD 89709 Solar Panel Array(Electrical layout)			
MWE/GWE/1.9.5	WTP Solar Panel Array(Layout &Elevations)			
MWE/GWE/1.9.6	WTP Solar Panel Array(Electrical layout)			
Transmission Mai				
MWE/GWE/2.1.1	Transmission Mains (CH 0+000.00 - 0+600.00)			
MWE/GWE/2.1.2	Transmission Mains (CH 0+600.00 - 1+200.00)			
MWE/GWE/2.1.3	Transmission Mains (CH 1+200.00 - 1+800.00)			
MWE/GWE/2.1.4	Transmission Mains (CH 1+800.00 - 2+400.00)			
MWE/GWE/2.1.5	Transmission Mains (CH 2+400.00 - 2+910.96)			
Transmission Mai	,			
MWE/GWE/2.2.1	Transmssion Main 01 (CH 0+000.00 - 0+600.00)			
MWE/GWE/2.2.2	Transmssion Main 01 (CH 0+600.00 - 1+200.00)			
MWE/GWE/2.2.3	Transmssion Main 01 (CH 1+200.00 - 1+800.00)			
MWE/GWE/2.2.4	Transmssion Main 01 (CH 1+800.00 - 1+874.10)			
Lefori Reservoir T	,			
MWE/GWE/3.1.1	Site Layout			
MWE/GWE/3.1.2	Top Plan			
MWE/GWE/3.1.3	Section A-A			
MWE/GWE/3.1.4	Section B-B			
MWE/GWE/3.1.5	Foundation Details			
General Layout - D	Distribution Mains			
MWE/GWE/4.0.0	General Overview			
Distribution Line (
MWE/GWE/4.1.1	Distribution Line 01 (CH 0+000.00 - 0+600.00)			
MWE/GWE/4.1.2	Distribution Line 01 (CH 0+600.00 - 1+200.00)			
MWE/GWE/4.1.3	Distribution Line 01 (CH 1+200.00 - 1+800.00)			
MWE/GWE/4.1.4	Distribution Line 01 (CH 1+800.00 - 2+400.00)			
MWE/GWE/4.1.5	Distribution Line 01 (CH 2+400.00 - 3+000.00)			
MWE/GWE/4.1.6	Distribution Line 01 (CH 3+000.00 - 3+600.00)			
MWE/GWE/4.1.7	Distribution Line 01 (CH 3+600.00 - 4+200.00)			
MWE/GWE/4.1.8	Distribution Line 01 (CH 4+200.00 - 4+800.00)			
MWE/GWE/4.1.9	Distribution Line 01 (CH 4+800.00 - 5+400.00)			
MWE/GWE/4.1.10	Distribution Line 01 (CH 5+400.00 - 6+000.00)			
MWE/GWE/4.1.11	Distribution Line 01 (CH 6+000.00 - 6+600.00)			
MWE/GWE/4.1.11	Distribution Line 01 (CH 6+600.00 - 7+200.00)			
MWE/GWE/4.1.13	Distribution Line 01 (CH 7+200.00 - 7+200.00)			
MWE/GWE/4.1.13	,			
	Distribution Line 01 (CH 7+800.00 - 8+400.00)			
MWE/GWE/4.1.15	Distribution Line 01 (CH 8+400.00 - 9+000.00)			
MWE/GWE/4.1.16	Distribution Line 01 (CH 9+000.00 - 9+600.00)			
MWE/GWE/4.1.17	Distribution Line 01 (CH 9+600.00 - 10+200.00)			
MWE/GWE/4.1.18	Distribution Line 01 (CH 10+200.00 - 10+800.00)			

AMENDMENTS				
No	Date	Revision		
1	4.8.2024	Draft Design		

- 1. All dimensions are in metres unless stated otherwise.
- 2. All levels are in metres above sea level.
- 3. For Site location see Dwg. MWE/GWE/0.0.0
- 4. For Node details, see Dwg. MWE/GWE/5.0.0
- All valves, hydrants and washout locations are identified by marker post in positions.

LEGEND





GOVERNMENT OF UGANDA

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MINISTRY OF WATER AND ENVIRONMENT DIRECTORATE OF WATER DEVELOPMENT (DWD) RURAL WATER SUPPLY AND SANITATION DEPARTMENT Plot 3 - 7 Kabalega Crescent Road, Luzira, Box 20026 Kampala Tel : +256 417 889 400, Email: mwe@mwe.go.ug Website: www.mwe.go.ug

PROJECT

Consultancy Services for the Feability Study, Detailed Engineering Design and Construction Supervision of Solar Powered Piped Water Supply Systems and Sanitation Facilities In Refugee Settlements and Host Districts In West Nile and Northern Uganda

- LOT 1 - MADI OKOLLO, TEREGO AND MOYO DISTRICTS -

CONSTRUCTION OF GWERE RGC WATER SUPPLY AND SANITATION SYSTEM

Consultant:



Corporate Headquarter 10 Philpot Lane, 1st Floor, London EC3M 8AA, United Kingdom

Drawing Title:

DRAWING LIST Drawing List

	Scale:	Designed:	O.R Daniel		
		Drawn:	P.S Eyamu		
Date:	Date:	Checked:	O.R Daniel		
	Dec-2022	Approved:	O.R Daniel		
	ENGINEERING DESIGN DRAWING				

Drg No: MWE/GWE/ Cad file No WSS<22_11>

List of Drawings				
Dwg No	Drawing Tittle			
Distribution Line 0)1			
MWE/GWE/4.1.19	Distribution Line 01 (CH 10+800.00 - 11+400.00)			
MWE/GWE/4.1.20	Distribution Line 01 (CH 11+400.00 - 12+000.00)			
MWE/GWE/4.1.21	Distribution Line 01 (CH 12+000.00 - 12+090.84)			
Distribution Line 1	A			
MWE/GWE/4.1a.1	Distribution Line 1A (CH 0+000.00 - 0+600.00)			
MWE/GWE/4.1a.2	Distribution Line 1A (CH 0+600.00 - 1+200.00)			
MWE/GWE/4.1a.3	Distribution Line 1A (CH 1+200.00 - 1+800.00)			
MWE/GWE/4.1a.4	Distribution Line 1A (CH 1+800.00 - 2+400.00)			
MWE/GWE/4.1a.5	Distribution Line 1A (CH 2+400.00 - 3+000.00)			
MWE/GWE/4.1a.6	Distribution Line 1A (CH 3+000.00 - 3+244.93)			
Distribution Line 0	02			
MWE/GWE/4.2.1	Distribution Line 02 (CH 0+000.00 - 0+600.00)			
MWE/GWE/4.2.2	Distribution Line 02 (CH 0+600.00 - 1+200.00)			
MWE/GWE/4.2.3	Distribution Line 02 (CH 1+200.00 - 1+800.00)			
MWE/GWE/4.2.4	Distribution Line 02 (CH 1+800.00 - 1+871.76)			
Distribution Line 0	03			
MWE/GWE/4.3.1	Distribution Line 03 (CH 0+000.00 - 0+600.00)			
MWE/GWE/4.3.2	Distribution Line 03 (CH 0+600.00 - 1+200.00)			
MWE/GWE/4.3.3	Distribution Line 03 (CH 1+200.00 - 1+800.00)			
MWE/GWE/4.3.4	Distribution Line 03 (CH 1+800.00 - 2+400.00)			
MWE/GWE/4.3.5	Distribution Line 03 (CH 2+400.00 - 2+710.55)			
Distribution Line 0)4			
MWE/GWE/4.4.1	Distribution Line 04 (CH 0+000.00 - 0+600.00)			
MWE/GWE/4.4.2	Distribution Line 04 (CH 0+600.00 - 1+200.00)			
MWE/GWE/4.4.3	Distribution Line 04 (CH 1+200.00 - 1+793.17)			
Distribution Line 0)5			
MWE/GWE/4.5.1	Distribution Line 05 (CH 0+000.00 - 0+600.00)			
MWE/GWE/4.5.2	Distribution Line 05 (CH 0+600.00 - 0+709.38)			
Distribution Line 0	06			
MWE/GWE/4.6.1	Distribution Line 06 (CH 0+000.00 - 0+600.00)			
MWE/GWE/4.6.2	Distribution Line 06 (CH 0+600.00 - 1+200.00)			
MWE/GWE/4.6.3	Distribution Line 06 (CH 1+200.00 - 1+392.35)			
Distribution Line 0)7			
MWE/GWE/4.7.1	Distribution Line 07 (CH 0+000.00 - 0+600.00)			
MWE/GWE/4.7.2	Distribution Line 07 (CH 0+600.00 - 1+200.00)			
MWE/GWE/4.7.3	Distribution Line 07 (CH 1+200.00 - 1+800.00)			
MWE/GWE/4.7.4	Distribution Line 07 (CH 1+800.00 - 2+400.00)			
MWE/GWE/4.7.5	Distribution Line 07 (CH 2+400.00 - 2+998.02)			

List of Drawings				
Dwg No	Drawing Tittle			
Distribution Line 0	8			
MWE/GWE/4.8.1	Distribution Line 08 (CH 0+000.00 - 0+600.00) (1)			
MWE/GWE/4.8.2	Distribution Line 08 (CH 0+600.00 - 1+013.01)			
Distribution Line 0	9			
MWE/GWE/4.9.1	Distribution Line 09 (CH 0+000.00 - 0+600.00)			
MWE/GWE/4.9.2	Distribution Line 09 (CH 0+600.00 - 0+902.63)			
Distribution Line 1	0			
MWE/GWE/4.10.1	Distribution Line 10 (CH 0+000.00 - 0+600.00)			
MWE/GWE/4.10.2	Distribution Line 10 (CH 0+600.00 - 0+670.80)			
Distribution Line 1	1			
MWE/GWE/4.11.1	Distribution Line 11 (CH 0+000.00 - 0+601.01)			
Distribution Line 1	2			
MWE/GWE/4.12.1	Distribution Line 12 (CH 0+000.00 - 0+600.00)			
MWE/GWE/4.12.2	Distribution Line 12 (CH 0+600.00 - 1+200.00)			
MWE/GWE/4.12.3	Distribution Line 12 (CH 1+200.00 - 1+475.96)			
Distribution Line 1	3			
MWE/GWE/4.13.1	Distribution Line 13 (CH 0+000.00 - 0+600.00)			
MWE/GWE/4.13.2	Distribution Line 13 (CH 0+600.00 - 1+200.00)			
MWE/GWE/4.13.3	Distribution Line 13 (CH 1+200.00 - 1+800.00)			
MWE/GWE/4.13.4	Distribution Line 13 (CH 1+800.00 - 2+400.00)			
MWE/GWE/4.13.5	Distribution Line 13 (CH 2+400.00 - 3+000.00)			
MWE/GWE/4.13.6	Distribution Line 13 (CH 3+000.00 - 3+467.73)			
Distribution Line 1	4			
MWE/GWE/4.14.1	Distribution Line 14 (CH 0+000.00 - 0+600.00)			
Distribution Line 1	5			
MWE/GWE/4.15.1	Distribution Line 15 (CH 0+000.00 - 0+600.00)			
MWE/GWE/4.15.2	Distribution Line 15 (CH 0+600.00 - 0+961.96)			
Distribution Line 1	6			
MWE/GWE/4.16.1	Distribution Line 16 (CH 0+000.00 - 0+600.00)			
MWE/GWE/4.16.2	Distribution Line 16 (CH 0+600.00 - 1+200.00)			
MWE/GWE/4.16.3	Distribution Line 16 (CH 1+200.00 - 1+725.00)			
Distribution Line 1	7			
MWE/GWE/4.17.1	Distribution Line 17 (CH 0+000.00 - 0+600.00)			
MWE/GWE/4.17.2	Distribution Line 17 (CH 0+600.00 - 1+123.70)			
Distribution Line 1	8			
MWE/GWE/4.18.1	Distribution Line 18 (CH 0+000.00 - 0+600.00)			
MWE/GWE/4.18.2	Distribution Line 18 (CH 0+600.00 - 0+816.29)			

AM	AMENDMENTS				
No	Date	Revision			
1	7.30.2023	Draft Design			

- 1. All dimensions are in metres unless stated otherwise.
- 2. All levels are in metres above sea level.
- 3. For Site location see Dwg. MWE/GWE/0.0.0
- 4. For Node details, see Dwg. MWE/GWE/5.0.0
- 5. All valves, hydrants and washout locations are identified by marker post in positions.

LEGEND



CLIENT M D

MINISTRY OF WATER AND ENVIRONMENT DIRECTORATE OF WATER DEVELOPMENT (DWD) RURAL WATER SUPPLY AND SANITATION DEPARTMENT Plot 3 - 7 Kabalega Crescent Road, Luzira, Box 20026 Kampala Tel : +256 417 889 400, Email: mwe@mwe go.ug Website: www.mwe.go.ug

ROJECT

Consultancy Services for the Feability Study, Detailed Engineering Design and Construction Supervision of Solar Powered Piped Water Supply Systems and Sanitation Facilities In Refugee Settlements and Host Districts In West Nile and Northern Uganda

- LOT 1 - MADI OKOLLO, TEREGO AND MOYO DISTRICTS -

CONSTRUCTION OF GWERE RGC WATER SUPPLY AND SANITATION SYSTEM

Consultant:



Corporate Headquarter 10 Philpot Lane, 1st Floor, London EC3M 8AA, United Kingdom

Cad file No WSS<22_11>

Drawing Title:

Drg No: MWE/GWE/

DRAWING LIST Drawing List (2)

ı	Scale:	Designed:	O.R Daniel
ı		Drawn:	P.S Eyamu
ı	Date:	Checked:	O.R Daniel
ı	Dec-2022	Approved:	O.R Daniel
ı	ENGINEERII	NG DESIGN	DRAWING

List of Drawings Dwg No Drawing Tittle				
Distribution Line 19				
MWE/GWE/4.19.1	Distribution Line 19 (CH 0+000.00 - 0+600.00)			
MWE/GWE/4.19.2	Distribution Line 19 (CH 0+600.00 - 0+000.00)			
Distribution Line 20	,			
MWE/GWE/4.20.1	Distribution Line 20 (CH 0+000.00 - 0+600.00)			
MWE/GWE/4.20.2	Distribution Line 20 (CH 0+600.00 - 0+938.11)			
Distribution Line 21	· · · · · · · · · · · · · · · · · · ·			
MWE/GWE/4.21.1	Distribution Line 21 (CH 0+000.00 - 0+600.00)			
MWE/GWE/4.21.2	Distribution Line 21 (CH 0+600.00 - 0+778.39)			
Distribution Mains	· · · · · · · · · · · · · · · · · · ·			
MWE/GWE/5.0.1	Node Details A			
MWE/GWE/5.0.2	Node Details B			
MWE/GWE/5.0.3	Node Details C			
MWE/GWE/5.0.4	Node Details D			
MWE/GWE/5.0.5	Node Details E			
MWE/GWE/5.0.6	Node Details F			
Typical Sand Post	•			
MWE/GWE/5.1.1	Plan and Sections			
Typical Yard Conne	ection			
MWE/GWE/5.2.1	Sectional Elevation			
Water Office Block				
MWE/GWE/6.1.1	Ground Floor Plan			
MWE/GWE/6.1.2	Roof Plan			
MWE/GWE/6.1.3	Section S[01]			
MWE/GWE/6.1.4	Elevations			
School Toilets - Bo	- ,			
MWE/GWE/7.1.1	Boys Toilet			
MWE/GWE/7.1.2	Girls Toilet			
MWE/GWE/7.1.3	Toilets-Details			
MWE/GWE/7.1.4	Incinerator			
6 Stanced VIP Publ				
MWE/GWE/7.2.1	Ground Floor Plan			
MWE/GWE/7.2.2	Roof Plan			
MWE/GWE/7.2.3	Section D_D			
MWE/GWE/7.2.4	Section E_E and Section F_F			
6 Stances Waterbo				
MWE/GWE/7.3.1	Ground Floor Plan			
MWE/GWE/7.3.2	Section L[S-01]			
MWE/GWE/7.3.3	Elevations			

List of Drawings			₩	ENDMEN	
5 11			No 1	Date 7.30.2023	Revision Draft Design
Dwg No	Drawing Tittle		Ľ	7.50.2025	Drait Design
MWE/GWE/7.3.4	Electrical Installation				
MWE/GWE/7.3.5	Plumbing Layout				
Standard Drawings				TES	
MWE/GWE/SD100	General Notes		ll .		ons are in metres unless stated otherwise. re in metres above sea level.
MWE/GWE/SD101	Sign Post		II .		eation see Dwg. MWE/GWE/0.0.0 letails, see Dwg. MWE/GWE/5.0.0
MWE/GWE/SD104	Fence & Gate		5.		hydrants and washout locations are y marker post in positions.
MWE/GWE/SD107E	Ladder Type A		LE	GEND	, ,
MWE/GWE/SD111A	Gate Valve I				
MWE/GWE/SD112A	Air Valve Pipework				
MWE/GWE/SD112B	Air Valve Chamber				
MWE/GWE/SD114A	Washout Pipe details				
MWE/GWE/SD114B	Washout Chamber				
MWE/GWE/SD116	Outfall				
MWE/GWE/SD117	Marker Post				
MWE/GWE/SD118A	Anchor blocks for Tapers				
MWE/GWE/SD118B	Anchor blocks for Bends 1				
MWE/GWE/SD118C	Anchor blocks for Bends 2				
MWE/GWE/SD122	Surface Box	F	CO-FI	NANCE BY:	
MWE/GWE/SD135A	Washout GV Chamber		8	THE	WORLD BANK AND
MWE/GWE/SD135C	Washout GV Roof Slab		B	y	
MWE/GWE/SD137	Flexible pipe joint details	-			GOVERNMENT OF UGAND
MWE/GWE/SD204	Pipe Bedding		CLIE	MINI	ISTRY OF WATER AND ENVIRONMENT
MWE/GWE/SD220	Pipe Supports (R.C Details)			RUF	AAL WATER SEVELUPHINENT (WWD) AAL WATER SUPPLY AND SANITATION DEPARTMENT 13 - 7 Kabalega Crescent Road, Luzira, Box 20026 Kampala Tel : +256 417 889 400, Email mwe@mwe.go.ug Website: www.mwe.go.ug
			Pow	Consultancy ngineering I vered Piped In Refu DT 1 - MADI	y Services for the Feability Study, Detailed Design and Construction Supervision of Solar Water Supply Systems and Sanitation Facilitie ugee Settlements and Host Districts In West Nile and Northern Uganda OKOLLO, TEREGO AND MOYO DISTRICTS CTION OF GWERE RGC WATER
		-	Со	nsultant	Y AND SANITATION SYSTEM
				€ ℃ S	Corporate Headquarter 10 Philpot Lane, 1st Floor, London EC3M 8AA, United Kingdom
		ļ	Dra	awing Tit	le: DRAWING LIST Drawing List (3)

Designed: O.R Daniel
Drawn: P.S Eyamu

Checked: O.R Daniel
Approved: O.R Daniel

ENGINEERING DESIGN DRAWING

Drg No: MWE/GWE/ Cad file No WSS<22_11>


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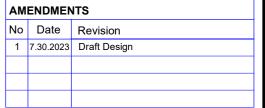
Date:

Dec-2022

GENERAL LAYOUT

(Transmission and Distribution Network)



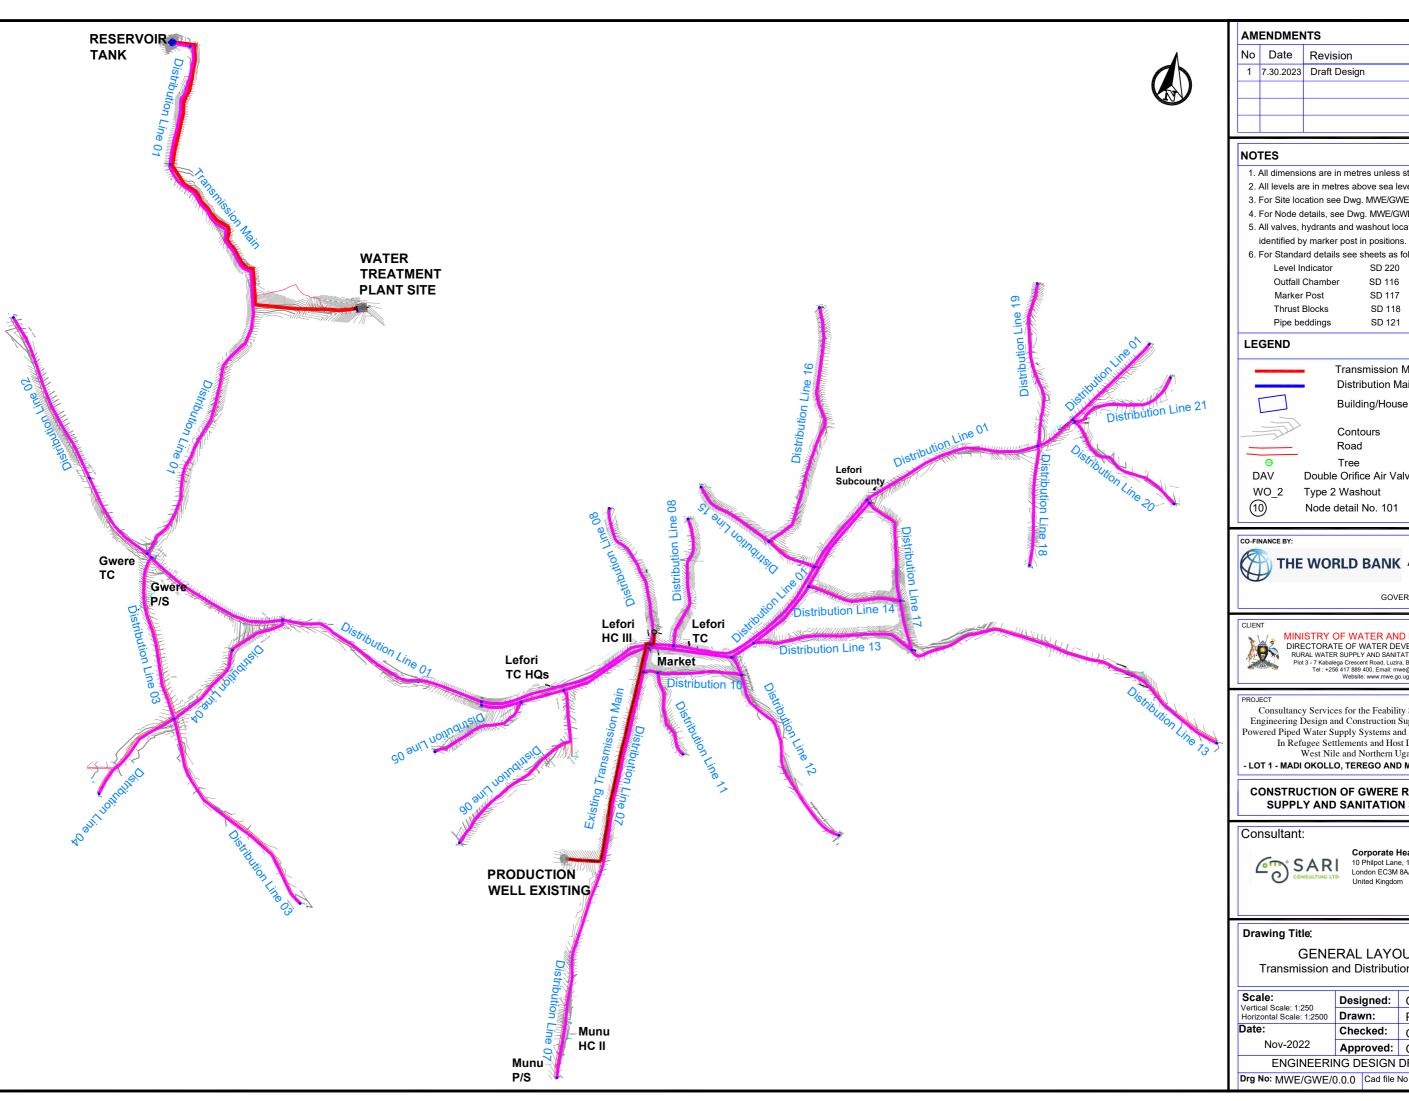

- 1. All dimensions are in metres unless stated otherwise.
- 2. All levels are in metres above sea level.
- 3. For Site location see Dwg. MWE/GWE/0.0.0
- 4. For Node details, see Dwg. MWE/GWE/5.0.0 5. All valves, hydrants and washout locations are
- 6. For Standard details see sheets as follows

Level Indicator SD 220 SD 116 Outfall Chamber Marker Post SD 117 Thrust Blocks SD 118

SD 121 Pipe beddings

Transmission Mains Distribution Mains Building/House

Contours Road

Double Orifice Air Valve

Type 2 Washout Node detail No. 101

Tree



GOVERNMENT OF UGANDA



MINISTRY OF WATER AND ENVIRONMENT
DIRECTORATE OF WATER DEVELOPMENT (DWD)
RURAL WATER SUPPLY AND SANITATION DEPARTMENT
Plot 3 - 7 Kabalega Crescent Road, Luzira, Box 20026 Kampala
Tel: +256 417 889 400, Email: mwe@mwe.go.ug
Website: www.mwe.go.ug

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CONSTRUCTION OF GWERE RGC WATER SUPPLY AND SANITATION SYSTEM

Consultant:



Corporate Headquarter 10 Philpot Lane, 1st Floor, London EC3M 8AA,

GENERAL LAYOUT Transmission and Distribution Network


Designed: O.R Daniel Vertical Scale: 1:250
Horizontal Scale: 1:2500

Drawn: P.S Eyamu Checked: O.R Daniel


> Approved: O.R Daniel ENGINEERING DESIGN DRAWING

Drg No: MWE/GWE/0.0.0 | Cad file No WSS<22_11>

WATER TREATMENT PLANT

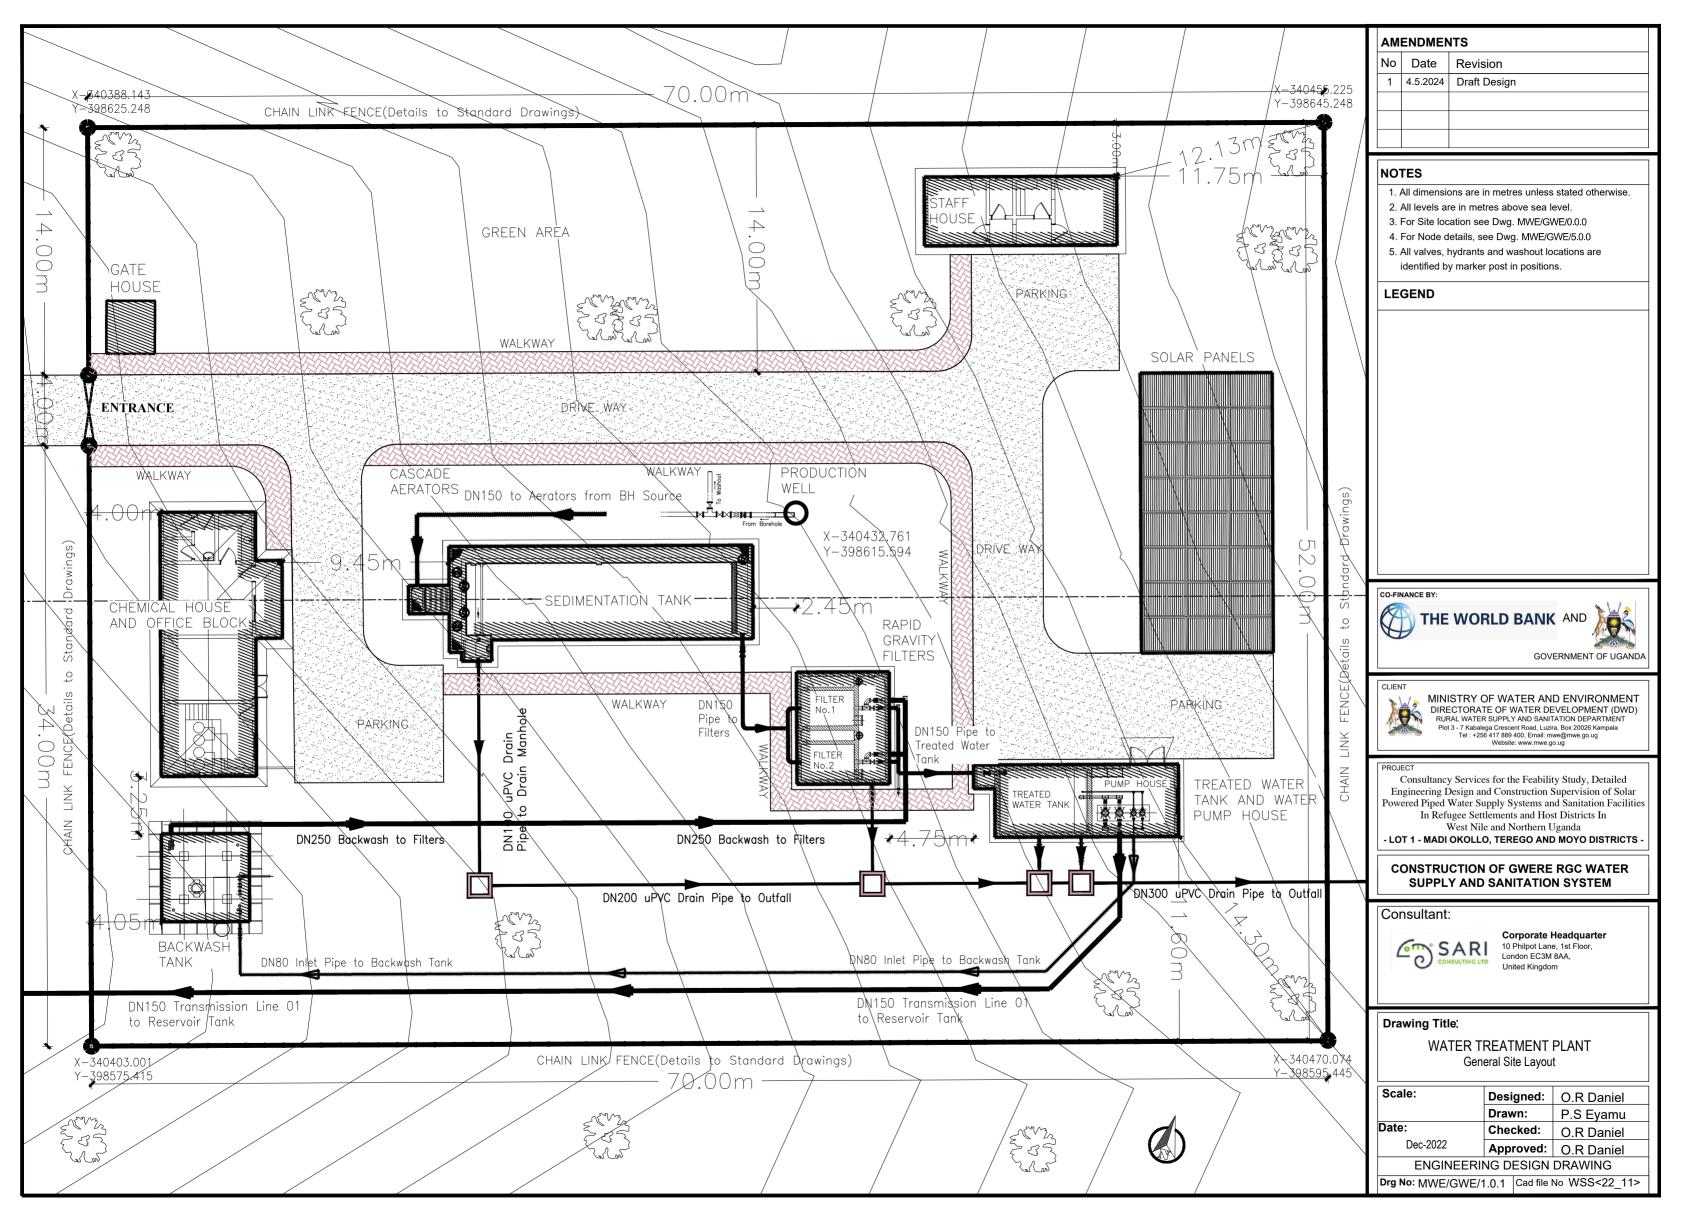

CROSS SECTIONAL ELEVATION_WATER TREATMENT PLANT

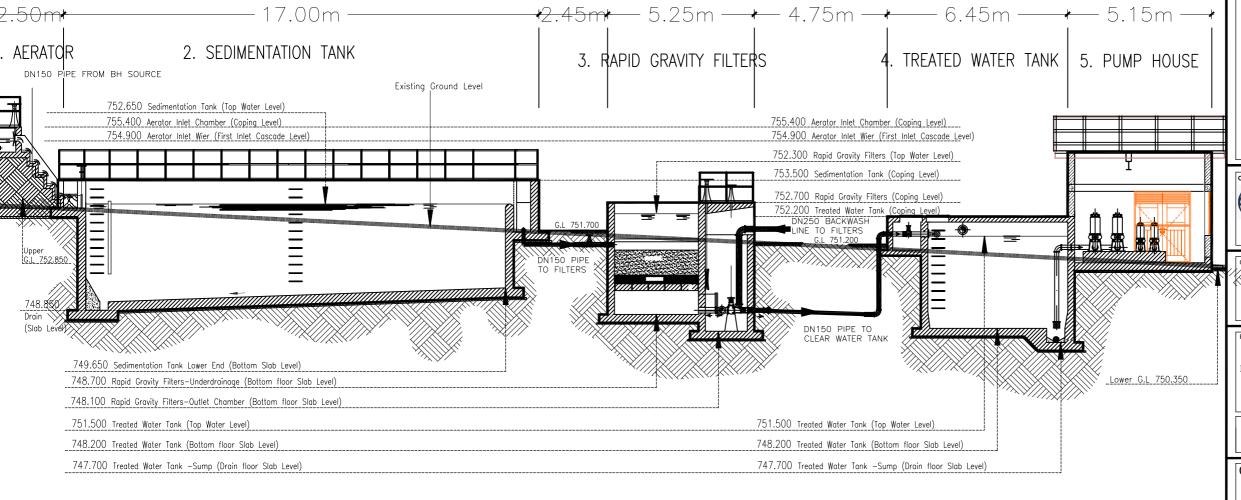

AMENDMENTS No Date Revision 1 8.16.2023 Draft Design

NOTES

- 1. All dimensions are in metres unless stated otherwise.
- 2. All levels are in metres above sea level.
- 3. For Site location see Dwg. MWE/GWE/0.0.0
- 4. For Node details, see Dwg. MWE/GWE/5.0.0
- All valves, hydrants and washout locations are identified by marker post in positions.

LEGEND





GOVERNMENT OF UGANDA

CLIENT

MINISTRY OF WATER AND ENVIRONMENT
DIRECTORATE OF WATER DEVELOPMENT (DWD)
RURAL WATER SUPPLY AND SANITATION DEPARTMENT
Plot 3 - 7 Kabalega Crescent Road, Luzira, Box 20026 Kampala
Tel: +256 417 889 400, Email: mew@mwe.go.ug
Website: www.mwe.go.ug

PROJECT

Consultancy Services for the Feability Study, Detailed Engineering Design and Construction Supervision of Solar Powered Piped Water Supply Systems and Sanitation Facilities In Refugee Settlements and Host Districts In West Nile and Northern Uganda

- LOT 1 - MADI OKOLLO, TEREGO AND MOYO DISTRICTS -

CONSTRUCTION OF GWERE RGC WATER SUPPLY AND SANITATION SYSTEM

Consultant:




Corporate Headquarter 10 Philpot Lane, 1st Floor, London EC3M 8AA, United Kingdom

Drawing Title:

WATER TREATMENT PLANT Hydraulic Profile

Scale:	Desi	gned:	O.R Daniel		
	Draw	/n:	P.S Eyamu		
Date:	Checked:		O.R Daniel		
Dec-2022	Appı	roved:	O.R Daniel		
ENGINEERING DESIGN DRAWING					
Drg No: MWE/GWE/1.0.2 Cad file No WSS<22_11					

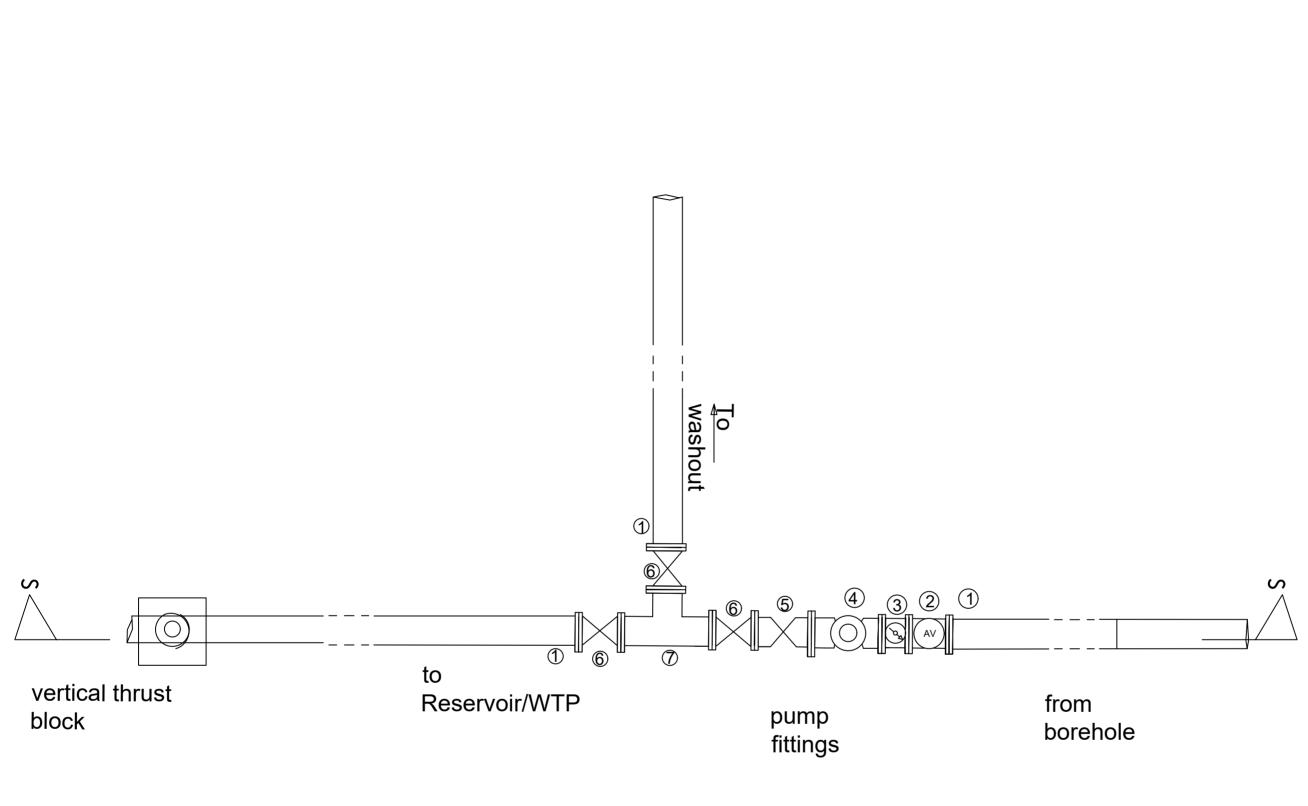

PLAN VIEW

AMENDMENTS		
No	Date	Revision
1	4.5.2024	Draft Design

NOTE

- 1. All dimensions are in metres unless stated otherwise.
- 2. All levels are in metres above sea level.
- 3. For Site location see Dwg. MWE/GWE/0.0.0
- 4. For Node details, see Dwg. MWE/GWE/5.0.0
- 5. All valves, hydrants and washout locations are identified by marker post in positions.

PIPE FITTINGS (DWD 89709)

- . 3No.DN125 G.I pipe
- 2. 1No.DN125 Air Release Valve.
- 3. 1No.DN125 Pressure Gauge.
- 4. 1No.DN125 Flow meter.
- 5. 1No.DN125 Non return valve
- 3. 3No.DN125 gate valve.
- 7. 1No.DN125 Equal tee.





CLIENT

MINISTRY OF WATER AND ENVIRONMENT
DIRECTORATE OF WATER DEVELOPMENT (DWD)
RURAL WATER SUPPLY AND SANITATION DEPARTMENT
Plot 3 - 7 Kabalega Crescent Road, Luzira, Box 20026 Kampala
Tel: +256 417 889 400, Email: mwe@mwe.go.ug
Website: www mwe ou ou

PROJEC1

Consultancy Services for the Feability Study, Detailed Engineering Design and Construction Supervision of Solar Powered Piped Water Supply Systems and Sanitation Facilities In Refugee Settlements and Host Districts In West Nile and Northern Uganda

LOT 1 - MADI OKOLLO, TEREGO AND MOYO DISTRICTS

CONSTRUCTION OF GWERE RGC WATER SUPPLY AND SANITATION SYSTEM

Consultant:



Corporate Headquarter 10 Philpot Lane, 1st Floor, London EC3M 8AA, United Kingdom


Drawing Title

BOREHOLE PUMP HOUSE Ground Floor Plan

Designed:	O.R Daniel
Drawn:	P.S Eyamu
Checked:	O.R Daniel
Approved:	O.R Daniel
	Drawn: Checked:

ENGINEERING DESIGN DRAWING

Drg No: MWE/GWE/1.0.3 | Cad file No WSS<22_11>

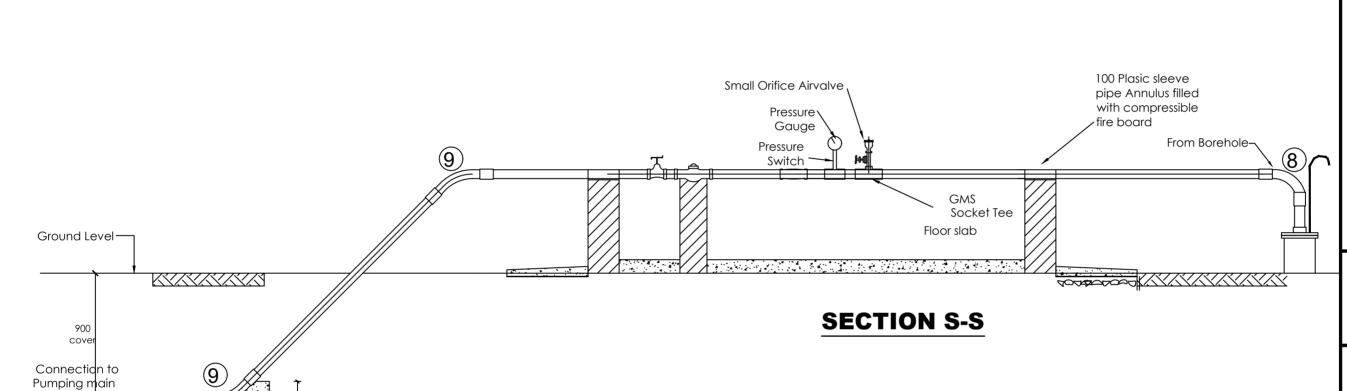

Treatment C20 Thrust block

AM	AMENDMENTS			
No	Date	Revision		
1	4.5.2024	Draft Design		

NOTE

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- 3. For Site location see Dwg. MWE/GWE/0.0.0
- 4. For Node details, see Dwg. MWE/GWE/5.0.0
- 5. All valves, hydrants and washout locations are identified by marker post in positions.

PIPE FITTINGS (DWD 89709)

- 1. 3No.DN125 G.I pipe
- 2. 1No.DN125 Air Release Valve.
- 3. 1No.DN125 Pressure Gauge.
- 4. 1No.DN125 Flow meter.
- 5. 1No.DN125 Non return valve
- 6. 3No.DN125 gate valve.
- 7. 1No.DN125 Equal tee.
- 8. 2No.DN125 45⁰ bend.
- 9. 1No.DN125 90⁰ bend





GOVERNMENT OF UGANDA





MINISTRY OF WATER AND ENVIRONMENT
DIRECTORATE OF WATER DEVELOPMENT (DWD)
RURAL WATER SUPPLY AND SANITATION DEPARTMENT
Plot 3 - 7 Kabalega Crescent Road, Luzira, Box 20026 Kampala
Tel: +256 417 889 400, Email: mwe@mwe.go.ug
Website: www.rnwe.go.ug

PROJEC

Consultancy Services for the Feability Study, Detailed Engineering Design and Construction Supervision of Solar Powered Piped Water Supply Systems and Sanitation Facilities In Refugee Settlements and Host Districts In West Nile and Northern Uganda

LOT 1 - MADI OKOLLO, TEREGO AND MOYO DISTRICTS

CONSTRUCTION OF GWERE RGC WATER SUPPLY AND SANITATION SYSTEM

Consultant:



Corporate Headquarter 10 Philpot Lane, 1st Floor, London EC3M 8AA, United Kingdom


rawing Title:

BOREHOLE PUMP HOUSE Secion S-S

Scale:	Designed:	O.R Daniel
	Drawn:	P.S Eyamu
Date:	Checked:	O.R Daniel
Dec-2022	Approved:	O.R Daniel

ENGINEERING DESIGN DRAWING

Drg No: MWE/GWE/1.0.4 | Cad file No WSS<22_11>

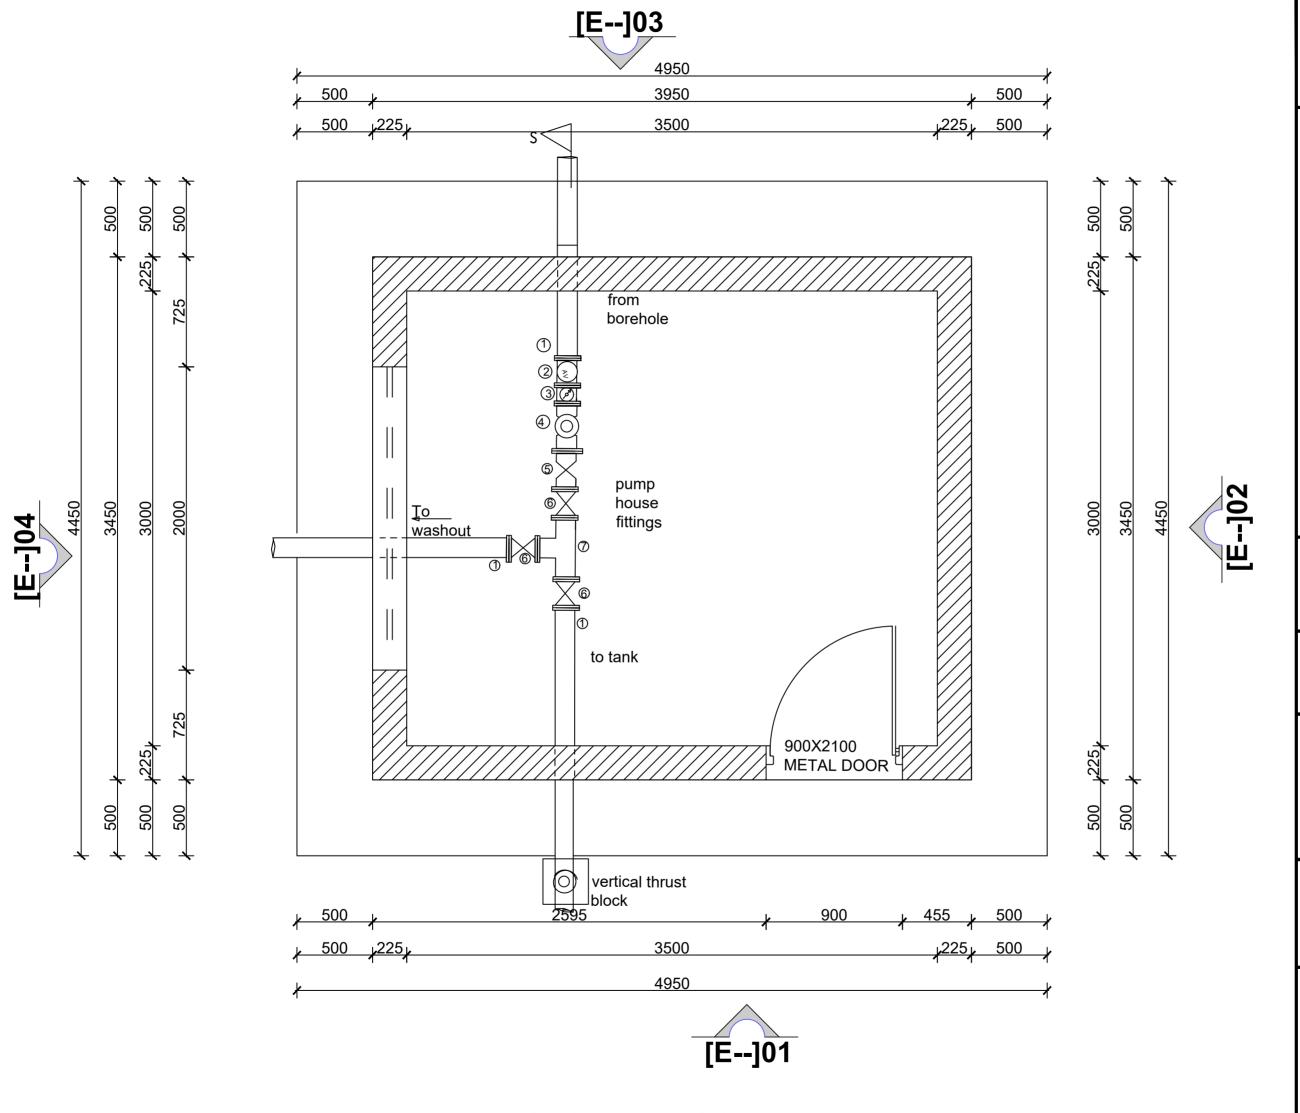

AMENDMENTS

Date

4.5.2024

- 1. All dimensions are in metres unless stated otherwise.
- 2. All levels are in metres above sea level.

Revision

Draft Design

- 3. For Site location see Dwg. MWE/GWE/0.0.0
- 4. For Node details, see Dwg. MWE/GWE/5.0.0
- 5. All valves, hydrants and washout locations are identified by marker post in positions.

PIPE FITTINGS (existing borehole)

- 1. 3No.DN50 G.I pipe
- 1No.DN50 Air Release Valve.
- 1No.DN50 Pressure Gauge.
- 1No.DN50 Flow meter.
- 5. 1No.DN50 Non return valve
- 3No.DN50 gate valve.
- 7. 1No.DN50 Equal tee.





GOVERNMENT OF UGANDA

MINISTRY OF WATER AND ENVIRONMENT DIRECTORATE OF WATER AND ENVIRONMENT (DWD)
RURAL WATER SUPPLY AND SANITATION DEPARTMENT
Plot 3 - 7 Kabalega Crescent Road, Luzira, Box 20026 Kampala
Tel: +256 417 889 400, Email: mwe@mwe.go.ug
Website: www.mwe.go.ug

Consultancy Services for the Feability Study, Detailed Engineering Design and Construction Supervision of Solar Powered Piped Water Supply Systems and Sanitation Facilities In Refugee Settlements and Host Districts In West Nile and Northern Uganda

LOT 1 - MADI OKOLLO, TEREGO AND MOYO DISTRICTS

CONSTRUCTION OF GWERE RGC WATER SUPPLY AND SANITATION SYSTEM

Consultant:



Corporate Headquarter 10 Philpot Lane, 1st Floor, London EC3M 8AA,

Drawing Title:


BOREHOLE PUMP HOUSE Ground Floor Plan

Scale:	Designed:	O.R Daniel
	Drawn:	P.S Eyamu
Date:	Checked:	O.R Daniel
Dec-2022	Approved:	O.R Daniel

ENGINEERING DESIGN DRAWING

Drg No: MWE/GWE/1.0.5 | Cad file No WSS<22_11>

GROUND FLOOR PLAN

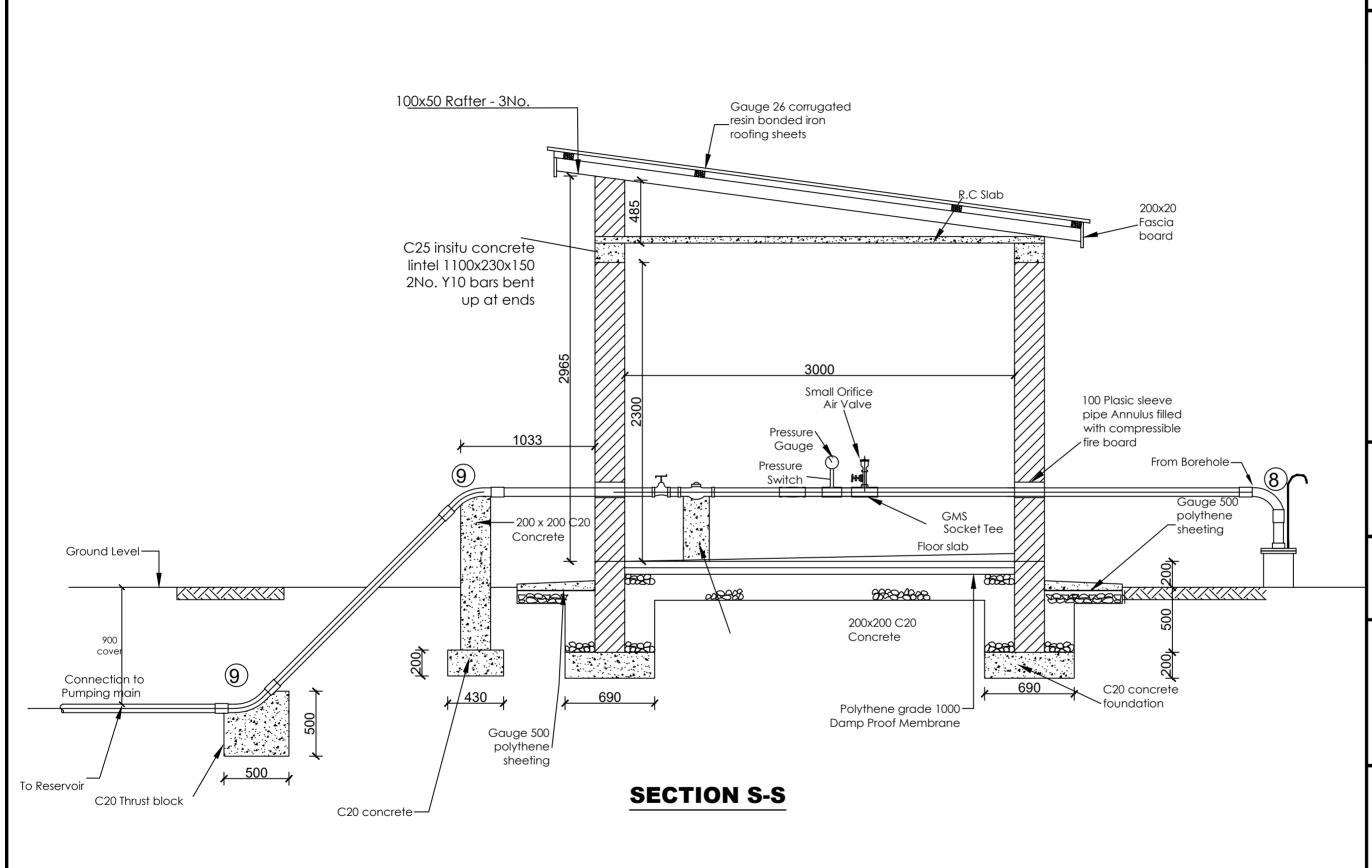

AMENDMENTS		
No	Date	Revision
1	4.5.2024	Draft Design

- 1. All dimensions are in metres unless stated otherwise.
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- 3. For Site location see Dwg. MWE/GWE/0.0.0
- 4. For Node details, see Dwg. MWE/GWE/5.0.0
- 5. All valves, hydrants and washout locations are identified by marker post in positions.

PIPE FITTINGS (DWD 89709)

- 1. 3No.DN50 G.I pipe
- 2. 1No.DN50 Air Release Valve.
- 3. 1No.DN50 Pressure Gauge.
- 1. 1No.DN50 Flow meter.
- 5. 1No.DN50 Non return valve
- 6. 3No.DN50 gate valve.
- 7. 1No.DN50 Equal tee.
- 8. 2No.DN50 45⁰ bend. 9. 1No.DN50 90⁰ bend





GOVERNMENT OF UGANDA



MINISTRY OF WATER AND ENVIRONMENT DIRECTORATE OF WATER DEVELOPMENT (DWD) RURAL WATER SUPPLY AND SANITATION DEPARTMENT Plot 3 - 7 Kabalega Crescent Road, Luzira, Box 20026 Kampala Tel: +256 417 889 400, Email: mwe@mwe.go.ug Website: www.mwe.go.ug

PROJECT

Consultancy Services for the Feability Study, Detailed Engineering Design and Construction Supervision of Solar Powered Piped Water Supply Systems and Sanitation Facilities In Refugee Settlements and Host Districts In West Nile and Northern Uganda

LOT 1 - MADI OKOLLO, TEREGO AND MOYO DISTRICTS

CONSTRUCTION OF GWERE RGC WATER SUPPLY AND SANITATION SYSTEM

Consultant:



Corporate Headquarter 10 Philpot Lane, 1st Floor, London EC3M 8AA, United Kingdom


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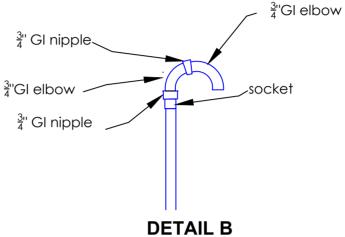
BOREHOLE PUMP HOUSE Secion S-S


Scale:	Designed:	O.R Daniel
	Drawn:	P.S Eyamu
Date:	Checked:	O.R Daniel
Dec-2022	Approved:	O.R Daniel

ENGINEERING DESIGN DRAWING

Drg No: MWE/GWE/1.0.6 Cad file No WSS<22_11>



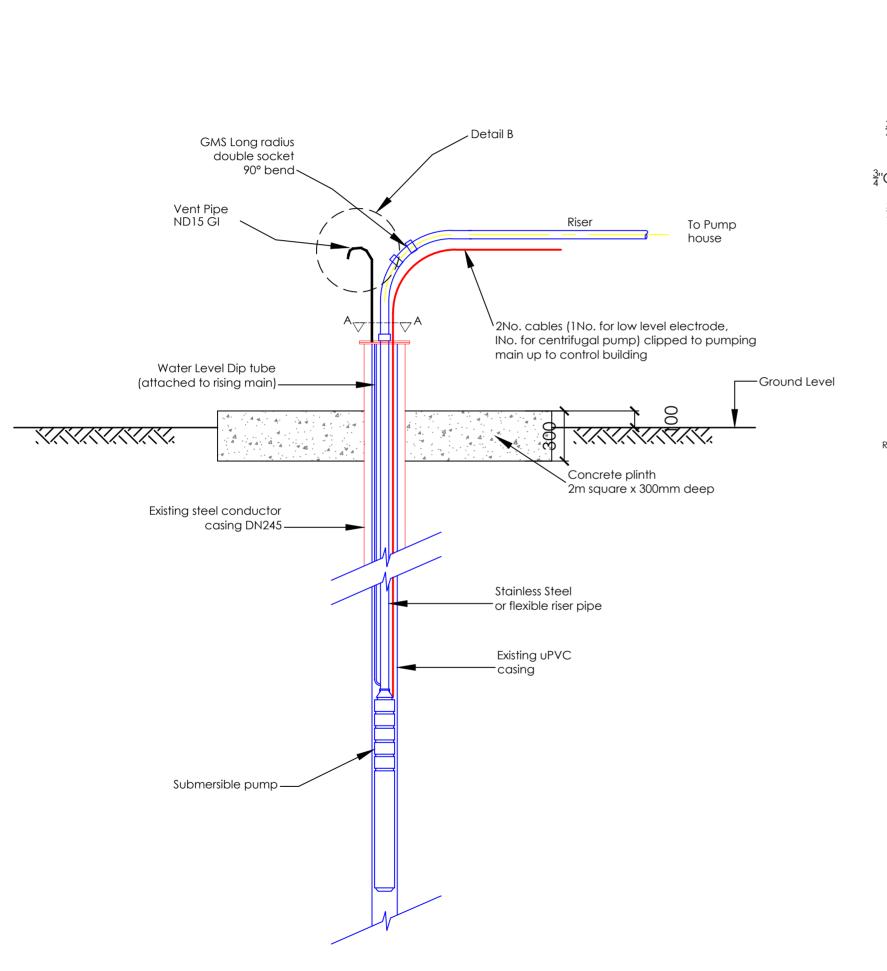

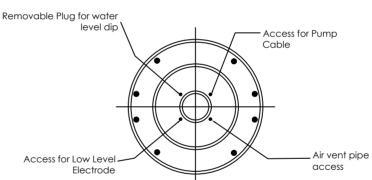

SECTION A-A

Scale: 1:20

ΑМ	AMENDMENTS			
No	Date	Revision		
1	4.5.2024	Draft Design		

NOTES

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- 3. For Site location see Dwg. MWE/GWE/0.0.0
- 4. For Node details, see Dwg. MWE/GWE/5.0.0
- 5. All valves, hydrants and washout locations are identified by marker post in positions.

LEGEND





GOVERNMENT OF UGANDA



MINISTRY OF WATER AND ENVIRONMENT
DIRECTORATE OF WATER DEVELOPMENT (DWD)
RURAL WATER SUPPLY AND SANITATION DEPARTMENT
Plot 3 - 7 Kabalega Crescent Road, Luzira, Box 20026 Kampala
Tel: +256 417 889 400, Email: mwe@mwe.go.ug
Website: www.mwe.go.ug

Consultancy Services for the Feability Study, Detailed Engineering Design and Construction Supervision of Solar Powered Piped Water Supply Systems and Sanitation Facilities In Refugee Settlements and Host Districts In West Nile and Northern Uganda

LOT 1 - MADI OKOLLO, TEREGO AND MOYO DISTRICTS

CONSTRUCTION OF GWERE RGC WATER SUPPLY AND SANITATION SYSTEM

Consultant:



Corporate Headquarter 10 Philpot Lane, 1st Floor, London EC3M 8AA, United Kingdom


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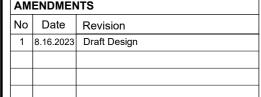
BOREHOLE PUMP HOUSE Riser Mains Details

Designed:	O.R Daniel
Drawn:	P.S Eyamu
Checked:	O.R Daniel
Approved:	O.R Daniel
	Drawn: Checked:

ENGINEERING DESIGN DRAWING

Drg No: MWE/GWE/1.0.7 Cad file No WSS<22_11>



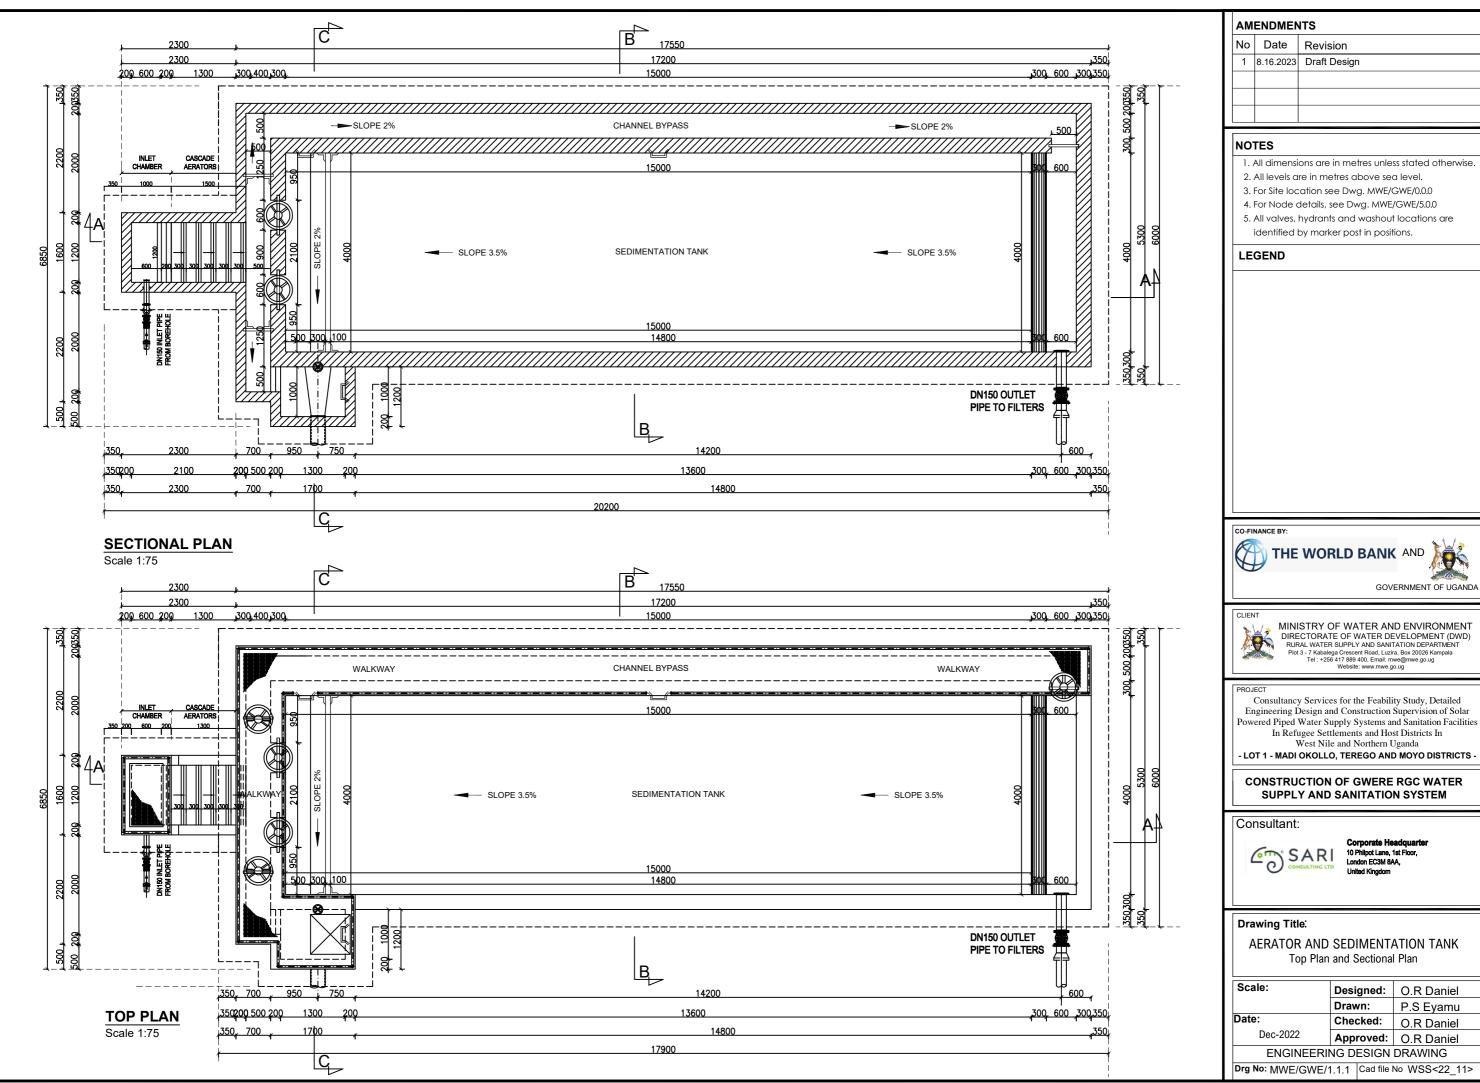

- 5. All valves, hydrants and washout locations are

GOVERNMENT OF UGANDA

DIRECTORATE OF WATER DEVELOPMENT (DWD)

RURAL WATER SUPPLY AND SANITATION DEPARTMENT

Plot 3 - 7 Kabalega Crescent Road, Luzira, Box 20026 Kampala

Tel: +256 417 889 400, Email: mwe@mwe.go.ug

Website: www.mwe.go.ug

Engineering Design and Construction Supervision of Solar Powered Piped Water Supply Systems and Sanitation Facilities In Refugee Settlements and Host Districts In West Nile and Northern Uganda


- LOT 1 - MADI OKOLLO, TEREGO AND MOYO DISTRICTS -


CONSTRUCTION OF GWERE RGC WATER **SUPPLY AND SANITATION SYSTEM**

10 Philpot Lane, 1st Floor,

Top Plan and Sectional Plan

Scale:	Designed:	O.R Daniel	
	Drawn:	P.S Eyamu	
Date:	Checked:	O.R Daniel	
Dec-2022	Approved:	O.R Daniel	
ENGINEERING DESIGN DRAWING			
Dec No. MAIE COME IA A A Cod File No. MCC 200 AAS			

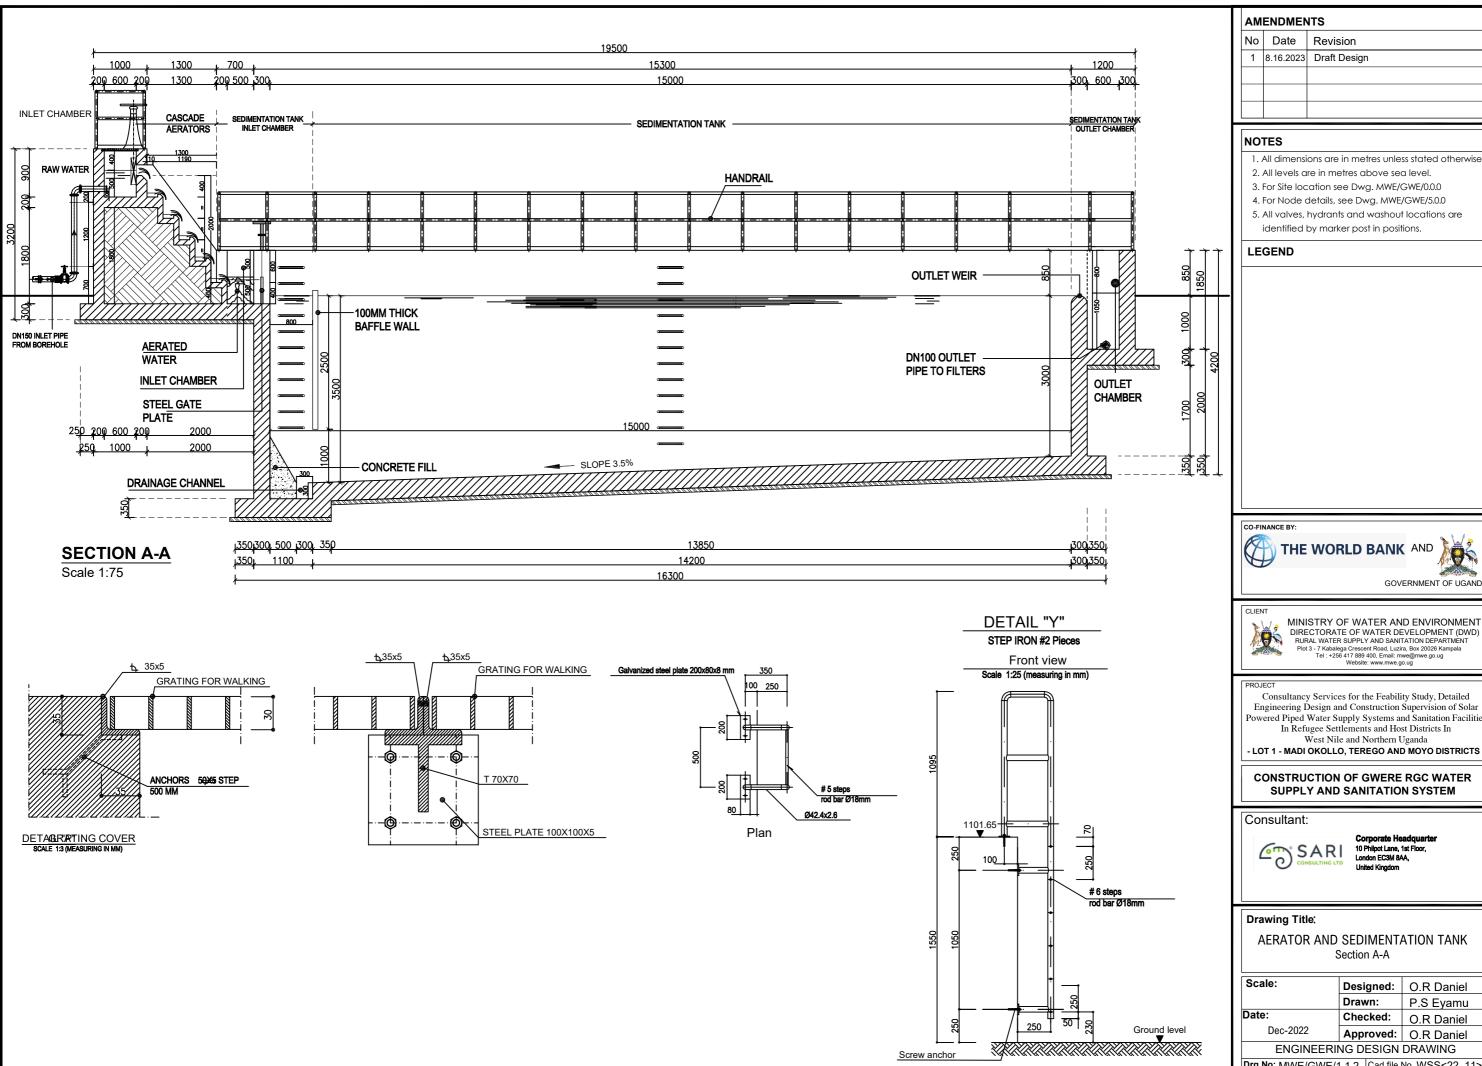

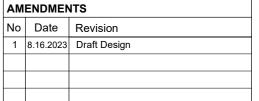

- 1. All dimensions are in metres unless stated otherwise.
- 5. All valves, hydrants and washout locations are



DIRECTORATE OF WATER DEVELOPMENT (DWD)

RURAL WATER SUPPLY AND SANITATION DEPARTMENT

Plot 3 - 7 Kabalega Crescent Road, Luzira, Box 20026 Kampala

Tel: +256 417 889 400, Email: mwe@mwe.go.ug

Website: www.mwe.go.ug


Consultancy Services for the Feability Study, Detailed Engineering Design and Construction Supervision of Solar Powered Piped Water Supply Systems and Sanitation Facilities In Refugee Settlements and Host Districts In

- LOT 1 - MADI OKOLLO, TEREGO AND MOYO DISTRICTS -

CONSTRUCTION OF GWERE RGC WATER **SUPPLY AND SANITATION SYSTEM**

10 Philpot Lane, 1st Floor,

Scale:	Designed:		O.R Daniel
	Draw	n:	P.S Eyamu
Date:	Checked:		O.R Daniel
Dec-2022	Appro	oved:	O.R Daniel
ENGINEERI	ERING DESIGN DRAWING		
Drg No: MWE/GWE/1	1.1.2	Cad file I	No WSS<22_11>

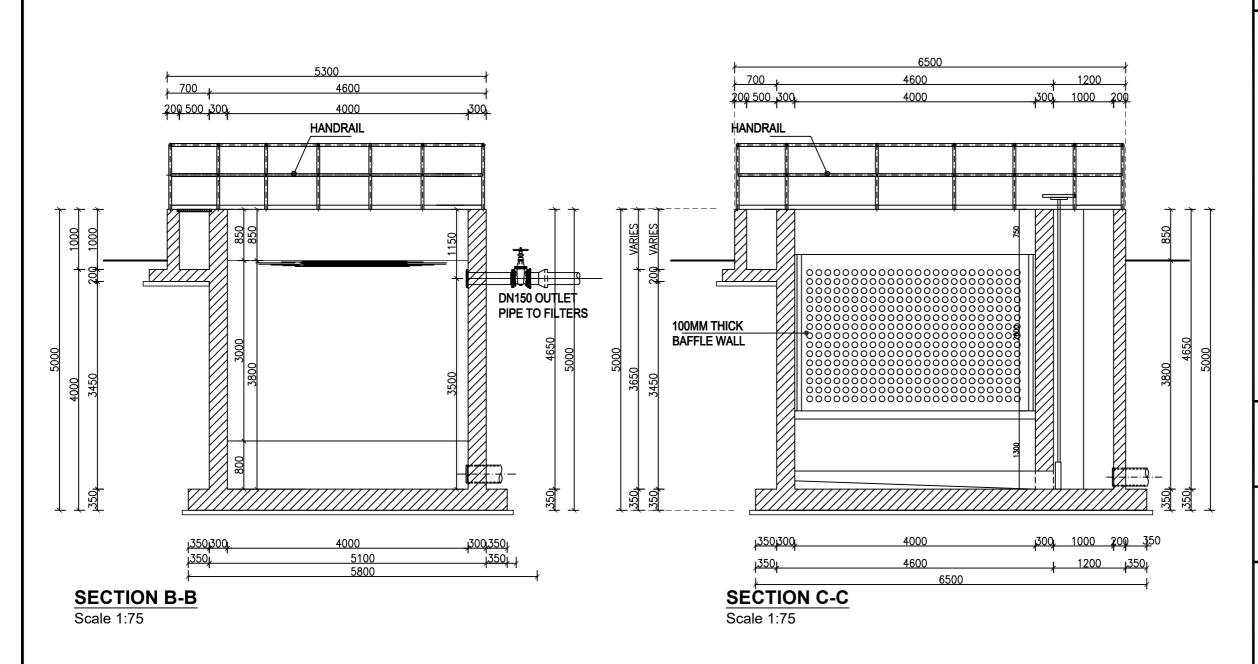

l	АМ	AMENDMENTS		
l	No	Date	Revision	
l	1	8.16.2023	Draft Design	
l				
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ı				

- 1. All dimensions are in metres unless stated otherwise
- 2. All levels are in metres above sea level.
- 3. For Site location see Dwg. MWE/GWE/0.0.0
- 4. For Node details, see Dwg. MWE/GWE/5.0.0
- All valves, hydrants and washout locations are identified by marker post in positions.

LEGEND







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MINISTRY OF WATER AND ENVIRONMENT
DIRECTORATE OF WATER DEVELOPMENT (DWD)
RURAL WATER SUPPLY AND SANITATION DEPARTMENT
Plot 3 - 7 Kabalega Crescent Road, Luzira, Box 20026 Kampala
Tel: +256 417 889 400, Email: mwe@mwe.go.u.g
Website: www.mwe.go.u.g

PROJEC

Consultancy Services for the Feability Study, Detailed Engineering Design and Construction Supervision of Solar Powered Piped Water Supply Systems and Sanitation Facilities In Refugee Settlements and Host Districts In West Nile and Northern Uganda

- LOT 1 - MADI OKOLLO, TEREGO AND MOYO DISTRICTS -

CONSTRUCTION OF GWERE RGC WATER SUPPLY AND SANITATION SYSTEM

Consultant:




Corporate Headquarter 10 Philpot Lane, 1st Floor, London EC3M 8AA, United Kingdom

Drawing Title:

AERATOR AND SEDIMENTATION TANK
Section B-B and Section C-C

Scale:	Designed:	O.R Daniel	
	Drawn:	P.S Eyamu	
Date:	Checked:	O.R Daniel	
Dec-2022	Approved:	O.R Daniel	
ENGINEERING DESIGN DRAWING			

Drg No: MWE/GWE/1.1.3 | Cad file No WSS<22_11>

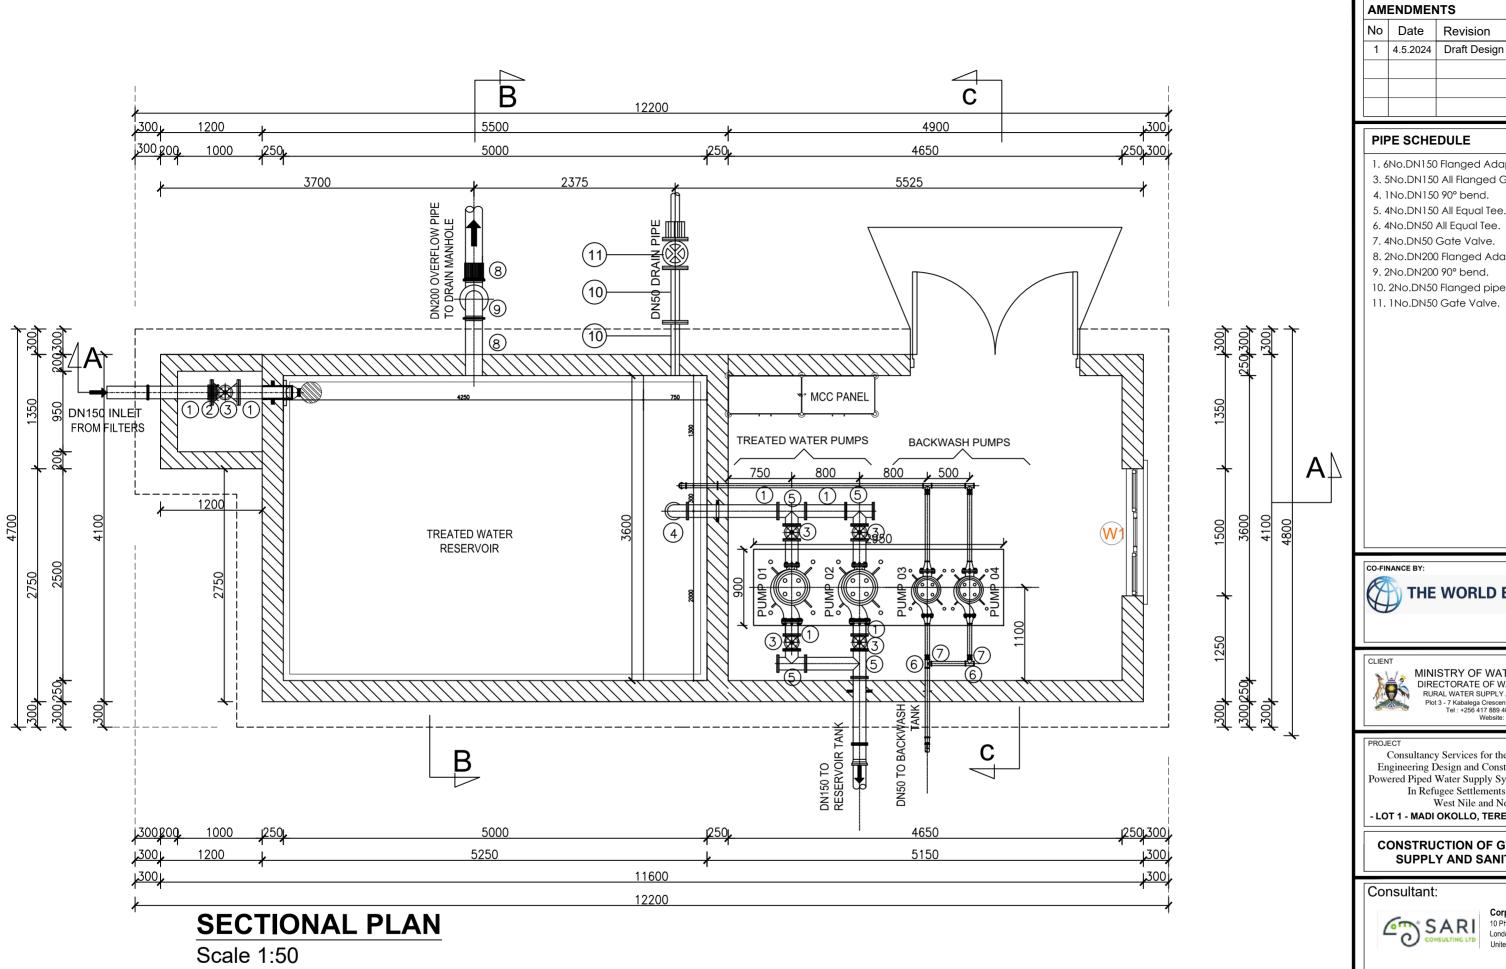

Date

- 1. 6No.DN150 Flanged Adaptor, Maxi type or similar...
- 3. 5No.DN150 All Flanged Gate Valve.

Revision

- 4. 1No.DN150 90° bend.
- 5. 4No.DN150 All Equal Tee.
- 6. 4No.DN50 All Equal Tee.
- 7. 4No.DN50 Gate Valve.
- 8. 2No.DN200 Flanged Adaptor, Maxi type or similar.
- 9. 2No.DN200 90° bend.
- 10. 2No.DN50 Flanged pipe not exceeding 1.0m.
- 11. 1No.DN50 Gate Valve.





GOVERNMENT OF UGANDA

MINISTRY OF WATER AND ENVIRONMENT DIRECTORATE OF WATER DEVELOPMENT (DWD)
RURAL WATER SUPPLY AND SANITATION DEPARTMENT
Plot 3 - 7 Kabalega Crescent Road, Luzira, Box 20026 Kampala
Tel: +256 417 889 400. Email: mwe@mwe.go.ug

Consultancy Services for the Feability Study, Detailed Engineering Design and Construction Supervision of Solar Powered Piped Water Supply Systems and Sanitation Facilities In Refugee Settlements and Host Districts In West Nile and Northern Uganda

- LOT 1 - MADI OKOLLO, TEREGO AND MOYO DISTRICTS -

CONSTRUCTION OF GWERE RGC WATER SUPPLY AND SANITATION SYSTEM

Consultant:



10 Philpot Lane, 1st Floor,


Drawing Title:

TREATED WATER TANK AND PUMP HOUSE Sectional Plan

Scale:	Designed:	O.R Daniel
	Drawn:	P.S Eyamu
Date:	Checked:	O.R Daniel
Dec-2022	Approved:	O.R Daniel

Drg No: MWE/GWE/1.3.1 | Cad file No WSS<22_11>

ENGINEERING DESIGN DRAWING

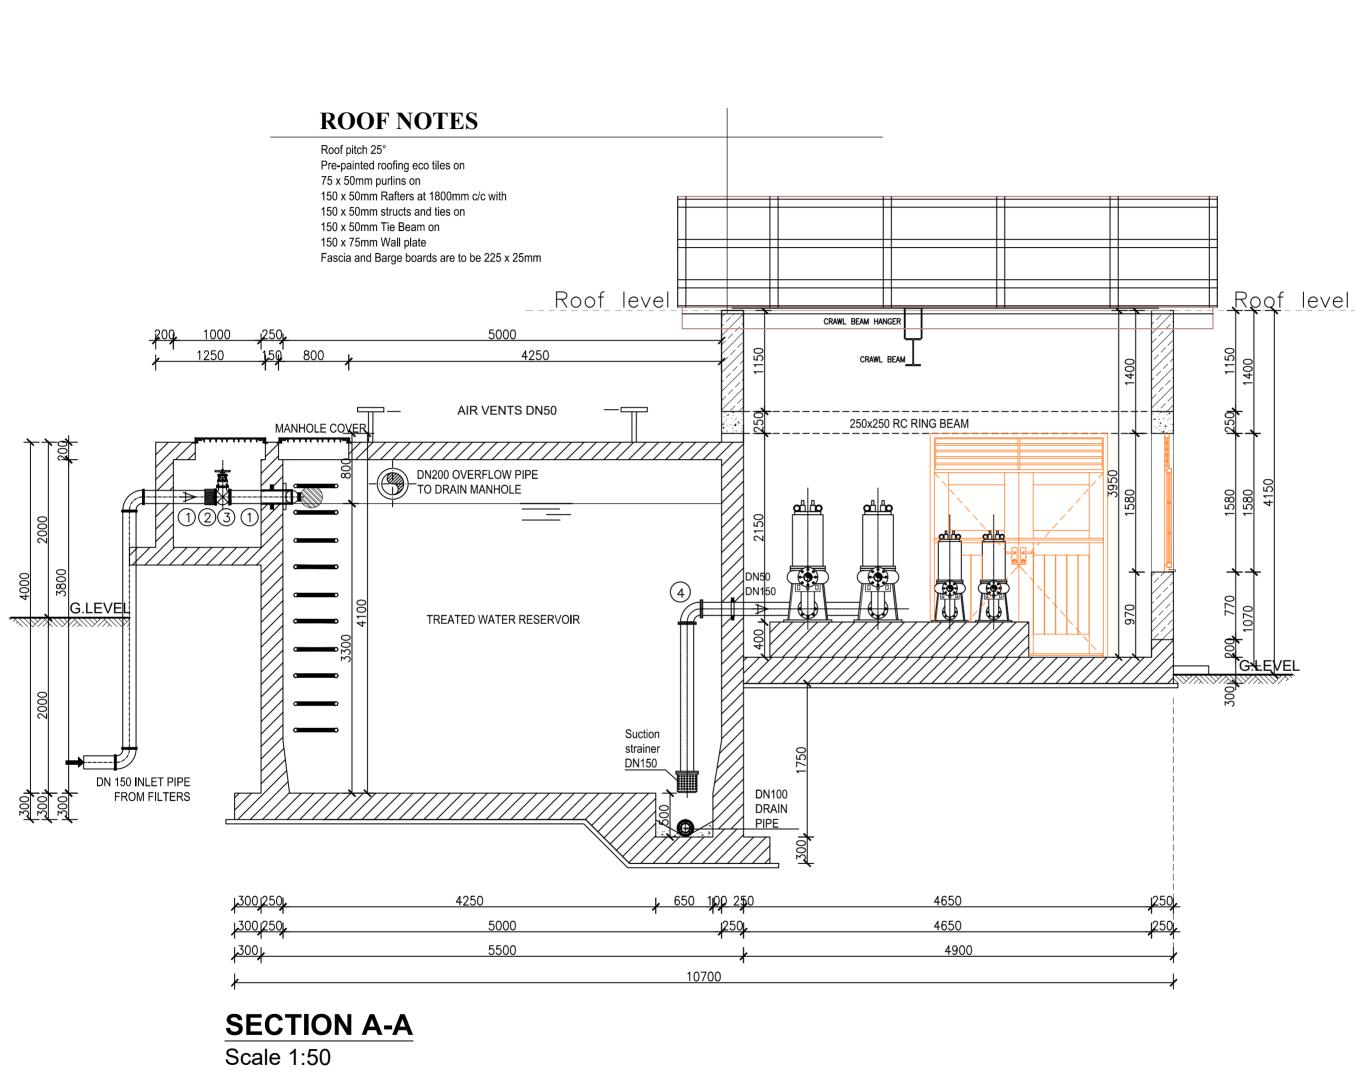

AMENDMENTS		
No	Date	Revision
1	4.5.2024	Draft Design

- 1. 6No.DN150 Flanged Adaptor, Maxi type or similar..
- 3. 5No.DN150 All Flanged Gate Valve.
- 4. 1No.DN150 90° bend.
- 5. 4No.DN150 All Equal Tee.
- 6. 4No.DN50 All Equal Tee.
- 7. 4No.DN50 Gate Valve.
- 8. 2No.DN200 Flanged Adaptor, Maxi type or similar.
- 9. 2No.DN200 90° bend.
- 10. 2No.DN50 Flanged pipe not exceeding 1.0m.
- 11. 1No.DN50 Gate Valve.





GOVERNMENT OF UGANDA



MINISTRY OF WATER AND ENVIRONMENT
DIRECTORATE OF WATER DEVELOPMENT (DWD)
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Plot 3 - 7 Kabalega Crescent Road, Luzira, Box 20026 Kampala
Tel: +256 417 889 400, Email: mwe@mwe.go.ug
Website: www.mwe.go.ug

PROJECT

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- LOT 1 - MADI OKOLLO, TEREGO AND MOYO DISTRICTS

CONSTRUCTION OF GWERE RGC WATER SUPPLY AND SANITATION SYSTEM

Consultant:




10 Philpot Lane, 1st Floor, London EC3M 8AA, United Kingdom

Drawing Title:

TREATED WATER TANK AND PUMP HOUSE Section A-A

Scale:	Designed:	O.R Daniel
	Drawn:	P.S Eyamu
Date:	Checked:	O.R Daniel
Dec-2022	Approved:	O.R Daniel
ENGINEERING DESIGN DRAWING		

Drg No: MWE/GWE/1.3.2 | Cad file No WSS<22_11>

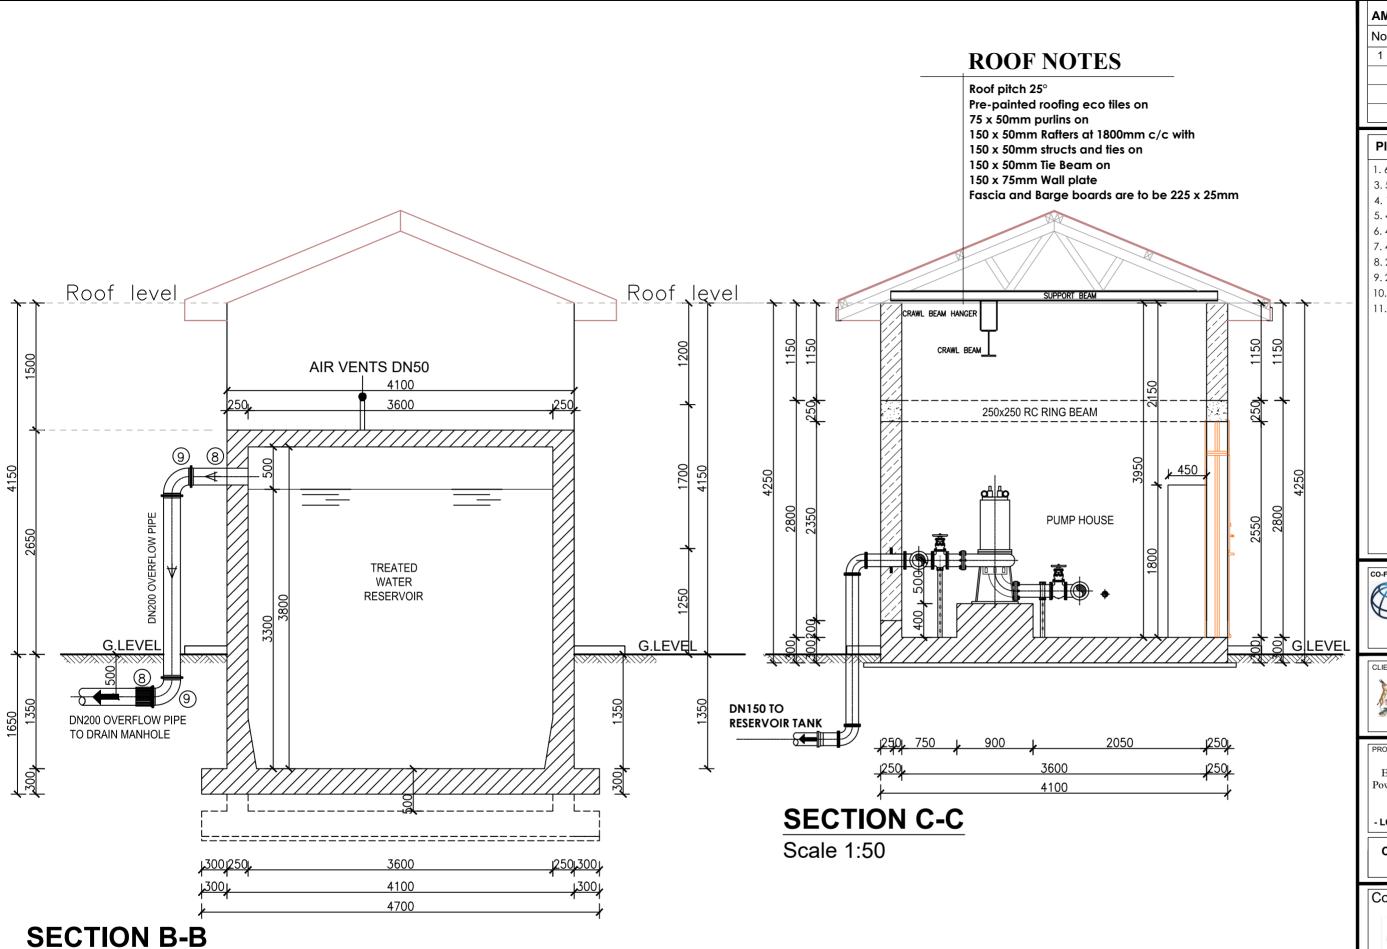

Scale 1:50

AMENDMENTS

No Date Revision

1 4.5.2024 Draft Design

PIPE SCHEDULE

- 1. 6No.DN150 Flanged Adaptor, Maxi type or similar..
- 3. 5No.DN150 All Flanged Gate Valve.
- 4. 1No.DN150 90° bend.
- 5. 4No.DN150 All Equal Tee.
- 6. 4No.DN50 All Equal Tee.
- 7. 4No.DN50 Gate Valve.
- 8. 2No.DN200 Flanged Adaptor, Maxi type or similar.
- 9. 2No.DN200 90° bend.
- 10. 2No.DN50 Flanged pipe not exceeding 1.0m.
- 11. 1No.DN50 Gate Valve.





GOVERNMENT OF UGANDA



MINISTRY OF WATER AND ENVIRONMENT DIRECTORATE OF WATER DEVELOPMENT (DWD) RURAL WATER SUPPLY AND SANITATION DEPARTMENT Plot 3 - 7 Kabalega Crescent Road, Luzira, Box 20026 Kampala Tel: +256 417 889 400, Email: mwe@mwe.go.ug

PROJECT

Consultancy Services for the Feability Study, Detailed Engineering Design and Construction Supervision of Solar Powered Piped Water Supply Systems and Sanitation Facilities In Refugee Settlements and Host Districts In West Nile and Northern Uganda

- LOT 1 - MADI OKOLLO, TEREGO AND MOYO DISTRICTS -

CONSTRUCTION OF GWERE RGC WATER SUPPLY AND SANITATION SYSTEM

Consultant:



Corporate Headquarter 10 Philpot Lane, 1st Floor, London EC3M 8AA, United Kingdom


Drawing Title:

TREATED WATER TANK AND PUMP HOUSE Section B-B and Section C-C

Scale:	Designed:	O.R Daniel	
	Drawn:	P.S Eyamu	
Date:	Checked:	O.R Daniel	
Dec-2022	Approved:	O.R Daniel	

ENGINEERING DESIGN DRAWING

Drg No: MWE/GWE/1.3.3 | Cad file No WSS<22_11>

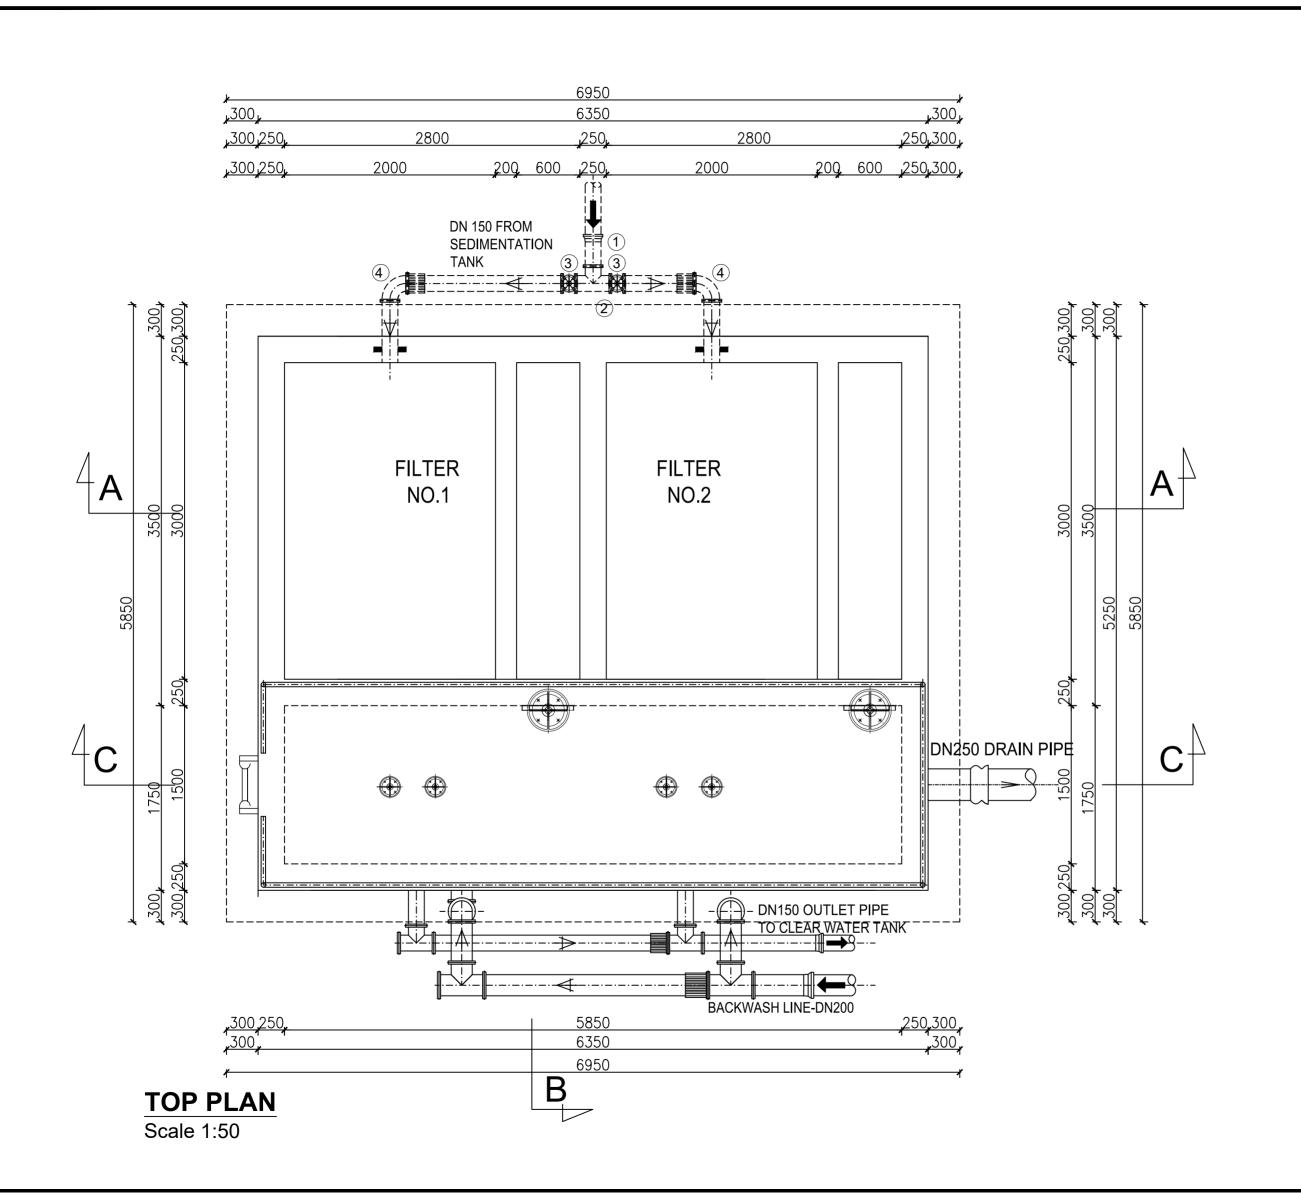

AMENDMENTS		
No	Date	Revision
1	4.5.2024	Draft Design

- 1. 14No.DN150 Flanged Adaptor, Maxi type or similar...
- 2. 3No.DN150 All Equal Tee.
- 3. 2No.DN150 All Flanged Gate Valve.
- 4. 2No.DN150 All Flanged 90° bend.
- 5. 4No.DN200/250 Tee.
- 6. 2No.DN200 /150 taper.
- 7. 6No.DN200 All Flanged 90° bend.
- 8. 2No.DN200 All Flanged Gate Valve.
- 9. 15No.DN250 Flanged Adaptor, Maxi type or similar.
- 10. 2No.DN250 All Flanged Gate Valve.
- 11. 2No.DN200 Flanged Adaptor, Maxi type or similar.





GOVERNMENT OF UGANDA



MINISTRY OF WATER AND ENVIRONMENT DIRECTORATE OF WATER DEVELOPMENT (DWD) RURAL WATER SUPPLY AND SANITATION DEPARTMENT Plot 3 - 7 Kabalega Crescent Road, Luzira, Box 20226 Kampala Tel: +256 417 889 400, Email: mwe@mwe.go.ug

Consultancy Services for the Feability Study, Detailed Engineering Design and Construction Supervision of Solar Powered Piped Water Supply Systems and Sanitation Facilities In Refugee Settlements and Host Districts In West Nile and Northern Uganda

- LOT 1 - MADI OKOLLO, TEREGO AND MOYO DISTRICTS

CONSTRUCTION OF GWERE RGC WATER SUPPLY AND SANITATION SYSTEM

Consultant:




RAPID GRAVITY FILTERS Top Plan

Scale:	Designed:	O.R Daniel
	Drawn:	P.S Eyamu
Date:	Checked:	O.R Daniel
Dec-2022	Approved:	O.R Daniel

ENGINEERING DESIGN DRAWING

Drg No: MWE/GWE/1.2.1 | Cad file No WSS<22_11>

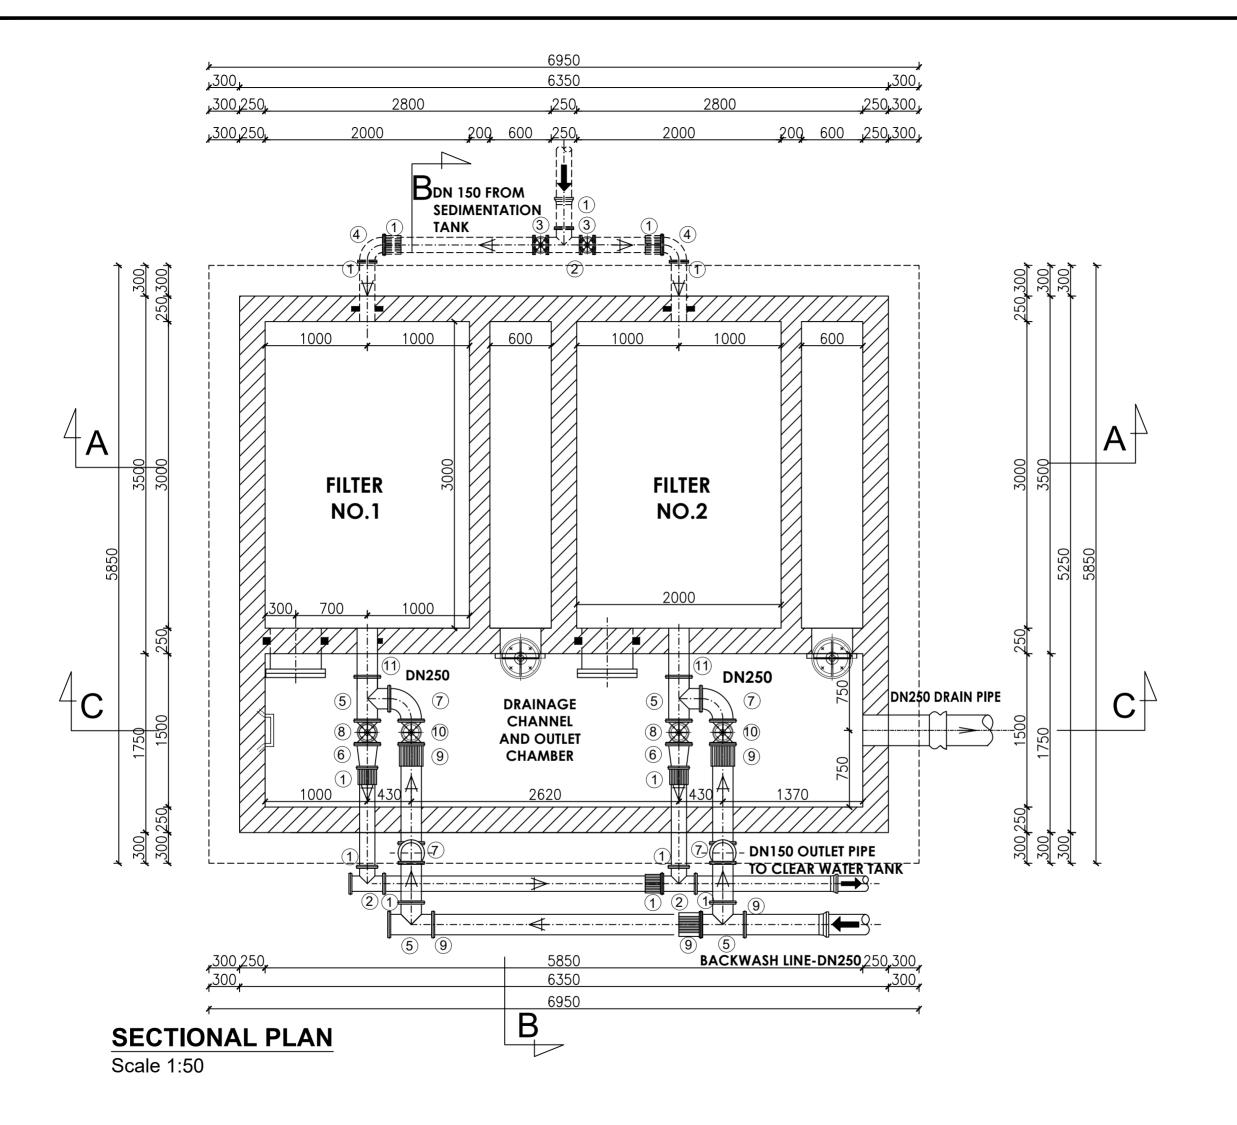

AM	AMENDMENTS	
No	Date	Revision
1	4.5.2024	Draft Design

- 1. 14No.DN150 Flanged Adaptor, Maxi type or similar...
- 2. 3No.DN150 All Equal Tee.
- 3. 2No.DN150 All Flanged Gate Valve.
- 4. 2No.DN150 All Flanged 90° bend.
- 5. 4No.DN200/250 Tee.
- 6. 2No.DN200 /150 taper.
- 7. 6No.DN200 All Flanged 90° bend.
- 8. 2No.DN200 All Flanged Gate Valve.
- 9. 15No.DN250 Flanged Adaptor, Maxi type or similar.
- 10. 2No.DN250 All Flanged Gate Valve.
- 11. 2No.DN200 Flanged Adaptor, Maxi type or similar.





GOVERNMENT OF UGANDA

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MINISTRY OF WATER AND ENVIRONMENT
DIRECTORATE OF WATER DEVELOPMENT (DWD)
RURAL WATER SUPPLY AND SANITATION DEPARTMENT
Plot 3 - 7 Kabalega Crescent Road, Luzira, Box 20026 Kampala
Tel: +256 417 889 400, Email: mwe@mwe.go.ug
Website: www.mwe.go.ug

PROJECT

Consultancy Services for the Feability Study, Detailed Engineering Design and Construction Supervision of Solar Powered Piped Water Supply Systems and Sanitation Facilities In Refugee Settlements and Host Districts In West Nile and Northern Uganda

- LOT 1 - MADI OKOLLO, TEREGO AND MOYO DISTRICTS

CONSTRUCTION OF GWERE RGC WATER SUPPLY AND SANITATION SYSTEM

Consultant:



10 Philpot Lane, 1st Floor, London EC3M 8AA, United Kingdom


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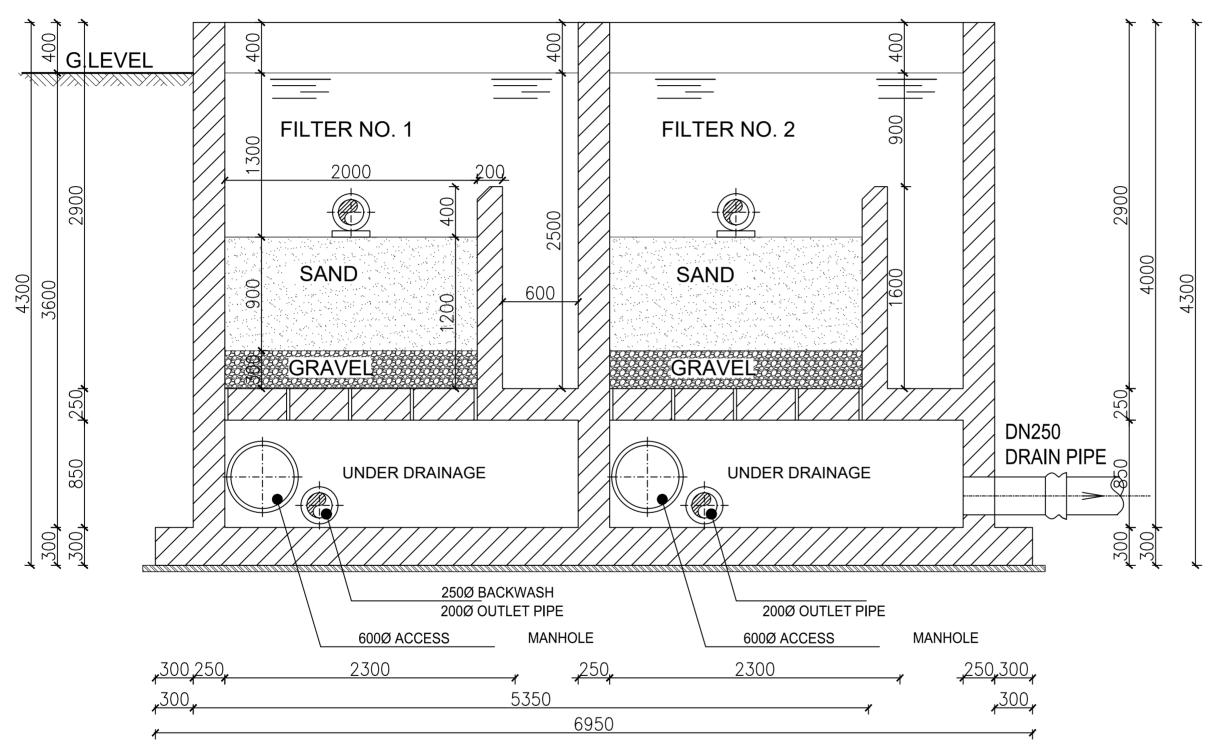
RAPID GRAVITY FILTERS
Sectional Plan

Scale:	Designed:	O.R Daniel
	Drawn:	P.S Eyamu
Date:	Checked:	O.R Daniel
Dec-2022	Approved:	O.R Daniel

ENGINEERING DESIGN DRAWING

Drg No: MWE/GWE/1.2.2 | Cad file No WSS<22_11>



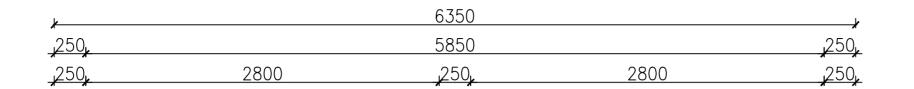

SECTION A-A

Scale 1:50

AM	AMENDMENTS		
No	Date	Revision	
1	4.5.2024	Draft Design	

PIPE SCHEDULE

- 1. 14No.DN150 Flanged Adaptor, Maxi type or similar...
- 2. 3No.DN150 All Equal Tee.
- 3. 2No.DN150 All Flanged Gate Valve.
- 4. 2No.DN150 All Flanged 90° bend.
- 5. 4No.DN200/250 Tee.
- 6. 2No.DN200 /150 taper.
- 7. 6No.DN200 All Flanged 90° bend.
- 8. 2No.DN200 All Flanged Gate Valve.
- 9. 15No.DN250 Flanged Adaptor, Maxi type or similar.
- 10. 2No.DN250 All Flanged Gate Valve.
- 11. 2No.DN200 Flanged Adaptor, Maxi type or similar.





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MINISTRY OF WATER AND ENVIRONMENT DIRECTORATE OF WATER DEVELOPMENT (DWD) RURAL WATER SUPPLY AND SANITATION DEPARTMENT Plot 3 - 7 Kabalega Crescent Road, Luzira, Box 20026 Kampala Tel : +256 1417 889 400, Email: mwe@mwe.go.ug Website: www.mwe.go.ug

PROJECT

Consultancy Services for the Feability Study, Detailed Engineering Design and Construction Supervision of Solar Powered Piped Water Supply Systems and Sanitation Facilities In Refugee Settlements and Host Districts In West Nile and Northern Uganda

- LOT 1 - MADI OKOLLO, TEREGO AND MOYO DISTRICTS

CONSTRUCTION OF GWERE RGC WATER SUPPLY AND SANITATION SYSTEM

Consultant:



Corporate Headqua 10 Philpot Lane, 1st Floor London EC3M 8AA, United Kingdom


Drawing Title:

RAPID GRAVITY FILTERS Section A-A

Scale:	Designed:	O.R Daniel	
	Drawn:	P.S Eyamu	
Date:	Checked:	O.R Daniel	
Dec-2022	Approved:	O.R Daniel	

ENGINEERING DESIGN DRAWING

Drg No: MWE/GWE/1.2.3 | Cad file No WSS<22_11>

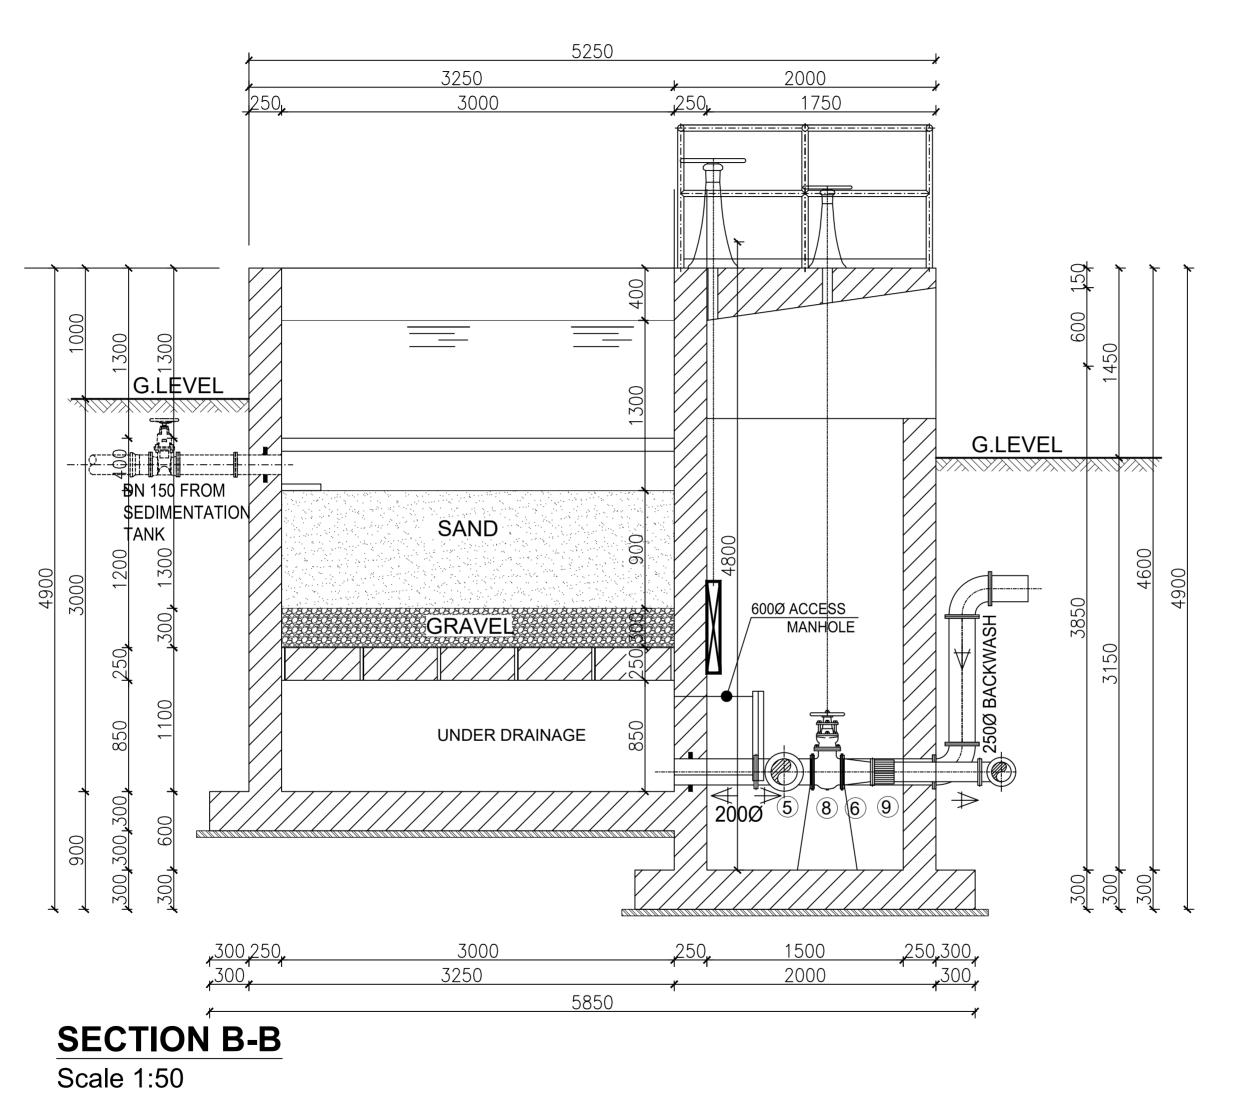

AM	AMENDMENTS	
No	Date	Revision
1	4.5.2024	Draft Design

- 1. 14No.DN150 Flanged Adaptor, Maxi type or similar.
- 2. 3No.DN150 All Equal Tee.
- 3. 2No.DN150 All Flanged Gate Valve.
- 4. 2No.DN150 All Flanged 90° bend.
- 5. 4No.DN200/250 Tee.
- 6. 2No.DN200 /150 taper.
- 7. 6No.DN200 All Flanged 90° bend.
- 8. 2No.DN200 All Flanged Gate Valve.
- 9. 15No.DN250 Flanged Adaptor, Maxi type or similar.
- 10. 2No.DN250 All Flanged Gate Valve.
- 11. 2No.DN200 Flanged Adaptor, Maxi type or similar.





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MINISTRY OF WATER AND ENVIRONMENT DIRECTORATE OF WATER DEVELOPMENT (DWD) RURAL WATER SUPPLY AND SANITATION DEPARTMENT Plot 3 - 7 Kabalega Crescent Road, Luzira, Box 20026 Kampala Tel : +256 417 889 400, Email: mwe@mwe.go.ug Website: www.rnwe.go.ug

PROJECT

Consultancy Services for the Feability Study, Detailed Engineering Design and Construction Supervision of Solar Powered Piped Water Supply Systems and Sanitation Facilities In Refugee Settlements and Host Districts In West Nile and Northern Uganda

- LOT 1 - MADI OKOLLO, TEREGO AND MOYO DISTRICTS

CONSTRUCTION OF GWERE RGC WATER SUPPLY AND SANITATION SYSTEM

Consultant:



10 Philpot Lane, 1st Floor London EC3M 8AA, United Kingdom


rawing Title:

RAPID GRAVITY FILTERS Section B-B

Scale:	Designed:	O.R Daniel
	Drawn:	P.S Eyamu
Date:	Checked:	O.R Daniel
Dec-2022	Approved:	O.R Daniel

ENGINEERING DESIGN DRAWING

Drg No: MWE/GWE/1.2.4 | Cad file No WSS<22_11>

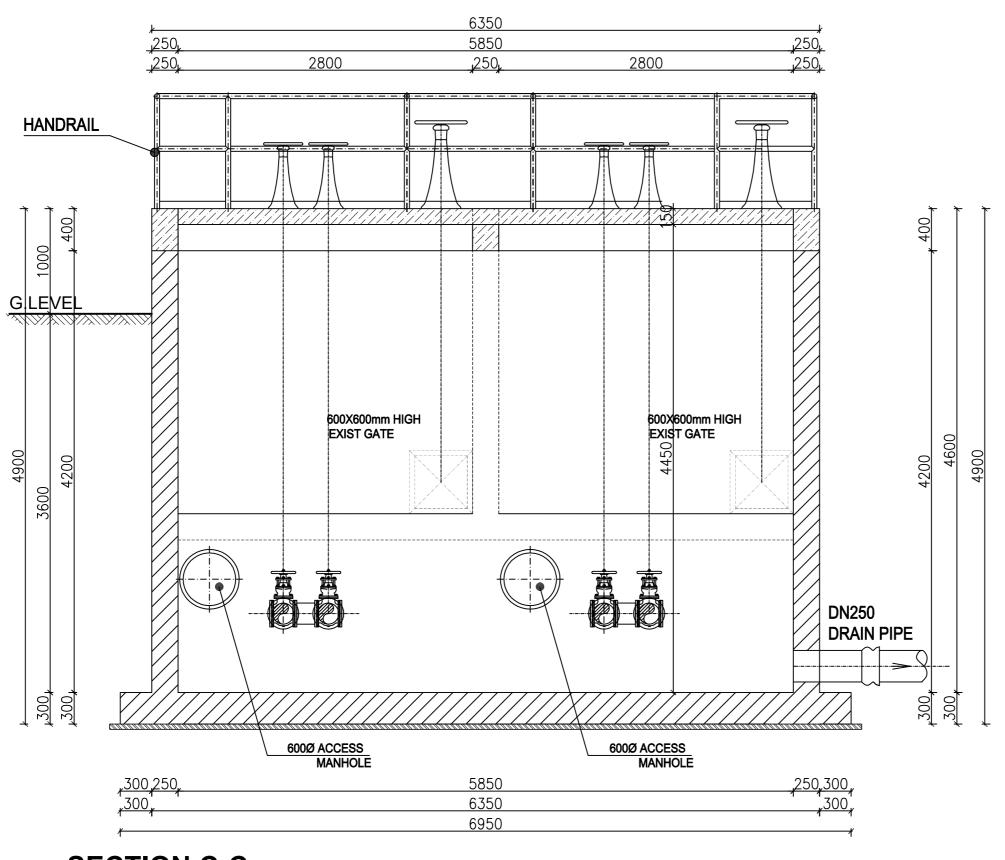

SECTION C-C

Scale 1:50

l	AMENDMENTS				
l	No	Date	Revision		
l	1	7.11.2023	23 Draft Design		
ı					
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NOTES

- 1. All dimensions are in metres unless stated otherwise.
- 2. All levels are in metres above sea level.
- 3. For Site location see Dwg. MWE/GWE/0.0.0
- 4. For Node details, see Dwg. MWE/GWE/5.0.0
- 5. All valves, hydrants and washout locations are identified by marker post in positions.

LEGEND



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MINISTRY OF WATER AND ENVIRONMENT DIRECTORATE OF WATER DEVELOPMENT (DWD) RURAL WATER SUPPLY AND SANITATION DEPARTMENT Plot 3 - 7 Kabalega Crescent Road, Luzira, Box 20026 Kampala Tel: +256 417 889 400, Emai: mwe@mwe.go.ug

Consultancy Services for the Feability Study, Detailed Engineering Design and Construction Supervision of Solar Powered Piped Water Supply Systems and Sanitation Facilities In Refugee Settlements and Host Districts In West Nile and Northern Uganda

- LOT 1 - MADI OKOLLO, TEREGO AND MOYO DISTRICTS -

CONSTRUCTION OF GWERE RGC WATER **SUPPLY AND SANITATION SYSTEM**

Consultant:




Drawing Title:

RAPID GRAVITY FILTERS Section C-C

Scale:	Designed:	O.R Daniel		
	Drawn:	P.S Eyamu		
Date:	Checked:	O.R Daniel		
Dec-2022	Approved:	O.R Daniel		
ENGINEERING DESIGN DRAWING				

Drg No: MWE/GWE/1.2.5 | Cad file No WSS<22_11>

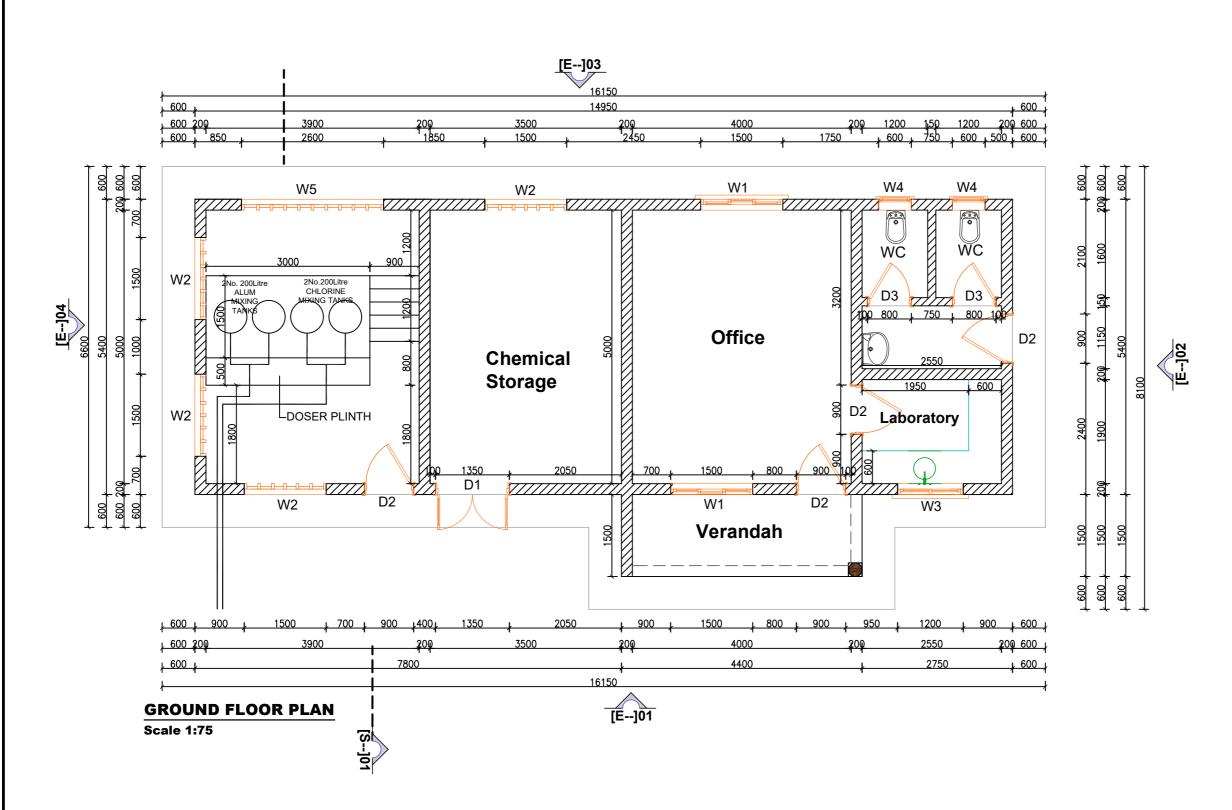

ı	AMENDMENTS			
l	No	Date	Revision	
l	1	7.8.2023	Draft Design	
l				
l				
l				

- 1. All dimensions are in metres unless stated otherwise.
- 2. All levels are in metres above sea level.
- 3. For Site location see Dwg. MWE/GWE/0.0.0

identified by marker post in positions.

4. For Node details, see Dwg. MWE/GWE/5.0.05. All valves, hydrants and washout locations are

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MINISTRY OF WATER AND ENVIRONMENT
DIRECTORATE OF WATER DEVELOPMENT (DWD)
RURAL WATER SUPPLY AND SANITATION DEPARTMENT
Plot 3 - 7 Kabalega Crescent Road, Luzira, Box 20026 Kampala
Tel: +256 417 889 400, Emai: mwe@mwe.go.ug
Website: www.mwe.go.ug

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Consultancy Services for the Feability Study, Detailed Engineering Design and Construction Supervision of Solar Powered Piped Water Supply Systems and Sanitation Facilities In Refugee Settlements and Host Districts In West Nile and Northern Uganda

- LOT 1 - MADI OKOLLO, TEREGO AND MOYO DISTRICTS

CONSTRUCTION OF GWERE RGC WATER SUPPLY AND SANITATION SYSTEM

Consultant:




Corporate Headquarter 10 Philpot Lane, 1st Floor, London EC3M 8AA, United Kingdom

Drawing Title:

CHEMICAL HOUSE AND OFFICE BLOCK
Ground Floor Plan

Scale:	Designed:	O.R Daniel		
	Drawn:	P.S Eyamu		
Date:	Checked:	O.R Daniel		
Dec-2022	Approved:	O.R Daniel		
ENGINEERING DESIGN DRAWING				

Drg No: MWE/GWE/1.4.1 | Cad file No WSS<22_11>

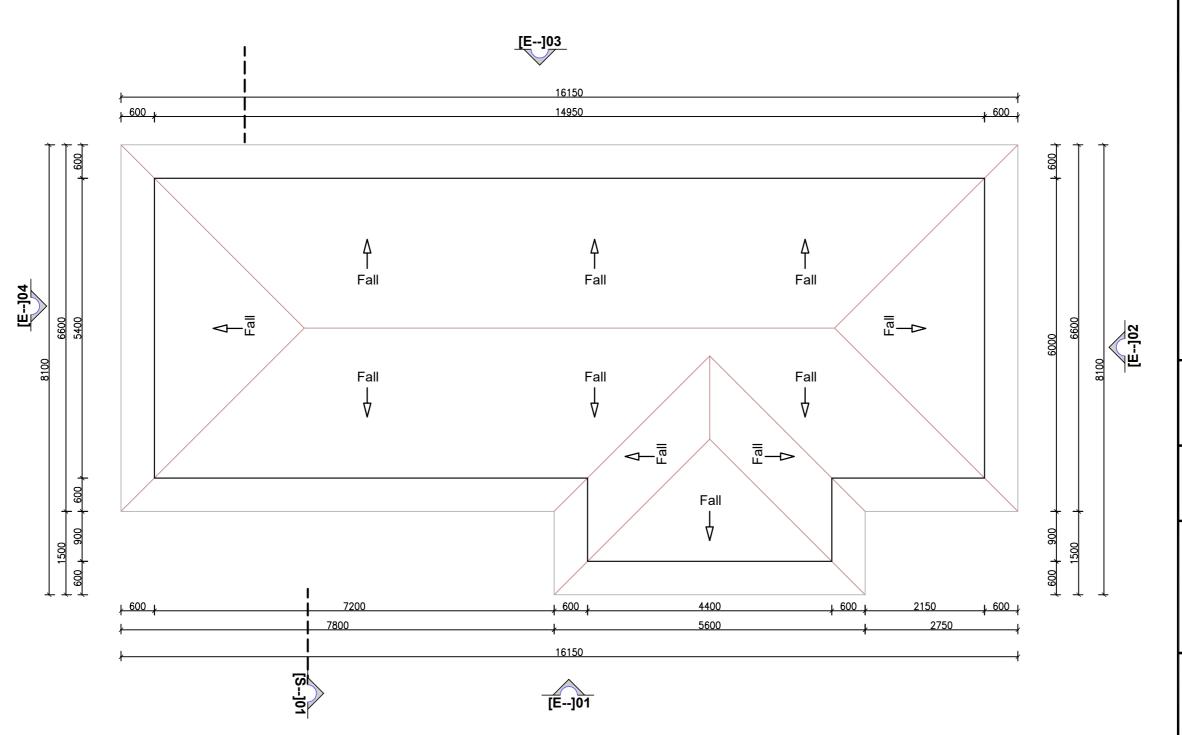

AM	AMENDMENTS		
No	Date	Revision	
1	7.8.2023	Draft Design	

- 1. All dimensions are in metres unless stated otherwise.
- 2. All levels are in metres above sea level.
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- 4. For Node details, see Dwg. MWE/GWE/5.0.05. All valves, hydrants and washout locations are identified by marker post in positions.

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MINISTRY OF WATER AND ENVIRONMENT DIRECTORATE OF WATER DEVELOPMENT (DWD) RURAL WATER SUPPLY AND SANITATION DEPARTMENT Plot 3 - 7 Kabalega Crescent Road, Luzira, Dox 20026 Kampala Tel: +256 417 889 400, Emai: mwe@mwe.go.ug

PROJECT

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- LOT 1 - MADI OKOLLO, TEREGO AND MOYO DISTRICTS -

CONSTRUCTION OF GWERE RGC WATER SUPPLY AND SANITATION SYSTEM

Consultant:




Corporate Headquarte 10 Philpot Lane, 1st Floor, London EC3M 8AA, United Kingdom

Drawing Title:

CHEMICAL HOUSE AND OFFICE BLOCK Roof Plan

Scale:	Desi	gned:	O.R Daniel
	Draw	/n:	P.S Eyamu
Date:	Chec	ked:	O.R Daniel
Dec-2022	Appı	roved:	O.R Daniel
ENGINEERI	NG DI	ESIGN	DRAWING
Drg No: MWE/GWE/1	1.4.2	Cad file I	No WSS<22_11>

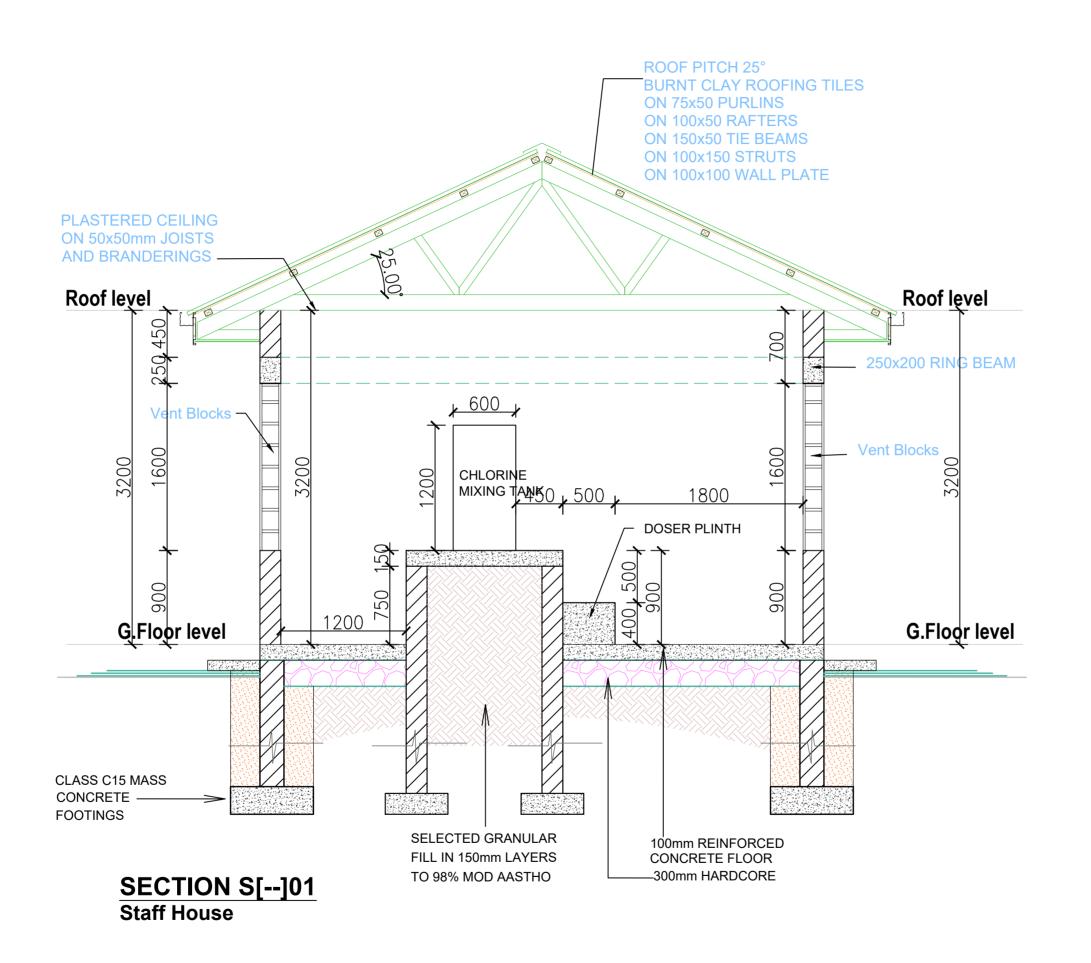

AMENDMENTS				
No	Date	Revision		
1	10.3.2023	Draft Design		

- 1. All dimensions are in metres unless stated otherwise.
- 2. All levels are in metres above sea level.
- 3. For Site location see Dwg. MWE/GWE/1.0.1

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DIRECTORATE OF WATER DEVELOPMENT (DWD)
RURAL WATER SUPPLY AND SANITATION DEPARTMENT
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Tel: +256 417 889 400, Email: mwe@mwe.go.ug
Website: www.mwe.go.ug

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Consultancy Services for the Feability Study, Detailed Engineering Design and Construction Supervision of Solar Powered Piped Water Supply Systems and Sanitation Facilities In Refugee Settlements and Host Districts In West Nile and Northern Uganda

- LOT 1 - MADI OKOLLO, TEREGO AND MOYO DISTRICTS

CONSTRUCTION OF GWERE RGC WATER SUPPLY AND SANITATION SYSTEM

Consultant:



Corporate Headquarto 10 Philpot Lane, 1st Floor, London EC3M 8AA, United Kingdom


Drawing Title:

CHEMICAL HOUSE AND OFFICE BLOCK Section S[01]

d: O.R Daniel
P.S Eyamu
d: O.R Daniel
ed: O.R Daniel

ENGINEERING DESIGN DRAWING

Drg No: MWE/GWE/1.4.3 | Cad file No WSS<22_11>

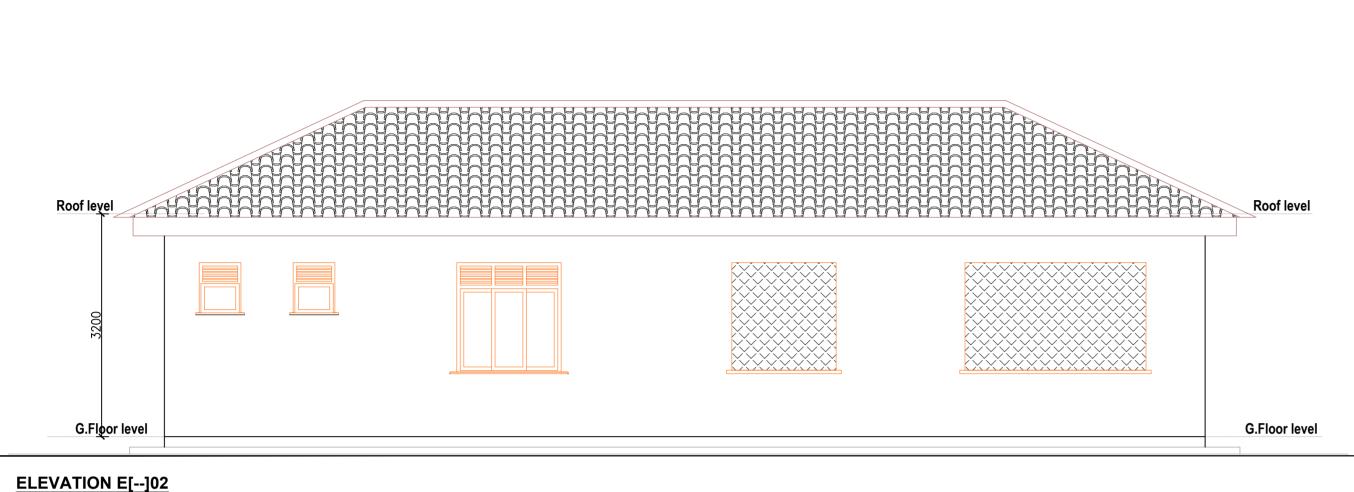

AMENDMENTS No Date 10.4.2023 Draft Design

- 1. All dimensions are in metres unless stated otherwise.
- 2. All levels are in metres above sea level.
- 3. For Site location see Dwg. MWE/GWE/1.0.1

LEGEND



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MINISTRY OF WATER AND ENVIRONMENT DIRECTORATE OF WATER DEVELOPMENT (DWD)
RURAL WATER SUPPLY AND SANITATION DEPARTMENT
Plot 3 - 7 Kabalega Crescent Road, Luzira, Box 20026 Kampala
Tel : +256 417 898 400, Email: mwe@mwe.go.ug
Website: www.mwe.go.ug

Consultancy Services for the Feability Study, Detailed Engineering Design and Construction Supervision of Solar Powered Piped Water Supply Systems and Sanitation Facilities In Refugee Settlements and Host Districts In West Nile and Northern Uganda

- LOT 1 - MADI OKOLLO, TEREGO AND MOYO DISTRICTS -

CONSTRUCTION OF GWERE RGC WATER SUPPLY AND SANITATION SYSTEM

Consultant:



SGAP

10 Philpot Lane, 1st Floor London EC3M 8AA,

CHEMICAL HOUSE AND OFFICE BLOCK Elevation_[L01] and Elevation L[02]

S	cale:	Designed:	O.R Daniel
		Drawn:	P.S Eyamu
	Date:	Checked:	O.R Daniel
	Sep-2023	Approved:	O.R Daniel

ENGINEERING DESIGN DRAWING


Drg No: MWE/GWE/1.4.4 Cad file No WSS<22_11>

Roof level Roof level G.Floor level **G.Floor level**

ELEVATION E[--]01


Staff House

Staff House

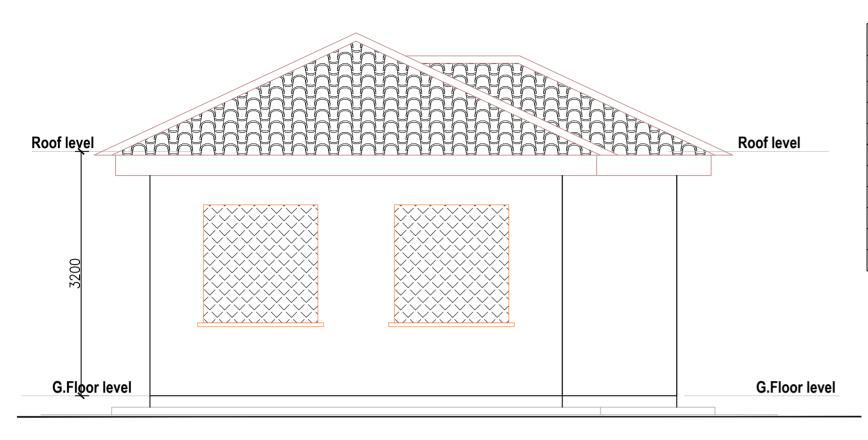

DOOR SCHEDULE						
MARK	WIDTH	HEIGHT	No.	DESCRIPTION		
D1	1300	2500	01	DOUBLE LEAF STEEL CASEMENT DOORS		
D2	900	2500	04	SINGLE LEAF HARDWOOD TIMBER DOORS		
D3	800	2500	02	SOLID FLUSH TIMBER DOORS		
WINDOW SCHEDULE						
W1	1500	1600	02	STEEL CASEMENT WINDOWS		
W2	1500	1600	04	POMPEY GRILL FILLED OPENING		
W3	1200	1600	01	STEEL CASEMENT WINDOWS		
W4	600	900	02	TOP HUNG WINDOW		
W5	2600	1600	01	POMPEY GRILL FILLED OPENING		

ELEVATION E[--]04 Staff House

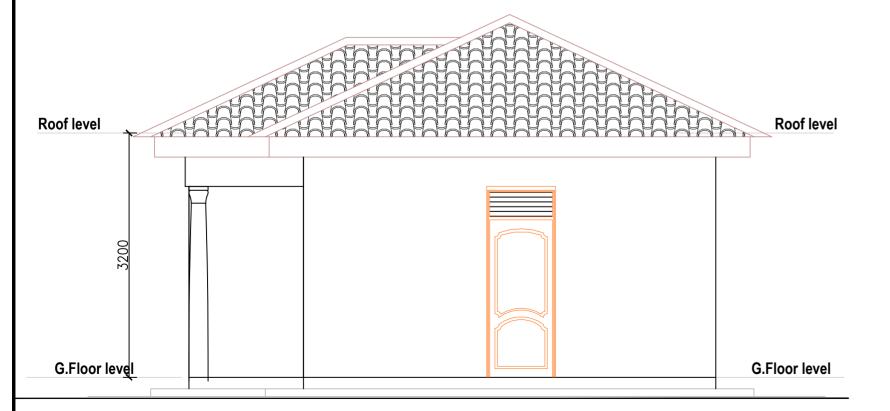

ELEVATION E[--]03
Staff House

AMENDMENTS		
No	Date	Revision
1	10.3.2023	Draft Design

NOTES

- 1. All dimensions are in metres unless stated otherwise.
- 2. All levels are in metres above sea level.
- 3. For Site location see Dwg. MWE/GWE/1.0.1

LEGEND



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MINISTRY OF WATER AND ENVIRONMENT
DIRECTORATE OF WATER DEVELOPMENT (DWD)
RURAL WATER SUPPLY AND SANITATION DEPARTMENT
Plot 3 - 7 Kabalega Crescent Road, Luzira, Box 20026 Kampala
Tel: +256 417 889 400, Email: mwe@mwe.go.ug

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ROJECT

Consultancy Services for the Feability Study, Detailed Engineering Design and Construction Supervision of Solar Powered Piped Water Supply Systems and Sanitation Facilities In Refugee Settlements and Host Districts In West Nile and Northern Uganda

- LOT 1 - MADI OKOLLO, TEREGO AND MOYO DISTRICTS -

CONSTRUCTION OF GWERE RGC WATER SUPPLY AND SANITATION SYSTEM

Consultant:



Corporate Headquarter 0 Philpot Lane, 1st Floor, ondon EC3M 8AA, Jnited Kingdom


Drawing Title:

CHEMICAL HOUSE AND OFFICE BLOCK Elevation_[L03] and Elevation L[04]

Scale:	Designed:	O.R Daniel		
	Drawn:	P.S Eyamu		
Date:	Checked:	O.R Daniel		
Sep-2023	Approved:	O.R Daniel		
ENCINEEDING DESIGN DRAWING				

ENGINEERING DESIGN DRAWING

Drg No: MWE/GWE/1.4.5 | Cad file No WSS<22_11>

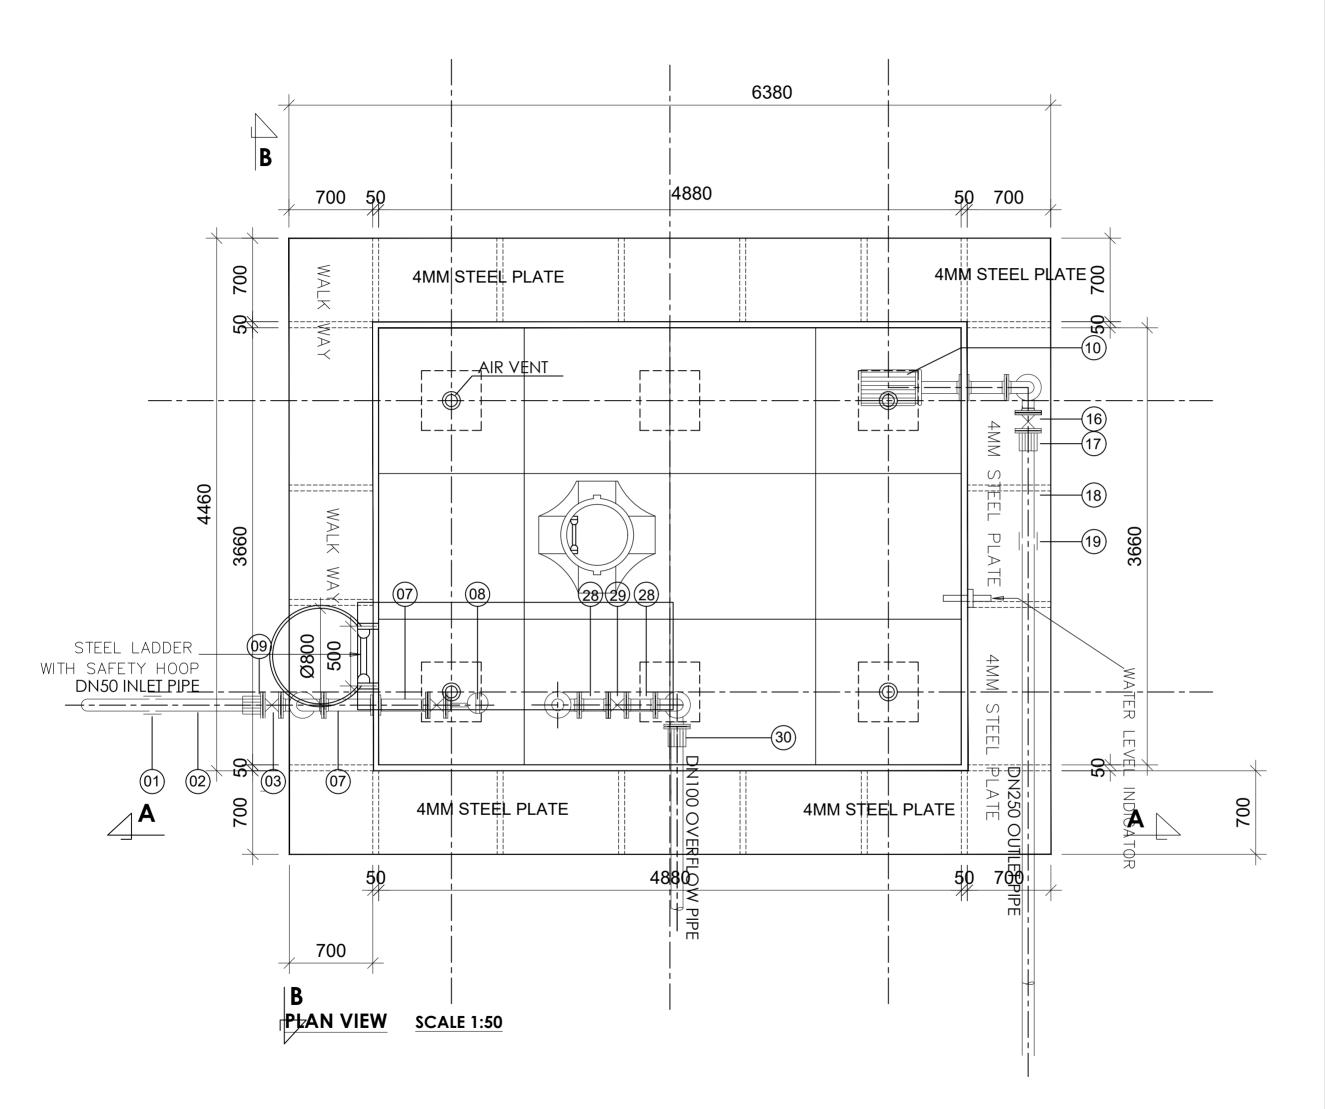

	AMENDMENTS		
No Date Revision		Revision	
	1	10.3.2023	Draft Design

- 1. 1No.DN50Vicking Johnson or Similar Coupling.
- 2. 1No.DN50 Pipe not exceeding 2.0m.
- 3. 1No.DN50 All Flanged Gate Valve.
- 4. 1No.DN50 All Flanged Duck foot 90° bend.
- 5. 3No.DN50 Double Flanged Pipe not exceeding 6.0m.
- 6. 1No.DN50 All Flanged 90° bend.
- 7. 2No.DN50 Double Flanged Pipe not exceeding 0.6m.
- 8. 1No.DN50 Flanged Ball Float Valve.
- 9. 1No.DN50 Flanged Adaptor,Maxi type or similar.
- 10. 1No.DN250 Flanged Outlet Pipe Strainer.
- 11. 2No.DN250 Double Flanged Pipe not exceeding 0.6m.
- 12. 1No.DN250 All Flanged 90° bend.
- 13. 2No.DN250 Double Flanged Pipe not exceeding 6.0m.
- 14. 1No.DN250 Double Flanged Pipe not exceeding 2.0m.
- 15. 1No.DN250 All Flanged Duck foot 90° bend.
- 16. 1No.DN250 Flanged Gate Valve.
- 17. 1No.DN250 Flanged Adaptor, Maxi type or similar.
- 18. 1No.DN100 Flanged Adaptor,Maxi type or similar.
- 19. 1No.DN250 Vicking Johnson or Similar Coupling. 20. 1No.DN100 Flanged Bell Mouth.
- 21. 1No.DN100 Double Flanged Pipe not exceeding 2.8m.
- 22. 1No.DN100 Double Flanged Pipe not exceeding 2.0m.
- 23. 1No.DN50/100 All Flanged Tee.
- 24. 2No.DN100 Double Flanged Pipe not exceeding 6.0m.
- 25. 1No.DN100 All Flanged Duck foot 90° bend.
- 26. 1No.DN50 All Flanged Pipe with puddle flange n.e 2.0m.
- 27. 1No.DN50 All Flanged 90° bend. 28. 2No.DN50 Double Flanged Pipe not exceeding 0.4m.
- 29. 1No.DN50 Flanged Gate Valve.





MINISTRY OF WATER AND ENVIRONMENT DIRECTORATE OF WATER DEVELOPMENT (DWD)
RURAL WATER SUPPLY AND SANITATION DEPARTMENT
Plot 3 - 7 Kabalega Crescent Road, Luzira, Box 20026 Kampala
Tel: +256 417 889 400, Email: mwe@mwe.go.ug
Website: www.mwe.go.ug

Consultancy Services for the Feability Study, Detailed Engineering Design and Construction Supervision of Solar Powered Piped Water Supply Systems and Sanitation Facilities In Refugee Settlements and Host Districts In West Nile and Northern Uganda

- LOT 1 - MADI OKOLLO, TEREGO AND MOYO DISTRICTS -

CONSTRUCTION OF GWERE RGC WATER SUPPLY AND SANITATION SYSTEM

Consultant:




Corporate Headquarter

Drawing Title:

62.3m3 BACKWASH AND SERVICE TANK Top Plan

Scale:	Designed:	O.R Daniel	
	Drawn:	P.S Eyamu	
Date:	Checked:	O.R Daniel	
Jul-2023	Approved:	O.R Daniel	
ENGINEERING DESIGN DRAWING			

Drg No: MWE/GWE/1.5.1 Cad file No WSS<22_11>

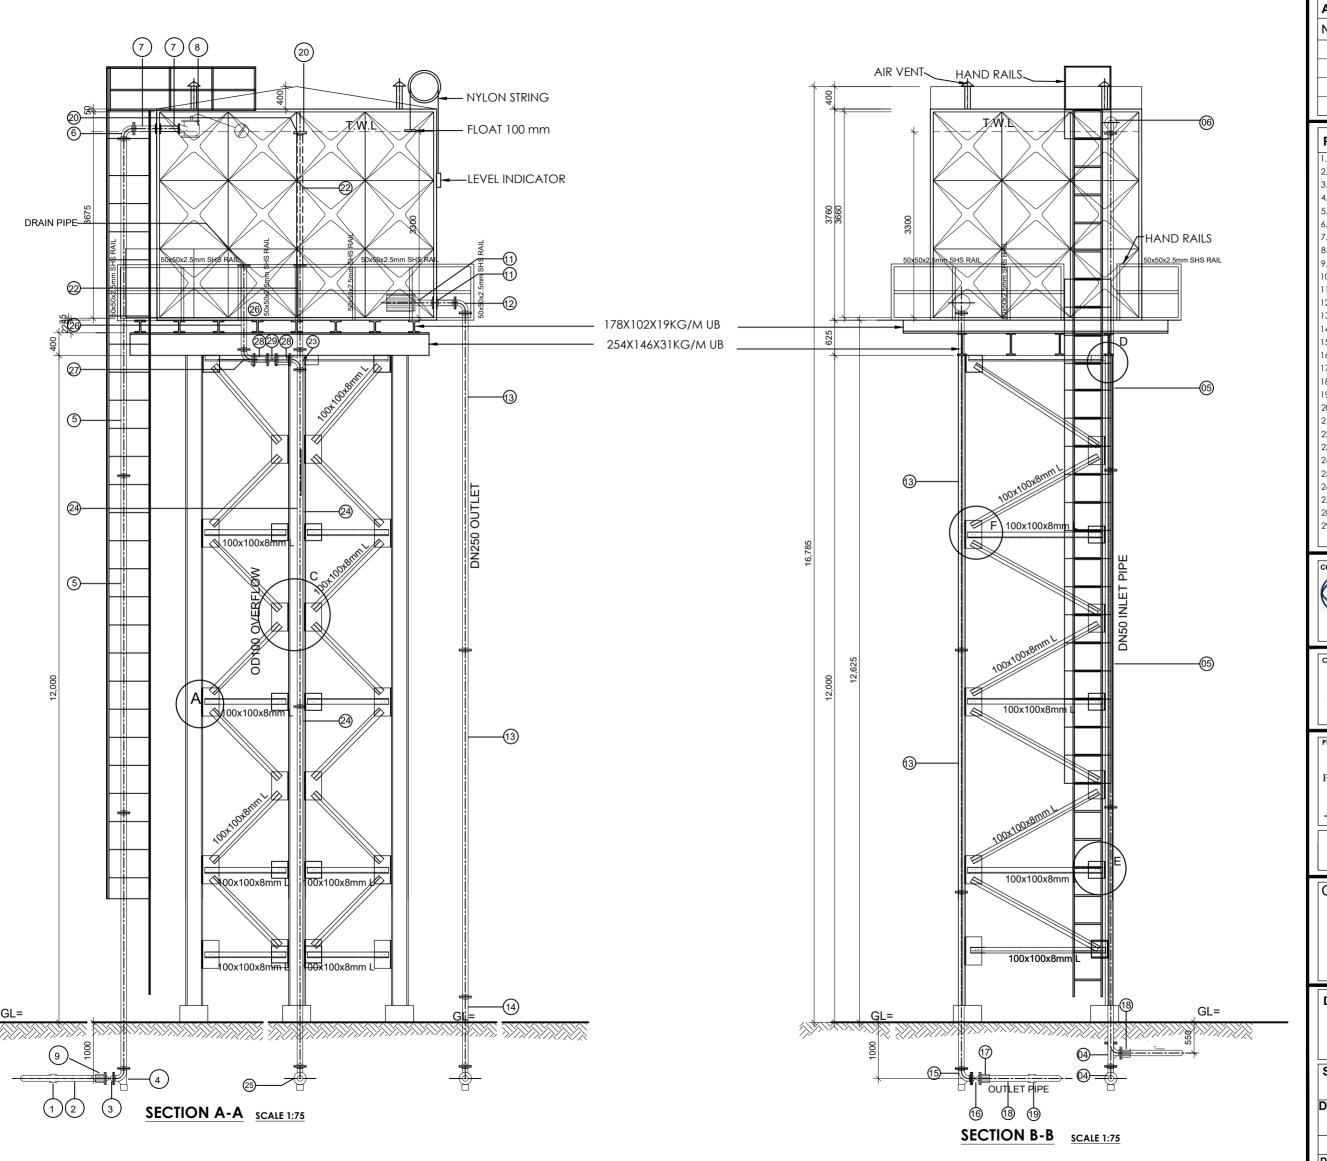

ı	AM	AMENDMENTS			
ı	No	Date	Revision		
ı	1	10.3.2023	Draft Design		
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- . 1No.DN50Vicking Johnson or Similar Coupling.
- 2. 1No.DN50 Pipe not exceeding 2.0m.
- 3. 1No.DN50 All Flanged Gate Valve.
- 4. 1No.DN50 All Flanged Duck foot 90° bend.
- 5. 3No.DN50 Double Flanged Pipe not exceeding 6.0m.
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- 14. 1No.DN250 Double Flanged Pipe not exceeding 2.0m.
- 15. 1No.DN250 All Flanged Duck foot 90° bend.
- 16. 1No.DN250 Flanged Gate Valve
- 17. 1No.DN250 Flanged Adaptor, Maxi type or similar.
- 18. 1No.DN100 Flanged Adaptor, Maxi type or similar.
- 19. 1No.DN250 Vicking Johnson or Similar Coupling.
- 20. 1No.DN100 Flanged Bell Mouth.
- 21. 1No.DN100 Double Flanged Pipe not exceeding 2.8m.
- 22. 1No.DN100 Double Flanged Pipe not exceeding 2.0m.
- 23. 1No.DN50/100 All Flanged Tee.
- 24. 2No.DN100 Double Flanged Pipe not exceeding 6.0m.
- 25. 1No.DN100 All Flanged Duck foot 90° bend. 26. 1No.DN50 All Flanged Pipe with puddle flange n.e 2.0m.
- 27. 1No.DN50 All Flanged 90° bend.
- 28. 2No.DN50 Double Flanged Pipe not exceeding 0.4m.
- 29. 1No.DN50 Flanged Gate Valve.





MINISTRY OF WATER AND ENVIRONMENT DIRECTORATE OF WATER DEVELOPMENT (DWD)
RURAL WATER SUPPLY AND SANITATION DEPARTMENT
Plot 3 - 7 Kabalega Crescent Road, Luzira, Box 20026 Kampala
Tel: +256 417 889 400, Email: mwe@mwe.go.ug
Website: www.mwe.go.ug

Consultancy Services for the Feability Study, Detailed Engineering Design and Construction Supervision of Solar Powered Piped Water Supply Systems and Sanitation Facilities In Refugee Settlements and Host Districts In West Nile and Northern Uganda

- LOT 1 - MADI OKOLLO, TEREGO AND MOYO DISTRICTS -

CONSTRUCTION OF GWERE RGC WATER SUPPLY AND SANITATION SYSTEM

Consultant:




Corporate Headquarter


62.3m³ BACKWASH AND SERVICE TANK Sections and Details


Scale:	Designed:	O.R Daniel
	Drawn:	P.S Eyamu
Date:	Checked:	O.R Daniel
Jul-2023	Approved:	O.R Daniel


ENGINEERING DESIGN DRAWING

Drg No: MWE/GWE/1.5.2 Cad file No WSS<22_11>

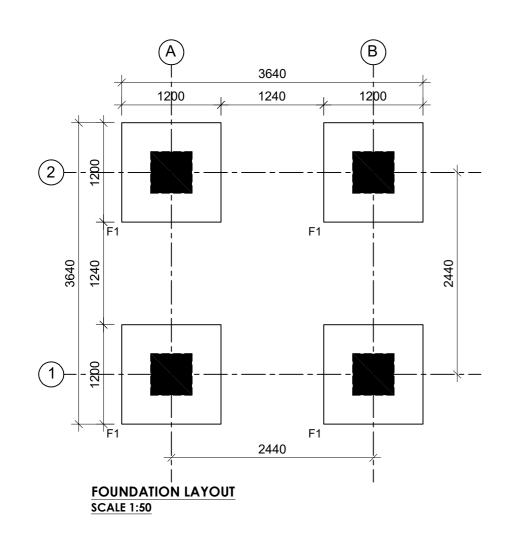

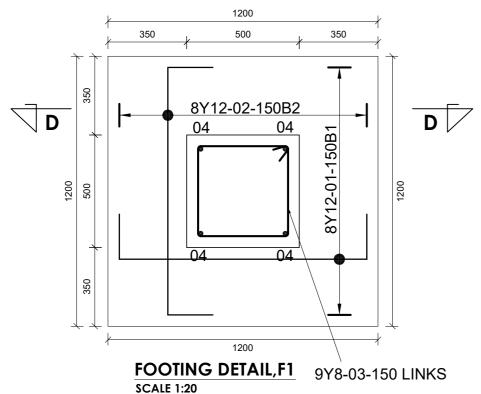

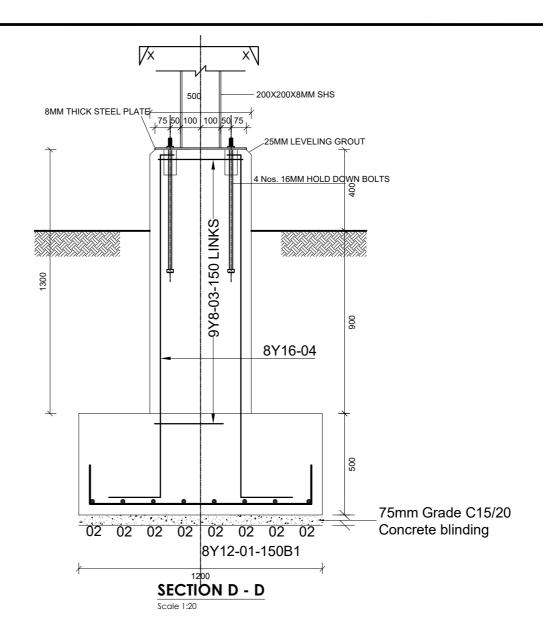

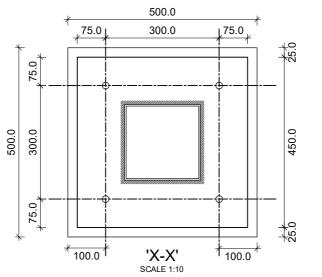

ΑN	AMENDMENTS		
No	Date	Revision	
1	7.30.2023	Draft Design	

- 1. All dimensions are in metres unless stated otherwise.
- 2. All levels are in metres above sea level.
- 3. For Site location see Dwg. MWE/GWE/0.0.0
- 4. For Node details, see Dwg. MWE/GWE/5.0.0
- 5. All valves, hydrants and washout locations are identified by marker post in positions.

LEGEND





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MINISTRY OF WATER AND ENVIRONMENT DIRECTORATE OF WATER DEVELOPMENT (DWD) RURAL WATER SUPPLY AND SANITATION DEPARTMENT Plot 3 - 7 Kabalega Crescent Road, Luzira, Box 20026 Kampala Tel: +2564 17889 400, Email: mww@mwe.go.ug

Consultancy Services for the Feability Study, Detailed Engineering Design and Construction Supervision of Solar Powered Piped Water Supply Systems and Sanitation Facilities In Refugee Settlements and Host Districts In West Nile and Northern Uganda

- LOT 1 - MADI OKOLLO, TEREGO AND MOYO DISTRICTS -

CONSTRUCTION OF GWERE RGC WATER SUPPLY AND SANITATION SYSTEM

Consultant:



Corporate Headquarter 10 Philpot Lane, 1st Floor, London EC3M 8AA,


Drawing Title:

62.3M3 BACKWASH AND SERVICE TANK Foundation layout and Details

Scale:	Designed:	O.R Daniel
	Drawn:	P.S Eyamu
Date:	Checked:	O.R Daniel
Jul-2023	Approved:	O.R Daniel

ENGINEERING DESIGN DRAWING

Drg No: MWE/GWE/1.5.3 Cad file No WSS<22_11>

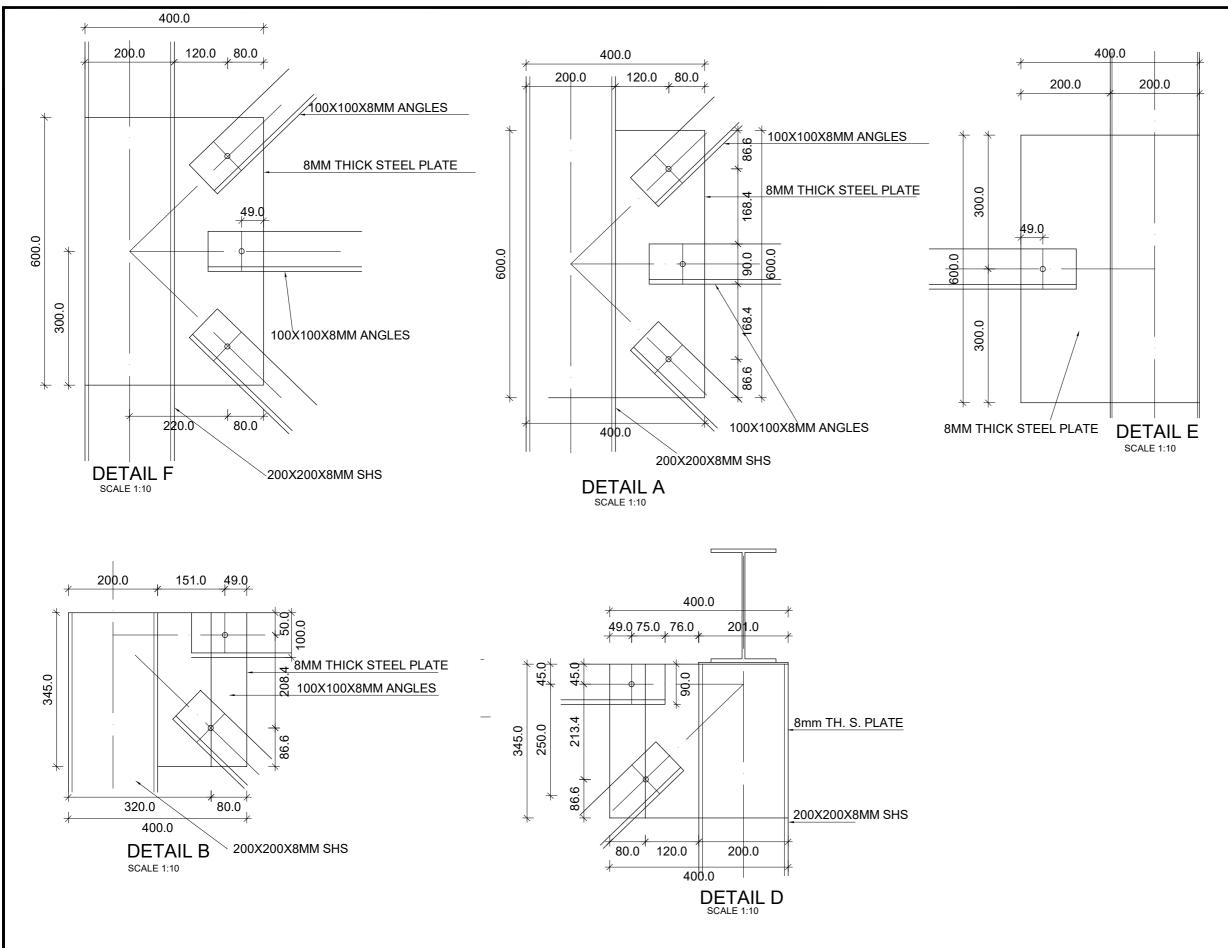

П	AMENDMENTS		
ı	No	Date	Revision
П	1	7.30.2023	Draft Design
П			
П			

- 1. All dimensions are in metres unless stated otherwise.
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LEGEND





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MINISTRY OF WATER AND ENVIRONMENT DIRECTORATE OF WATER DEVELOPMENT (DWD) RURAL WATER SUPPLY AND SANITATION DEPARTMENT Plot 3 - 7 Kabalega Crescent Road, Luzira, Box 20026 Kampala Tel: +256 417 889 400, Email: mwe@mwe.go.ug

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CONSTRUCTION OF GWERE RGC WATER SUPPLY AND SANITATION SYSTEM

Consultant:



Corporate Headquarter 10 Philpot Lane, 1st Floor, London EC3M 8AA, United Kingdom


Drawing Title:

62.3M³ BACKWASH AND SERVICE TANK Steel Connection Details

Scale:	Designed:	O.R Daniel
	Drawn:	P.S Eyamu
Date:	Checked:	O.R Daniel
Jul-2023	Approved:	O.R Daniel

ENGINEERING DESIGN DRAWING

Drg No: MWE/GWE/1.5.4 Cad file No WSS<22_11>

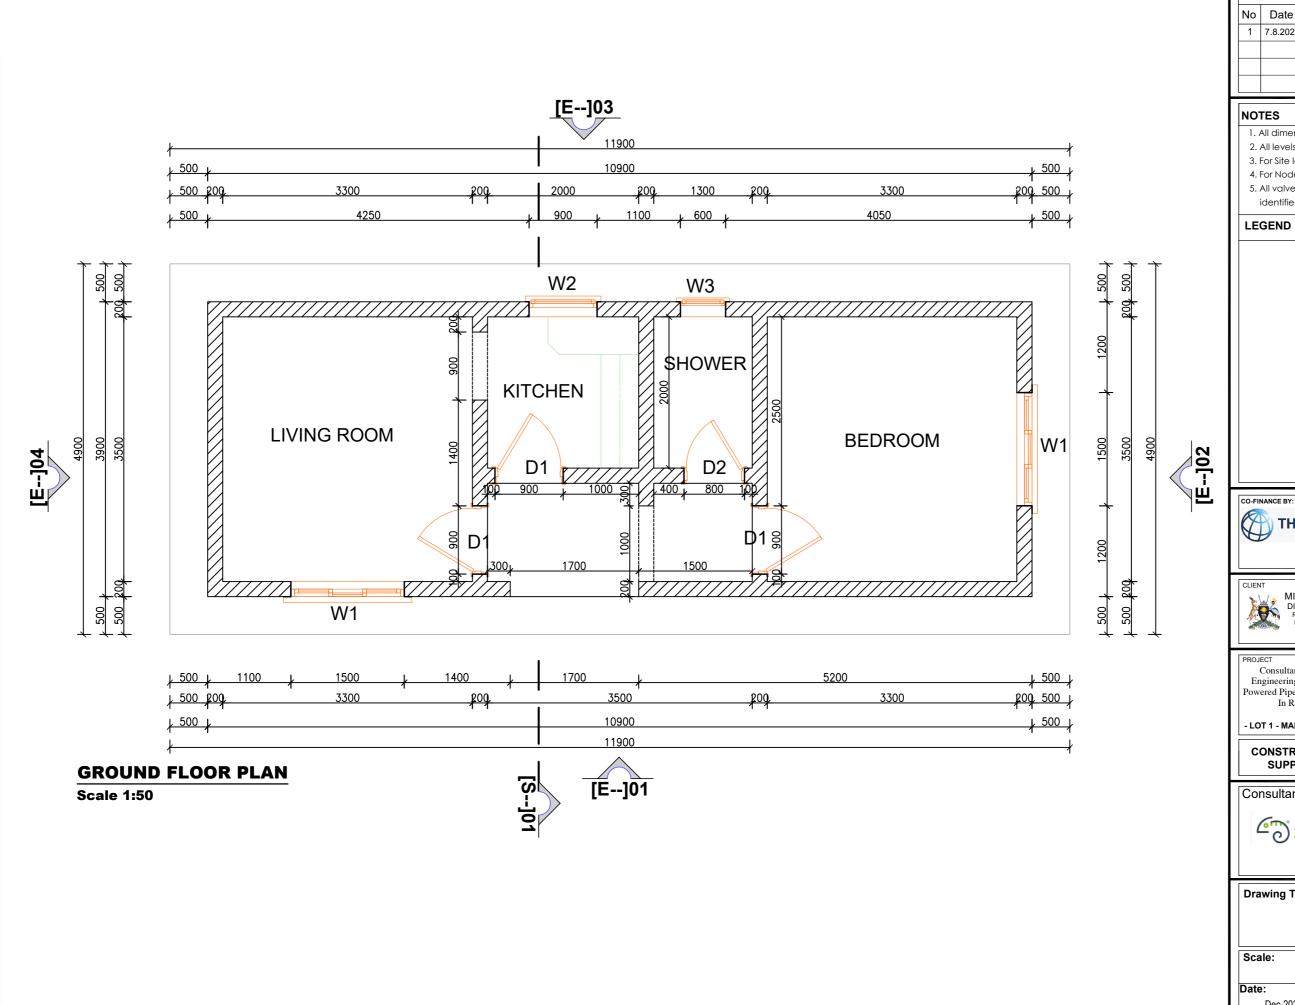

AM	AMENDMENTS		
No	Date	Revision	
1	7.8.2023	Draft Design	

- 1. All dimensions are in metres unless stated otherwise.
- 2. All levels are in metres above sea level.
- 3. For Site location see Dwg. MWE/GWE/0.0.0
- 4. For Node details, see Dwg. MWE/GWE/5.0.0 5. All valves, hydrants and washout locations are
- identified by marker post in positions.





GOVERNMENT OF UGANDA



MINISTRY OF WATER AND ENVIRONMENT
DIRECTORATE OF WATER DEVELOPMENT (DWD)
RURAL WATER SUPPLY AND SANITATION DEPARTMENT
Plot 3 - 7 Kabalega Crescent Road, Luzira, Box 20026 Kampala
Tel: +256 417 889 400, Email: mwe@mwe.go.ug
Website: www.mwe.go.ug

Consultancy Services for the Feability Study, Detailed Engineering Design and Construction Supervision of Solar Powered Piped Water Supply Systems and Sanitation Facilities In Refugee Settlements and Host Districts In West Nile and Northern Uganda

- LOT 1 - MADI OKOLLO, TEREGO AND MOYO DISTRICTS -

CONSTRUCTION OF GWERE RGC WATER **SUPPLY AND SANITATION SYSTEM**

Consultant:




Drawing Title:

STAFF HOUSE Ground Floor Plan

	1		
Scale:	Designed:	O.R Daniel	
	Drawn:	P.S Eyamu	
Date:	Checked:	O.R Daniel	
Dec-2022	Approved:	O.R Daniel	
ENGINEEDING DESIGN DRAWING			

ENGINEERING DESIGN DRAWING

Drg No: MWE/GWE/1.6.1 | Cad file No WSS<22_11>

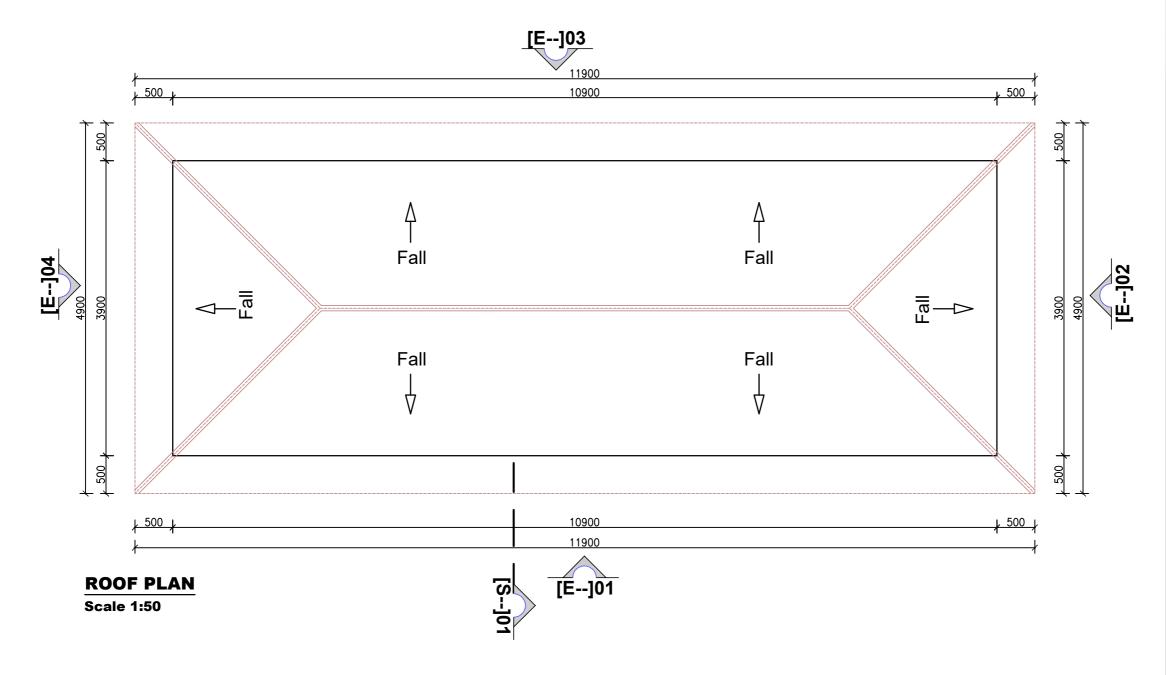

AM	AMENDMENTS		
No	Date	Revision	
1	7.8.2023	Draft Design	

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- 4. For Node details, see Dwg. MWE/GWE/5.0.0 5. All valves, hydrants and washout locations are identified by marker post in positions.

LEGEND





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MINISTRY OF WATER AND ENVIRONMENT DIRECTORATE OF WATER DEVELOPMENT (DWD) RURAL WATER SUPPLY AND SANITATION DEPARTMENT Plot 3 - 7 Kabalega Crescent Road, Luzira, Dec 20026 Kampala Tel: +256 417 889 400, Emai: mwe@mwe.go.ug

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West Nile and Northern Uganda

- LOT 1 - MADI OKOLLO, TEREGO AND MOYO DISTRICTS -

CONSTRUCTION OF GWERE RGC WATER SUPPLY AND SANITATION SYSTEM

Consultant:




Corporate Headquarts 10 Philpot Lane, 1st Floor, London EC3M 8AA,

Drawing Title:

STAFF HOUSE Roof Plan

Scale:	Designed:	O.R Daniel	
	Drawn:	P.S Eyamu	
Date:	Checked:	O.R Daniel	
Dec-2022	Approved:	O.R Daniel	
ENGINEERING DESIGN DRAWING			

Drg No: MWE/GWE/1.6.2 | Cad file No WSS<22_11>

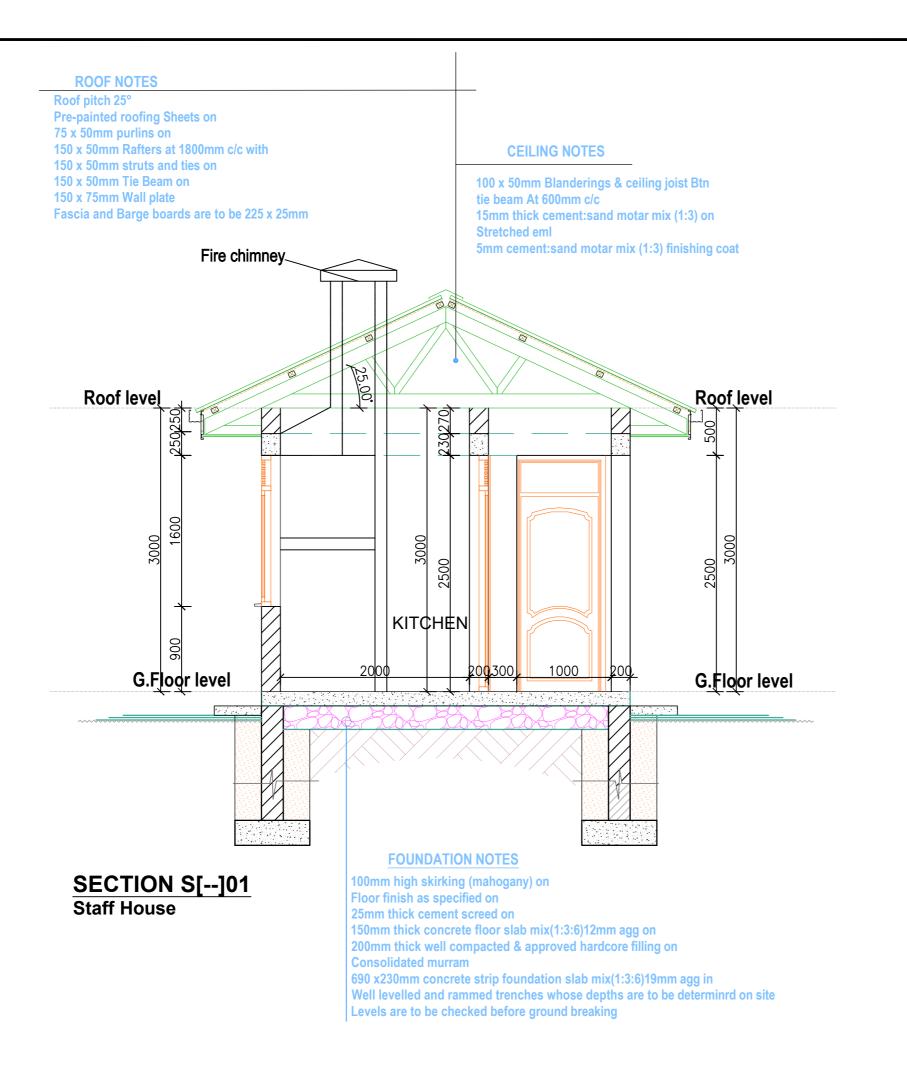

AMENDMENTS

No Date Revision

1 7.8.2023 Draft Design

NOTES

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- 3. For Site location see Dwg. MWE/GWE/0.0.0
- 4. For Node details, see Dwg. MWE/GWE/5.0.05. All valves, hydrants and washout locations are
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LEGEND





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MINISTRY OF WATER AND ENVIRONMENT
DIRECTORATE OF WATER DEVELOPMENT (DWD)
RURAL WATER SUPPLY AND SANITATION DEPARTMENT
Plot 3 - 7 Kabalega Crescent Road, Luzira, Box 20026 Kampala
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Website: www.mwe.go.ug

PROJECT

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- LOT 1 - MADI OKOLLO, TEREGO AND MOYO DISTRICTS -

CONSTRUCTION OF GWERE RGC WATER SUPPLY AND SANITATION SYSTEM

Consultant:



Corporate Headquarter 10 Philpot Lane, 1st Floor, London EC3M 8AA, United Kingdom


Drawing Title:

STAFF HOUSE Section S[01]

Scale:	Designed:	O.R Daniel	
	Drawn:	P.S Eyamu	
Date:	Checked:	O.R Daniel	
Dec-2022	Approved:	O.R Daniel	
ENGINEEDING DESIGN DRAWING			


ENGINEERING DESIGN DRAWING

Drg No: MWE/GWE/1.6.3 | Cad file No WSS<22_11>

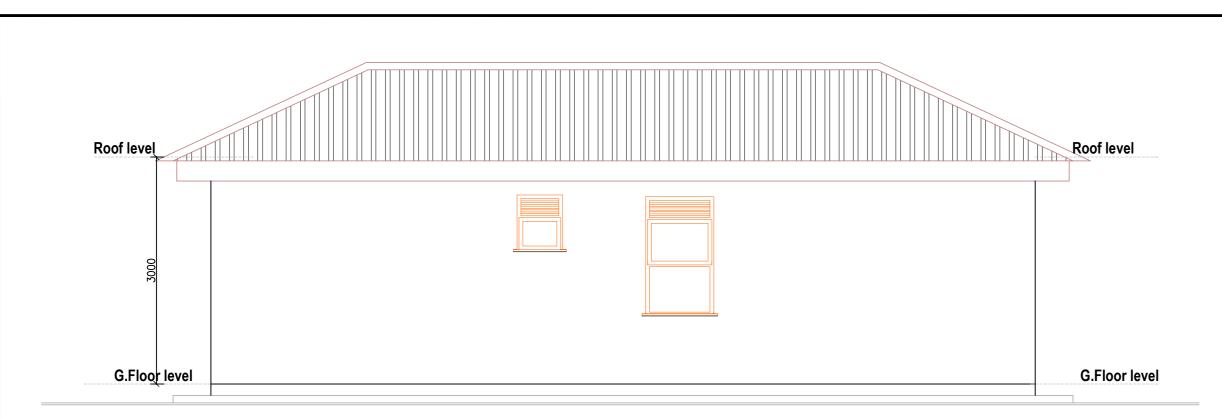

ELEVATION E[--]03

Staff House

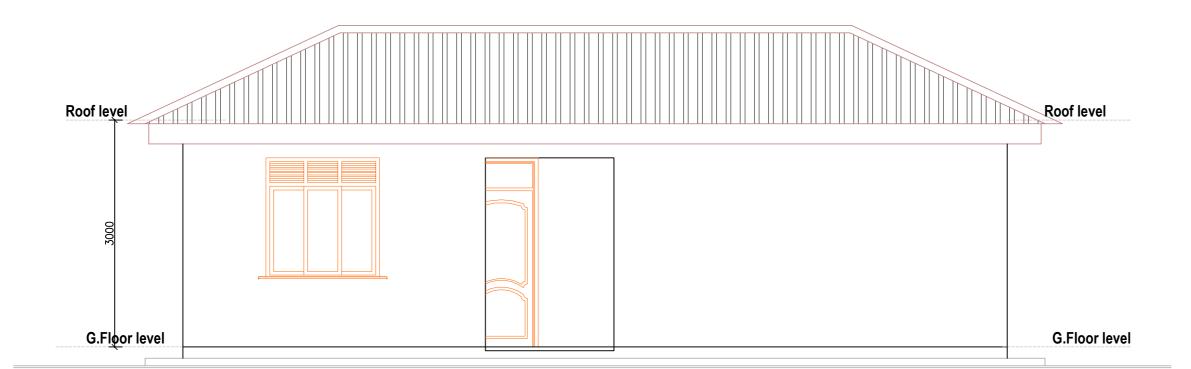

ELEVATION E[--]01 Staff House

AM	MENDMENTS			
No	Date	Revision		
1	7.8.2023	Draft Design		

NOTES

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- 3. For Site location see Dwg. MWE/GWE/0.0.0
- 4. For Node details, see Dwg. MWE/GWE/5.0.0
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LEGEND





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MINISTRY OF WATER AND ENVIRONMENT DIRECTORATE OF WATER DEVELOPMENT (DWD) RURAL WATER SUPPLY AND SANITATION DEPARTMENT Plot 3 - 7 Kabalega Crescent Road, Luzira, Box 20026 Kampala Tel: +256 417 889 400, Emai: mwe@mwe.go.ug

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- LOT 1 - MADI OKOLLO, TEREGO AND MOYO DISTRICTS -

CONSTRUCTION OF GWERE RGC WATER **SUPPLY AND SANITATION SYSTEM**

Consultant:




10 Philpot Lane, 1st Floor, London EC3M 8AA,

Drawing Title:

STAFF HOUSE Elevation_[L01] and Elevation L[02]

Scale:	Designed:	O.R Daniel	
	Drawn:	P.S Eyamu	
Date:	Checked:	O.R Daniel	
Dec-2022	Approved:	O.R Daniel	
ENGINEERING DESIGN DRAWING			

Drg No: MWE/GWE/1.6.4 | Cad file No WSS<22_11>

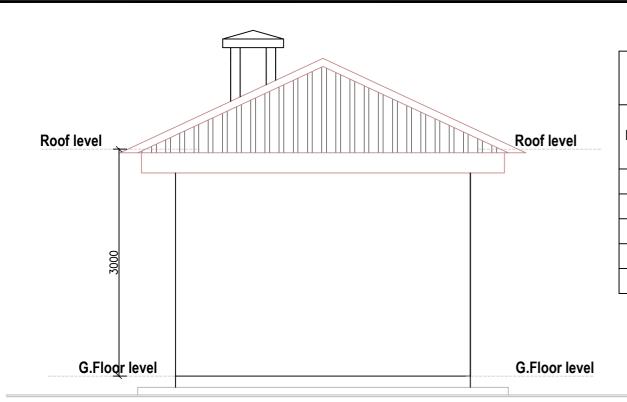

DOORS AND WINDOWS SCHEDULE


		DIMENSIONS			
NOTATION	NO	HEIGHT (mm)	WIDTH (mm)	REMARKS	
D1	3	900	2500	Framed Ledge batten doors with PVO	
D2	1	800	2500	Solid flush door with PVO	
W1	2	1500	1600	Steel casement window with PVO	
W2	1	600	900	Steel casement window with PVO	
W3	1	900	1600	Steel casement window with PVO	

AMENDMENTS Date Revision 1 7.8.2023 Draft Design

NOTES

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- 4. For Node details, see Dwg. MWE/GWE/5.0.0
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ELEVATION E[--]04 Staff House

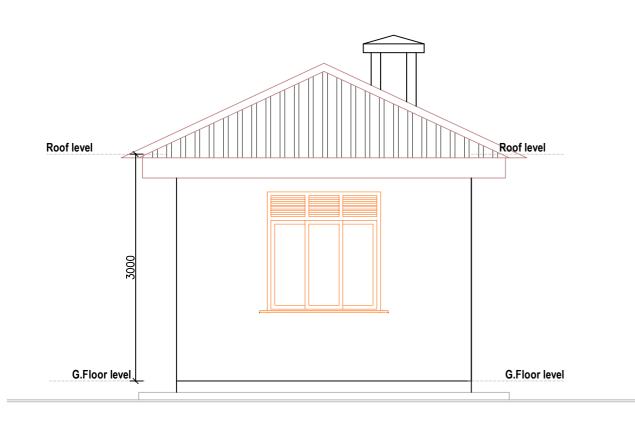

ELEVATION E[--]02

Staff House



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- LOT 1 - MADI OKOLLO, TEREGO AND MOYO DISTRICTS -

CONSTRUCTION OF GWERE RGC WATER **SUPPLY AND SANITATION SYSTEM**

Consultant:




10 Philpot Lane, 1st Floor, London EC3M 8AA,

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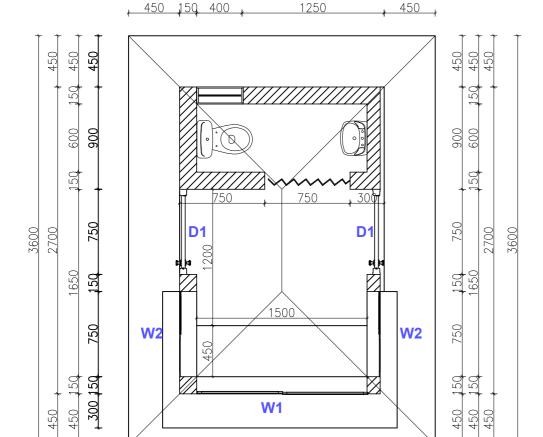
STAFF HOUSE Elevation_[L03] and Elevation L[04]

Scale:	Designed:	O.R Daniel
	Drawn:	P.S Eyamu
Date:	Checked:	O.R Daniel
Dec-2022	Approved:	O.R Daniel
ENGINEERING DESIGN DRAWING		

Drg No: MWE/GWE/1.6.5 | Cad file No WSS<22_11>

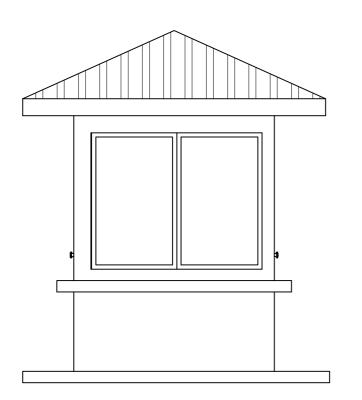

Front view



1500

1650 2700


Top view

2700

150, 450

150, 450


150 450

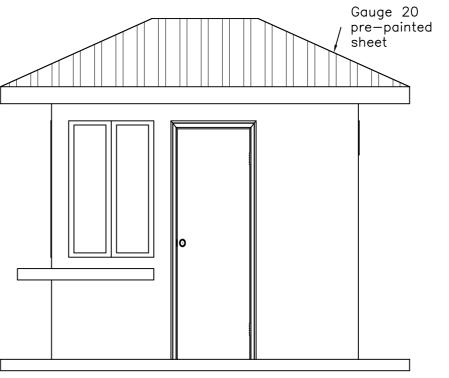

Side view

DOORS AND WINDOWS SCHEDULE					
DIMENSIONS					
NOTATION	NO	WIDTH (mm)	HEIGHT (mm)		
D1	2	750	2100		
W1	1	1500	1200		
W2	2	750	1200		
W3	1	400	600		

Rear view

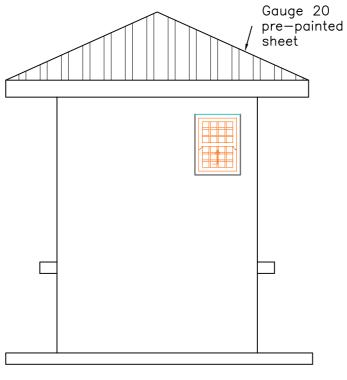

ı	AM	AMENDMENTS		
l	No	Date	Revision	
l	1	7.8.2023	Draft Design	
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LEGEND





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MINISTRY OF WATER AND ENVIRONMENT DIRECTORATE OF WATER DEVELOPMENT (DWD) RURAL WATER SUPPLY AND SANITATION DEPARTMENT Plot 3 - 7 Kabalega Crescent Road, Luzira, a Dec 20026 Kampala Tel: +256 417 889 400, Emai: mwe@mwe.go.ug

Consultancy Services for the Feability Study, Detailed Engineering Design and Construction Supervision of Solar Powered Piped Water Supply Systems and Sanitation Facilities In Refugee Settlements and Host Districts In West Nile and Northern Uganda

- LOT 1 - MADI OKOLLO, TEREGO AND MOYO DISTRICTS

CONSTRUCTION OF GWERE RGC WATER **SUPPLY AND SANITATION SYSTEM**

Consultant:




Drawing Title:

GUARD HOUSE Plan and Sections

Scale:	Designed:	O.R Daniel			
	Drawn:	P.S Eyamu			
Date:	Checked:	O.R Daniel			
Dec-2022	Approved:	O.R Daniel			
ENGINEERING DESIGN DRAWING					

Drg No: MWE/GWE/1.7.1 | Cad file No WSS<22_11>

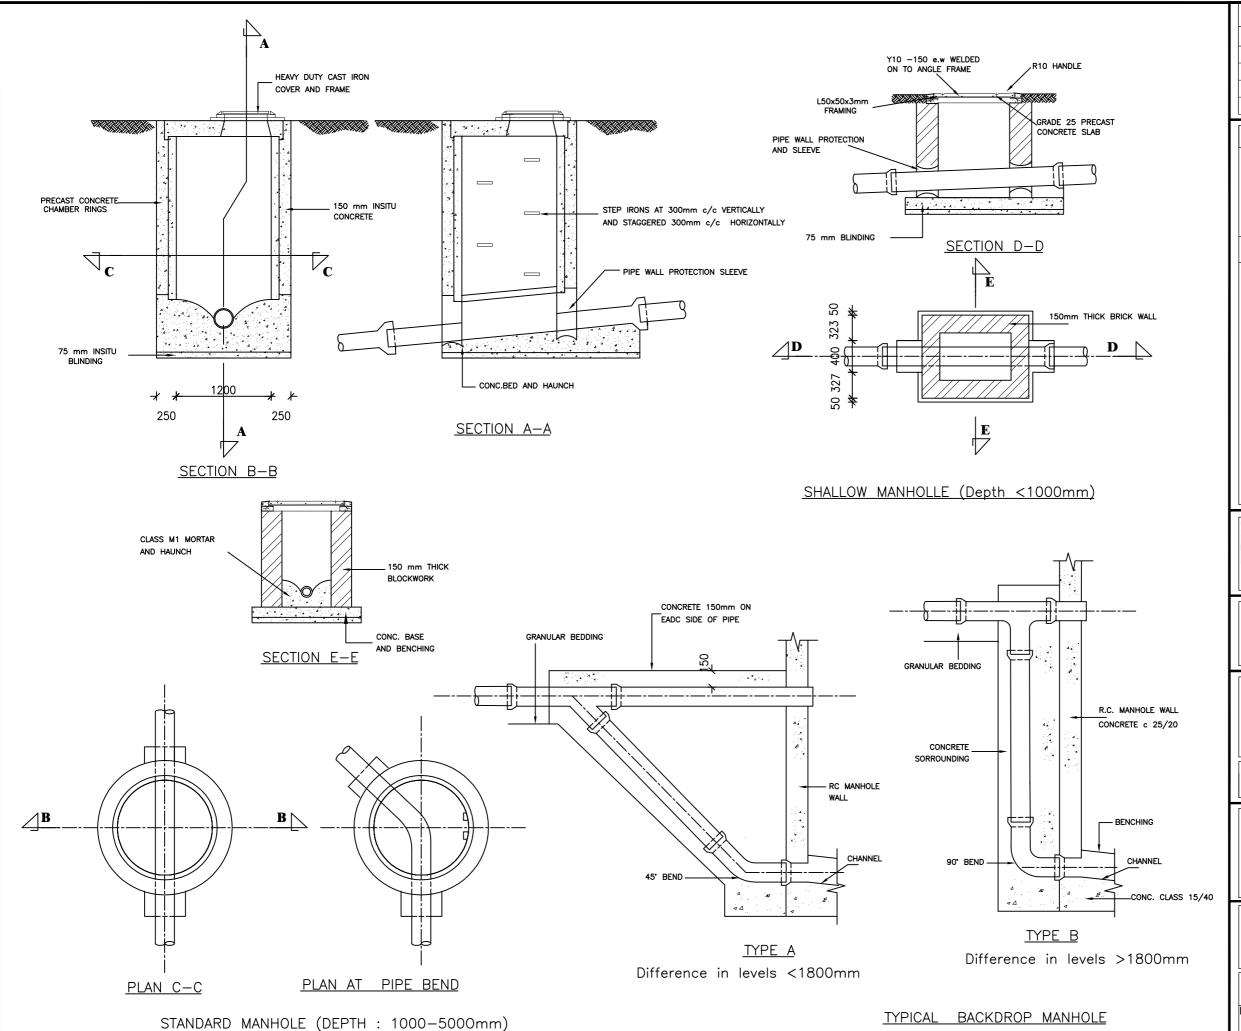

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	No	Date	Revision	
П	1	7.28.2023	Draft Design	
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- 4. For Node details, see Dwg. MWE/GWE/5.0.05. All valves, hydrants and washout locations are identified by marker post in positions.

LEGEND





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MINISTRY OF WATER AND ENVIRONMENT
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RURAL WATER SUPPLY AND SANITATION DEPARTMENT
Plot 3 - 7 Kabalega Crescent Road, Luzira, Box 20026 Kampala
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Website: www.mwe.go.u.g

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Consultancy Services for the Feability Study, Detailed Engineering Design and Construction Supervision of Solar Powered Piped Water Supply Systems and Sanitation Facilities In Refugee Settlements and Host Districts In West Nile and Northern Uganda

- LOT 1 - MADI OKOLLO, TEREGO AND MOYO DISTRICTS -

CONSTRUCTION OF GWERE RGC WATER SUPPLY AND SANITATION SYSTEM

Consultant



Corporate Headquarter 10 Philpot Lane, 1st Floor, London EC3M 8AA, United Kingdom


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MANHOLE DETAILS
Plan and Sections


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	Drav	vn:	P.S Eyamu	
Date:	Che	cked:	O.R Daniel	
Dec-2022	App	roved:	O.R Daniel	
ENGINEERING DESIGN DRAWING				
Drg No: MWE/GWE/	E/1.8.1 Cad file		No WSS<22_11>	


1650 1650 24 Solar **Panels ELEVATION M-M** 1650 1650 20 3320 **ELEVATION Y-Y**


SOLAR PANELS LAYOUT

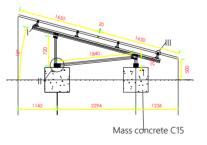


ELEVATION Y-Y

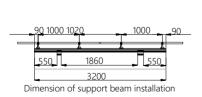

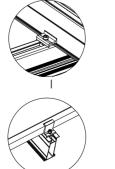

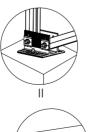



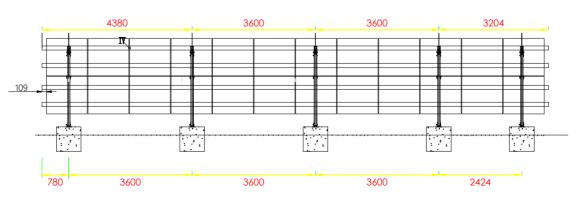

ELEVATION M-M

AM	AMENDMENTS		
No	Date	Revision	
1	10.4.2023	Draft Design	

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LEGEND







DIRECTORATE OF WATER AND ENVIRONMENT
DIRECTORATE OF WATER DEVELOPMENT (DWD)
RURAL WATER SUPPLY AND SANITATION DEPARTMENT
Plot 3 - 7 Kabalega Crescent Road, Luzira, Box 20026 Kampala
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- LOT 1 - MADI OKOLLO, TEREGO AND MOYO DISTRICTS -

CONSTRUCTION OF GWERE WATER SUPPLY AND SANITATION SYSTEM

Consultant:






Corporate Headquarte 10 Philpot Lane, 1st Floor, London EC3M 8AA, United Kingdom

DWD- BH 2 SOLAR PANEL ARRAY LAYOUT, ELEVATION AND DETAILS

Designed:	O.R.D			
Drawn:	P.S.E			
Checked:	O.R.D			
Approved:	O.R.D			
ENGINEERING DESIGN DRAWING				
	Drawn: Checked: Approved:			

Controller

1 set 1-phase cable Well Probe V2, 2x PV Disconnect 1000-40-5, PV Combiner 1000-125-4, PV Protect 1000-125, SmartPSUk2-40, SmartStart, Surge Protector2

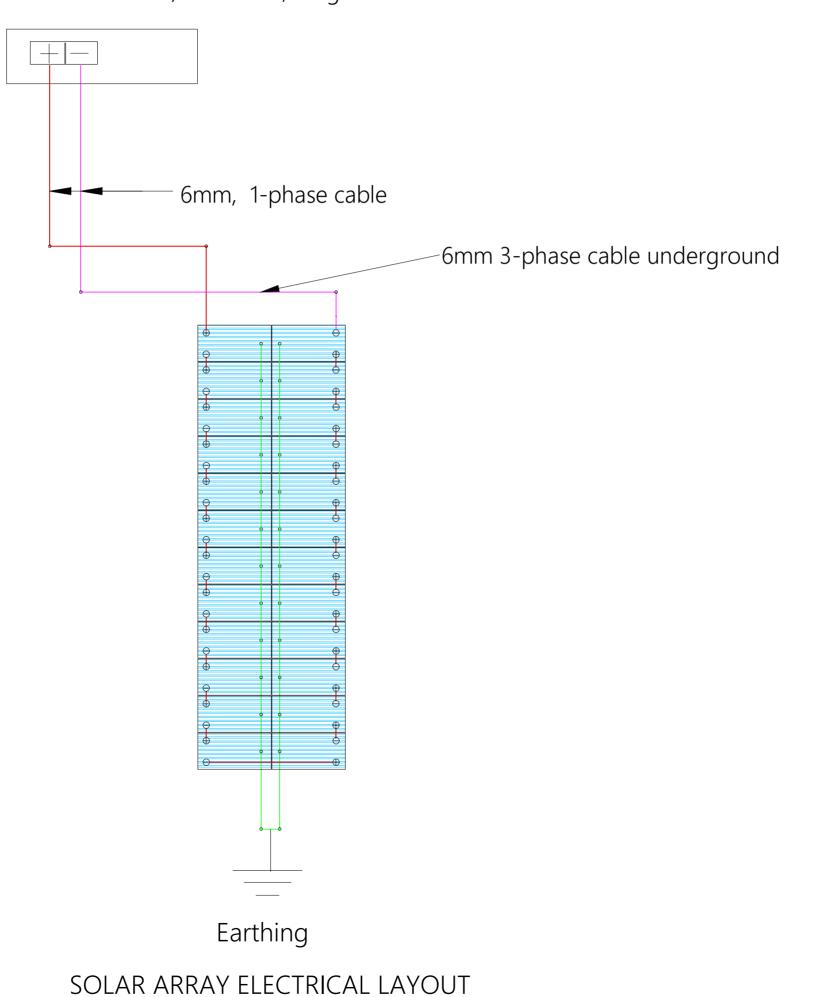

AM	AMENDMENTS		
No	Date	Revision	
1	10.4.2023	Draft Design	

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LEGEND



MINISTRY OF WATER AND ENVIRONMENT

DIRECTORATE OF WATER AND ENVIRONMENT
DIRECTORATE OF WATER DEVELOPMENT (DWD)
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Plot 3 - 7 Kabalega Crescent Road, Luzira, Box 20026 Kampala
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West Nile and Northern Uganda

- LOT 1 - MADI OKOLLO, TEREGO AND MOYO DISTRICTS -

CONSTRUCTION OF GWERE WATER SUPPLY AND **SANITATION SYSTEM**

Consultant:






10 Philpot Lane, 1st Floor, London EC3M 8AA, United Kingdom

DWD- BH 2 SOLAR PANEL ARRAY ELECTRICAL LAYOUT

Scale:	Desi	gned:	O.R.D
	Drav	vn:	P.S.E
Date:	Checked:		O.R.D
Sep-2023	Approved:		O.R.D
ENGINEERING DESIGN DRAWING			
Drg No: MWE/GWE/1	1.9.2	Cad file I	No #########



SOLAR PANELS LAYOUT

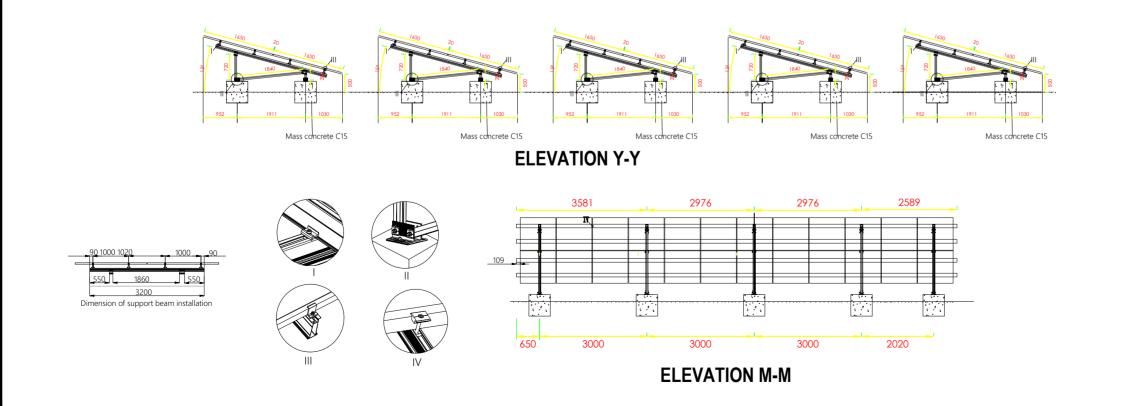

AM	AMENDMENTS		
No	Date	Revision	
1	10.4.2023	Draft Design	

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LEGEND



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Plot 3 - 7 Kabalega Crescent Road, Luzira, Box 2026 Kampala
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West Nile and Northern Uganda
- LOT 1 - MADI OKOLLO, TEREGO AND MOYO DISTRICTS -

CONSTRUCTION OF GWERE WATER SUPPLY AND SANITATION SYSTEM

Consultant:






Corporate Headquarte 10 Philpot Lane, 1st Floor, London EC3M 8AA, United Kingdom

DWD-89709 SOLAR PANEL ARRAY LAYOUT, ELEVATION AND DETAILS

Scale:	Designed:	O.R.D
	Drawn:	P.S.E
Date:	Checked:	O.R.D
Sep-2023	Approved:	O.R.D
ENGINEERIN	NG DESIGN [DRAWING

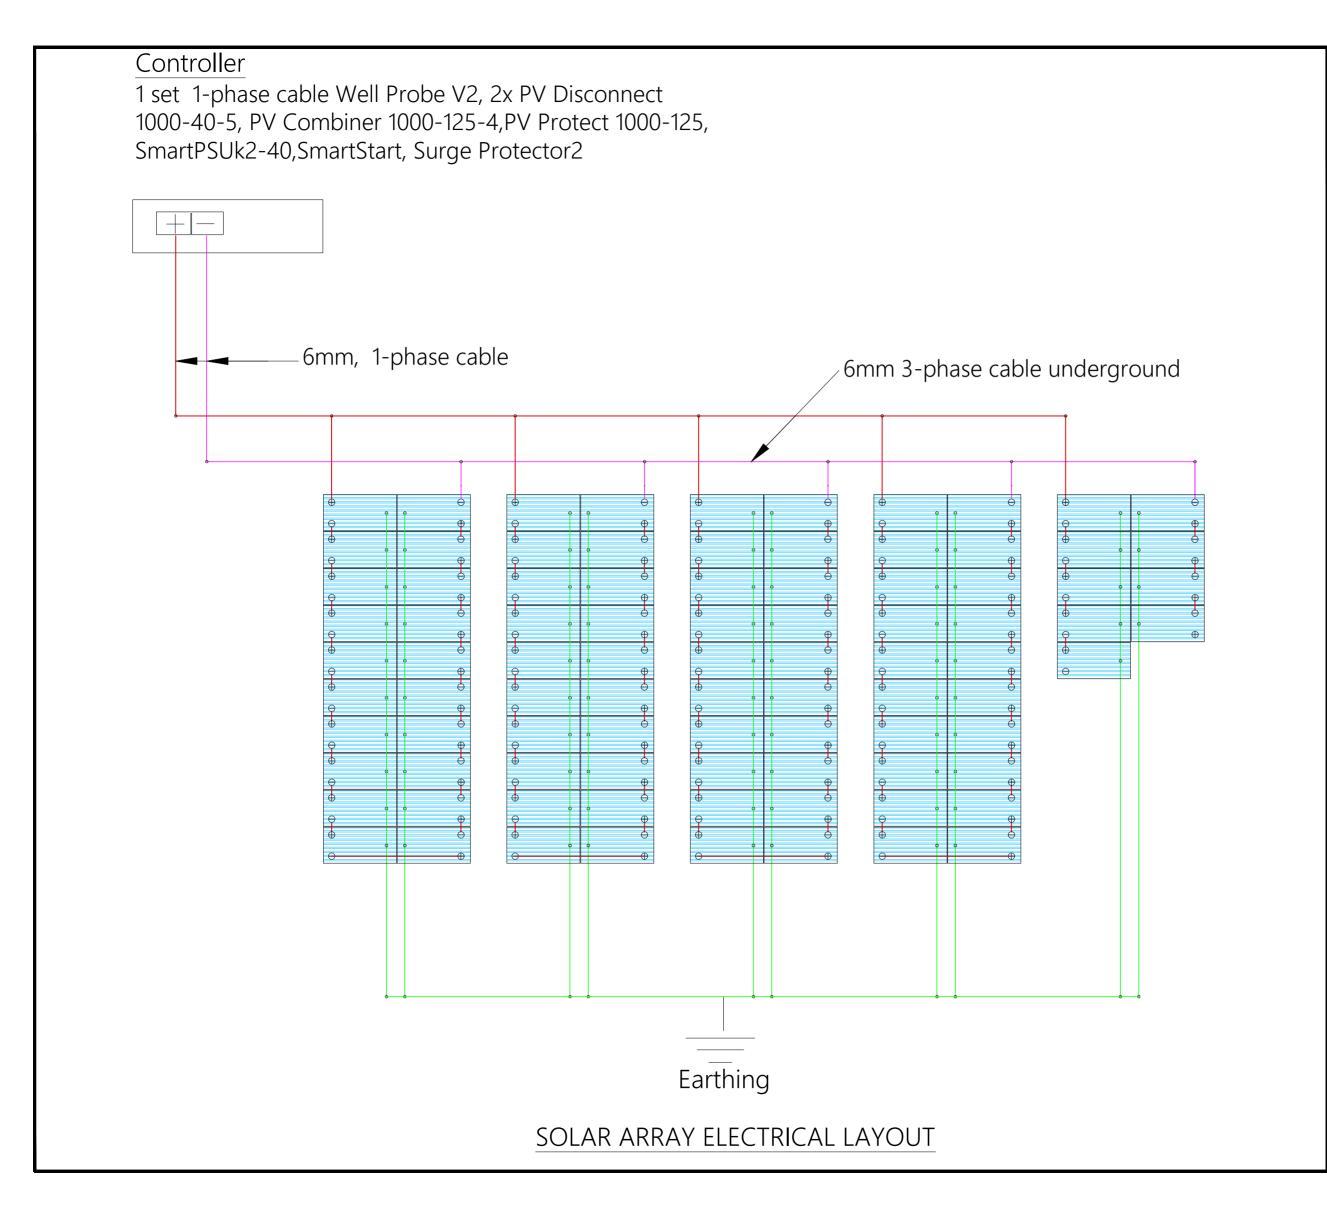

AMENDMENTS		
No	Date	Revision
1	10.4.2023	Draft Design

- 1. All dimensions are in metres unless stated otherwise.
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- 3. For Site location see Dwg. MWE/GWE/1.0.1

LEGEND



MINISTRY OF WATER AND ENVIRONMENT DIRECTORATE OF WATER AND ENVIRONMENT DIRECTORATE OF WATER DEVELOPMENT (DWD) RURAL WATER SUPPLY AND SANITATION DEPARTMENT Plot 3 - 7 Kabalega Crescent Road, Luzira, Box 20026 Kampala Tel : +256 147 889 400. Email: mwe@mwe go.ug Website: www.mwe.go.ug

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- LOT 1 - MADI OKOLLO, TEREGO AND MOYO DISTRICTS -

CONSTRUCTION OF GWERE WATER SUPPLY AND **SANITATION SYSTEM**

Consultant:





Corporate Headquarte 10 Philpot Lane, 1st Floor, London EC3M 8AA, United Kingdom



DWD- 89709 SOLAR PANEL ARRAY ELECTRICAL LAYOUT

Scale:	Designed:		O.R.D
	Draw	n:	P.S.E
Date:	Checked:		O.R.D
Sep-2023	Аррі	roved:	O.R.D
ENGINEERING DESIGN DRAWING			
Drg No: MWE/GWE/1	.9.4	Cad file I	No ###########

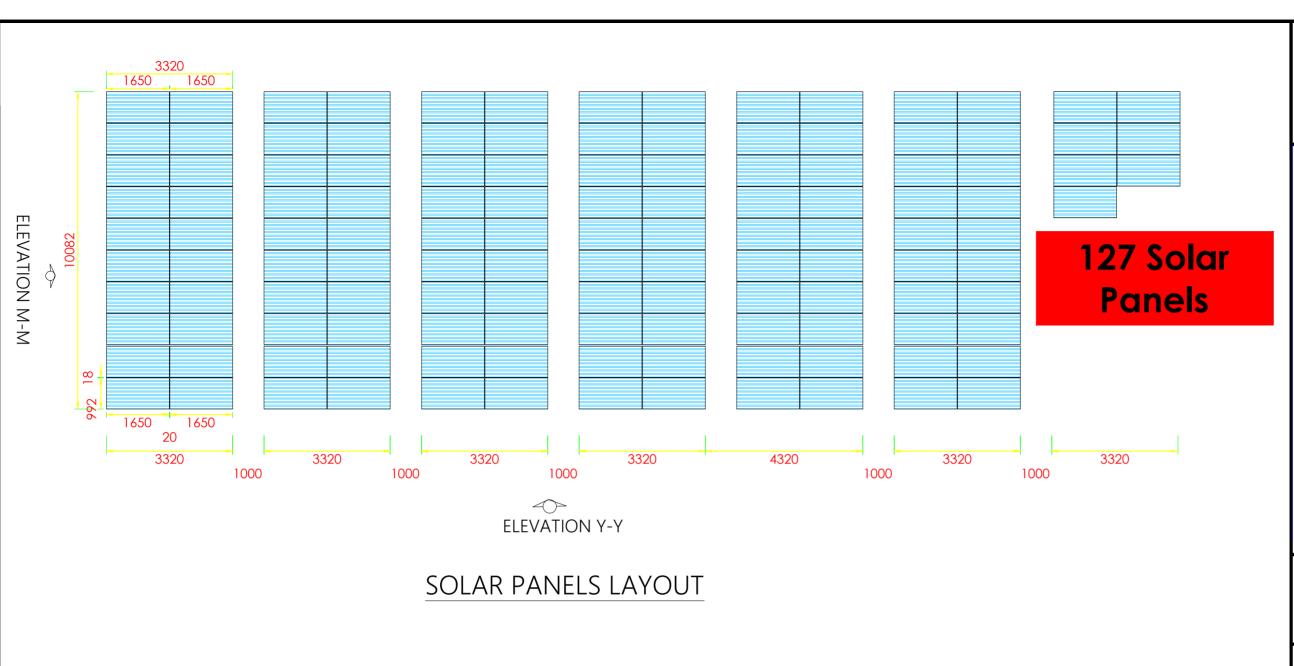

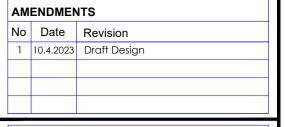

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LEGEND





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MINISTRY OF WATER AND ENVIRONMENT

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RURAL WATER SUPPLY AND SANITATION DEPARTMENT
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15 : +256 417 889 400, Email: mwe@mwe.go.ug

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- LOT 1 - MADI OKOLLO, TEREGO AND MOYO DISTRICTS -

CONSTRUCTION OF GWERE WATER SUPPLY AND SANITATION SYSTEM

Consultant:







Corporate Headquarte 10 Philpot Lane, 1st Floor, London EC3M 8AA, United Kingdom

WTP SOLAR PANEL ARRAY LAYOUT, ELEVATION AND DETAILS

Scale:	Designed:	O.R.D	
	Drawn:	P.S.E	
Date:	Checked:	O.R.D	
Sep-2023	Approved:	O.R.D	
ENGINEERING DESIGN DRAWING			
Drg No: MWE/GWE/1	.9.5 Cad file	No ##########	

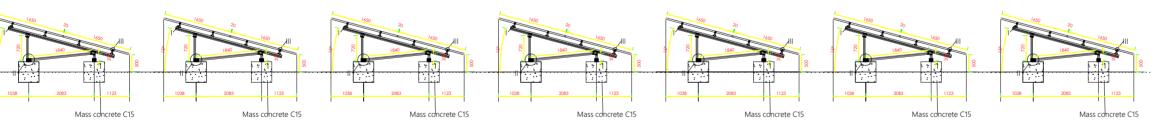


ELEVATION Y-Y

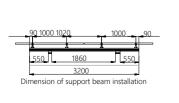








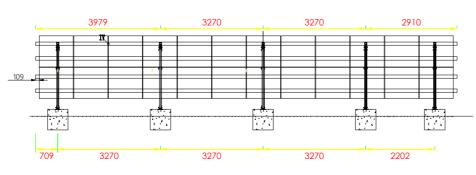

ELEVATION M-M

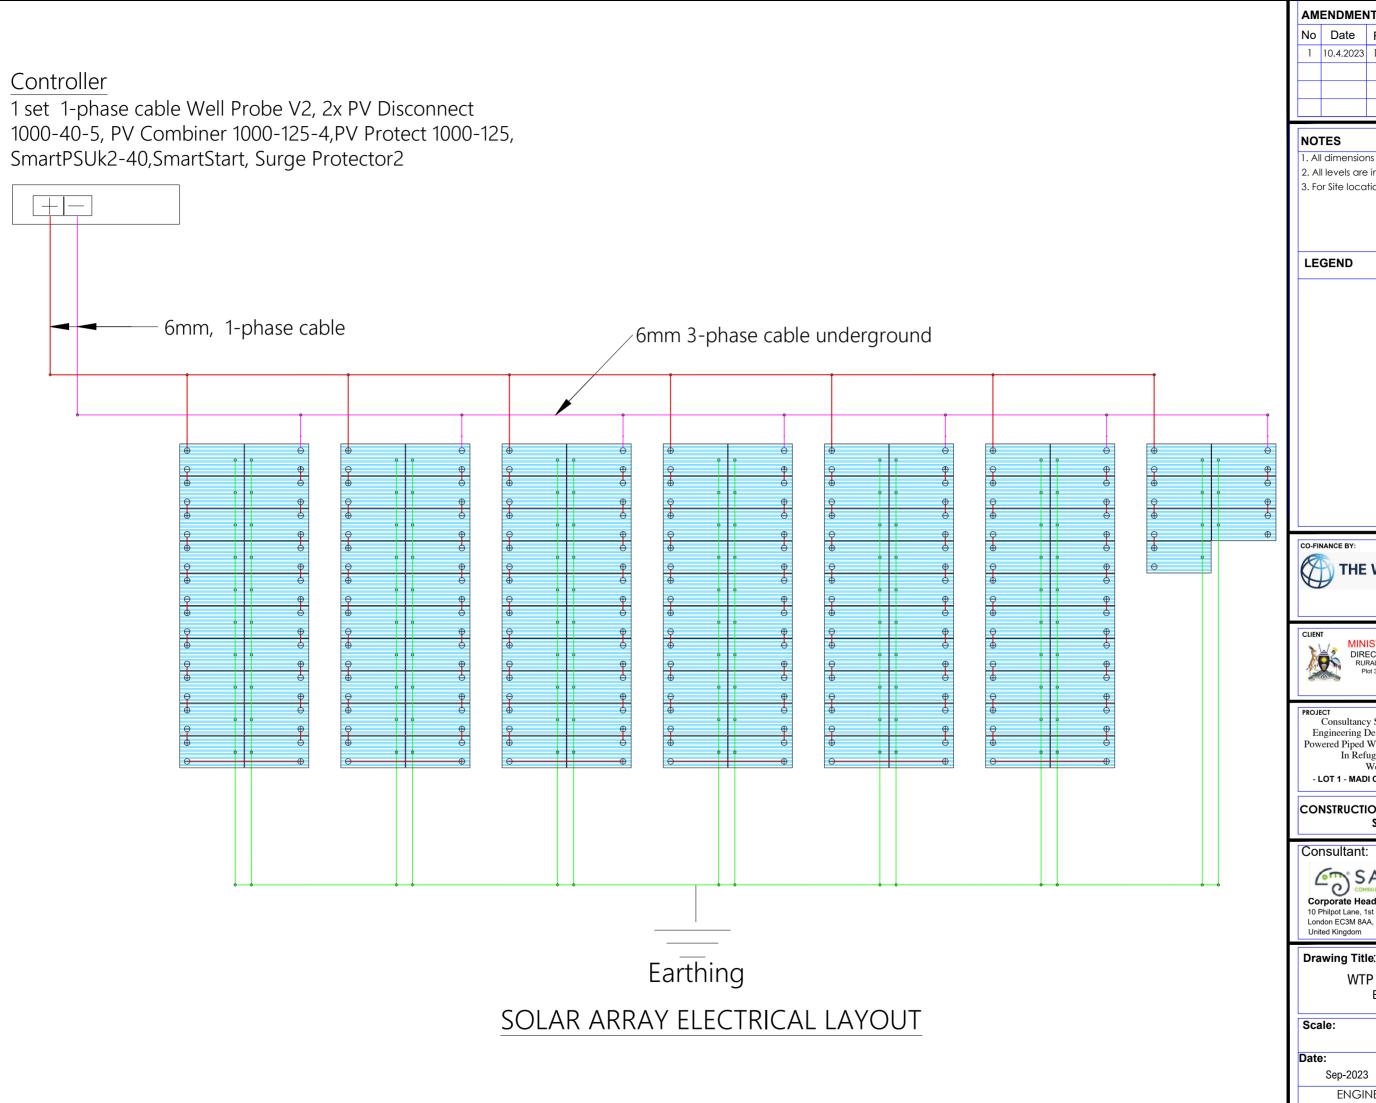

AM	AMENDMENTS			
No	Date	Revision		
1	10.4.2023	Draft Design		

1. All dimensions are in metres unless stated otherwise.

- 2. All levels are in metres above sea level.
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MINISTRY OF WATER AND ENVIRONMENT

DIRECTORATE OF WATER AND ENVIRONMENT
DIRECTORATE OF WATER DEVELOPMENT (DWD)
RURAL WATER SUPPLY AND SANITATION DEPARTMENT
Plot 3 - 7 Kabalega Crescent Road, Luzira, Box 20026 Kampala
Tel : +256 417 889 400, Email: mwe@mwe.go.ug
Website: www.mwe.go.ug

Consultancy Services for the Feability Study, Detailed Engineering Design and Construction Supervision of Solar Powered Piped Water Supply Systems and Sanitation Facilities In Refugee Settlements and Host Districts In
West Nile and Northern Uganda

- LOT 1 - MADI OKOLLO, TEREGO AND MOYO DISTRICTS -

CONSTRUCTION OF GWERE WATER SUPPLY AND SANITATION SYSTEM



SARI Un Joint Venture with




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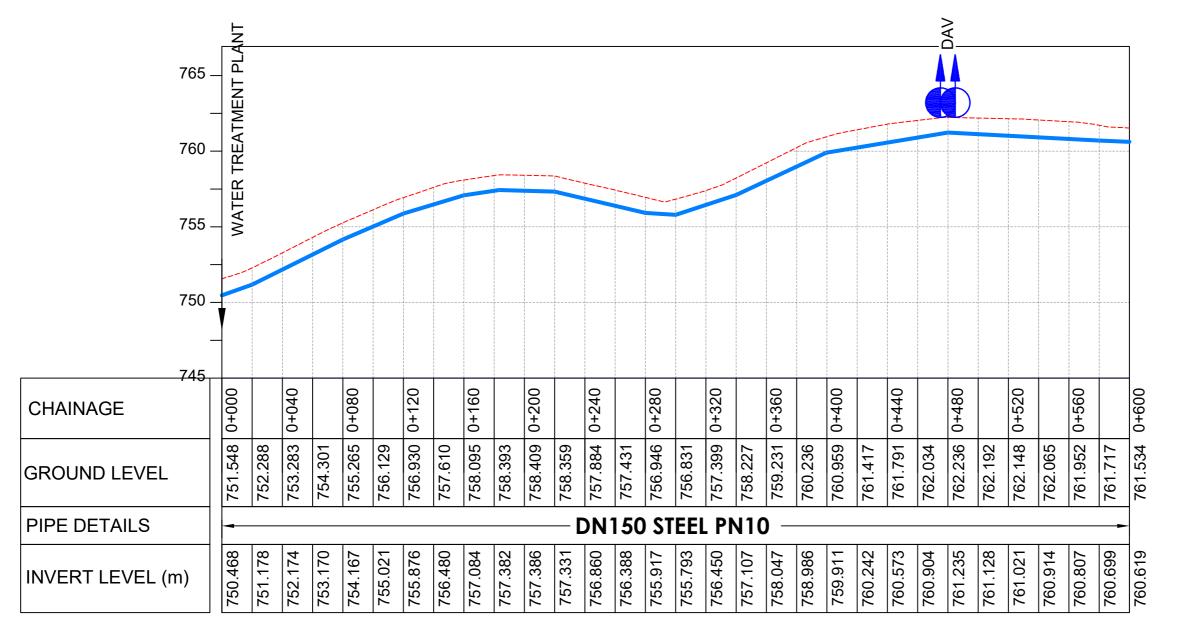
WTP SOLAR PANEL ARRAY ELECTRICAL LAYOUT

Designed: O.R.D Drawn: P.S.E Checked: O.R.D Sep-2023 Approved: O.R.D

ENGINEERING DESIGN DRAWING

TRANSMISSION MAIN (Plan and Profile)



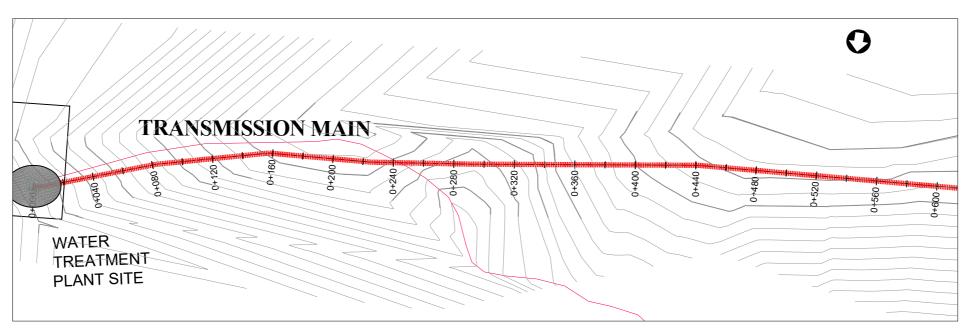

LONGITUDINAL PROFILE

AM	AMENDMENTS		
No	Date	Revision	
1	7.29.2023	Draft Design	

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- 5. All valves, hydrants and washout locations are

Level Indicator SD 220 SD 116 Outfall Chamber SD 117 Thrust Blocks SD 118

Pipe beddings SD 121

LEGEND



Transmission Mains **Distribution Mains**

Building/House

Contours Road

Double Orifice Air Valve WO_2 Type 2 Washout

Node detail No. 101

Tree

CO-FINANCE BY



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MINISTRY OF WATER AND ENVIRONMENT
DIRECTORATE OF WATER DEVELOPMENT (DWD)
RURAL WATER SUPPLY AND SANITATION DEPARTMENT
Plot 3 - 7 Kabalega Crescent Road, Luzira, Box 20026 Kampala
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GOVERNMENT OF UGANDA

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- LOT 1 - MADI OKOLLO, TEREGO AND MOYO DISTRICTS

CONSTRUCTION OF GWERE RGC WATER **SUPPLY AND SANITATION SYSTEM**

Consultant:



10 Philpot Lane, 1st Floor,


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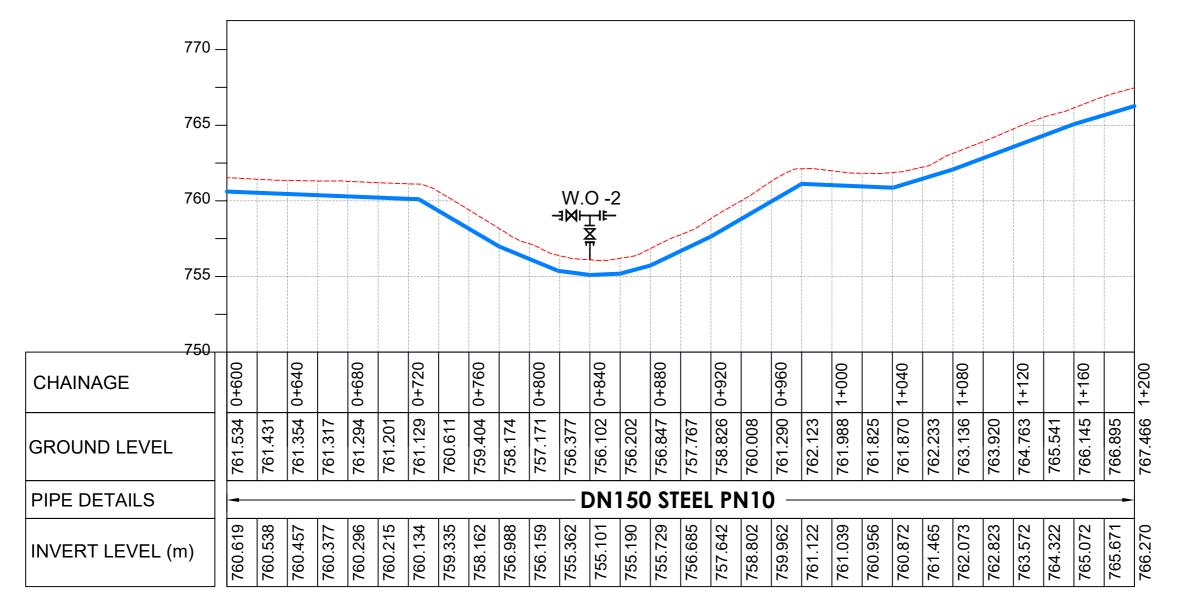
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I	Scale: Vertical Scale: 1:250	Designed:	O.R Daniel
ı	Horizontal Scale: 1:250	Drawn:	P.S Eyamu
ı	Date:	Checked:	O.R Daniel
١	Nov-2022	Approved:	O.R Daniel

ENGINEERING DESIGN DRAWING

Drg No: MWE/GWE/2.1.1 Cad file No WSS<22_11>



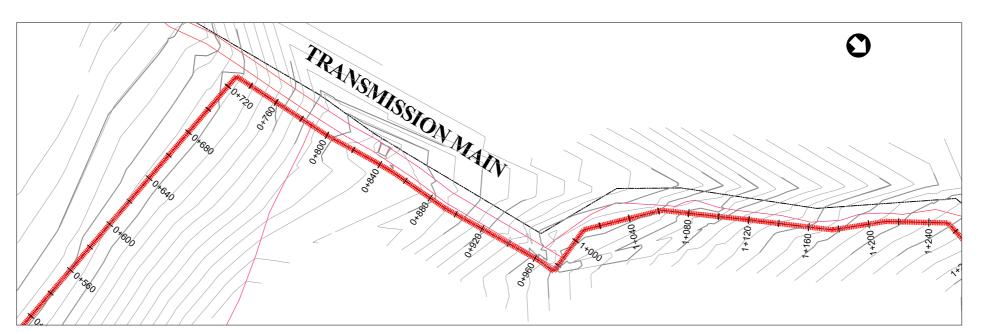

AMENDMENTS No Date Revision 1 7.29.2023 Draft Design

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Level Indicator SD 220 SD 116 Outfall Chamber SD 117

Thrust Blocks SD 118 Pipe beddings SD 121

LEGEND



Transmission Mains **Distribution Mains**

Building/House

Contours Road

Double Orifice Air Valve WO_2 Type 2 Washout

Node detail No. 101

Tree

CO-FINANCE BY

10



GOVERNMENT OF UGANDA



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Consultant:



10 Philpot Lane, 1st Floor,


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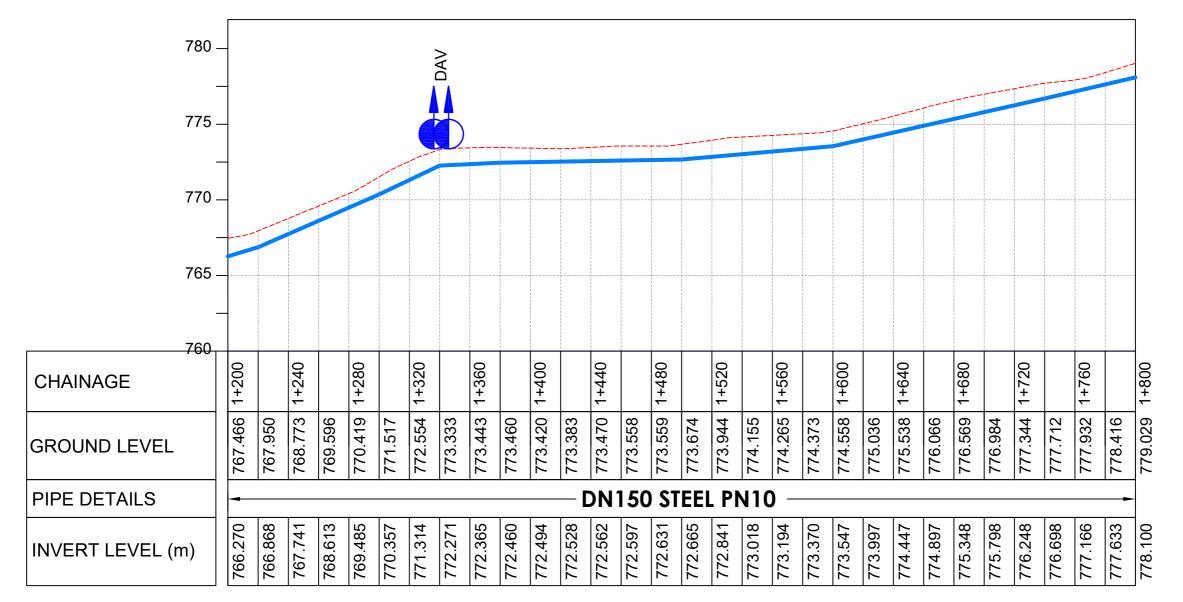
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Scale: Vertical Scale: 1:250	Designed:	O.R Daniel
Horizontal Scale: 1:2500	Drawn:	P.S Eyamu
Date:	Checked:	O.R Daniel
Nov-2022	Approved:	O.R Daniel

ENGINEERING DESIGN DRAWING

Drg No: MWE/GWE/2.1.2 | Cad file No WSS<22_11>



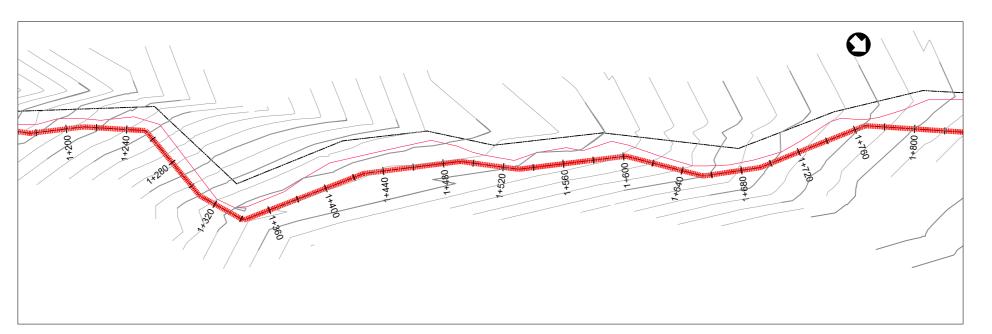

AMENDMENTS No Date Revision 1 7.29.2023 Draft Design

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SD 220 Level Indicator SD 116 Outfall Chamber SD 117 Thrust Blocks SD 118 SD 121 Pipe beddings

LEGEND



Transmission Mains **Distribution Mains**

Building/House

Contours

Road

Double Orifice Air Valve WO_2

Type 2 Washout Node detail No. 101

Tree

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MINISTRY OF WATER AND ENVIRONMENT
DIRECTORATE OF WATER DEVELOPMENT (DWD)
RURAL WATER SUPPLY AND SANITATION DEPARTMENT
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- LOT 1 - MADI OKOLLO, TEREGO AND MOYO DISTRICTS -

CONSTRUCTION OF GWERE RGC WATER **SUPPLY AND SANITATION SYSTEM**

Consultant:




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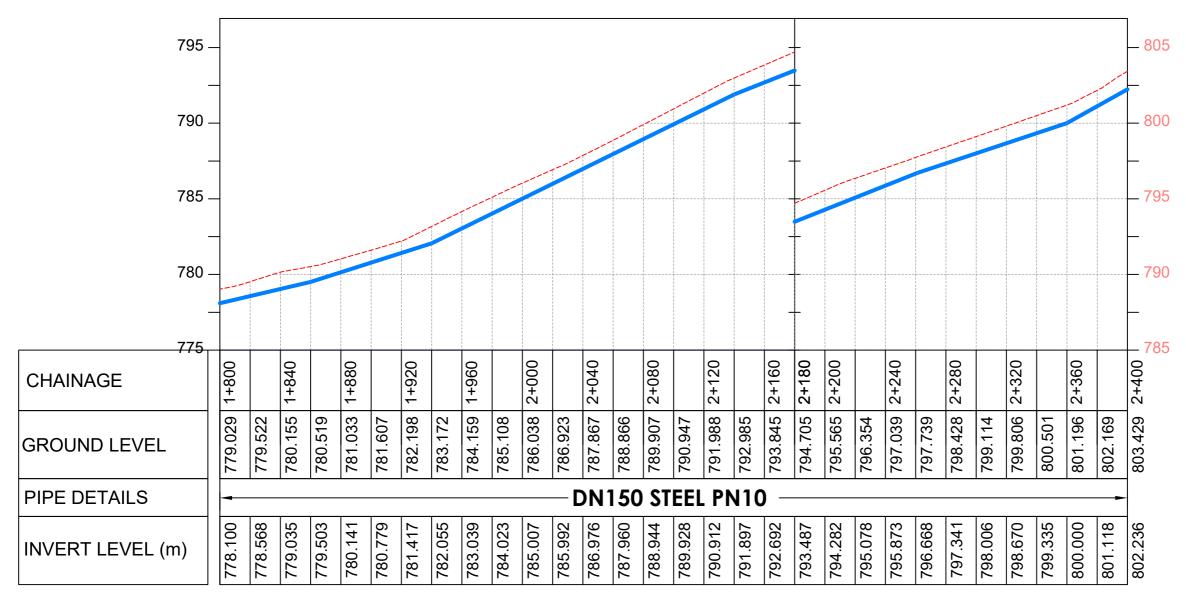
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Scale:	Designed:	O.R Daniel		
Vertical Scale: 1:250 Horizontal Scale: 1:2500	Drawn:	P.S Eyamu		
Date:	Checked:	O.R Daniel		
Nov-2022	Approved:	O.R Daniel		

ENGINEERING DESIGN DRAWING Drg No: MWE/GWE/2.1.3 Cad file No WSS<22_11>





LONGITUDINAL PROFILE

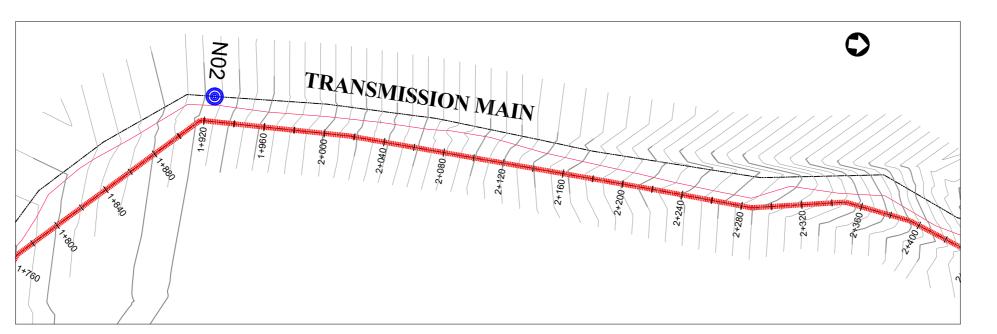AMENDMENTS No Date Revision 1 7.29.2023 Draft Design

	No	Date	Revision
	1	7.29.2023	Draft Design

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Level Indicator SD 220
Outfall Chamber SD 116
Marker Post SD 117

Thrust Blocks SD 118
Pipe beddings SD 121

LEGEND



Transmission Mains
Distribution Mains

Building/House

0

Contours Road

Tree

DAV Double Orifice Air Valve
WO 2 Type 2 Washout

WO_2 Type 2 Washout

Node detail No. 101

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MINISTRY OF WATER AND ENVIRONMENT

DIRECTORATE OF WATER DEVELOPMENT (DWD)

RURAL WATER SUPPLY AND SANITATION DEPARTMENT

Plot 3 - 7 Kabalega Crescent Road, Luzira, Box 20026 Kampala

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PROJEC*

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- LOT 1 - MADI OKOLLO, TEREGO AND MOYO DISTRICTS

CONSTRUCTION OF GWERE RGC WATER SUPPLY AND SANITATION SYSTEM

Consultant:



Corporate Headquarter 10 Philpot Lane, 1st Floor, London EC3M 8AA, United Kingdom

Drawing Title:

TRANSMISSION MAIN
Transmission Mains (CH 1+800.00 - 2+400.00)

Scale:
Vertical Scale: 1:250
Designed: O.R Daniel

Vertical Scale: 1:250
Horizontal Scale: 1:2500


Date:
Nov-2022


ENGINEERING DESIGN DRAWING

O.R Daniel
Approved:
O.R Daniel
O.R Daniel

ENGINEERING DESIGN DRAWING

Drg No: MWE/GWE/2.1.4 Cad file No WSS<22 11>

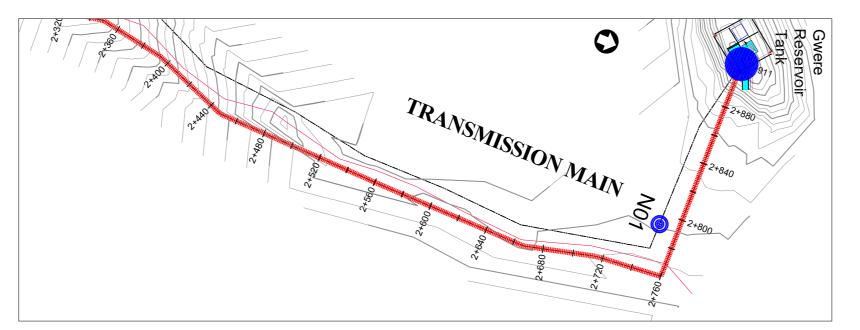

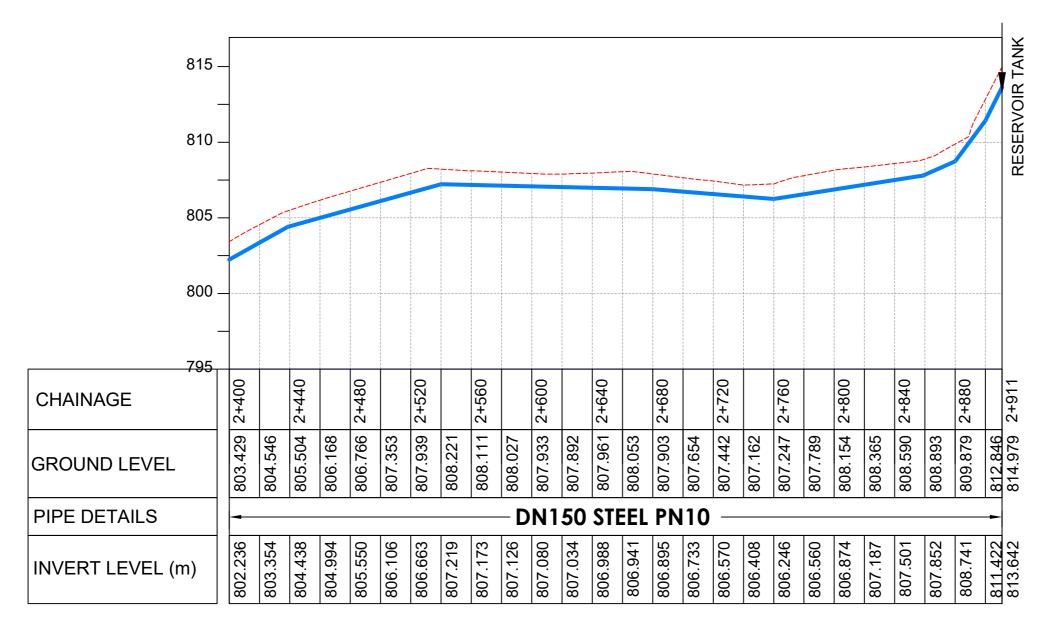

LONGITUDINAL PROFILE

l	AM	AMENDMENTS		
l	No	Date	Revision	
l	1	7.29.2023	Draft Design	
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Level Indicator SD 220
Outfall Chamber SD 116
Marker Post SD 117
Thrust Blocks SD 118

LEGEND



Pipe beddings

Transmission Mains

SD 121

Distribution Mains
Building/House

Contours Road

Tree
Double Orifice Air Valve
Type 2 Washout

Node detail No. 101

CO-FINANCE BY:

DAV

10

WO_2



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MINISTRY OF WATER AND ENVIRONMENT

DIRECTORATE OF WATER DEVELOPMENT (DWD)

RURAL WATER SUPPLY AND SANITATION DEPARTMENT

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- LOT 1 - MADI OKOLLO, TEREGO AND MOYO DISTRICTS

CONSTRUCTION OF GWERE RGC WATER SUPPLY AND SANITATION SYSTEM

Consultant:



Corporate Headquarter 10 Philpot Lane, 1st Floor, London EC3M 8AA, United Kingdom


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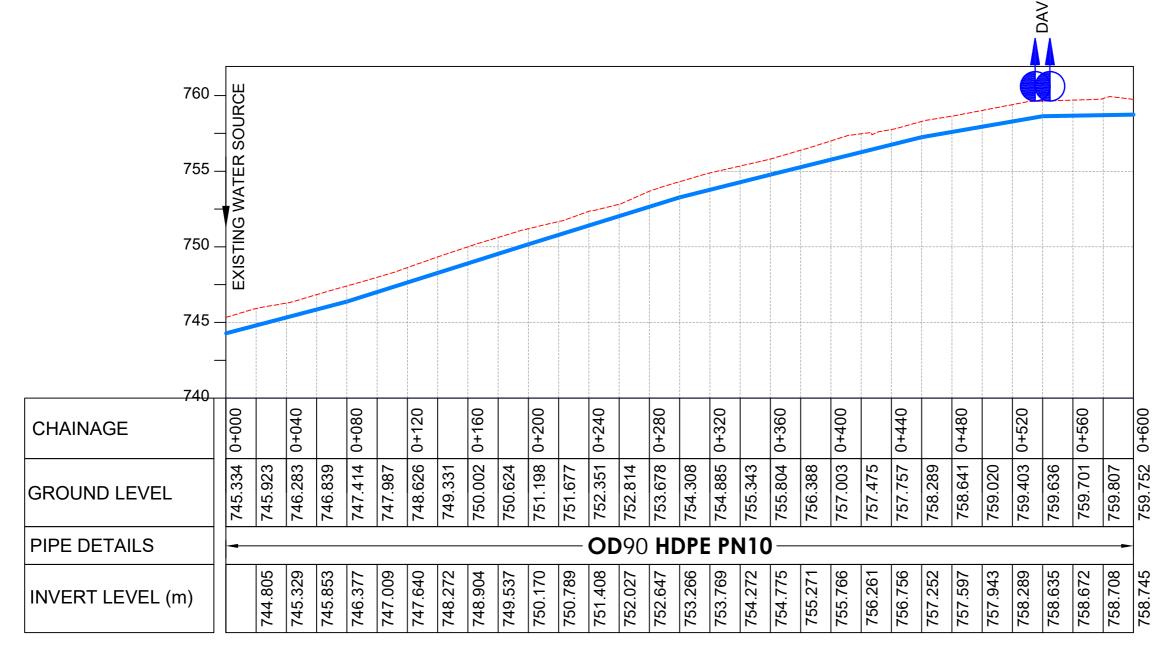
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Transmission Mains (CH 2+400.00 - 2+910.96)

Scale:	Designed:	O.R Daniel				
Vertical Scale: 1:250 Horizontal Scale: 1:2500	Drawn:	P.S Eyamu				
Date:	Checked:	O.R Daniel				
Nov-2022	Approved:	O.R Daniel				

ENGINEERING DESIGN DRAWING

Drg No: MWE/GWE/2.1.5 | Cad file No WSS<22_11>



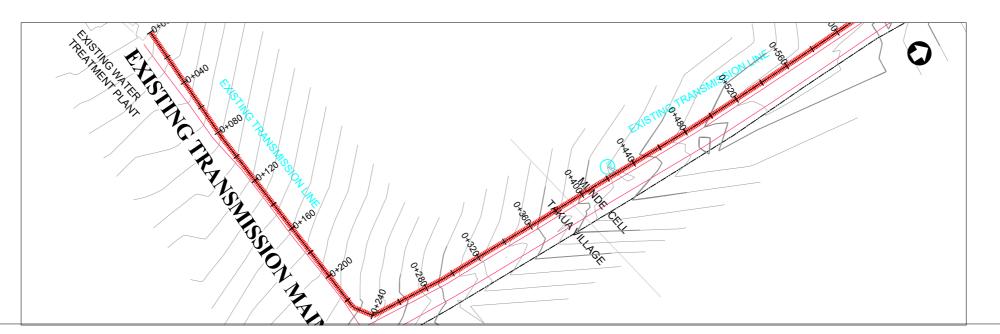

AMENDMENTS

No	Date	Revision
1	7.29.2023	Draft Design

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6. For Standard details see sheets as follows Level Indicator SD 220

SD 116 Outfall Chamber

Marker Post SD 117 Thrust Blocks SD 118

LEGEND



Pipe beddings

Transmission Mains **Distribution Mains**

SD 121

Building/House

Contours Road

③ Tree Double Orifice Air Valve

WO_2 Type 2 Washout 10

Node detail No. 101

CO-FINANCE BY



GOVERNMENT OF UGANDA



MINISTRY OF WATER AND ENVIRONMENT
DIRECTORATE OF WATER DEVELOPMENT (DWD)
RURAL WATER SUPPLY AND SANITATION DEPARTMENT
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- LOT 1 - MADI OKOLLO, TEREGO AND MOYO DISTRICTS -

CONSTRUCTION OF GWERE RGC WATER **SUPPLY AND SANITATION SYSTEM**

Consultant:




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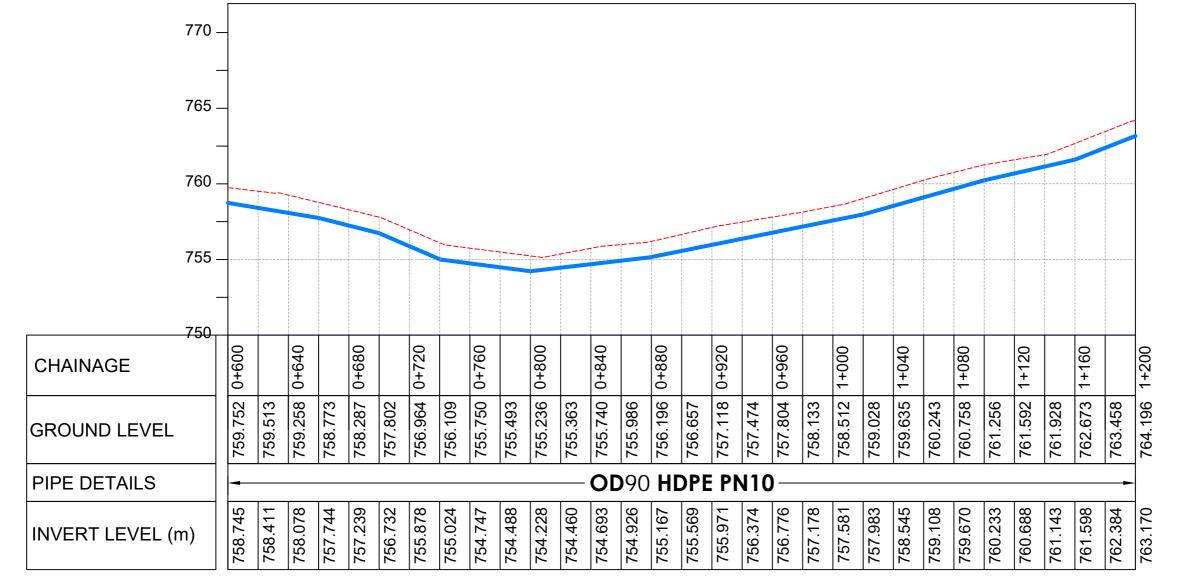
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TRANSMISSION MAIN 01 Transmssion Main 01 (CH 0+000.00 - 0+600.00)

Scale: Vertical Scale: 1:250	Designed:	O.R Daniel
Horizontal Scale: 1:250	Drawn:	P.S Eyamu
Date:	Checked:	O.R Daniel
Nov-2022	Approved:	O.R Daniel
ENGINEERI	NG DESIGN	

Drg No: MWE/GWE/2.2.1 Cad file No WSS<22_11>



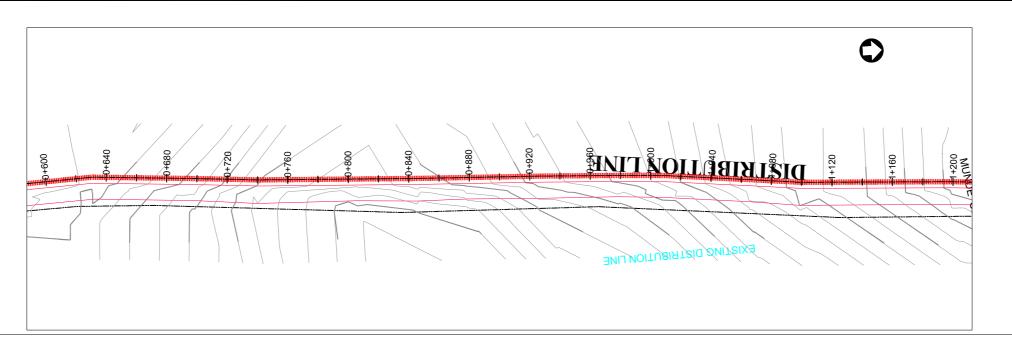

AMENDMENTS

l	No	Date	Revision
l	1	7.29.2023	Draft Design
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SD 220 Level Indicator Outfall Chamber SD 116 Marker Post SD 117 Thrust Blocks SD 118

SD 121 Pipe beddings

LEGEND



Transmission Mains **Distribution Mains**

Building/House



Contours Road

Tree Double Orifice Air Valve WO_2

Type 2 Washout Node detail No. 101

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MINISTRY OF WATER AND ENVIRONMENT
DIRECTORATE OF WATER DEVELOPMENT (DWD)
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Consultant:



10 Philpot Lane, 1st Floor,


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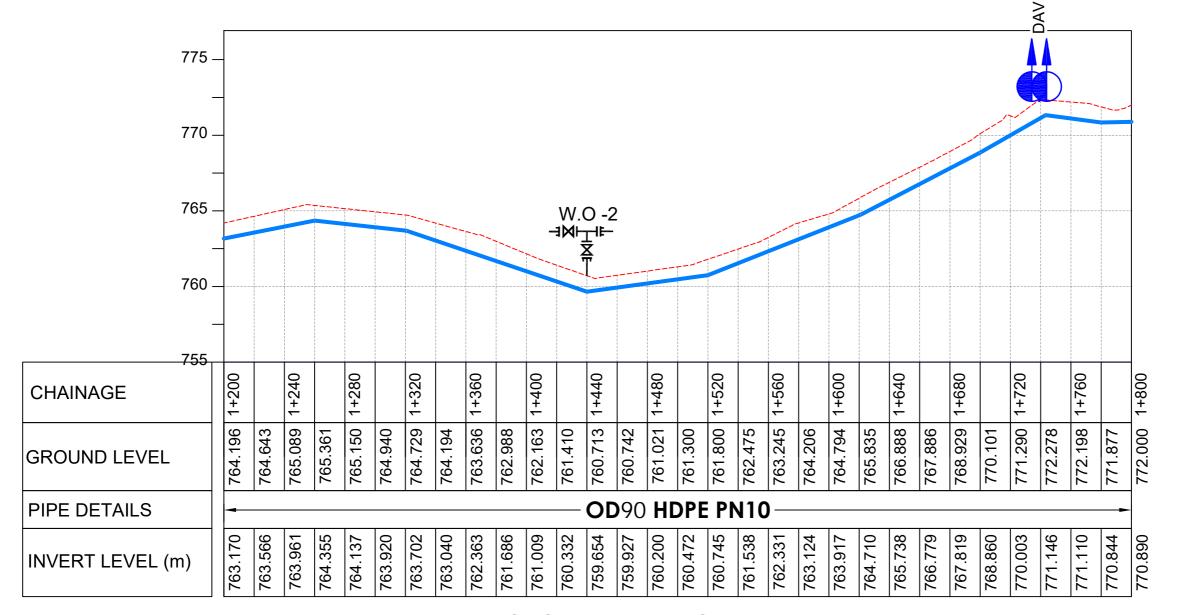
TRANSMISSION MAIN 01 Transmssion Main 01 (CH 0+600.00 - 1+200.00)

Scale:	Designed:	O.R Daniel
Vertical Scale: 1:250 Horizontal Scale: 1:2500	Drawn:	P.S Eyamu
Date:	Checked:	O.R Daniel
Nov-2022	Approved:	O.R Daniel

ENGINEERING DESIGN DRAWING

Drg No: MWE/GWE/2.2.2 Cad file No WSS<22_11>



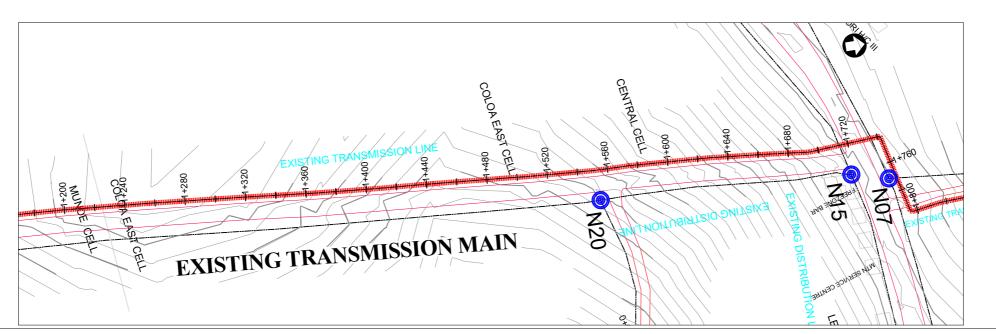

AMENDMENTS

	No	Date	Revision
	1	7.29.2023	Draft Design
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Level Indicator SD 220 SD 116 Outfall Chamber SD 117

Thrust Blocks SD 118 Pipe beddings SD 121

LEGEND



Transmission Mains **Distribution Mains**

Building/House

Contours Road

Double Orifice Air Valve WO_2

Type 2 Washout

Tree

Node detail No. 101

CO-FINANCE BY

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GOVERNMENT OF UGANDA



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CONSTRUCTION OF GWERE RGC WATER **SUPPLY AND SANITATION SYSTEM**

Consultant:




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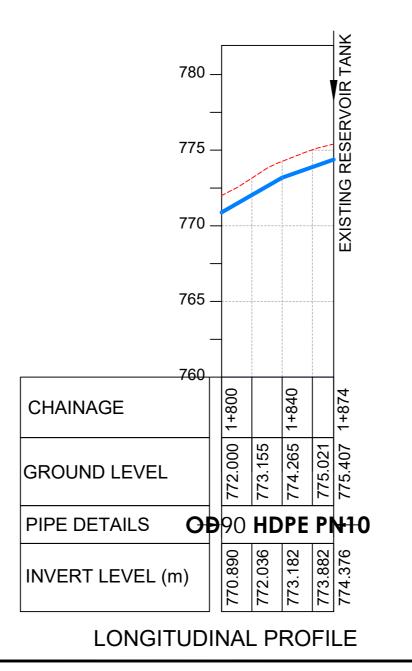
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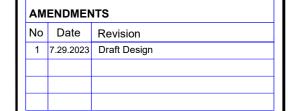
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Designed: O.R Daniel Vertical Scale: 1:250 Horizontal Scale: 1:2500 Drawn: P.S Eyamu Checked: O.R Daniel Approved: O.R Daniel

ENGINEERING DESIGN DRAWING Drg No: MWE/GWE/2.2.3 | Cad file No WSS<22_11>





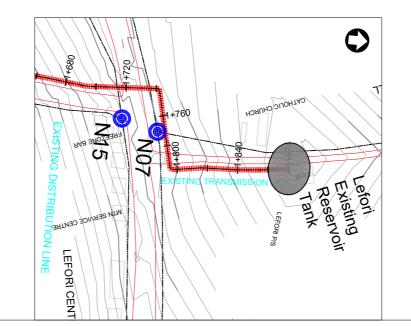

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SD 220 Level Indicator Outfall Chamber SD 116 Marker Post SD 117 Thrust Blocks SD 118 SD 121 Pipe beddings

LEGEND



Transmission Mains

Distribution Mains Building/House



DAV

Contours Road

Tree Double Orifice Air Valve

WO_2 Type 2 Washout 10 Node detail No. 101

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10 Philpot Lane, 1st Floor, London EC3M 8AA,


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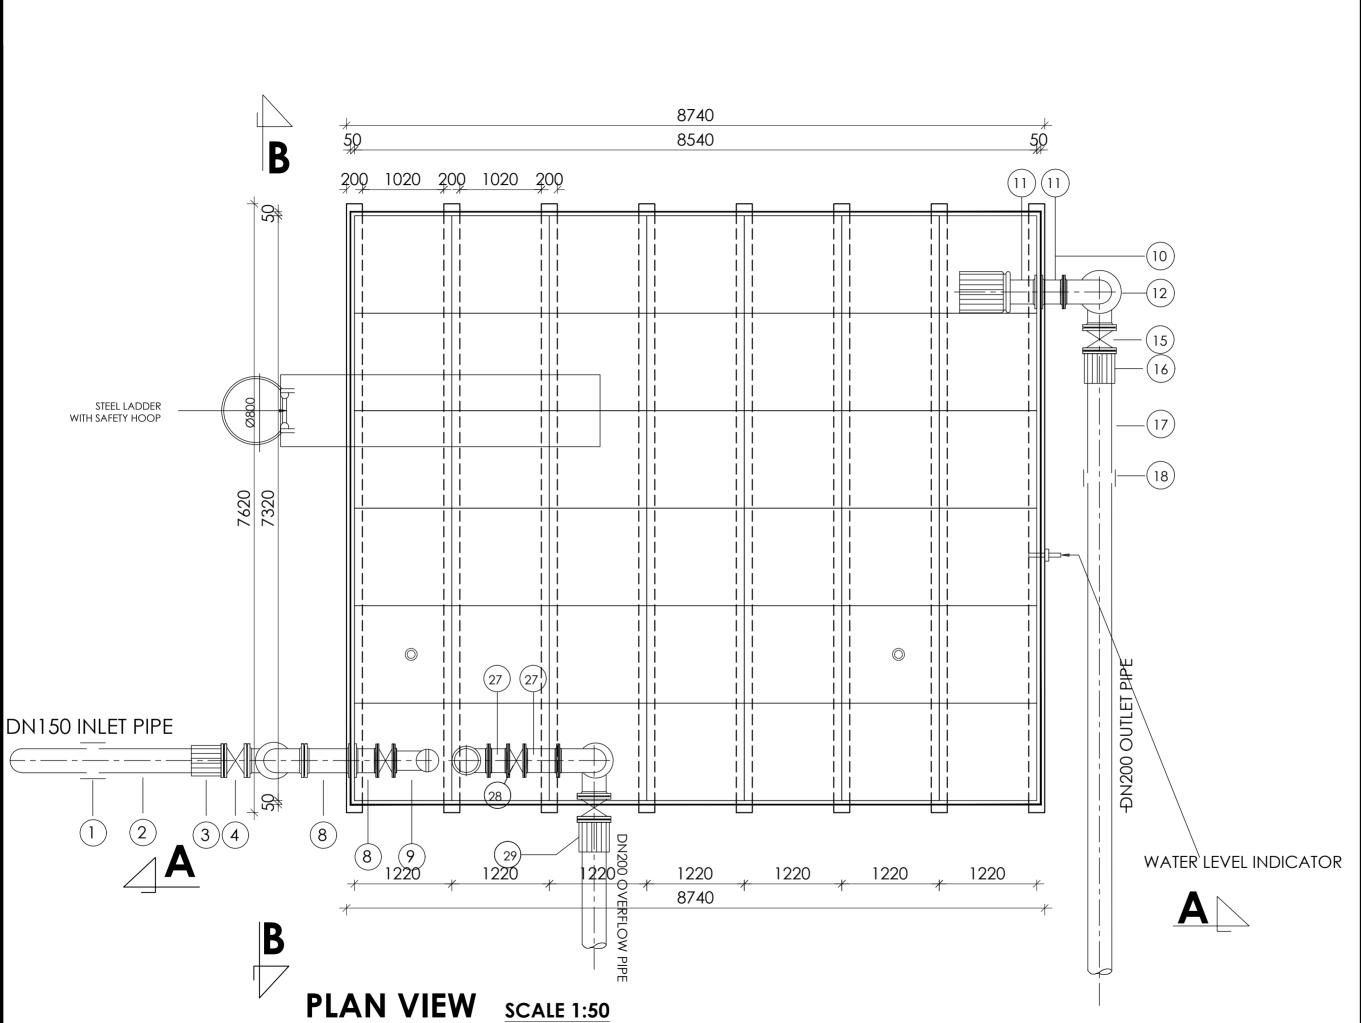
TRANSMISSION MAIN 01 Transmssion Main 01 (CH 1+800.00 - 1+874.10)

ı	Scale: Vertical Scale: 1:250	Designed:	O.R Daniel
ı	Horizontal Scale: 1:2500	Drawn:	P.S Eyamu
ı	Date:	Checked:	O.R Daniel
۱	Nov-2022	Approved:	O.R Daniel

ENGINEERING DESIGN DRAWING

Drg No: MWE/GWE/2.2.4 | Cad file No WSS<22_11>



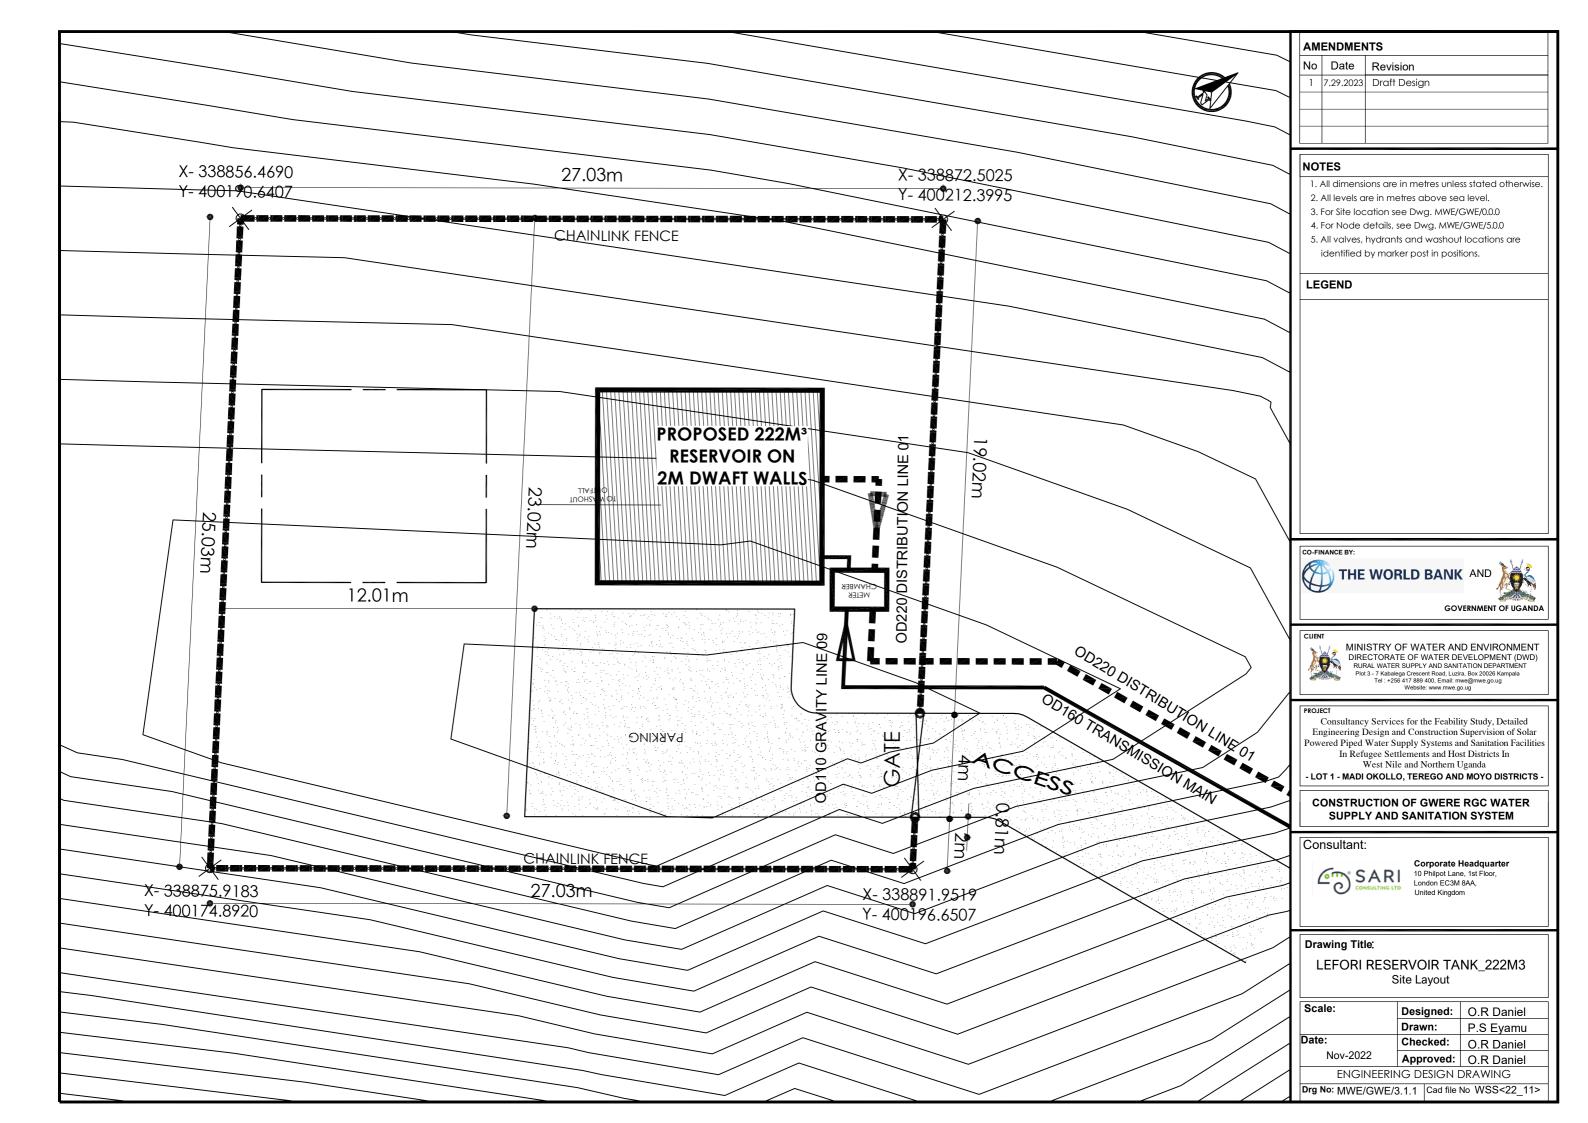

AM	AMENDMENTS		
No	Date	Revision	
1	4.8.2024	Draft Design	

PIPE SCHEDULE

- . 1No.DN150 Vicking Johnson or Similar Coupling.
- 2. 1No.DN150 Pipe not exceeding 2.0m.
- 3. 1No.DN150 Flanged Adaptor, Maxi type or similar..
- 4. 1No.DN150 Flanged Gate Valve
- 5. 1No.DN150 All Flanged Duck foot 90° bend..
- 6. 1No.DN150 Double Flanged Pipe not exceeding 6.0m.
- 7. 1No.DN150 All Flanged 90° bend.
- 8. 2No.DN150 Double Flanged Pipe not exceeding 0.5m.
- 9. 1No.DN150 Float Ball valve.
- 10. 1No.DN200 Flanged Outlet Pipe Strainer.
- 11. 2No.DN200 Double Flanged Pipe not exceeding 0.6m.
- 12. 1No.DN200 All Flanged 90° bend.
- 13. 1No.DN200 Double Flanged Pipe not exceeding 3.0m.
- 14. 1No.DN200 All Flanged Duck foot 90° bend.
- 15. 1No.DN200 Flanged Gate Valve.
- 16. 1No.DN200 Flanged Adaptor, Maxi type or similar.
- 17. 1No.DN200 Pipe not exceeding 2.0m.
- 18. 1No.DN200 Vicking Johnson or Similar Coupling.. 19. 1No.DN200 Flanged Bell Mouth.
- 20. 1No.DN200 Double Flanged Pipe not exceeding 2.8m
- 21. 1No.DN200 Double Flanged Pipe not exceeding 2.0m.
- 22. 1No.DN200/100 All Flanged Tee.
- 23. 1No.DN200 Double Flanged Pipe not exceeding 1.0m.
- 24. 1No.DN200 All Flanged Duck foot 90° bend.
- 25. 1No.DN100 All Flanged Pipe with puddle flange n.e 2.0m.
- 26. 1No.DN100 All Flanged 90° bend.
- 27. 2No.DN100 Double Flanged Pipe not exceeding 0.4m.
- 28. 1No.DN100 Flanged Gate Valve.
- 29. 1No.DN200 Flanged Adaptor, Maxi type or similar.





MINISTRY OF WATER AND ENVIRONMENT DIRECTORATE OF WATER DEVELOPMENT (DWD)
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Consultant:



Corporate Headquarter 10 Philpot Lane, 1st Floor, London EC3M 8AA,


Drawing Title:

LEFORI RESERVOIR TANK_222m³ Top Plan

Scale:	Designed:	O.R Daniel
	Drawn:	P.S Eyamu
Date:	Checked:	O.R Daniel
Nov-2022	Approved:	O.R Daniel

ENGINEERING DESIGN DRAWING

Drg No: MWE/GWE/3.1.2 | Cad file No WSS<22_11>

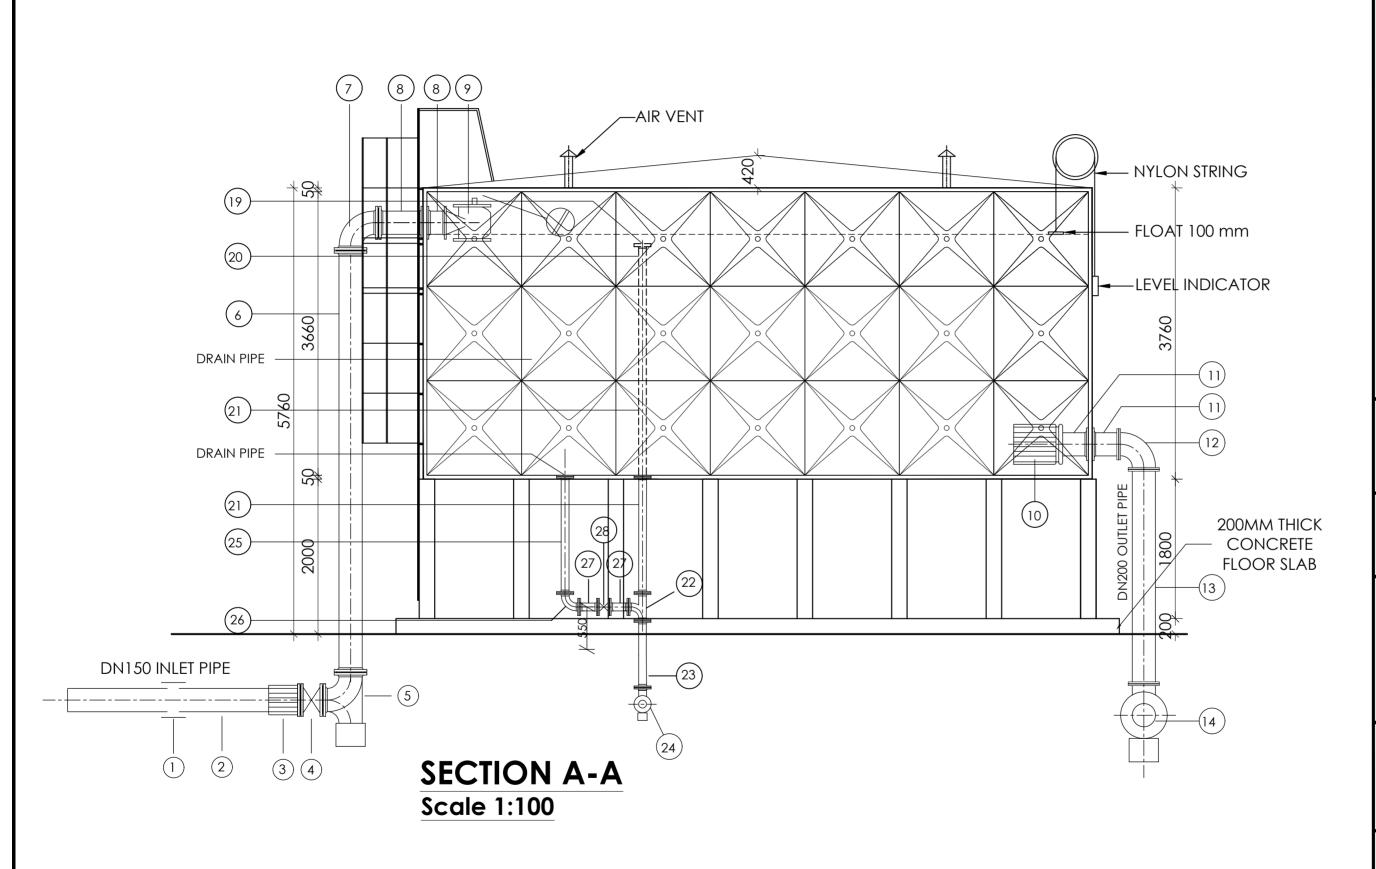

AMENDMENTS		
No	Date	Revision
1	4.8.2024	Draft Design

PIPE SCHEDULE

- 1. 1No.DN150 Vicking Johnson or Similar Coupling.
- 2. 1No.DN150 Pipe not exceeding 2.0m.
- 3. 1No.DN150 Flanged Adaptor, Maxi type or similar..
- 4. 1No.DN150 Flanged Gate Valve.
- 5. 1No.DN150 All Flanged Duck foot 90° bend..
- 6. 1No.DN150 Double Flanged Pipe not exceeding 6.0m.
- 7. 1No.DN150 All Flanged 90° bend.
- 8. 2No.DN150 Double Flanged Pipe not exceeding 0.5m.
- 9. 1No.DN150 Float Ball valve.
- 10. 1No.DN200 Flanged Outlet Pipe Strainer.
- 11. 2No.DN200 Double Flanged Pipe not exceeding 0.6m.
- 12. 1No.DN200 All Flanged 90° bend.
- 13. 1No.DN200 Double Flanged Pipe not exceeding 3.0m.
- 14. 1No.DN200 All Flanged Duck foot 90° bend.
- 15. 1No.DN200 Flanged Gate Valve.
- 16. 1No.DN200 Flanged Adaptor, Maxi type or similar.
- 17. 1No.DN200 Pipe not exceeding 2.0m.
- 18. 1No.DN200 Vicking Johnson or Similar Coupling..
- 19. 1No.DN200 Flanged Bell Mouth.
- 20. 1No.DN200 Double Flanged Pipe not exceeding 2.8m
- 21. 1No.DN200 Double Flanged Pipe not exceeding 2.0m.
- 22. 1No.DN200/100 All Flanged Tee.
- 23. 1No.DN200 Double Flanged Pipe not exceeding 1.0m.
- 24. 1No.DN200 All Flanged Duck foot 90° bend.
- 25. 1No.DN100 All Flanged Pipe with puddle flange n.e 2.0m.
- 26. 1No.DN100 All Flanged 90° bend. 27. 2No.DN100 Double Flanged Pipe not exceeding 0.4m.
- 28. 1No.DN100 Flanged Gate Valve.
- 29. 1No.DN200 Flanged Adaptor, Maxi type or similar.



GOVERNMENT OF UGANDA



MINISTRY OF WATER AND ENVIRONMENT DIRECTORATE OF WATER DEVELOPMENT (DWD)
RURAL WATER SUPPLY AND SANITATION DEPARTMENT
Plot 3 - 7 Kabalega Crescent Road, Luzira, Box 20026 Kampala
Tel : +256 417 889 400, Emait: mwe@mwe.go.ug
Website: www.mwe.go.ug

Consultancy Services for the Feability Study, Detailed Engineering Design and Construction Supervision of Solar Powered Piped Water Supply Systems and Sanitation Facilities
In Refugee Settlements and Host Districts In West Nile and Northern Uganda

- LOT 1 - MADI OKOLLO, TEREGO AND MOYO DISTRICTS -

CONSTRUCTION OF GWERE RGC WATER SUPPLY AND SANITATION SYSTEM

Consultant:



10 Philpot Lane, 1st Floor, London EC3M 8AA,


Drawing Title:

LEFORI RESERVOIR TANK_222m³ Section A-A

Scale:	Designed:	O.R Daniel
	Drawn:	P.S Eyamu
Date:	Checked:	O.R Daniel
Nov-2022	Approved:	O.R Daniel
ENCINEEDING DESIGN DRAWING		

ENGINEERING DESIGN DRAWING

Drg No: MWE/GWE/3.1.3 | Cad file No WSS<22_11>

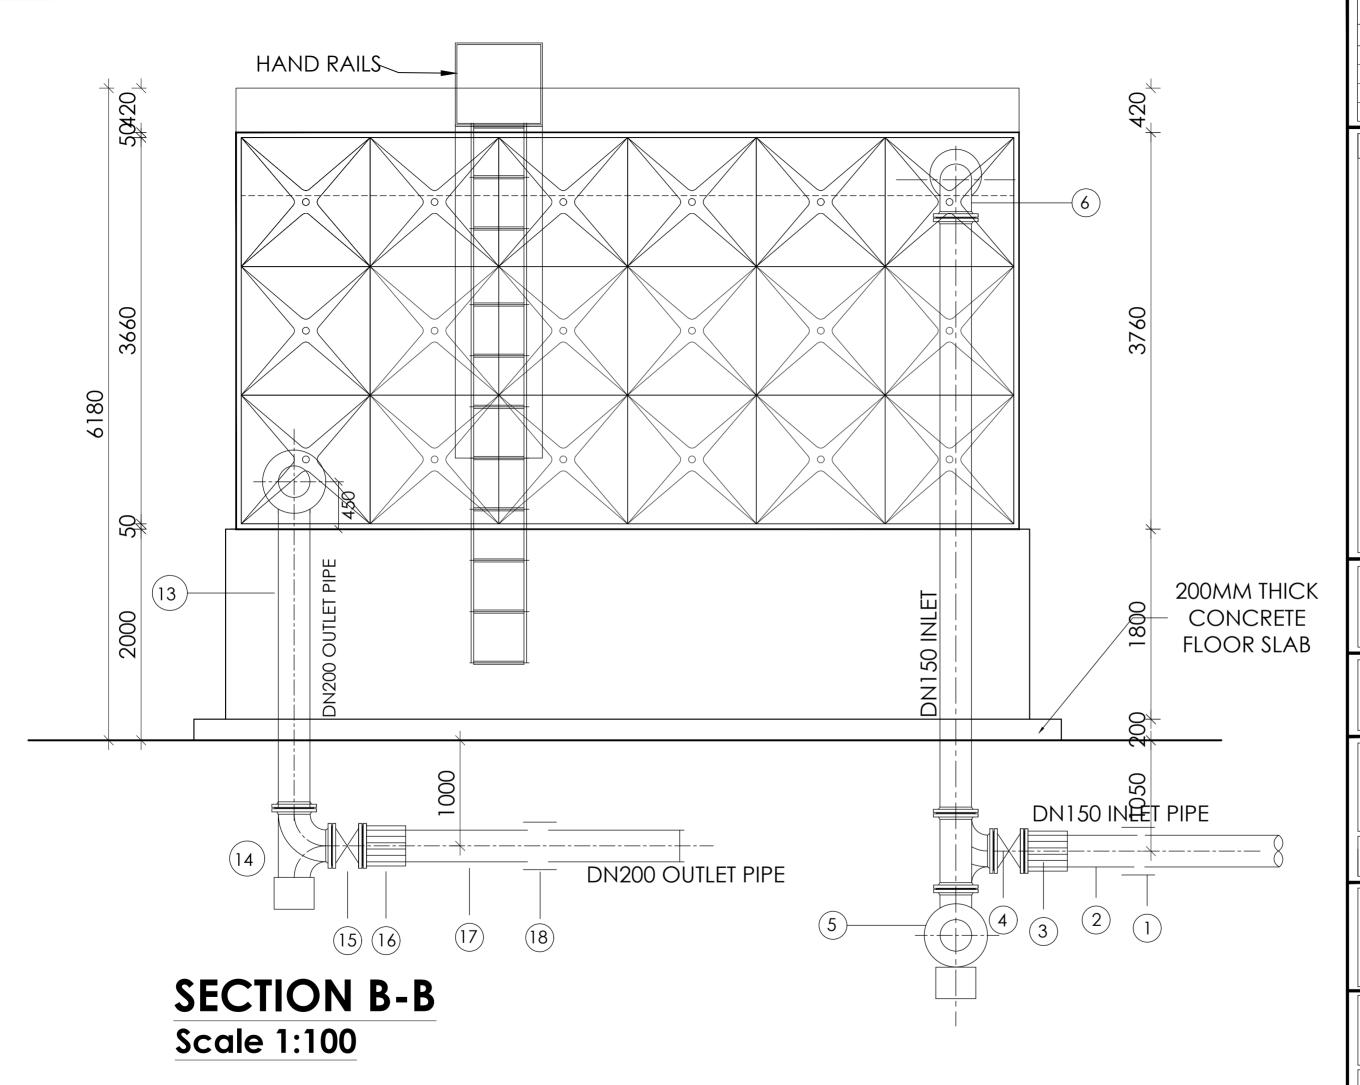

AM	AMENDMENTS		
No	Date	Revision	
1	4.8.2024	Draft Design	

PIPE SCHEDULE

- 1. 1No.DN150 Vicking Johnson or Similar Coupling.
- 2. 1No.DN150 Pipe not exceeding 2.0m.
- 3. 1No.DN150 Flanged Adaptor, Maxi type or similar...
- 4. 1No.DN150 Flanged Gate Valve.
- 5. 1No.DN150 All Flanged Duck foot 90° bend..
- 6. 1No.DN150 Double Flanged Pipe not exceeding 6.0m.
- 7. 1No.DN150 All Flanged 90° bend.
- 8. 2No.DN150 Double Flanged Pipe not exceeding 0.5m.
- 9. 1No.DN150 Float Ball valve.
- 10. 1No.DN200 Flanged Outlet Pipe Strainer.
- 11. 2No.DN200 Double Flanged Pipe not exceeding 0.6m.
- 12. 1No.DN200 All Flanged 90° bend.
- 13. 1No.DN200 Double Flanged Pipe not exceeding 3.0m.
- 14. 1No.DN200 All Flanged Duck foot 90° bend.
- 15. 1No.DN200 Flanged Gate Valve.
- 16. 1No.DN200 Flanged Adaptor, Maxi type or similar.
- 17. 1No.DN200 Pipe not exceeding 2.0m.
- 18. 1No.DN200 Vicking Johnson or Similar Coupling..
- 19. 1No.DN200 Flanged Bell Mouth.
- 20. 1No.DN200 Double Flanged Pipe not exceeding 2.8m
- 21. 1No.DN200 Double Flanged Pipe not exceeding 2.0m.
- 22. 1No.DN200/100 All Flanged Tee.
- 23. 1No.DN200 Double Flanged Pipe not exceeding 1.0m.
- 24. 1No.DN200 All Flanged Duck foot 90° bend. 25. 1No.DN100 All Flanged Pipe with puddle flange n.e 2.0m.
- 26. 1No.DN100 All Flanged 90° bend.
- 27. 2No.DN100 Double Flanged Pipe not exceeding 0.4m.
- 28. 1No.DN100 Flanged Gate Valve.
- 29. 1No.DN200 Flanged Adaptor, Maxi type or similar.

CO-FINANCE BY:







MINISTRY OF WATER AND ENVIRONMENT DIRECTORATE OF WATER DEVELOPMENT (DWD) RURAL WATER SUPPLY AND SANITATION DEPARTMENT Plot 3 - 7 Kabalega Crescent Road, Luzira, Box 20026 Kampala Tel: +256 417 889 400, Email: mwe@mwe.go.ug Website: www.mwe.go.ug

Consultancy Services for the Feability Study, Detailed Engineering Design and Construction Supervision of Solar Powered Piped Water Supply Systems and Sanitation Facilitie In Refugee Settlements and Host Districts In West Nile and Northern Uganda

- LOT 1 - MADI OKOLLO, TEREGO AND MOYO DISTRICTS

CONSTRUCTION OF GWERE RGC WATER SUPPLY AND SANITATION SYSTEM

Consultant:



10 Philpot Lane, 1st Floor, London EC3M 8AA,


Drawing Title:

LEFORI RESERVOIR TANK_222m3 Section B-B

Scale:	Designed:	O.R Daniel
	Drawn:	P.S Eyamu
Date:	Checked:	O.R Daniel
Nov-2022	Approved:	O.R Daniel
ENGINEEDING DEGICAL DRAWING		


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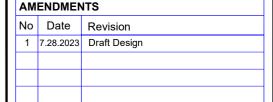
Drg No: MWE/GWE/3.1.4 Cad file No WSS<22_11>

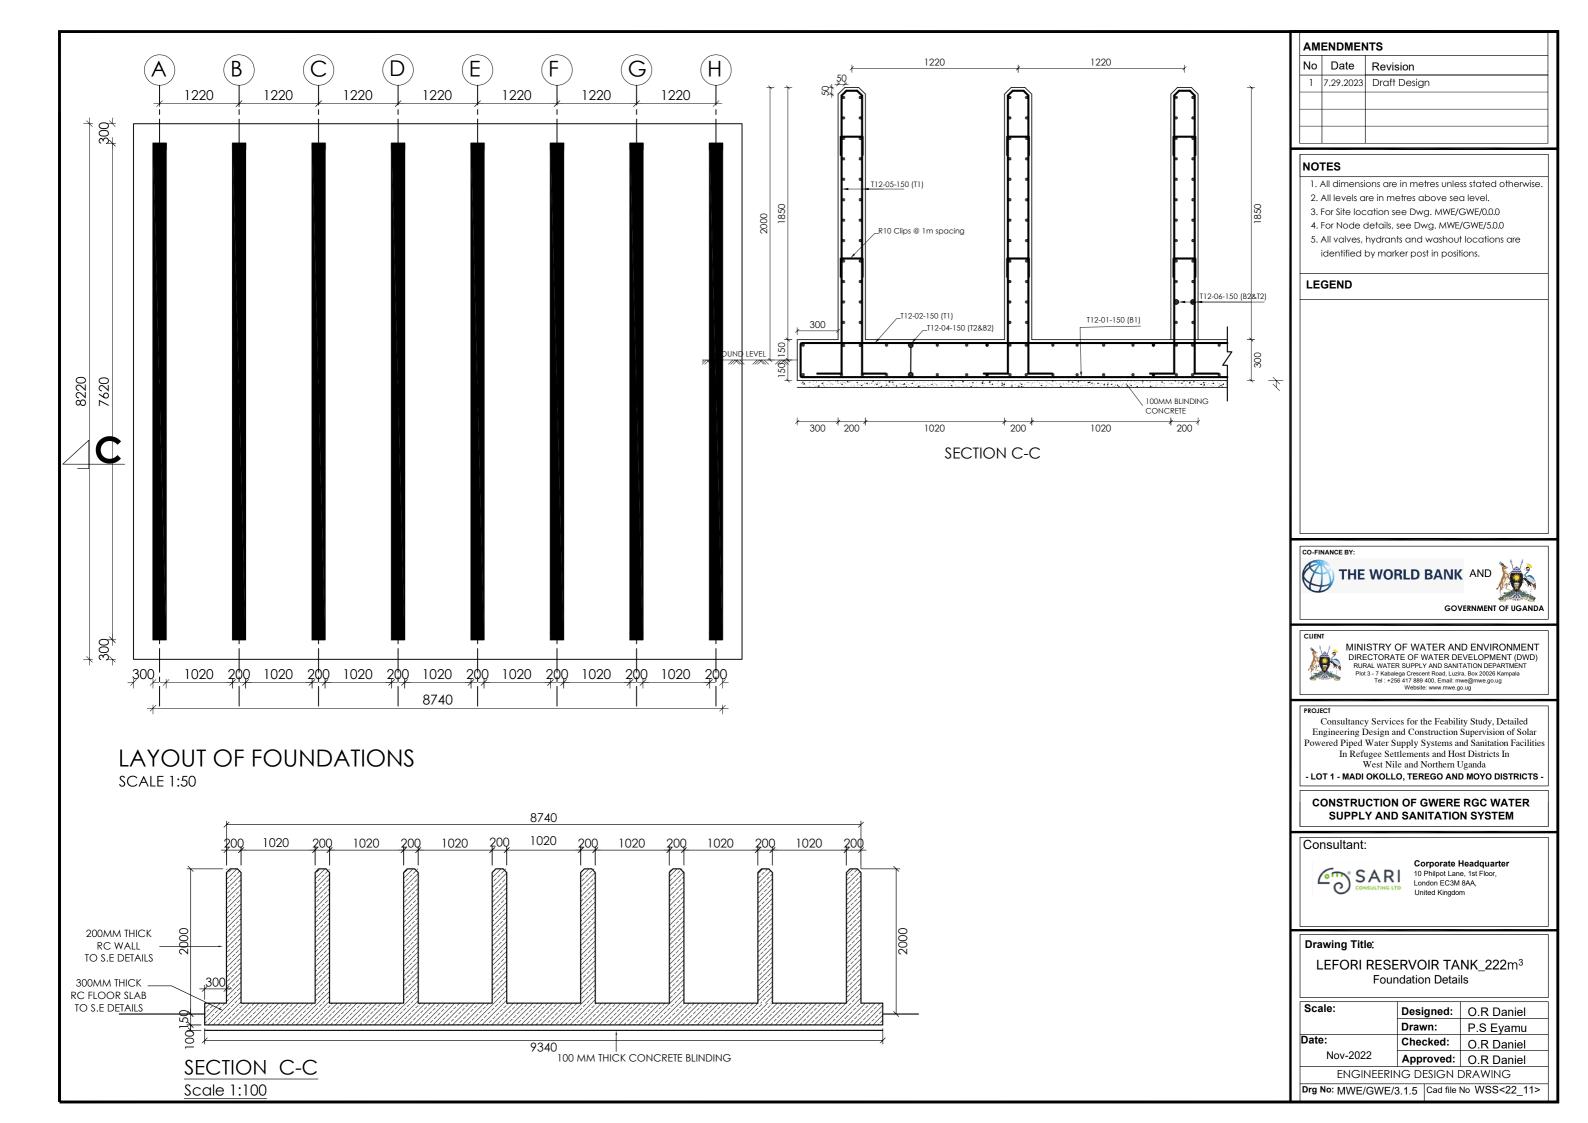

DISTRIBUTION MAINS

(Plan and Profile)




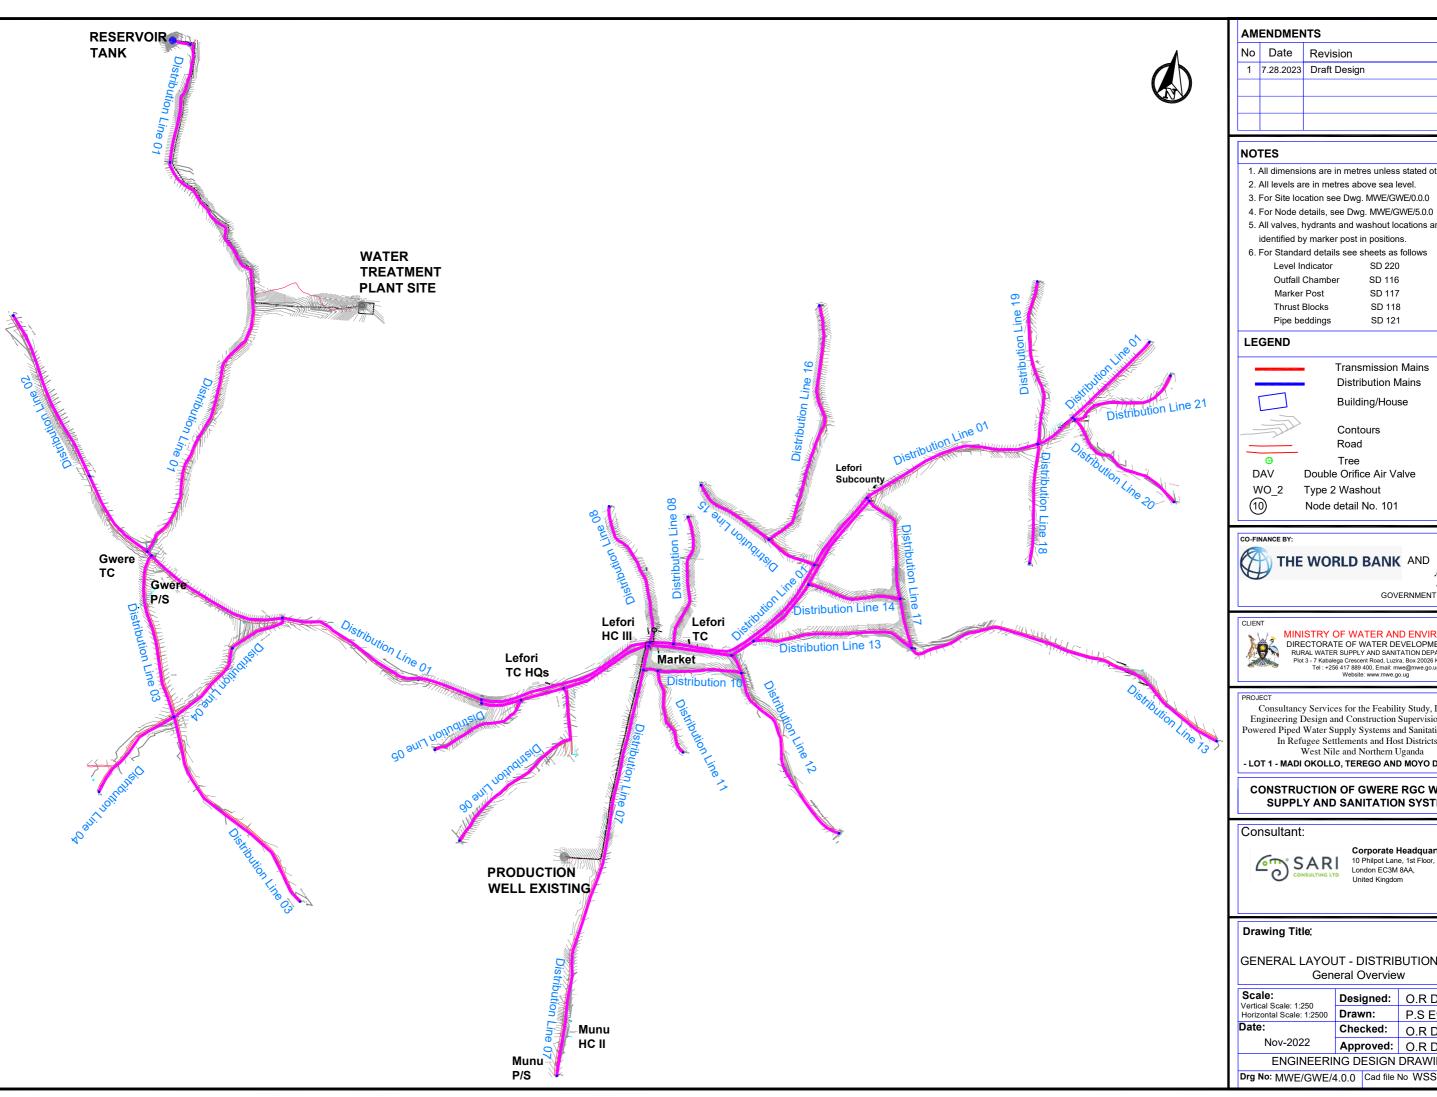

- 1. All dimensions are in metres unless stated otherwise.
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- 3. For Site location see Dwg. MWE/GWE/0.0.0
- 5. All valves, hydrants and washout locations are
- 6. For Standard details see sheets as follows

SD 220 SD 116 SD 117

SD 118 SD 121

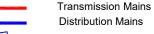

Road

Double Orifice Air Valve Type 2 Washout



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Consultancy Services for the Feability Study, Detailed Engineering Design and Construction Supervision of Solar Powered Piped Water Supply Systems and Sanitation Facilities In Refugee Settlements and Host Districts In
West Nile and Northern Uganda

- LOT 1 - MADI OKOLLO, TEREGO AND MOYO DISTRICTS -

CONSTRUCTION OF GWERE RGC WATER SUPPLY AND SANITATION SYSTEM


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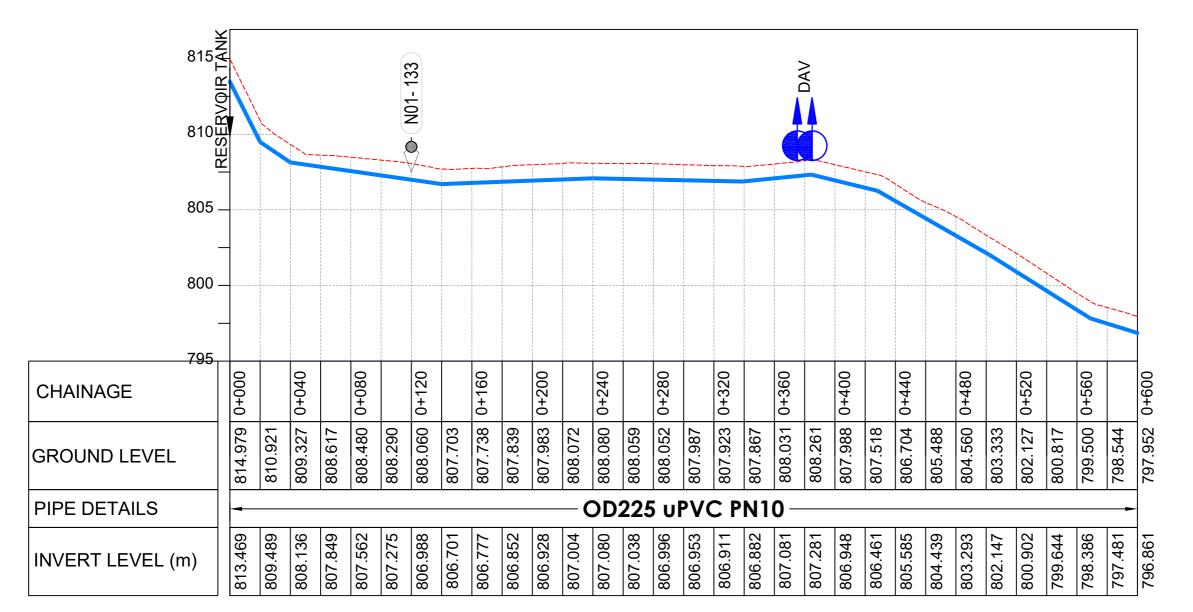
GENERAL LAYOUT - DISTRIBUTION MAINS General Overview

Scale:	Designed:	O.R Daniel
Vertical Scale: 1:250 Horizontal Scale: 1:2500	Drawn:	P.S Eyamu
Date:	Checked:	O.R Daniel
Nov-2022	Approved:	O.R Daniel

ENGINEERING DESIGN DRAWING

Drg No: MWE/GWE/4.0.0 Cad file No WSS<22_11>



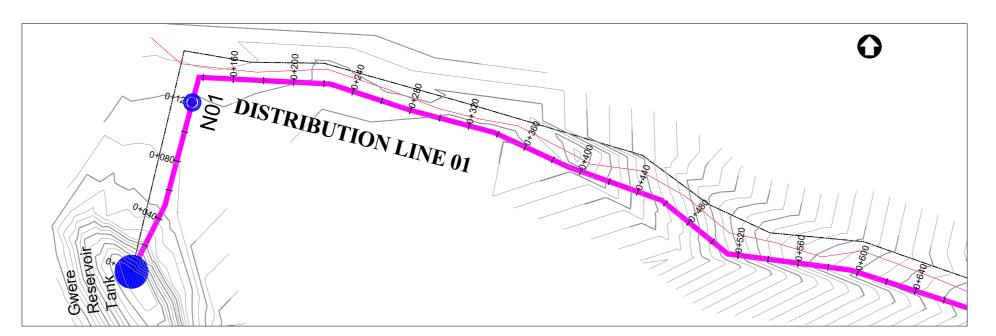

LONGITUDINAL PROFILE

AM	AMENDMENTS		
No	No Date Revision		
1	7.28.2023	Draft Design	

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- 4. For Node details, see Dwg. MWE/GWE/5.0.0
- 6. For Standard details see sheets as follows

Level Indicator SD 220 SD 116 Outfall Chamber SD 117 Thrust Blocks SD 118 Pipe beddings SD 121

LEGEND



Transmission Mains **Distribution Mains**

Building/House

Contours

Node detail No. 101

Road Tree

Double Orifice Air Valve WO_2 Type 2 Washout

10





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MINISTRY OF WATER AND ENVIRONMENT
DIRECTORATE OF WATER DEVELOPMENT (DWD)
RURAL WATER SUPPLY AND SANITATION DEPARTMENT
Plot 3 - 7 Kabalega Crescent Road, Luzira, Box 20026 Kampala
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LOT 1 - MADI OKOLLO, TEREGO AND MOYO DISTRICTS -

CONSTRUCTION OF GWERE RGC WATER **SUPPLY AND SANITATION SYSTEM**

Consultant:




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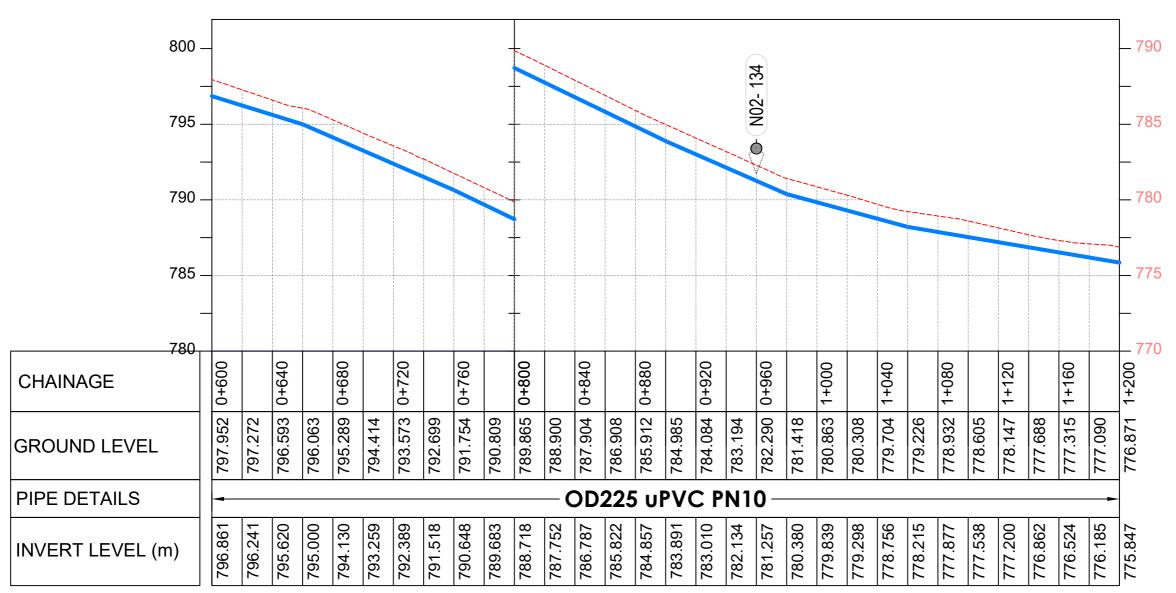
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Horizontal Scale: 1:2500	Drawn:	P.S Eyamu
Date:	Checked:	O.R Daniel
Nov-2022	Approved:	O.R Daniel

ENGINEERING DESIGN DRAWING

Drg No: MWE/GWE/4.1.1 Cad file No WSS<22_11>



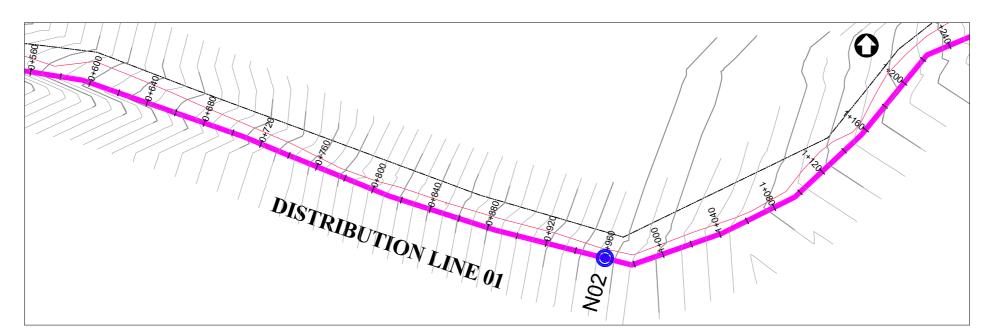

AMENDMENTS

	No	Date	Revision
	1	7.28.2023	Draft Design
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- 4. For Node details, see Dwg. MWE/GWE/5.0.0
- 5. All valves, hydrants and washout locations are identified by marker post in positions
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Level Indicator SD 220 Outfall Chamber SD 116 Marker Post SD 117

Thrust Blocks SD 118 SD 121 Pipe beddings

LEGEND



Transmission Mains **Distribution Mains**

Building/House

Contours Road

Tree Double Orifice Air Valve

Type 2 Washout Node detail No. 101

DAV

WO_2

10



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GOVERNMENT OF UGANDA

MINISTRY OF WATER AND ENVIRONMENT

DIRECTORATE OF WATER DEVELOPMENT (DWD)
RURAL WATER SUPPLY AND SANITATION DEPARTMENT
Plot 3 - 7 Kabalega Crescent Road, Luzira, Box 20026 Kampala
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- LOT 1 - MADI OKOLLO, TEREGO AND MOYO DISTRICTS

CONSTRUCTION OF GWERE RGC WATER **SUPPLY AND SANITATION SYSTEM**

Consultant:





10 Philpot Lane, 1st Floor, London EC3M 8AA,

DISTRIBUTION LINE 01 Distribution Line 01 (CH 0+600.00 - 1+200.00)

Scale: Vertical Scale: 1:250	Designed:	O.R Daniel	
Horizontal Scale: 1:2500	Drawn:	P.S Eyamu	
Date:	Checked:	O.R Daniel	
Nov-2022	Approved:	O.R Daniel	
ENGINEERING DESIGN DRAWIN			

Drg No: MWE/GWE/4.1.2 Cad file No WSS<22_11>

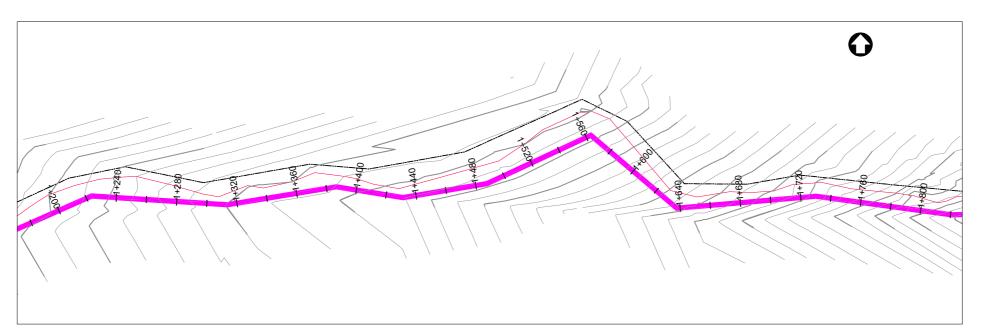

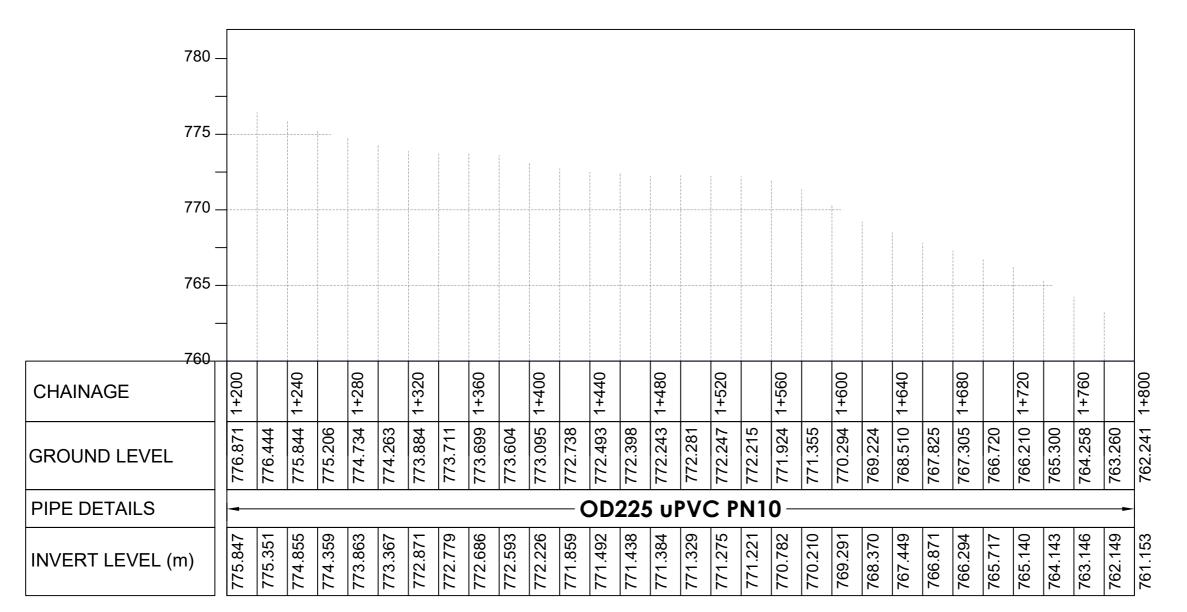

LONGITUDINAL PROFILE

AM	AMENDMENTS		
No Date Revision			
1	7.28.2023	Draft Design	

NOTES

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- 4. For Node details, see Dwg. MWE/GWE/5.0.0
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- 6. For Standard details see sheets as follows

Level Indicator SD 220 SD 116 Outfall Chamber SD 117

Thrust Blocks SD 118 Pipe beddings SD 121

LEGEND





Contours Road

Double Orifice Air Valve WO_2 Type 2 Washout

Node detail No. 101

Tree

10



GOVERNMENT OF UGANDA



MINISTRY OF WATER AND ENVIRONMENT
DIRECTORATE OF WATER DEVELOPMENT (DWD)
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- LOT 1 - MADI OKOLLO, TEREGO AND MOYO DISTRICTS -

CONSTRUCTION OF GWERE RGC WATER **SUPPLY AND SANITATION SYSTEM**

Consultant:




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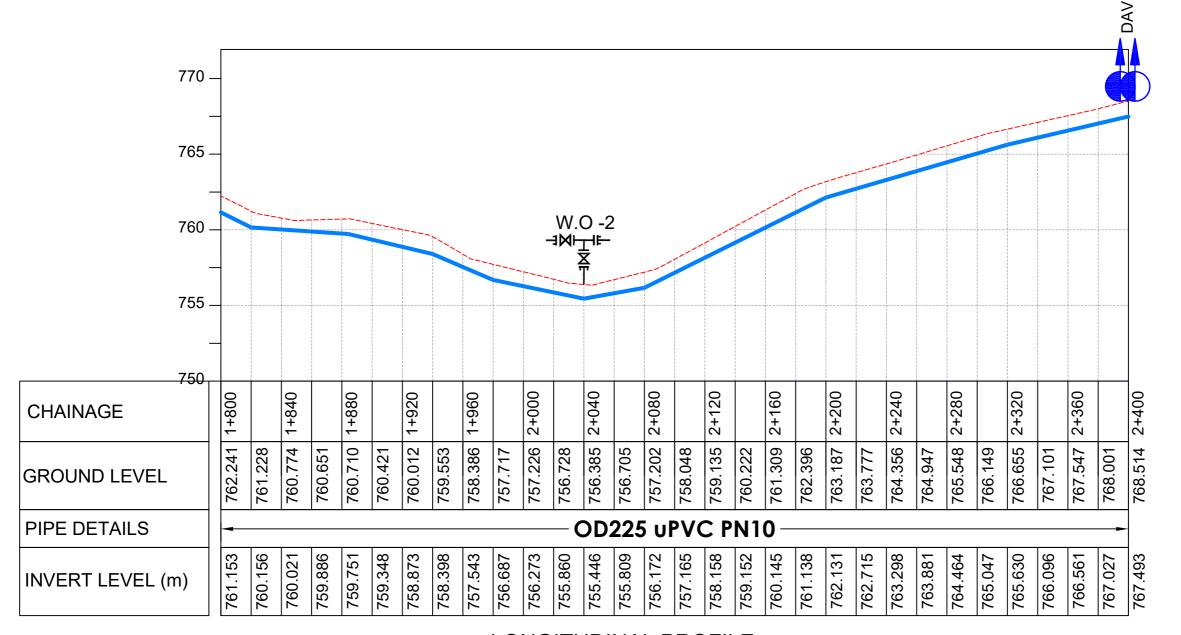
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Scale: Vertical Scale: 1:250	Designed:	O.R Daniel		
Horizontal Scale: 1:2500	Drawn:	P.S Eyamu		
Date:	Checked:	O.R Daniel		
Nov-2022	Approved:	O.R Daniel		

ENGINEERING DESIGN DRAWING

Drg No: MWE/GWE/4.1.3 Cad file No WSS<22_11>



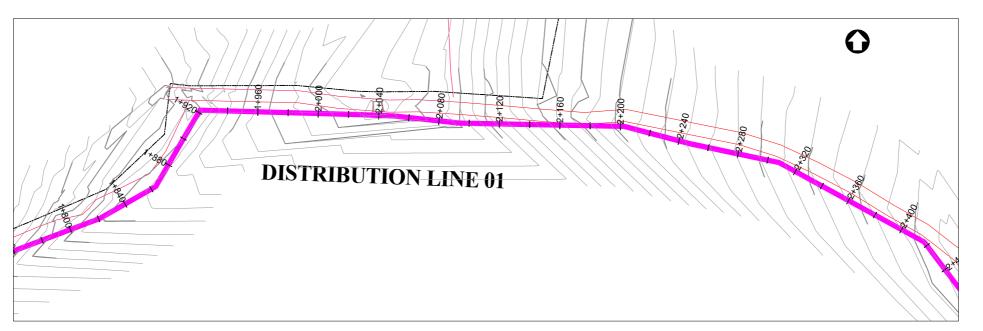

AMENDMENTS

No	Date	Revision
1	7.28.2023	Draft Design


NOTES

- 1. All dimensions are in metres unless stated otherwise.
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- 3. For Site location see Dwg. MWE/GWE/0.0.0
- 4. For Node details, see Dwg. MWE/GWE/5.0.0
- 5. All valves, hydrants and washout locations are identified by marker post in positions

SD 220 Level Indicator SD 116 Outfall Chamber Marker Post SD 117 Thrust Blocks SD 118

LEGEND

Pipe beddings

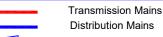

SD 121

Building/House

Contours Road

Tree DAV Double Orifice Air Valve Type 2 Washout WO_2

10 Node detail No. 101





GOVERNMENT OF UGANDA



MINISTRY OF WATER AND ENVIRONMENT
DIRECTORATE OF WATER DEVELOPMENT (DWD)
RURAL WATER SUPPLY AND SANITATION DEPARTMENT
Plot 3 - 7 Kabalega Crescent Road, Luzira, Box 20026 Kampala
Tel: +256 417 889 400, Email: mwe@mwe.go.ug
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Consultancy Services for the Feability Study, Detailed Engineering Design and Construction Supervision of Solar Powered Piped Water Supply Systems and Sanitation Facilities In Refugee Settlements and Host Districts In West Nile and Northern Uganda

- LOT 1 - MADI OKOLLO, TEREGO AND MOYO DISTRICTS

CONSTRUCTION OF GWERE RGC WATER **SUPPLY AND SANITATION SYSTEM**

Consultant:




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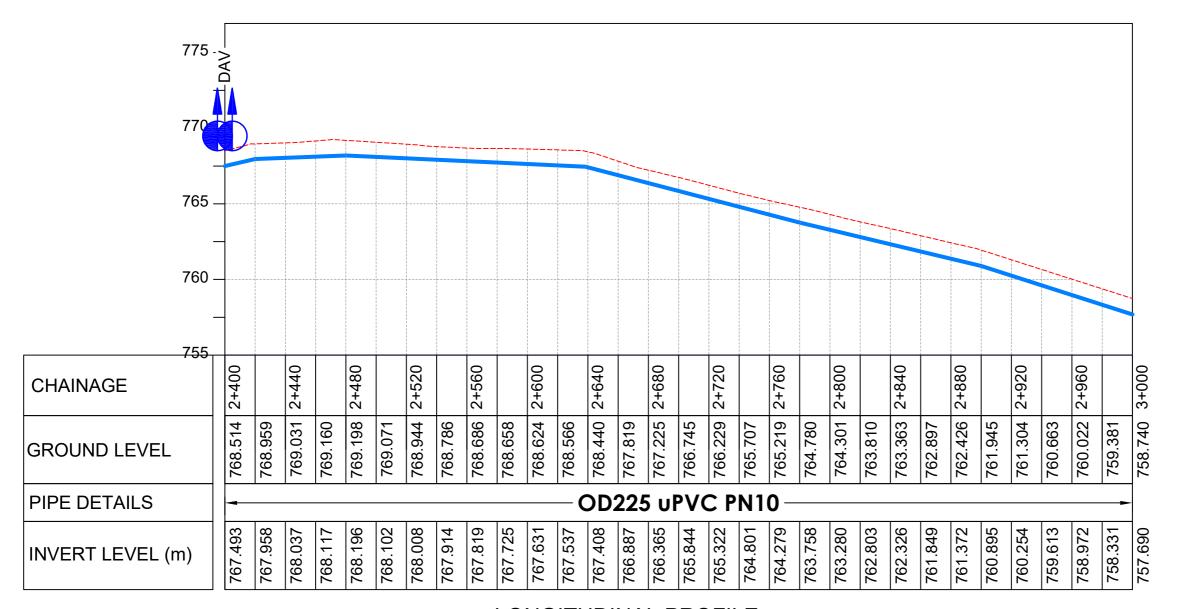
DISTRIBUTION LINE 01 Distribution Line 01 (CH 1+800.00 - 2+400.00)

Scale: Vertical Scale: 1:250	Designed:	O.R Daniel		
Horizontal Scale: 1:2500	Drawn:	P.S Eyamu		
Date:	Checked:	O.R Daniel		
Nov-2022	Approved:	O.R Daniel		

ENGINEERING DESIGN DRAWING

Drg No: MWE/GWE/4.1.4 Cad file No WSS<22_11>



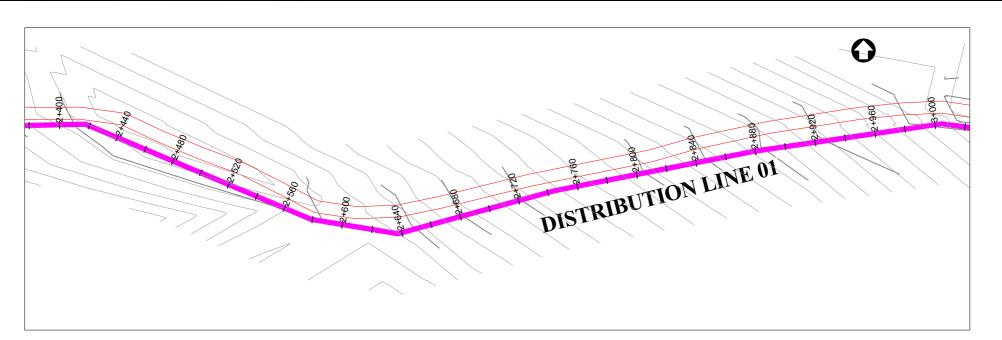

No Date Revision 1 7.28.2023 Draft Design

NOTES

AMENDMENTS

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- 3. For Site location see Dwg. MWE/GWE/0.0.0
- 4. For Node details, see Dwg. MWE/GWE/5.0.0
- All valves, hydrants and washout locations are identified by marker post in positions.
- 6. For Standard details see sheets as follows

Level Indicator SD 220
Outfall Chamber SD 116
Marker Post SD 117
Thrust Blocks SD 118
Pipe beddings SD 121

LEGEND



Transmission Mains
Distribution Mains

Building/House

Contours

Road Tree

DAV Double Orifice Air Valve WO_2 Type 2 Washout

CO-FINANCE BY:



10

THE WORLD BANK AND

Node detail No. 101

GOVERNMENT OF UGANDA

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MINISTRY OF WATER AND ENVIRONMENT

DIRECTORATE OF WATER DEVELOPMENT (DWD)

RURAL WATER SUPPLY AND SANITATION DEPARTMENT

Plot 3 - 7 Kabalega Crescent Road, Luzira, Box 20026 Kampala

Tel: +256 417 889 400, Email: mwe@mwe.go.ug

Website: www.mwe.go.ug

PROJE

Consultancy Services for the Feability Study, Detailed Engineering Design and Construction Supervision of Solar Powered Piped Water Supply Systems and Sanitation Facilities In Refugee Settlements and Host Districts In West Nile and Northern Uganda

- LOT 1 - MADI OKOLLO, TEREGO AND MOYO DISTRICTS -

CONSTRUCTION OF GWERE RGC WATER SUPPLY AND SANITATION SYSTEM

Consultant:




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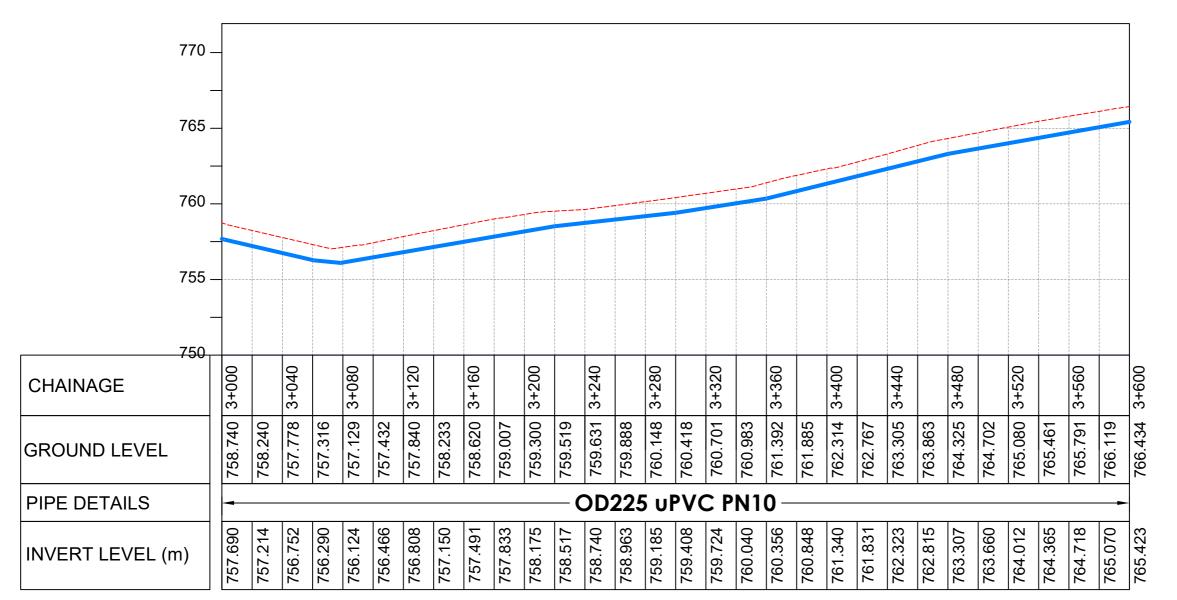
Drawing Title:

DISTRIBUTION LINE 01
Distribution Line 01 (CH 2+400.00 - 3+000.00)

Scale: Vertical Scale: 1:250 Horizontal Scale: 1:2500	Designed:	O.R Daniel
	Drawn:	P.S Eyamu
Date:	Checked:	O.R Daniel
Nov-2022	Approved:	O.R Daniel
ENGINEERING DESIGN DRAWING		

Drg No: MWE/GWE/4.1.5 Cad file No WSS<22_11>



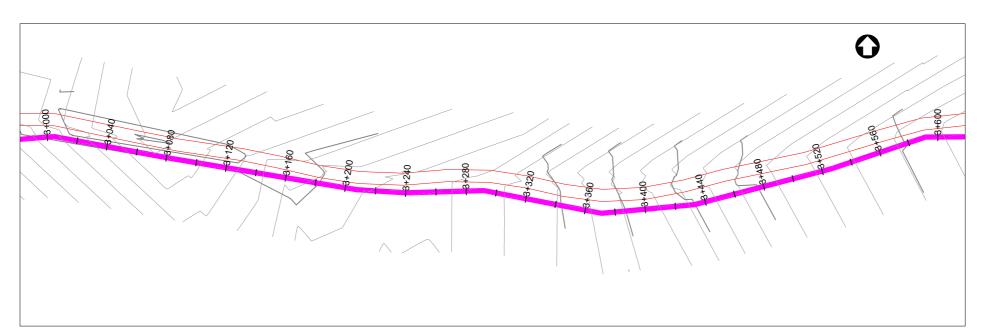

LONGITUDINAL PROFILE

AM	AMENDMENTS	
No	Date	Revision
1	7.28.2023	Draft Design

NOTES

- 1. All dimensions are in metres unless stated otherwise.
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- 3. For Site location see Dwg. MWE/GWE/0.0.0
- 4. For Node details, see Dwg. MWE/GWE/5.0.0
- 6. For Standard details see sheets as follows

Level Indicator SD 220 SD 116 Outfall Chamber SD 117 Thrust Blocks SD 118

LEGEND



Pipe beddings

Transmission Mains

SD 121

Distribution Mains Building/House

Contours Road

Tree

Double Orifice Air Valve

Type 2 Washout Node detail No. 101

10

WO_2





GOVERNMENT OF UGANDA



MINISTRY OF WATER AND ENVIRONMENT
DIRECTORATE OF WATER DEVELOPMENT (DWD)
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- LOT 1 - MADI OKOLLO, TEREGO AND MOYO DISTRICTS -

CONSTRUCTION OF GWERE RGC WATER **SUPPLY AND SANITATION SYSTEM**

Consultant:




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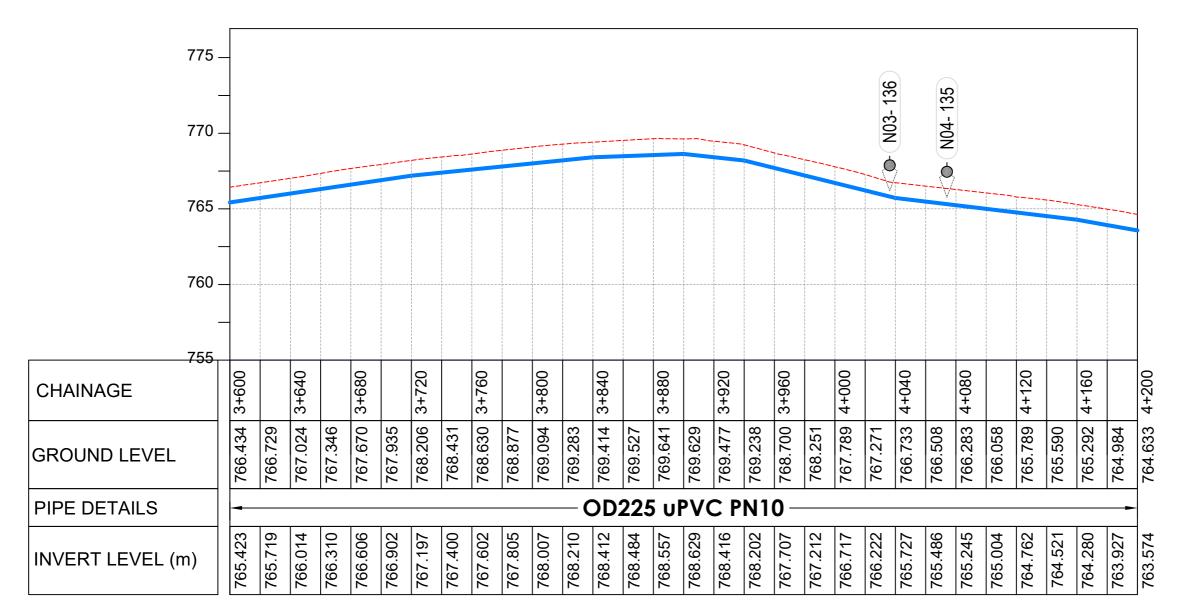
DISTRIBUTION LINE 01 Distribution Line 01 (CH 3+000.00 - 3+600.00)

Scale: Vertical Scale: 1:250	Designed:	O.R Daniel
Horizontal Scale: 1:250	Drawn:	P.S Eyamu
Date:	Checked:	O.R Daniel
Nov-2022	Approved:	O.R Daniel

ENGINEERING DESIGN DRAWING

Drg No: MWE/GWE/4.1.6 Cad file No WSS<22_11>



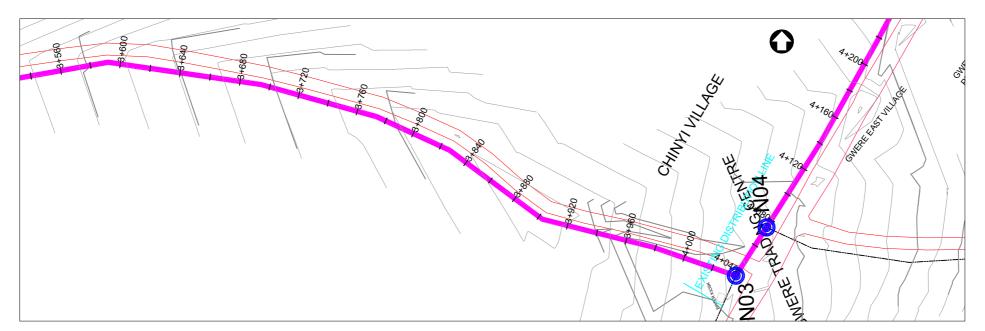

LONGITUDINAL PROFILE

AM	AMENDMENTS	
No	Date	Revision
1	7.28.2023	Draft Design

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Level Indicator SD 220 SD 116 Outfall Chamber SD 117 Thrust Blocks SD 118 Pipe beddings SD 121

LEGEND



Transmission Mains **Distribution Mains**

Building/House

Contours Road

Tree

Double Orifice Air Valve WO_2 Type 2 Washout

Node detail No. 101

10



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MINISTRY OF WATER AND ENVIRONMENT
DIRECTORATE OF WATER DEVELOPMENT (DWD)
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- LOT 1 - MADI OKOLLO, TEREGO AND MOYO DISTRICTS -

CONSTRUCTION OF GWERE RGC WATER **SUPPLY AND SANITATION SYSTEM**

Consultant:




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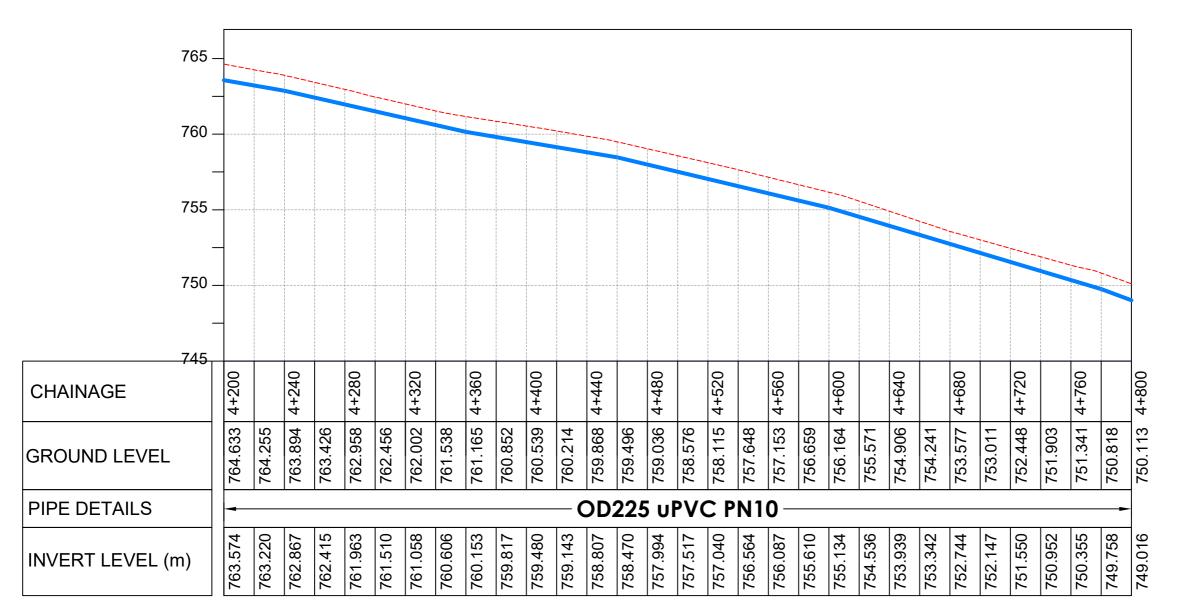
DISTRIBUTION LINE 01 Distribution Line 01 (CH 3+600.00 - 4+200.00)

Scale: Vertical Scale: 1:250	Designed:	O.R Daniel
Horizontal Scale: 1:2500	Drawn:	P.S Eyamu
Date:	Checked:	O.R Daniel
Nov-2022	Approved:	O.R Daniel

ENGINEERING DESIGN DRAWING

Drg No: MWE/GWE/4.1.7 | Cad file No WSS<22_11>



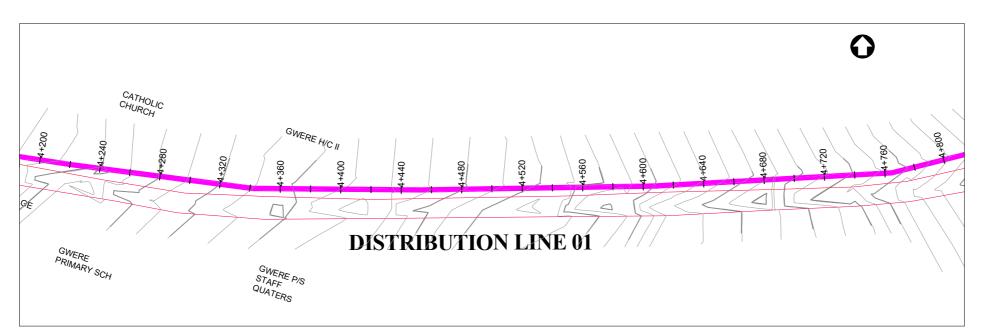

LONGITUDINAL PROFILE

AM	AMENDMENTS		
No	Date	Revision	
1	7.28.2023	Draft Design	

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Level Indicator SD 220 SD 116 Outfall Chamber SD 117 Thrust Blocks SD 118 Pipe beddings SD 121

LEGEND



Transmission Mains

Distribution Mains

Building/House

Contours Road

Tree Double Orifice Air Valve WO_2

Type 2 Washout Node detail No. 101

CO-FINANCE BY

10



GOVERNMENT OF UGANDA

MINISTRY OF WATER AND ENVIRONMENT
DIRECTORATE OF WATER DEVELOPMENT (DWD)
RURAL WATER SUPPLY AND SANITATION DEPARTMENT
Plot 3 - 7 Kabalega Crescent Road, Luzira, Box 20026 Kampala
Tel: +256 417 889 400, Email: mwe@mwe.go.ug
Website: www.mwe.go.ug

Consultancy Services for the Feability Study, Detailed Engineering Design and Construction Supervision of Solar Powered Piped Water Supply Systems and Sanitation Facilities In Refugee Settlements and Host Districts In West Nile and Northern Uganda

- LOT 1 - MADI OKOLLO, TEREGO AND MOYO DISTRICTS -

CONSTRUCTION OF GWERE RGC WATER **SUPPLY AND SANITATION SYSTEM**

Consultant:




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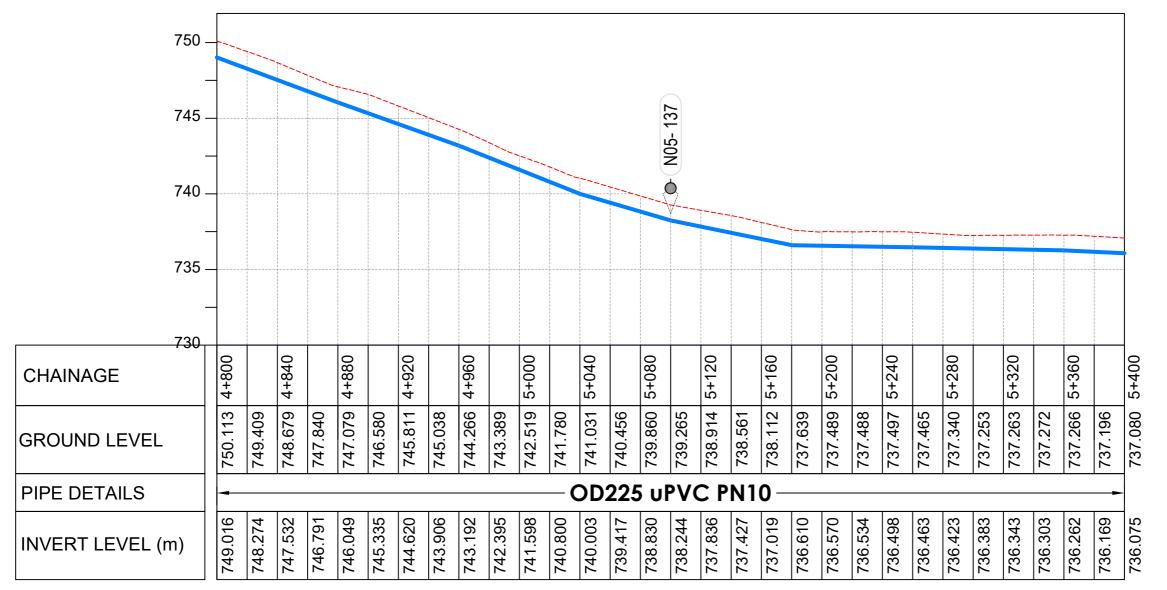
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Scale: Vertical Scale: 1:250	Designed:	O.R Daniel	
Horizontal Scale: 1:250	Drawn:	P.S Eyamu	
Date:	Checked:	O.R Daniel	
Nov-2022	Approved:	O.R Daniel	

ENGINEERING DESIGN DRAWING

Drg No: MWE/GWE/4.1.8 Cad file No WSS<22_11>



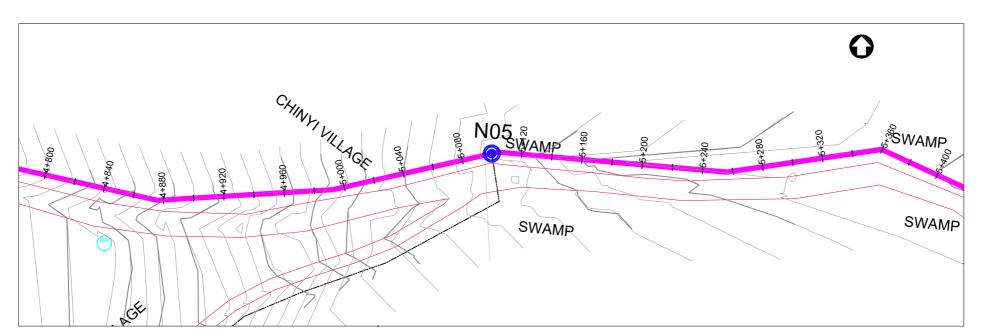

LONGITUDINAL PROFILE

AM	AMENDMENTS	
No	Date	Revision
1	7.28.2023	Draft Design

NOTES

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- 4. For Node details, see Dwg. MWE/GWE/5.0.0
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Level Indicator SD 220 SD 116 Outfall Chamber SD 117

Thrust Blocks SD 118 Pipe beddings SD 121

LEGEND



Transmission Mains **Distribution Mains**

Building/House

Contours Road

Tree Double Orifice Air Valve

WO_2 Type 2 Washout Node detail No. 101

10



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CONSTRUCTION OF GWERE RGC WATER **SUPPLY AND SANITATION SYSTEM**

Consultant:




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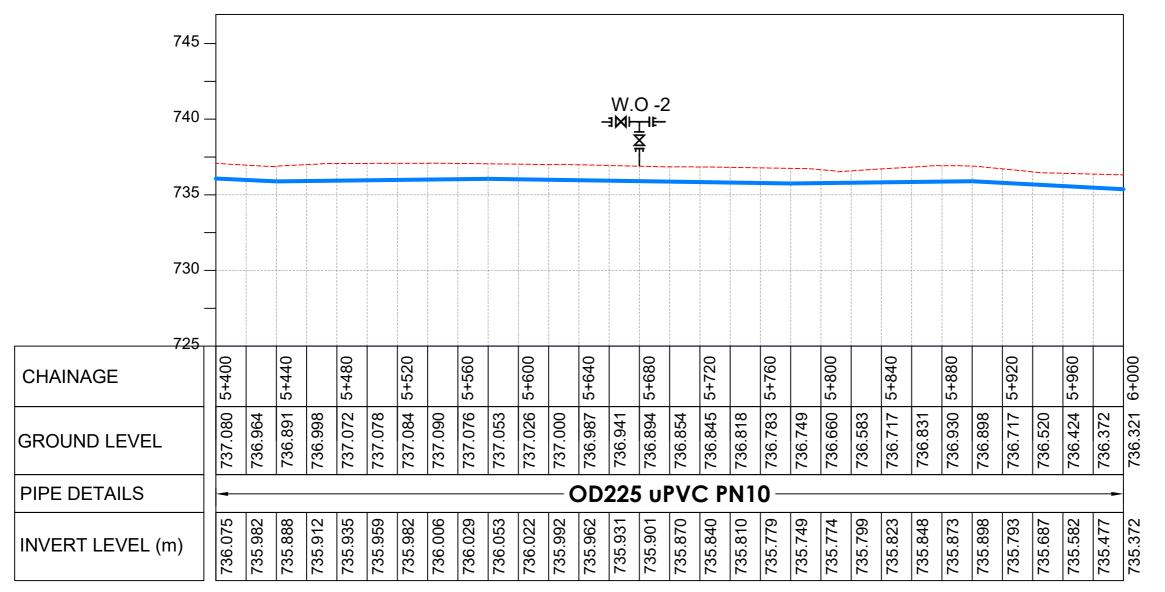
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Vertical Scale: 1:250 Horizontal Scale: 1:2500	Drawn:	P.S Eyamu		
Date:	Checked:	O.R Daniel		
Nov-2022	Approved:	O.R Daniel		

ENGINEERING DESIGN DRAWING

Drg No: MWE/GWE/4.1.9 | Cad file No WSS<22_11>



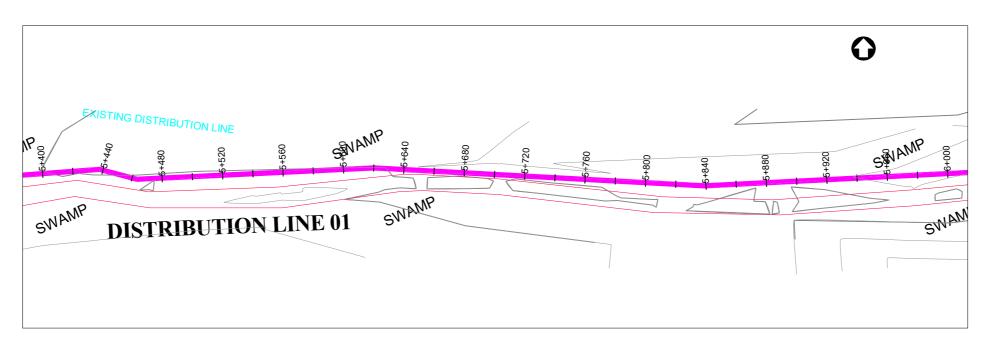

LONGITUDINAL PROFILE

AM	AMENDMENTS	
No	Date	Revision
1	7.28.2023	Draft Design

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- identified by marker post in positions
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Level Indicator SD 220 SD 116 Outfall Chamber SD 117 Thrust Blocks SD 118

Pipe beddings SD 121

LEGEND



Contours Road

Tree Double Orifice Air Valve WO_2 Type 2 Washout

10 Node detail No. 101

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MINISTRY OF WATER AND ENVIRONMENT
DIRECTORATE OF WATER DEVELOPMENT (DWD)
RURAL WATER SUPPLY AND SANITATION DEPARTMENT
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- LOT 1 - MADI OKOLLO, TEREGO AND MOYO DISTRICTS -

CONSTRUCTION OF GWERE RGC WATER **SUPPLY AND SANITATION SYSTEM**

Consultant:




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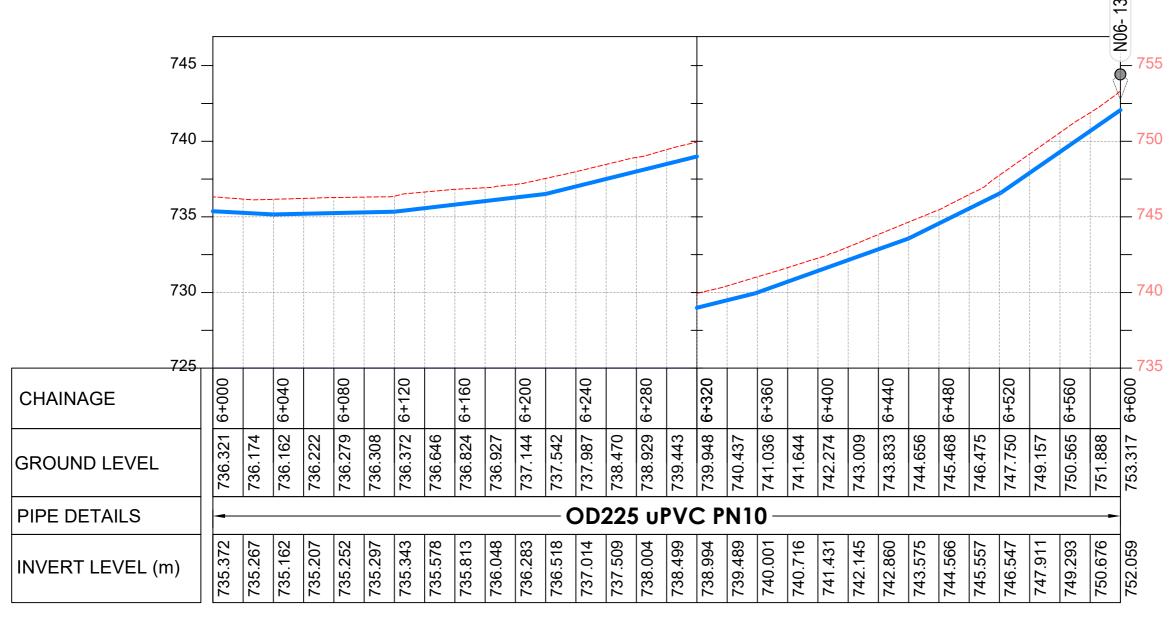
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Horizontal Scale: 1:2500	Drawn:	P.S Eyamu	
Date:	Checked:	O.R Daniel	
Nov-2022	Approved:	O.R Daniel	

ENGINEERING DESIGN DRAWING

Drg No: MWE/GWE/4.1.10 Cad file No WSS<22_11>



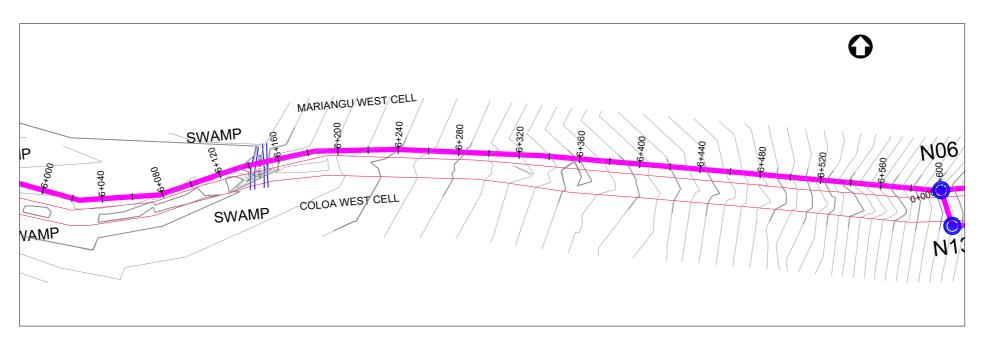

LONGITUDINAL PROFILE

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No	Date	Revision	
1	7.28.2023	Draft Design	

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- 6. For Standard details see sheets as follows

Level Indicator SD 220 SD 116 Outfall Chamber SD 117

Thrust Blocks SD 118 Pipe beddings SD 121

LEGEND



Transmission Mains **Distribution Mains**

Building/House

Contours

Road

Tree

Node detail No. 101

Double Orifice Air Valve WO_2 Type 2 Washout

10



GOVERNMENT OF UGANDA

MINISTRY OF WATER AND ENVIRONMENT
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- LOT 1 - MADI OKOLLO, TEREGO AND MOYO DISTRICTS

CONSTRUCTION OF GWERE RGC WATER **SUPPLY AND SANITATION SYSTEM**

Consultant:





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DISTRIBUTION LINE 01 Distribution Line 01 (CH 6+000.00 - 6+600.00)

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Horizontal Scale: 1:2500	Drawn:	P.S Eyamu
Date:	Checked:	O.R Daniel
Nov-2022	Approved:	O.R Daniel

ENGINEERING DESIGN DRAWING Drg No: MWE/GWE/4.1.11 Cad file No WSS<22_11>



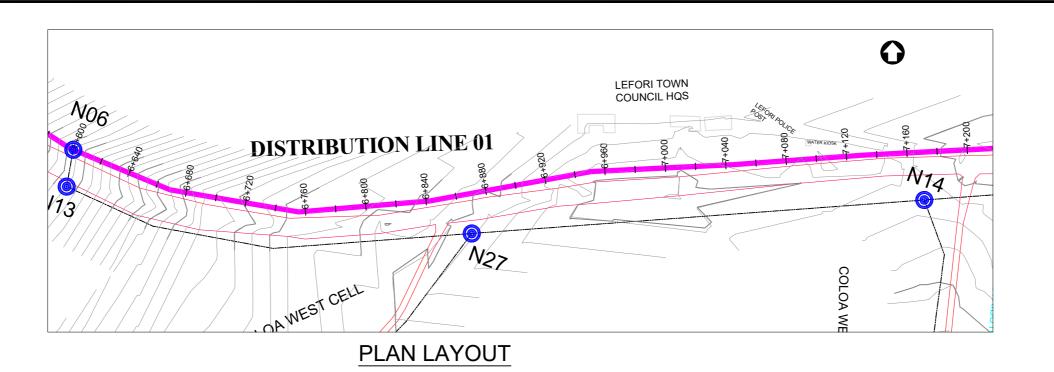

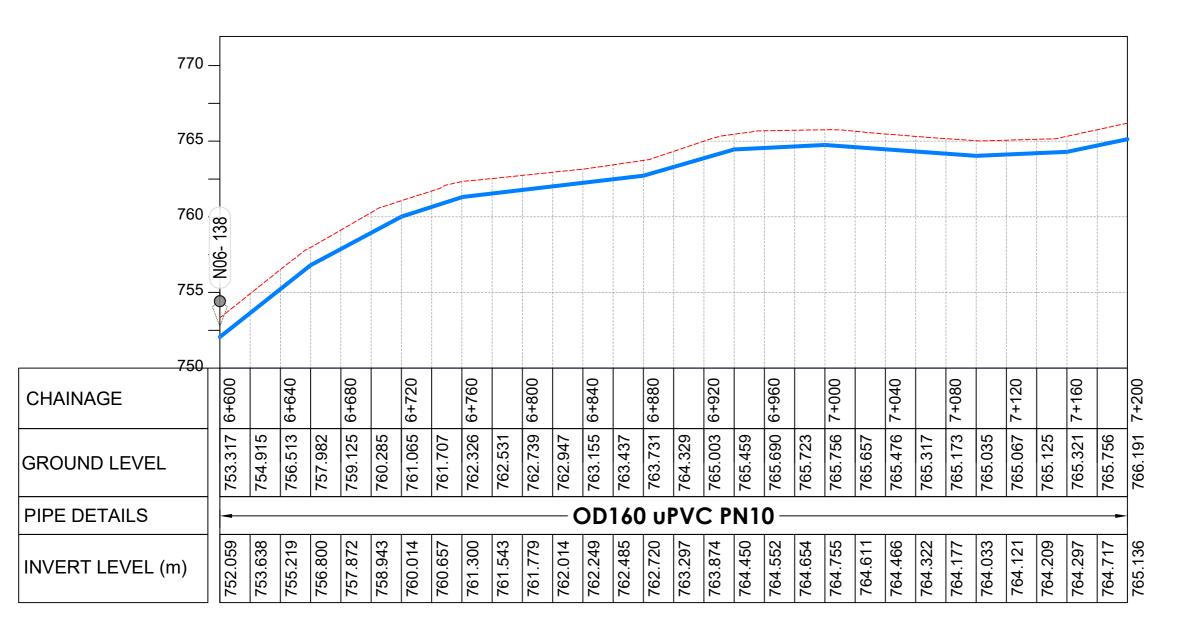LONGITUDINAL PROFILE

AM	AMENDMENTS	
No	Date	Revision
1	7.28.2023	Draft Design

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Level Indicator SD 220 SD 116 Outfall Chamber SD 117

Thrust Blocks SD 118 Pipe beddings SD 121

LEGEND



Transmission Mains

Distribution Mains Building/House

Contours Road

Tree Double Orifice Air Valve

Type 2 Washout

Node detail No. 101

CO-FINANCE BY

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WO_2



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MINISTRY OF WATER AND ENVIRONMENT
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- LOT 1 - MADI OKOLLO, TEREGO AND MOYO DISTRICTS -

CONSTRUCTION OF GWERE RGC WATER **SUPPLY AND SANITATION SYSTEM**

Consultant:




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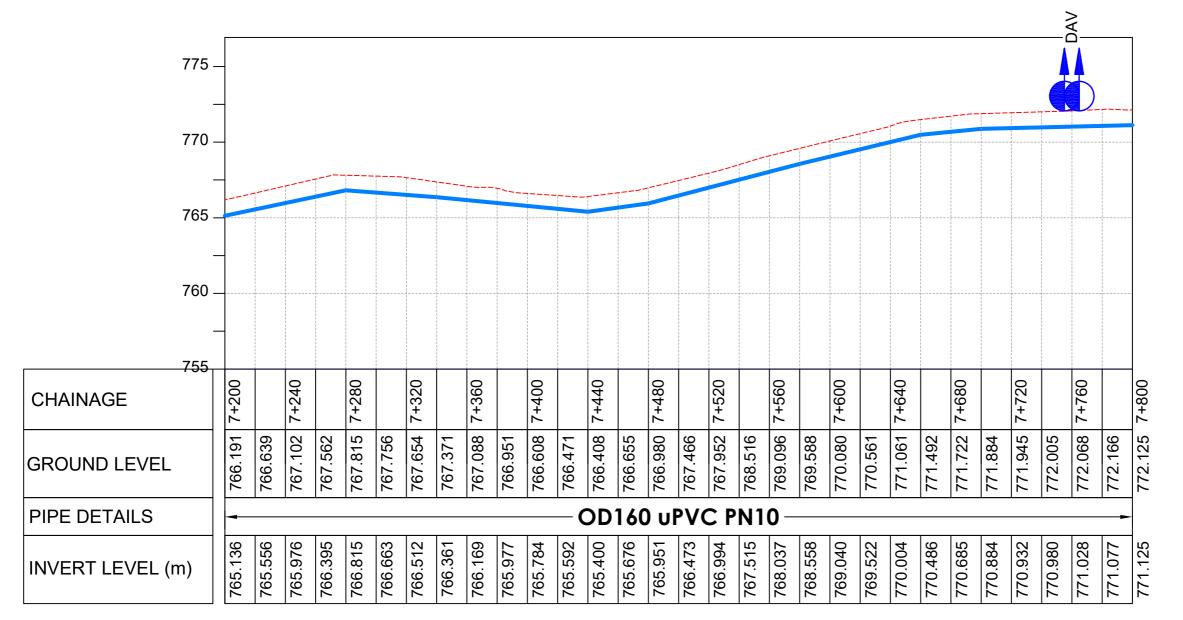
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Vertical Scale: 1:250 Horizontal Scale: 1:2500	Drawn:	P.S Eyamu		
Date:	Checked:	O.R Daniel		
Nov-2022	Approved:	O.R Daniel		

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Drg No: MWE/GWE/4.1.12 Cad file No WSS<22_11>





LONGITUDINAL PROFILE

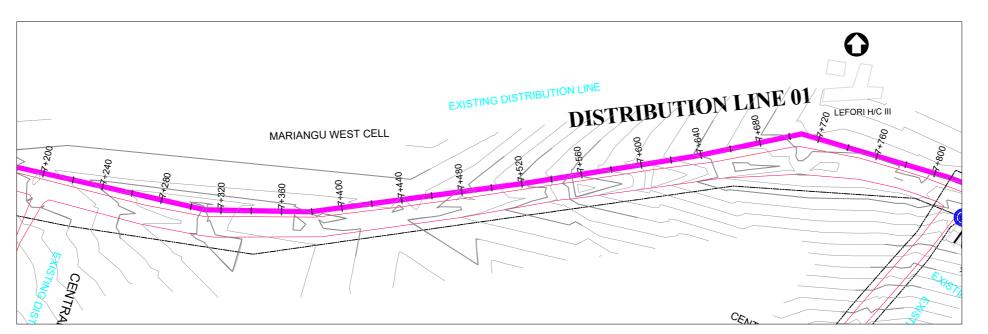AM	AMENDMENTS	
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Level Indicator SD 220 SD 116 Outfall Chamber SD 117

Thrust Blocks SD 118 Pipe beddings SD 121

LEGEND



Transmission Mains

Distribution Mains

Building/House

Contours Road

Tree Double Orifice Air Valve

Type 2 Washout

Node detail No. 101

CO-FINANCE BY

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WO_2



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CONSTRUCTION OF GWERE RGC WATER **SUPPLY AND SANITATION SYSTEM**

Consultant:



10 Philpot Lane, 1st Floor,


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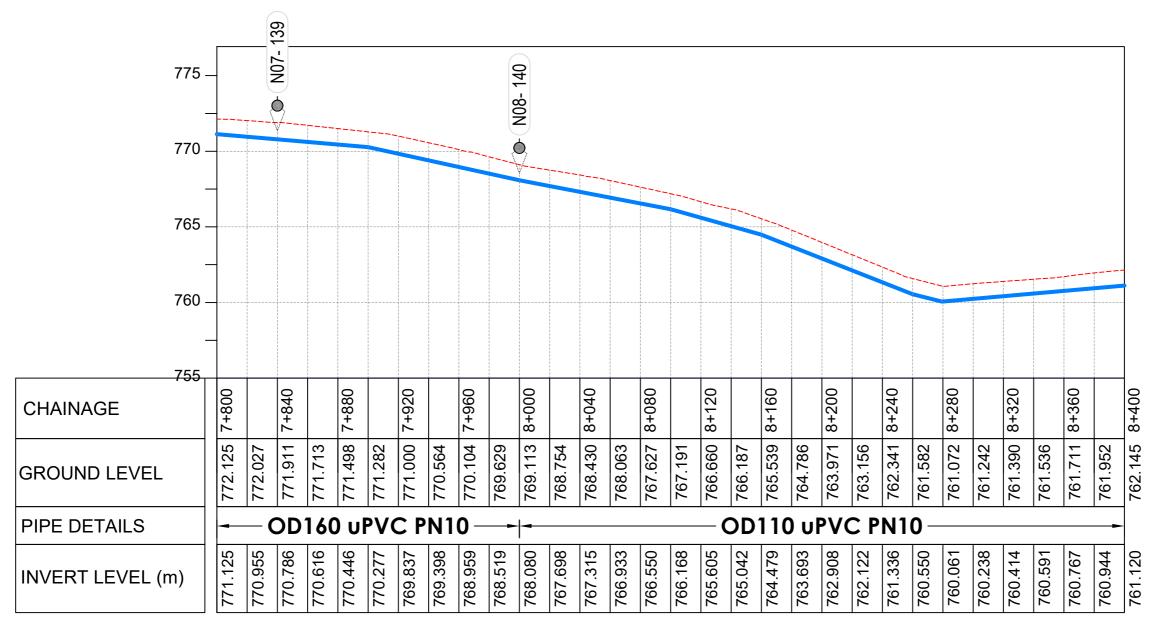
DISTRIBUTION LINE 01 Distribution Line 01 (CH 7+200.00 - 7+800.00)

Scale: Vertical Scale: 1:250	Designed:	O.R Daniel	
Horizontal Scale: 1:2500	Drawn:	P.S Eyamu	
Date:	Checked:	O.R Daniel	
Nov-2022	Approved:	O.R Daniel	

ENGINEERING DESIGN DRAWING

Drg No: MWE/GWE/4.1.13 Cad file No WSS<22_11>



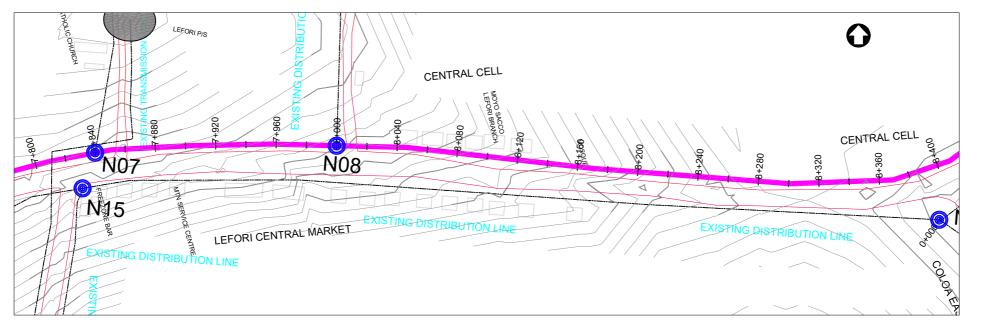

LONGITUDINAL PROFILE

ΑM	AMENDMENTS	
No	Date	Revision
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Level Indicator SD 220 SD 116 Outfall Chamber SD 117 Thrust Blocks SD 118 Pipe beddings SD 121

LEGEND



Transmission Mains **Distribution Mains**

Building/House

Contours

Road Tree

Node detail No. 101

Double Orifice Air Valve WO_2 Type 2 Washout

10



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MINISTRY OF WATER AND ENVIRONMENT
DIRECTORATE OF WATER DEVELOPMENT (DWD)
RURAL WATER SUPPLY AND SANITATION DEPARTMENT
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- LOT 1 - MADI OKOLLO, TEREGO AND MOYO DISTRICTS -

CONSTRUCTION OF GWERE RGC WATER **SUPPLY AND SANITATION SYSTEM**

Consultant:




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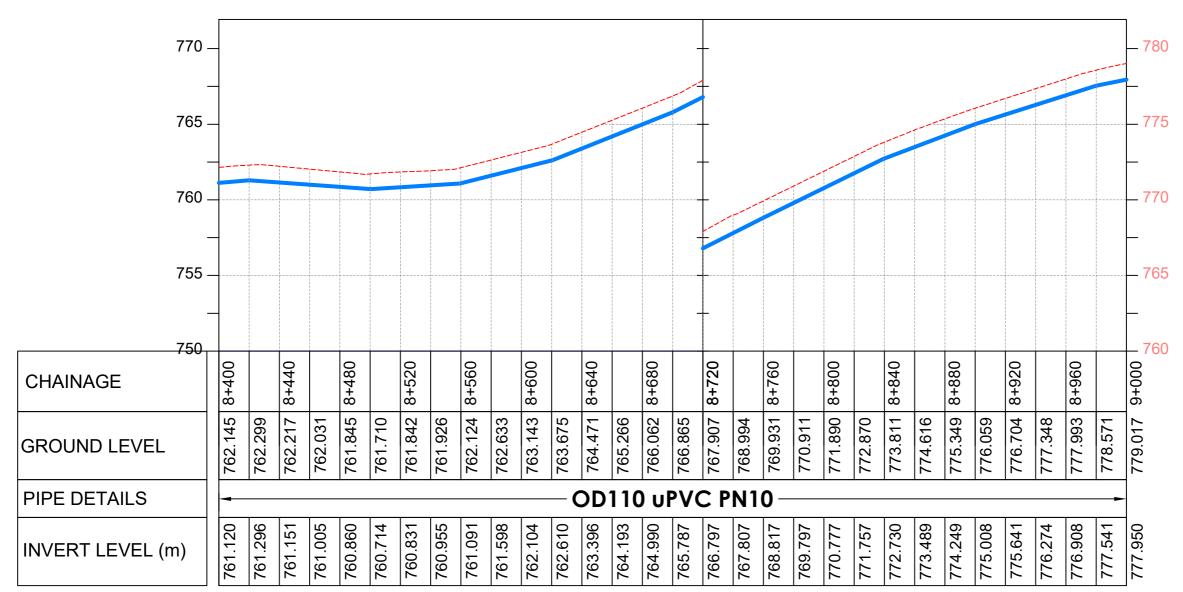
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Horizontal Scale: 1:2500	Drawn:	P.S Eyamu		
Date:	Checked:	O.R Daniel		
Nov-2022	Approved:	O.R Daniel		
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ENGINEERING DESIGN DRAWING

Drg No: MWE/GWE/4.1.14 Cad file No WSS<22_11>





LONGITUDINAL PROFILE

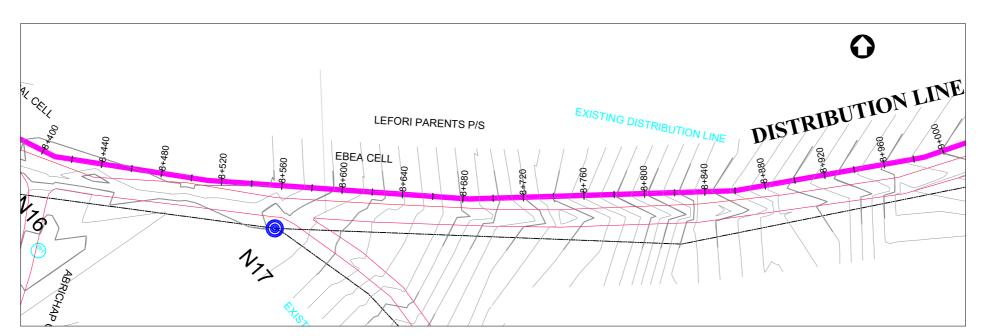ı	AM	AMENDMENTS		
l	No	Date	Revision	
ı	1	7.28.2023	Draft Design	
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Level Indicator SD 220 SD 116 Outfall Chamber SD 117 Thrust Blocks SD 118

Pipe beddings SD 121

LEGEND



Transmission Mains **Distribution Mains**

Contours Road

Tree Double Orifice Air Valve WO_2 Type 2 Washout

Node detail No. 101

10



GOVERNMENT OF UGANDA

MINISTRY OF WATER AND ENVIRONMENT
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CONSTRUCTION OF GWERE RGC WATER **SUPPLY AND SANITATION SYSTEM**

Consultant:




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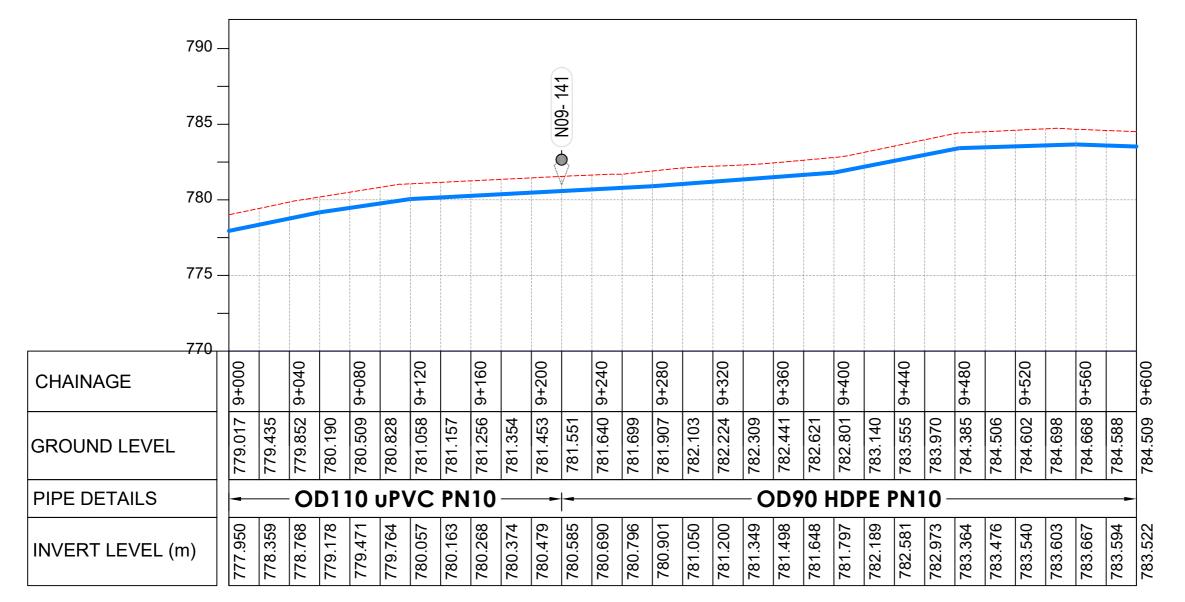
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Horizontal Scale: 1:250	Drawn:	P.S Eyamu			
Date:	Checked:	O.R Daniel			
Nov-2022	Approved:	O.R Daniel			

ENGINEERING DESIGN DRAWING Drg No: MWE/GWE/4.1.15 Cad file No WSS<22_11>





LONGITUDINAL PROFILE

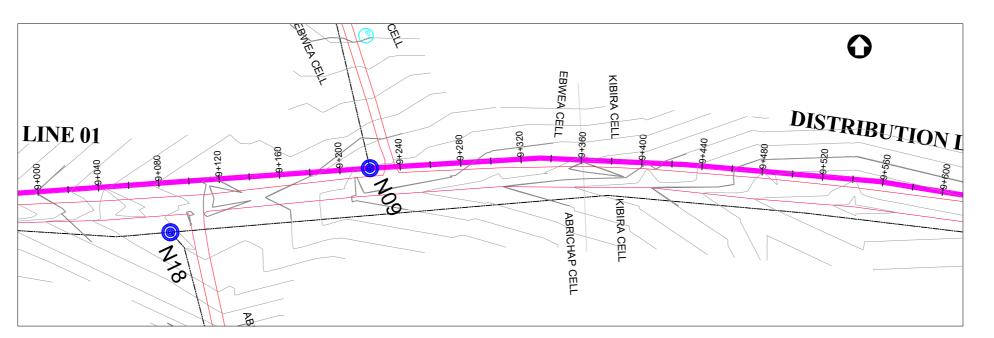AM	AMENDMENTS		
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1	7.28.2023	Draft Design	

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Level Indicator SD 220 SD 116 Outfall Chamber SD 117 Thrust Blocks SD 118 Pipe beddings SD 121

LEGEND



Transmission Mains

Distribution Mains Building/House

Contours Road

Tree Double Orifice Air Valve WO_2

Type 2 Washout Node detail No. 101

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GOVERNMENT OF UGANDA



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CONSTRUCTION OF GWERE RGC WATER **SUPPLY AND SANITATION SYSTEM**

Consultant:





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DISTRIBUTION LINE 01 Distribution Line 01 (CH 9+000.00 - 9+600.00)

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Horizontal Scale: 1:2500	Drawn:	P.S Eyamu
Date:	Checked:	O.R Daniel
Nov-2022	Approved:	O.R Daniel

ENGINEERING DESIGN DRAWING Drg No: MWE/GWE/4.1.16 Cad file No WSS<22_11>



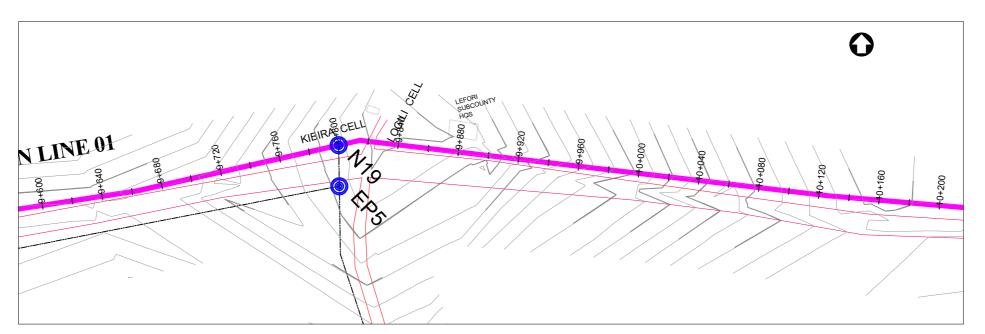

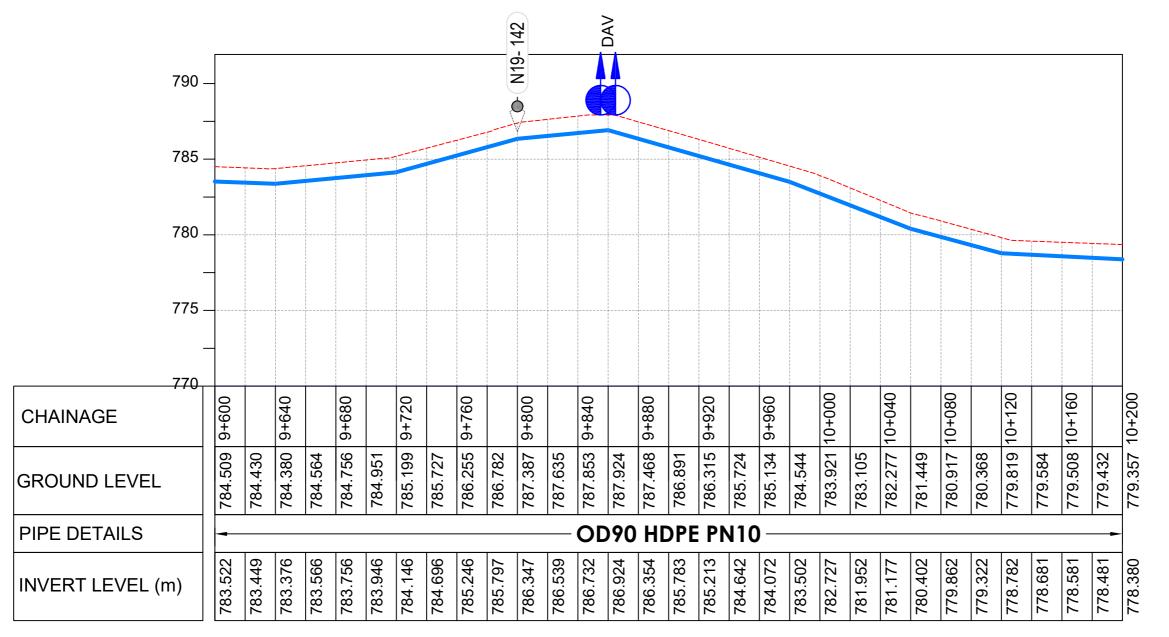LONGITUDINAL PROFILE

AM	AMENDMENTS		
No	Date	Revision	
1	7.28.2023	Draft Design	

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- 4. For Node details, see Dwg. MWE/GWE/5.0.0
- 6. For Standard details see sheets as follows

Level Indicator SD 220 SD 116 Outfall Chamber SD 117 Thrust Blocks SD 118

Pipe beddings SD 121

LEGEND



Transmission Mains **Distribution Mains**

Building/House

Contours

Road

Double Orifice Air Valve WO_2 Type 2 Washout

Node detail No. 101

Tree

10



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MINISTRY OF WATER AND ENVIRONMENT
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- LOT 1 - MADI OKOLLO, TEREGO AND MOYO DISTRICTS -

CONSTRUCTION OF GWERE RGC WATER **SUPPLY AND SANITATION SYSTEM**

Consultant:



10 Philpot Lane, 1st Floor,

Drawing Title:


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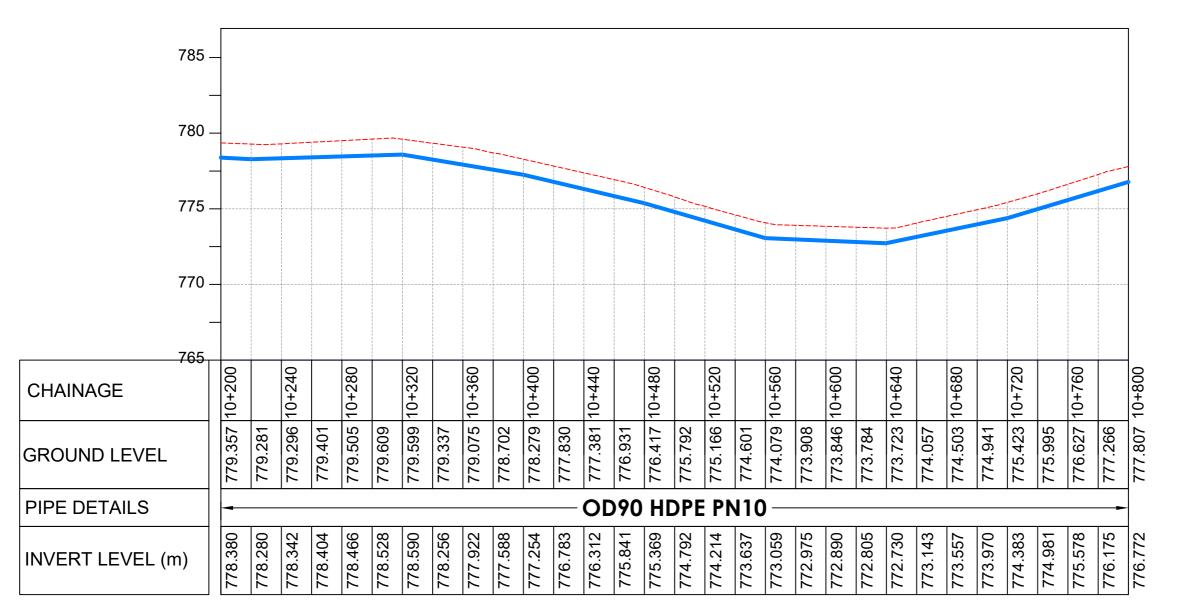
Distribution Line 01 (CH 9+600.00 - 10+200.00)

Designed: O.R Daniel Vertical Scale: 1:250 Horizontal Scale: 1:2500 Drawn: P.S Eyamu Checked: O.R Daniel Approved: O.R Daniel

ENGINEERING DESIGN DRAWING

Drg No: MWE/GWE/4.1.17 Cad file No WSS<22_11>



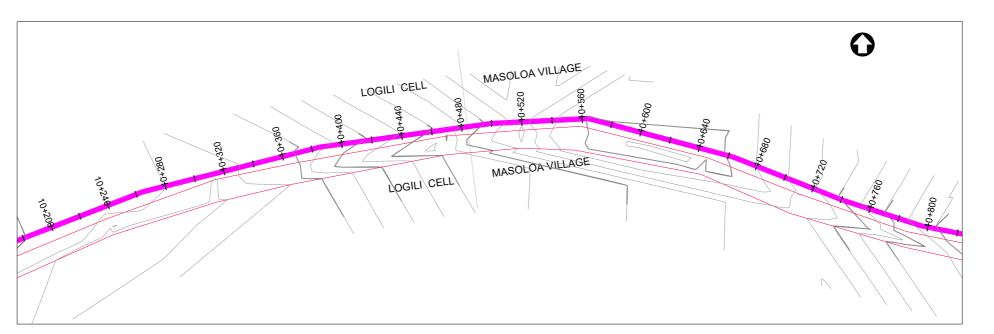

LONGITUDINAL PROFILE

AMENDMENTS		
No	Date	Revision
1	7.28.2023	Draft Design

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- 4. For Node details, see Dwg. MWE/GWE/5.0.0
- 5. All valves, hydrants and washout locations are

SD 220 Level Indicator SD 116 Outfall Chamber SD 117 Thrust Blocks SD 118

LEGEND



Pipe beddings

Transmission Mains **Distribution Mains**

SD 121

Building/House

Contours Road

Tree Double Orifice Air Valve WO_2

Type 2 Washout Node detail No. 101

CO-FINANCE BY

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MINISTRY OF WATER AND ENVIRONMENT
DIRECTORATE OF WATER DEVELOPMENT (DWD)
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CONSTRUCTION OF GWERE RGC WATER **SUPPLY AND SANITATION SYSTEM**

Consultant:



10 Philpot Lane, 1st Floor,


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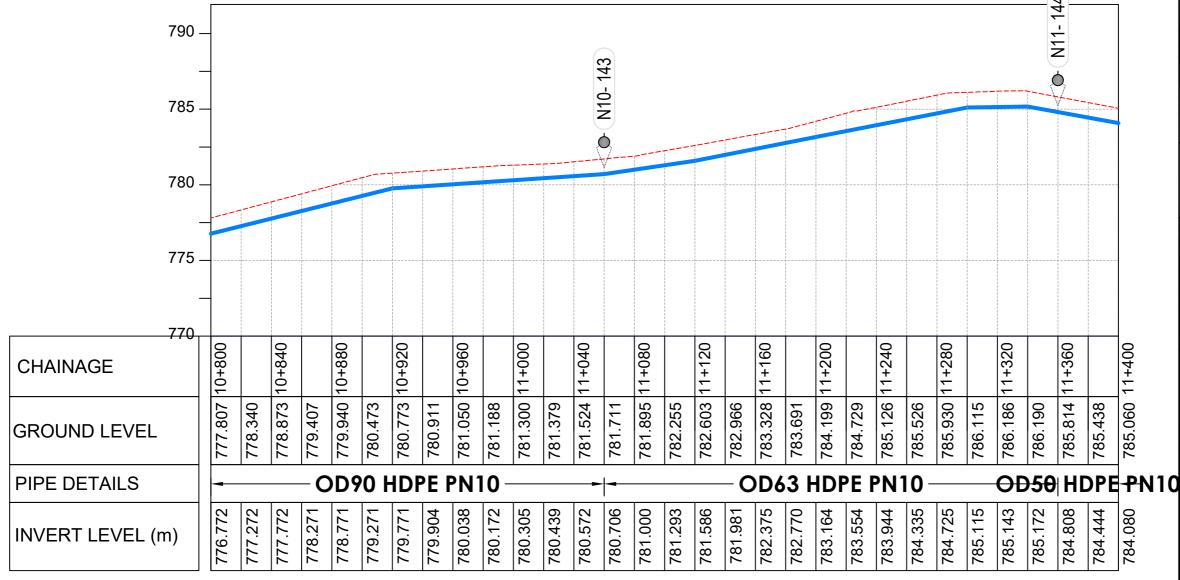
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Horizontal Scale: 1:250	Drawn:	P.S Eyamu			
Date:	Checked:	O.R Daniel			
Nov-2022	Approved:	O.R Daniel			

ENGINEERING DESIGN DRAWING

Drg No: MWE/GWE/4.1.18 Cad file No WSS<22_11>



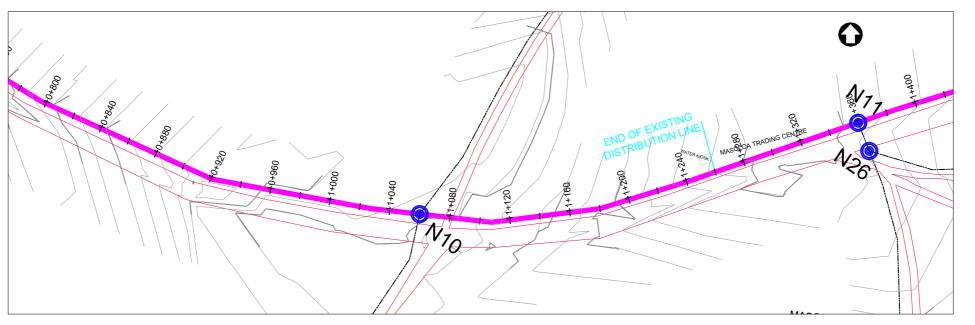

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- 3. For Site location see Dwg. MWE/GWE/0.0.0
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- 5. All valves, hydrants and washout locations are identified by marker post in positions

SD 220 Level Indicator SD 116 Outfall Chamber Marker Post SD 117 Thrust Blocks SD 118

Pipe beddings SD 121

LEGEND



AMENDMENTS No Date Revision 1 7.28.2023 Draft Design

> Transmission Mains **Distribution Mains**

Building/House

Contours

Road

Double Orifice Air Valve

Type 2 Washout Node detail No. 101

Tree

CO-FINANCE BY

10

DAV

WO_2



THE WORLD BANK AND

DIRECTORATE OF WATER DEVELOPMENT (DWD)

RURAL WATER SUPPLY AND SANITATION DEPARTMENT

Plot 3 - 7 Kabalega Crescent Road, Luzira, Box 20026 Kampala

Tel: +256 417 889 400, Email: mwe@mwe.go.ug

Website: www.mwe.go.ug

GOVERNMENT OF UGANDA

Consultancy Services for the Feability Study, Detailed Engineering Design and Construction Supervision of Solar Powered Piped Water Supply Systems and Sanitation Facilities In Refugee Settlements and Host Districts In West Nile and Northern Uganda

- LOT 1 - MADI OKOLLO, TEREGO AND MOYO DISTRICTS

CONSTRUCTION OF GWERE RGC WATER **SUPPLY AND SANITATION SYSTEM**

Consultant:



10 Philpot Lane, 1st Floor, London EC3M 8AA,

Drawing Title:

DISTRIBUTION LINE 01

Distribution Line 01 (CH 10+800.00 - 11+400.00)


Designed: O.R Daniel Vertical Scale: 1:250 Horizontal Scale: 1:2500 Drawn: P.S Eyamu Checked: O.R Daniel Approved: O.R Daniel

ENGINEERING DESIGN DRAWING

Drg No: MWE/GWE/4.1.19 Cad file No WSS<22 11>

LONGITUDINAL PROFILE



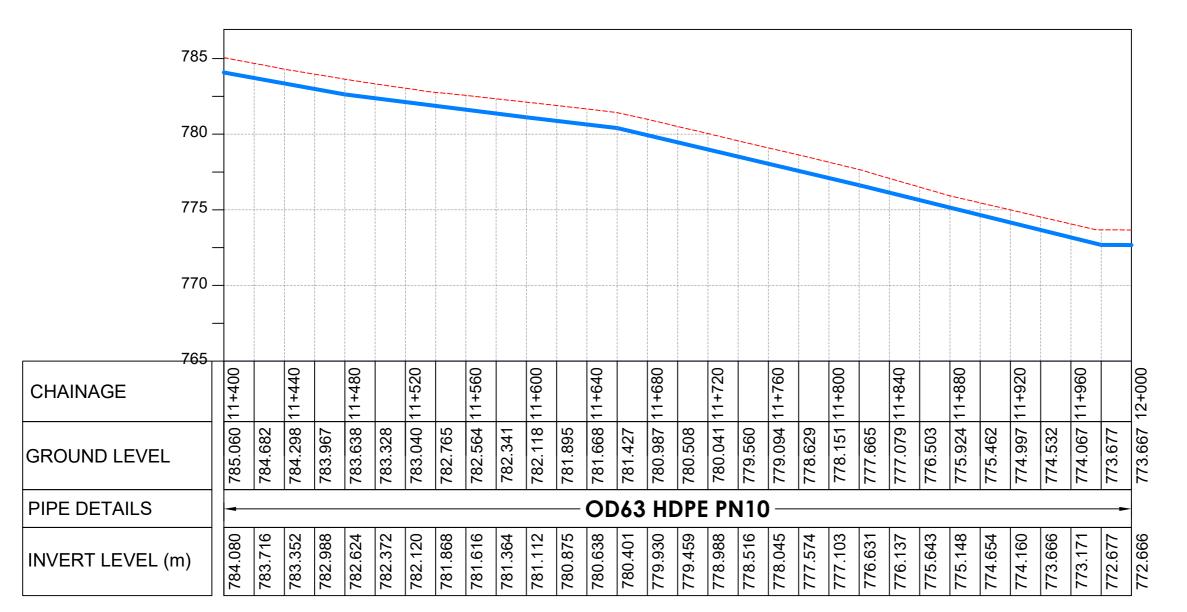

LONGITUDINAL PROFILE

AM	AMENDMENTS		
No	Date	Revision	
1	7.28.2023	Draft Design	

NOTES

- 1. All dimensions are in metres unless stated otherwise.
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- 3. For Site location see Dwg. MWE/GWE/0.0.0
- 4. For Node details, see Dwg. MWE/GWE/5.0.0
- 5. All valves, hydrants and washout locations are
- 6. For Standard details see sheets as follows

Level Indicator SD 220 SD 116 Outfall Chamber SD 117 Thrust Blocks SD 118 Pipe beddings SD 121

LEGEND



Transmission Mains

Distribution Mains Building/House

Contours

Road Tree

Double Orifice Air Valve WO_2 Type 2 Washout 10

CO-FINANCE BY





Node detail No. 101

GOVERNMENT OF UGANDA

MINISTRY OF WATER AND ENVIRONMENT
DIRECTORATE OF WATER DEVELOPMENT (DWD)
RURAL WATER SUPPLY AND SANITATION DEPARTMENT
Plot 3 - 7 Kabalega Crescent Road, Luzira, Box 20026 Kampala
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Consultancy Services for the Feability Study, Detailed Engineering Design and Construction Supervision of Solar Powered Piped Water Supply Systems and Sanitation Facilities In Refugee Settlements and Host Districts In West Nile and Northern Uganda

- LOT 1 - MADI OKOLLO, TEREGO AND MOYO DISTRICTS -

CONSTRUCTION OF GWERE RGC WATER **SUPPLY AND SANITATION SYSTEM**

Consultant:




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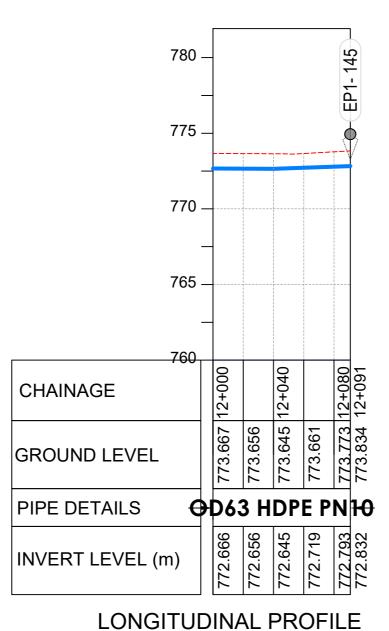
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Scale: Vertical Scale: 1:250	Designed:	O.R Daniel			
Horizontal Scale: 1:2500	Drawn:	P.S Eyamu			
Date:	Checked:	O.R Daniel			
Nov-2022	Approved:	O.R Daniel			

ENGINEERING DESIGN DRAWING

Drg No: MWE/GWE/4.1.20 Cad file No WSS<22_11>



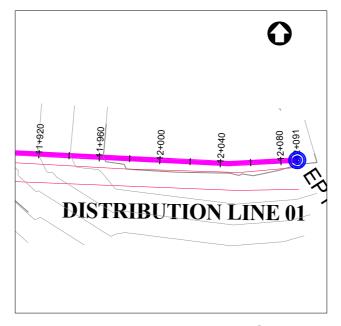

AMENDMENTS No Date Revision 1 7.28.2023 Draft Design

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- 1. All dimensions are in metres unless stated otherwise.
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- 3. For Site location see Dwg. MWE/GWE/0.0.0
- 4. For Node details, see Dwg. MWE/GWE/5.0.0
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- 6. For Standard details see sheets as follows

SD 220 Level Indicator Outfall Chamber SD 116 Marker Post SD 117 Thrust Blocks SD 118 SD 121 Pipe beddings

LEGEND



Transmission Mains

Distribution Mains Building/House

Contours Road

Tree

Double Orifice Air Valve Type 2 Washout

Node detail No. 101

CO-FINANCE BY

10

DAV

WO_2



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MINISTRY OF WATER AND ENVIRONMENT

DIRECTORATE OF WATER DEVELOPMENT (DWD)

RURAL WATER SUPPLY AND SANITATION DEPARTMENT

Plot 3 - 7 Kabalega Crescent Road, Luzira, Box 20026 Kampala

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- LOT 1 - MADI OKOLLO, TEREGO AND MOYO DISTRICTS -

CONSTRUCTION OF GWERE RGC WATER SUPPLY AND SANITATION SYSTEM

Consultant:



10 Philpot Lane, 1st Floor,

Drawing Title:


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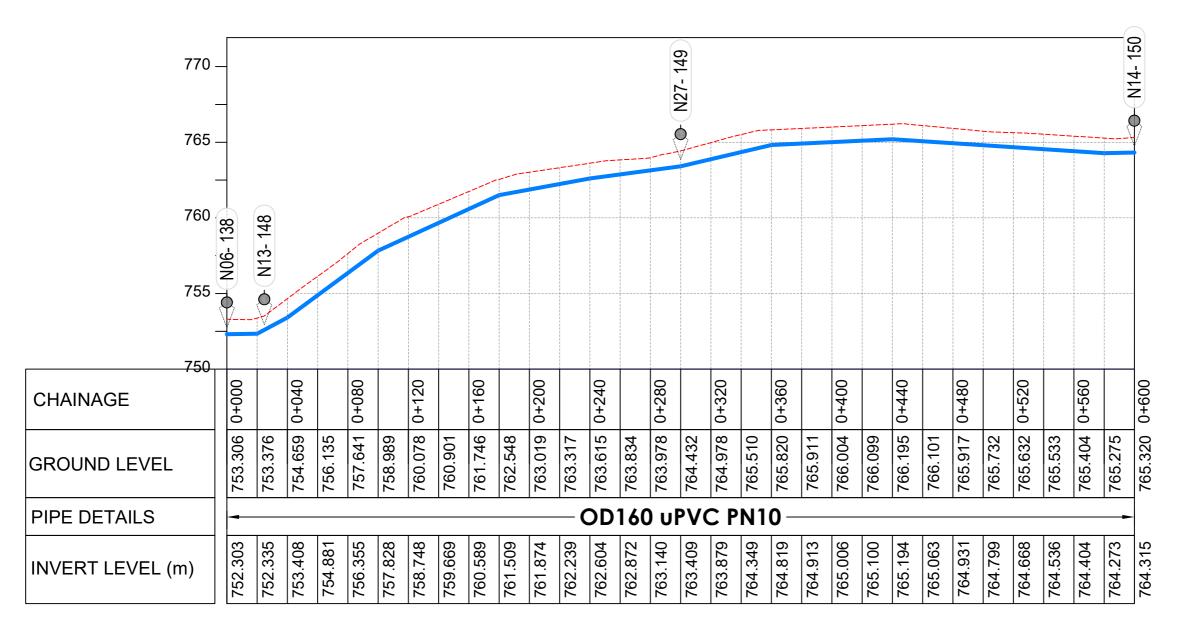
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Designed: O.R Daniel Vertical Scale: 1:250 Horizontal Scale: 1:2500 Drawn: P.S Eyamu Checked: O.R Daniel Nov-2022 Approved: O.R Daniel

ENGINEERING DESIGN DRAWING

Drg No: MWE/GWE/4.1.21 Cad file No WSS<22_11>



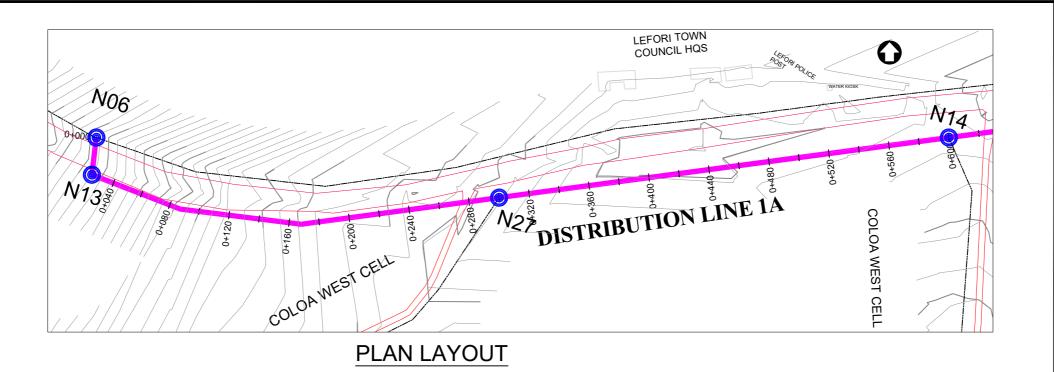

AMENDMENTS No Date Revision 1 7.28.2023 Draft Design

NOTES

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- 3. For Site location see Dwg. MWE/GWE/0.0.0
- 4. For Node details, see Dwg. MWE/GWE/5.0.0
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Level Indicator SD 220 SD 116 Outfall Chamber SD 117

Thrust Blocks SD 118 Pipe beddings SD 121

LEGEND



Transmission Mains **Distribution Mains**

Building/House

Contours

Road Tree

DAV Double Orifice Air Valve WO_2 Type 2 Washout

10





Node detail No. 101

GOVERNMENT OF UGANDA



MINISTRY OF WATER AND ENVIRONMENT
DIRECTORATE OF WATER DEVELOPMENT (DWD)
RURAL WATER SUPPLY AND SANITATION DEPARTMENT
Plot 3 - 7 Kabalega Crescent Road, Luzira, Box 20026 Kampala
Tel: +256 417 889 400, Email: mwe@mwe.go.ug
Website: www.mwe.go.ug

Consultancy Services for the Feability Study, Detailed Engineering Design and Construction Supervision of Solar Powered Piped Water Supply Systems and Sanitation Facilities In Refugee Settlements and Host Districts In West Nile and Northern Uganda

LOT 1 - MADI OKOLLO, TEREGO AND MOYO DISTRICTS

CONSTRUCTION OF GWERE RGC WATER **SUPPLY AND SANITATION SYSTEM**

Consultant:



10 Philpot Lane, 1st Floor,

Drawing Title:


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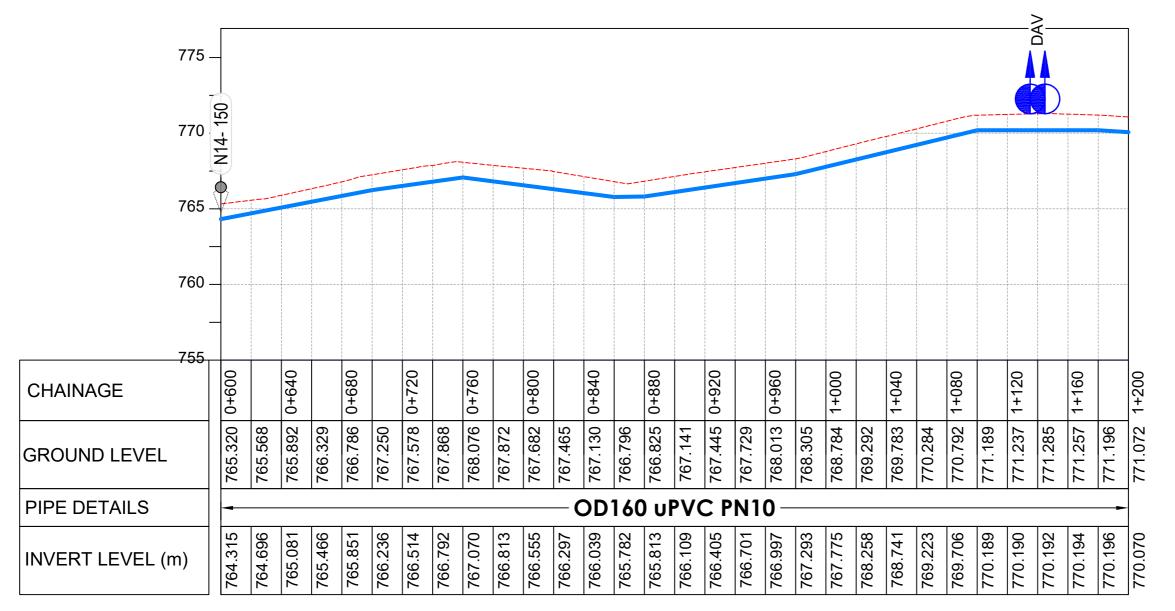
Scale: Vertical Scale: 1:250	Designed:	O.R Daniel		
Horizontal Scale: 1:2500	Drawn:	P.S Eyamu		
Date:	Checked:	O.R Daniel		
Nov-2022	Approved:	O.R Daniel		

ENGINEERING DESIGN DRAWING

Drg No: MWE/GWE/4.1A.1 Cad file No WSS<22_11>

LONGITUDINAL PROFILE



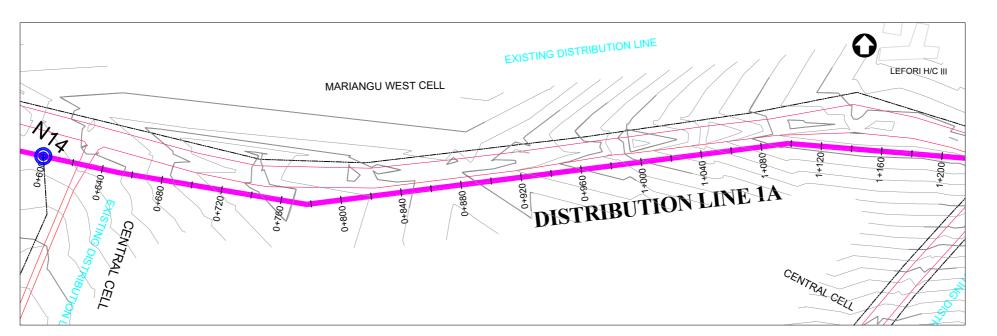

LONGITUDINAL PROFILE

ΑM	ENDMEN	ENDMENTS	
No	Date	Revision	
1	7.28.2023	Draft Design	

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Level Indicator SD 220 SD 116 Outfall Chamber SD 117 Thrust Blocks SD 118

LEGEND



Pipe beddings

Transmission Mains

SD 121

Distribution Mains Building/House

Contours

Road Tree

Node detail No. 101

Double Orifice Air Valve WO_2 Type 2 Washout

10



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MINISTRY OF WATER AND ENVIRONMENT
DIRECTORATE OF WATER DEVELOPMENT (DWD)
RURAL WATER SUPPLY AND SANITATION DEPARTMENT
Plot 3 - 7 Kabalega Crescent Road, Luzira, Box 20026 Kampala
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Website: www.mwe.go.ug

Consultancy Services for the Feability Study, Detailed Engineering Design and Construction Supervision of Solar Powered Piped Water Supply Systems and Sanitation Facilities In Refugee Settlements and Host Districts In West Nile and Northern Uganda

- LOT 1 - MADI OKOLLO, TEREGO AND MOYO DISTRICTS -

CONSTRUCTION OF GWERE RGC WATER **SUPPLY AND SANITATION SYSTEM**

Consultant:



10 Philpot Lane, 1st Floor,


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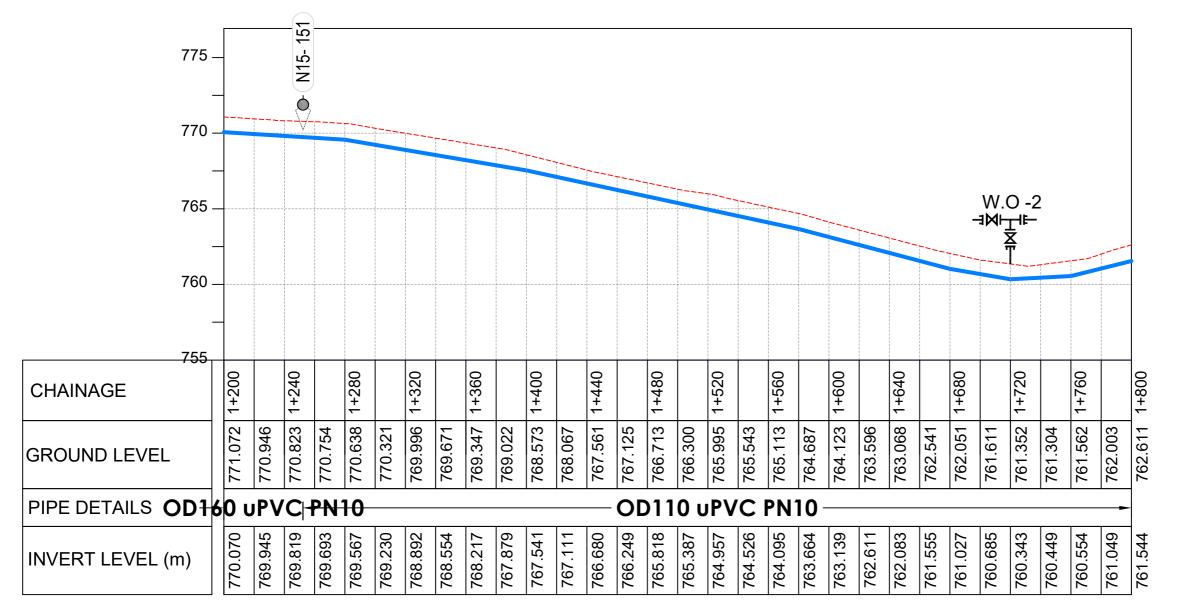
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Scale: Vertical Scale: 1:250	Designed:	O.R Daniel	
Horizontal Scale: 1:2500	Drawn:	P.S Eyamu	
Date:	Checked:	O.R Daniel	
Nov-2022	Approved:	O.R Daniel	
ENGINEEDING DEGICAL DRAWING			

ENGINEERING DESIGN DRAWING

Drg No: MWE/GWE/4.1A.2 Cad file No WSS<22_11>



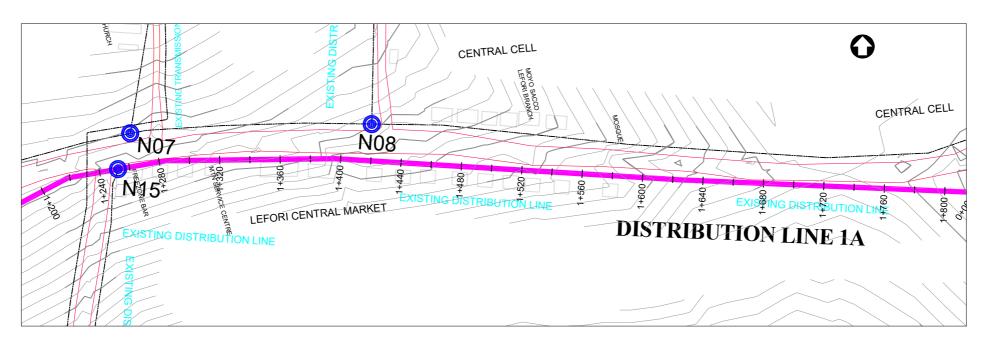

LONGITUDINAL PROFILE

AM	AMENDMENTS		
No	No Date Revision		
1	1 7.28.2023 Draft Design		

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- 6. For Standard details see sheets as follows

Level Indicator SD 220
Outfall Chamber SD 116
Marker Post SD 117
Thrust Blocks SD 118
Pipe beddings SD 121

LEGEND



Transmission Mains

Distribution Mains

Building/House

Contours Road Tree

DAV Double Orifice Air Valve WO_2 Type 2 Washout

Node detail No. 101

CO-FINANCE BY:

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MINISTRY OF WATER AND ENVIRONMENT

DIRECTORATE OF WATER DEVELOPMENT (DWD)

RURAL WATER SUPPLY AND SANITATION DEPARTMENT

Plot 3 - 7 Kabalega Crescent Road, Luzira, Box 20026 Kampala

Tel: +256 417 889 400, Email: mwe@mwe.go.ug

Website: www.mwe.go.ug

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Consultancy Services for the Feability Study, Detailed Engineering Design and Construction Supervision of Solar Powered Piped Water Supply Systems and Sanitation Facilities In Refugee Settlements and Host Districts In West Nile and Northern Uganda

- LOT 1 - MADI OKOLLO, TEREGO AND MOYO DISTRICTS

CONSTRUCTION OF GWERE RGC WATER SUPPLY AND SANITATION SYSTEM

Consultant:



Corporate Headquarte
10 Philpot Lane, 1st Floor,
London EC3M 8AA,


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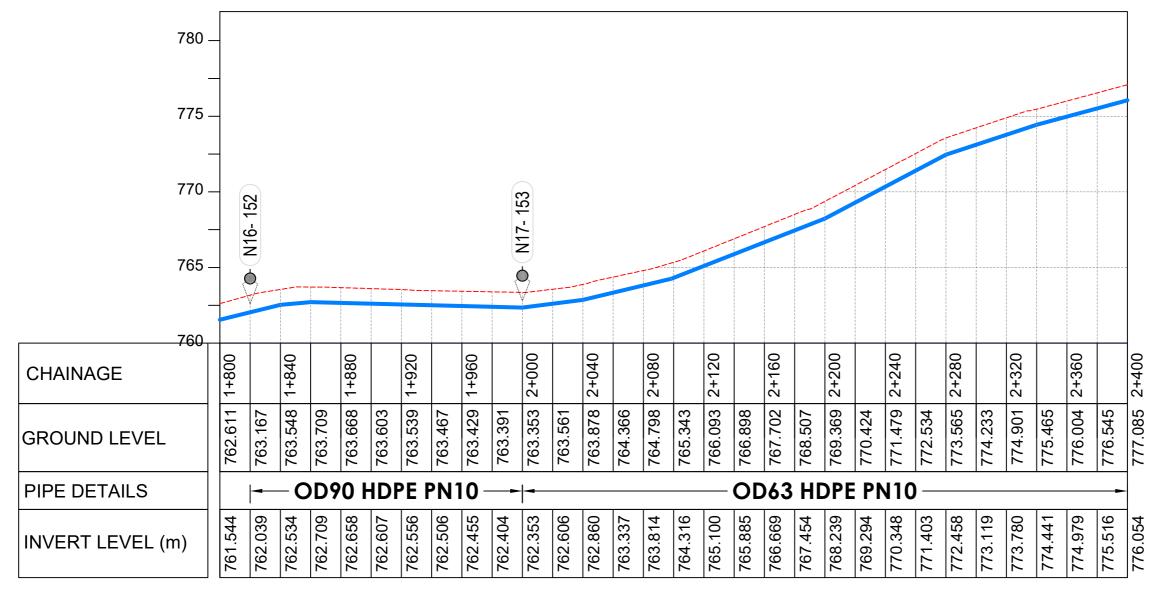
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Scale: Vertical Scale: 1:250	Designed:	O.R Daniel			
Horizontal Scale: 1:2500	Drawn:	P.S Eyamu			
Date:	Checked:	O.R Daniel			
Nov-2022	Approved:	O.R Daniel			

ENGINEERING DESIGN DRAWING

Drg No: MWE/GWE/4.1A.3 Cad file No WSS<22_11>



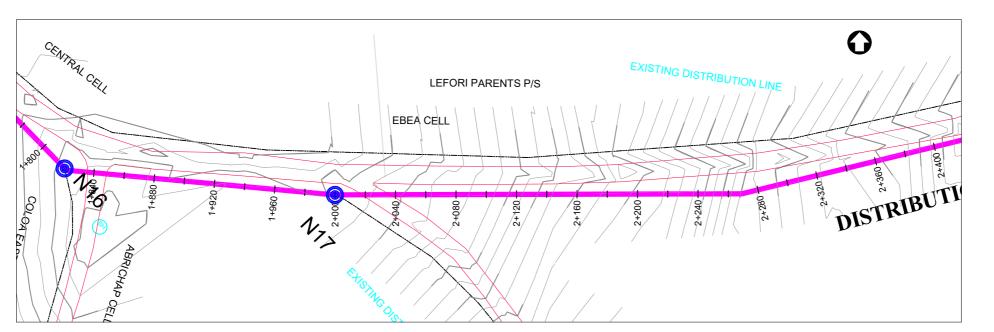

LONGITUDINAL PROFILE

AM	AMENDMENTS		
No	Date	Revision	
1	7.28.2023	Draft Design	

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- 4. For Node details, see Dwg. MWE/GWE/5.0.0
- 5. All valves, hydrants and washout locations are
- 6. For Standard details see sheets as follows

Level Indicator SD 220 SD 116 Outfall Chamber SD 117

Thrust Blocks SD 118 Pipe beddings SD 121

LEGEND



Transmission Mains

Distribution Mains Building/House

Contours

Road Tree

Double Orifice Air Valve WO_2 Type 2 Washout

Node detail No. 101

CO-FINANCE BY

10



THE WORLD BANK AND

GOVERNMENT OF UGANDA



MINISTRY OF WATER AND ENVIRONMENT
DIRECTORATE OF WATER DEVELOPMENT (DWD)
RURAL WATER SUPPLY AND SANITATION DEPARTMENT
Plot 3 - 7 Kabalega Crescent Road, Luzira, Box 20026 Kampala
Tel: +256 417 889 400, Email: mwe@mwe.go.ug
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Consultancy Services for the Feability Study, Detailed Engineering Design and Construction Supervision of Solar Powered Piped Water Supply Systems and Sanitation Facilities In Refugee Settlements and Host Districts In West Nile and Northern Uganda

- LOT 1 - MADI OKOLLO, TEREGO AND MOYO DISTRICTS -

CONSTRUCTION OF GWERE RGC WATER **SUPPLY AND SANITATION SYSTEM**

Consultant:



10 Philpot Lane, 1st Floor, London EC3M 8AA,


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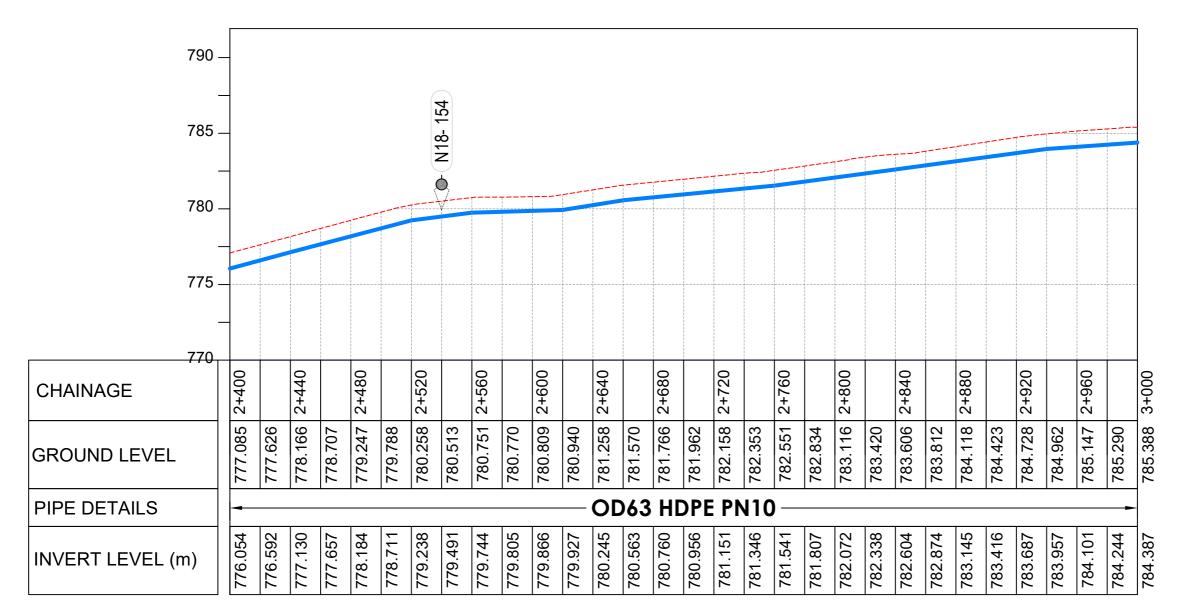
Scale: Vertical Scale: 1:250	Designed:	O.R Daniel	
Horizontal Scale: 1:2500	Drawn:	P.S Eyamu	
Date:	Checked:	O.R Daniel	
Nov-2022	Approved:	O.R Daniel	

ENGINEERING DESIGN DRAWING

Drg No: MWE/GWE/4.1A.4 Cad file No WSS<22_11>



PLAN LAYOUT

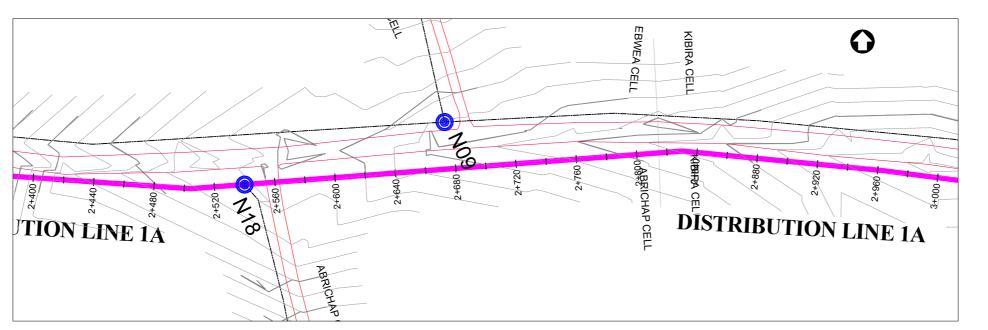

LONGITUDINAL PROFILE

AM	AMENDMENTS		
No	Date Revision		
1 7.28.2023 Draft Design			

NOTES

1. All dimensions are in metres unless stated otherwise.

SD 121

- 2. All levels are in metres above sea level.
- 3. For Site location see Dwg. MWE/GWE/0.0.0
- 4. For Node details, see Dwg. MWE/GWE/5.0.0
- 5. All valves, hydrants and washout locations are

Level Indicator SD 220 SD 116 Outfall Chamber SD 117 Thrust Blocks SD 118

LEGEND



Pipe beddings

Contours Road

Tree Double Orifice Air Valve WO_2 Type 2 Washout

10 Node detail No. 101

CO-FINANCE BY



GOVERNMENT OF UGANDA

MINISTRY OF WATER AND ENVIRONMENT
DIRECTORATE OF WATER DEVELOPMENT (DWD)
RURAL WATER SUPPLY AND SANITATION DEPARTMENT
Plot 3 - 7 Kabalega Crescent Road, Luzira, Box 20026 Kampala
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Consultancy Services for the Feability Study, Detailed Engineering Design and Construction Supervision of Solar Powered Piped Water Supply Systems and Sanitation Facilities In Refugee Settlements and Host Districts In West Nile and Northern Uganda

- LOT 1 - MADI OKOLLO, TEREGO AND MOYO DISTRICTS

CONSTRUCTION OF GWERE RGC WATER **SUPPLY AND SANITATION SYSTEM**

Consultant:




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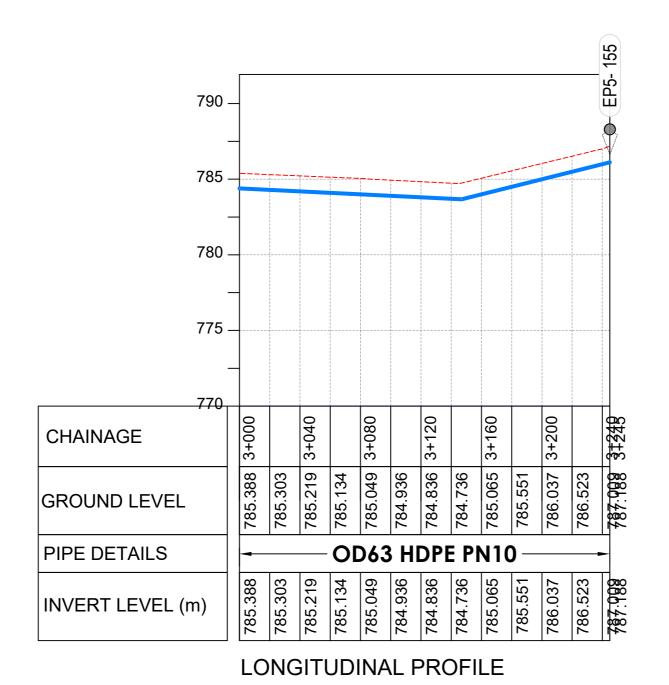
Scale: Vertical Scale: 1:250	Designed:	O.R Daniel	
Horizontal Scale: 1:2500	Drawn:	P.S Eyamu	
Date:	Checked:	O.R Daniel	
Nov-2022	Approved:	O.R Daniel	

ENGINEERING DESIGN DRAWING

Drg No: MWE/GWE/4.1A.5 Cad file No WSS<22_11>



PLAN LAYOUT

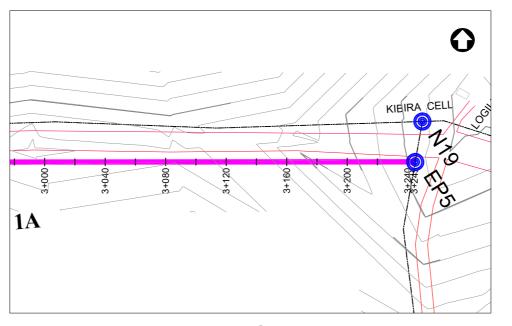

AMENDMENTS No Date Revision 1 7.28.2023 Draft Design

NOTES

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- 5. All valves, hydrants and washout locations are identified by marker post in positions
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SD 220 Level Indicator SD 116 Outfall Chamber SD 117 Thrust Blocks SD 118 SD 121 Pipe beddings

LEGEND



Transmission Mains

Distribution Mains

Building/House

Contours Road

Tree

Double Orifice Air Valve WO_2 Type 2 Washout

Node detail No. 101

CO-FINANCE BY

10

DAV



GOVERNMENT OF UGANDA



MINISTRY OF WATER AND ENVIRONMENT

DIRECTORATE OF WATER DEVELOPMENT (DWD)

RURAL WATER SUPPLY AND SANITATION DEPARTMENT

Plot 3 - 7 Kabalega Crescent Road, Luzira, Box 20026 Kampala

Tel: +256 417 889 400, Email: mwe@mwe.go.ug

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Consultancy Services for the Feability Study, Detailed Engineering Design and Construction Supervision of Solar Powered Piped Water Supply Systems and Sanitation Facilities In Refugee Settlements and Host Districts In West Nile and Northern Uganda

- LOT 1 - MADI OKOLLO, TEREGO AND MOYO DISTRICTS -

CONSTRUCTION OF GWERE RGC WATER SUPPLY AND SANITATION SYSTEM

Consultant:



10 Philpot Lane, 1st Floor,


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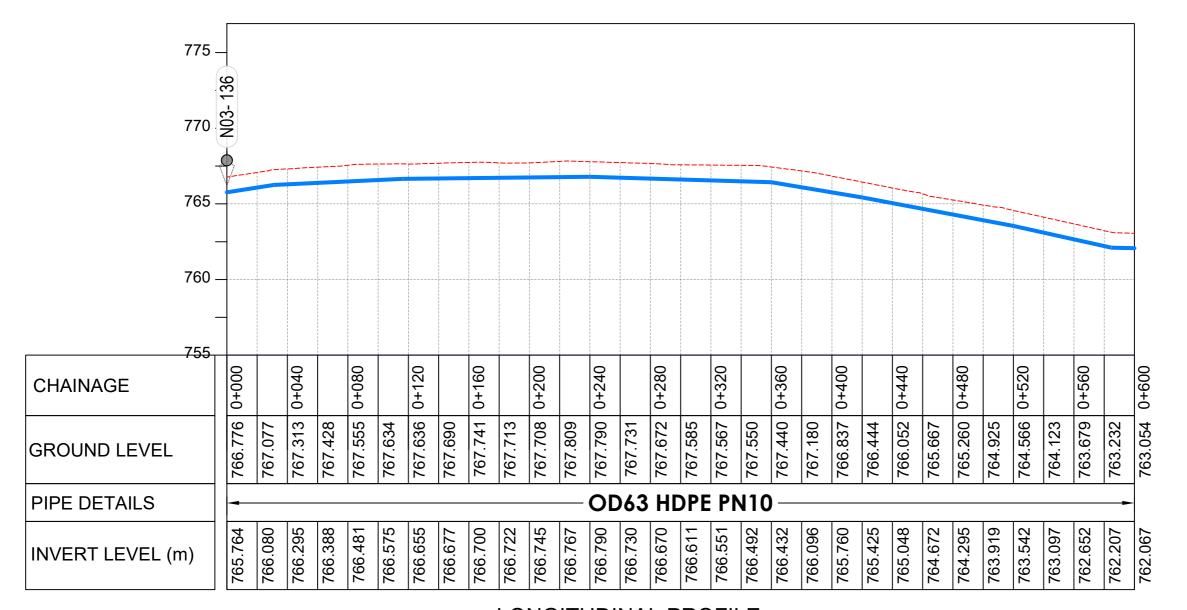
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Designed:	O.R Daniel
Drawn:	P.S Eyamu
Checked:	O.R Daniel
Approved:	O.R Daniel
	Drawn: Checked:

ENGINEERING DESIGN DRAWING

Drg No: MWE/GWE/4.1A.6 Cad file No WSS<22_11>



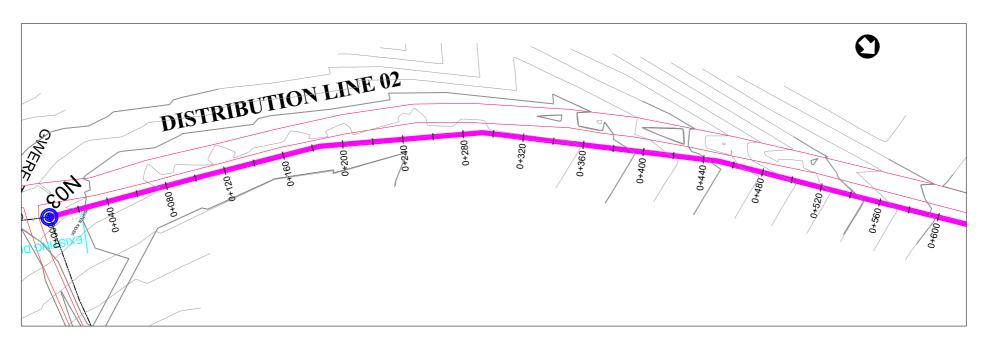

AMENDMENTS No Date Revision 1 7.28.2023 Draft Design

NOTES

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- 4. For Node details, see Dwg. MWE/GWE/5.0.0
- 5. All valves, hydrants and washout locations are

Level Indicator SD 220 SD 116 Outfall Chamber SD 117 Thrust Blocks SD 118

Pipe beddings

LEGEND

Transmission Mains

SD 121

Distribution Mains

Building/House

Contours Road

Tree Double Orifice Air Valve

WO_2 Type 2 Washout

Node detail No. 101

CO-FINANCE BY

10



GOVERNMENT OF UGANDA



MINISTRY OF WATER AND ENVIRONMENT
DIRECTORATE OF WATER DEVELOPMENT (DWD)
RURAL WATER SUPPLY AND SANITATION DEPARTMENT
Plot 3 - 7 Kabalega Crescent Road, Luzira, Box 20026 Kampala
Tel: +256 417 889 400, Email: mwe@mwe.go.ug
Website: www.mwe.go.ug

Consultancy Services for the Feability Study, Detailed Engineering Design and Construction Supervision of Solar Powered Piped Water Supply Systems and Sanitation Facilities In Refugee Settlements and Host Districts In West Nile and Northern Uganda

- LOT 1 - MADI OKOLLO, TEREGO AND MOYO DISTRICTS

CONSTRUCTION OF GWERE RGC WATER **SUPPLY AND SANITATION SYSTEM**

Consultant:



10 Philpot Lane, 1st Floor,

Drawing Title:


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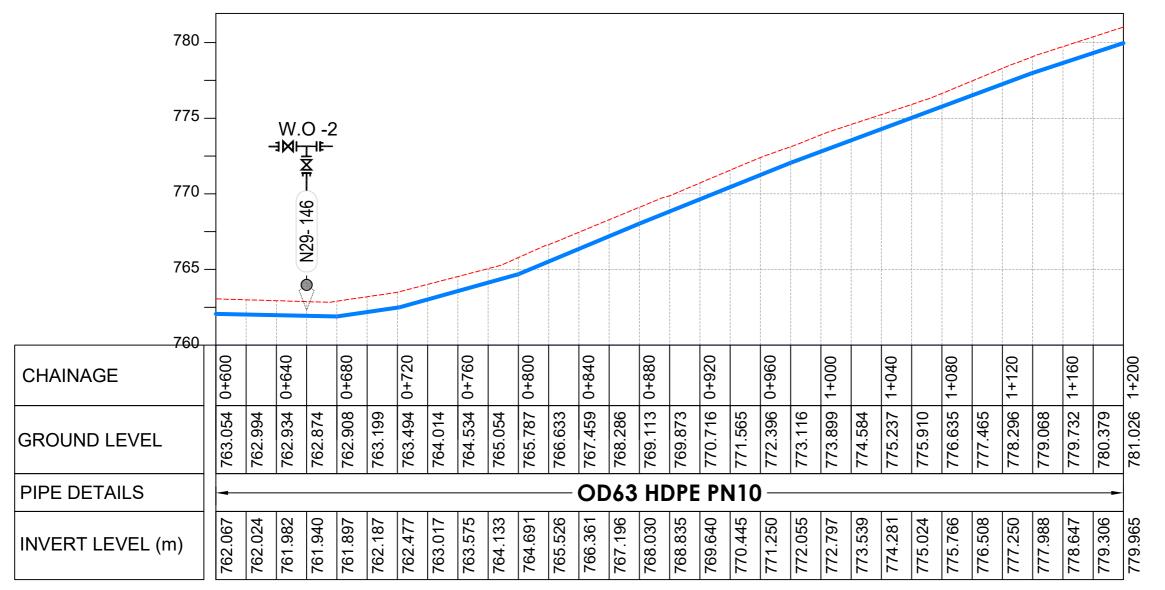
Scale: Vertical Scale: 1:250	Designed:	O.R Daniel		
Horizontal Scale: 1:2500	Drawn:	P.S Eyamu		
Date:	Checked:	O.R Daniel		
Nov-2022	Approved:	O.R Daniel		

ENGINEERING DESIGN DRAWING

Drg No: MWE/GWE/4.2.1 | Cad file No WSS<22_11>

LONGITUDINAL PROFILE



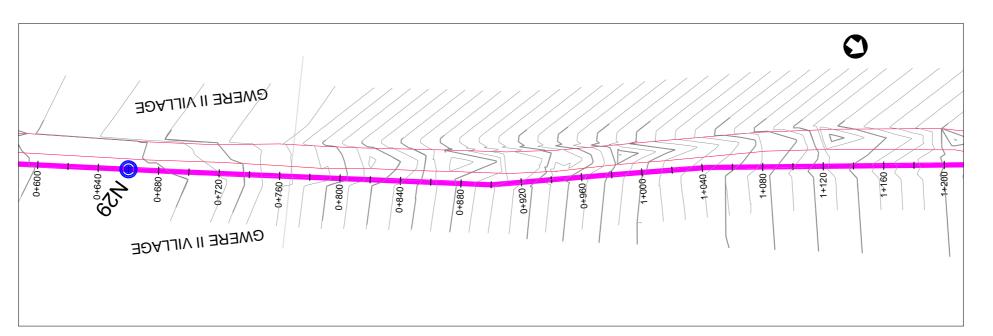

LONGITUDINAL PROFILE

ΑM	AMENDMENTS			
No Date Revision				
1	7.28.2023	Draft Design		

NOTES

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- 4. For Node details, see Dwg. MWE/GWE/5.0.0
- 5. All valves, hydrants and washout locations are
- 6. For Standard details see sheets as follows

Level Indicator SD 220 SD 116 Outfall Chamber SD 117 Thrust Blocks SD 118 Pipe beddings SD 121

LEGEND



Transmission Mains

Distribution Mains Building/House

Contours Road

Tree

Double Orifice Air Valve WO_2

Type 2 Washout Node detail No. 101

CO-FINANCE BY

10

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Consultancy Services for the Feability Study, Detailed Engineering Design and Construction Supervision of Solar Powered Piped Water Supply Systems and Sanitation Facilities In Refugee Settlements and Host Districts In West Nile and Northern Uganda

- LOT 1 - MADI OKOLLO, TEREGO AND MOYO DISTRICTS -

CONSTRUCTION OF GWERE RGC WATER **SUPPLY AND SANITATION SYSTEM**

Consultant:




10 Philpot Lane, 1st Floor,


DISTRIBUTION LINE 02 Distribution Line 02 (CH 0+600.00 - 1+200.00)

Designed:	O.R Daniel
Drawn:	P.S Eyamu
Checked:	O.R Daniel
Approved:	O.R Daniel
	Drawn: Checked:

ENGINEERING DESIGN DRAWING

Drg No: MWE/GWE/4.2.2 Cad file No WSS<22_11>

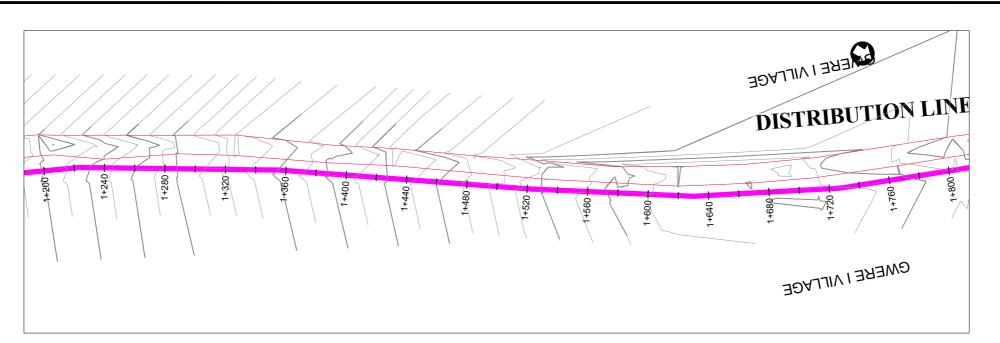

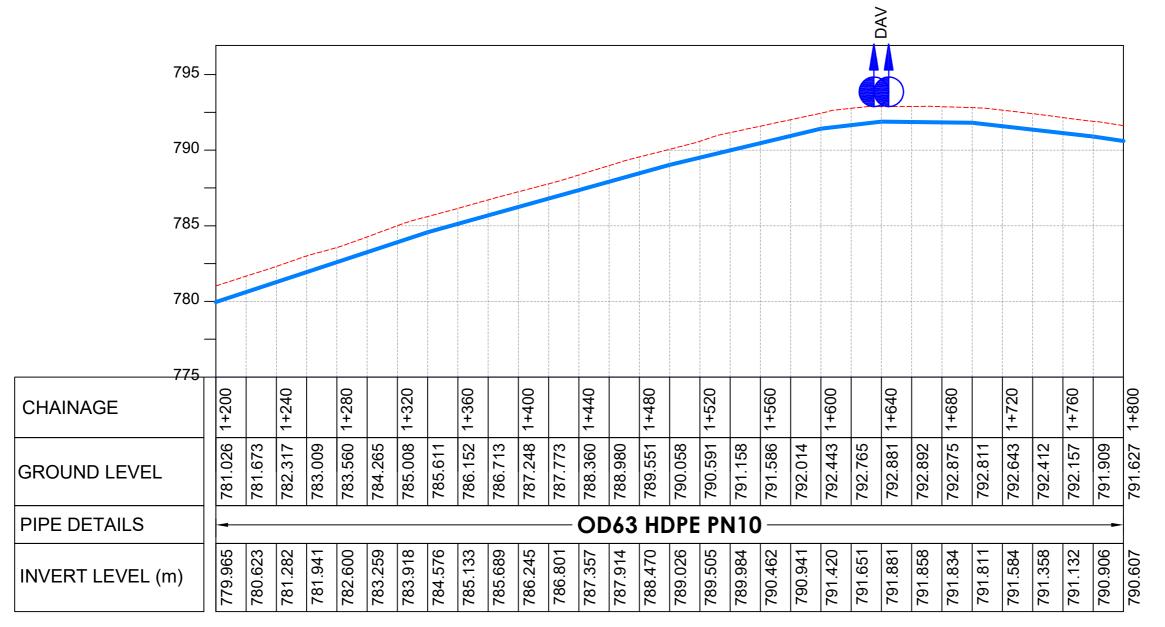

AMENDMENTS

	No	Date	Revision
	1	7.28.2023	Draft Design

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LEGEND



Transmission Mains **Distribution Mains**

Building/House

Contours

Road

Double Orifice Air Valve WO_2 Type 2 Washout

Node detail No. 101

Tree

CO-FINANCE BY

10



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GOVERNMENT OF UGANDA



MINISTRY OF WATER AND ENVIRONMENT
DIRECTORATE OF WATER DEVELOPMENT (DWD)
RURAL WATER SUPPLY AND SANITATION DEPARTMENT
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CONSTRUCTION OF GWERE RGC WATER **SUPPLY AND SANITATION SYSTEM**

Consultant:




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DISTRIBUTION LINE 02 Distribution Line 02 (CH 1+200.00 - 1+800.00)


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Horizontal Scale: 1:2500	Drawn:	P.S Eyamu	
Date:	Checked:	O.R Daniel	
Nov-2022	Approved:	O.R Daniel	
ENGINEERING DESIGN DRAWING			

Drg No: MWE/GWE/4.2.3 Cad file No WSS<22_11>

LONGITUDINAL PROFILE

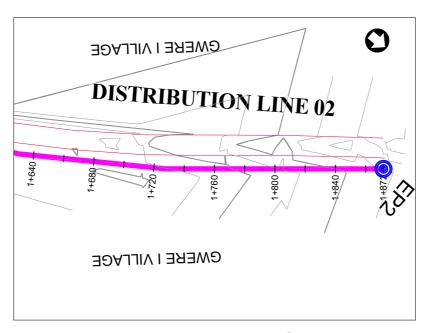

PLAN LAYOUT

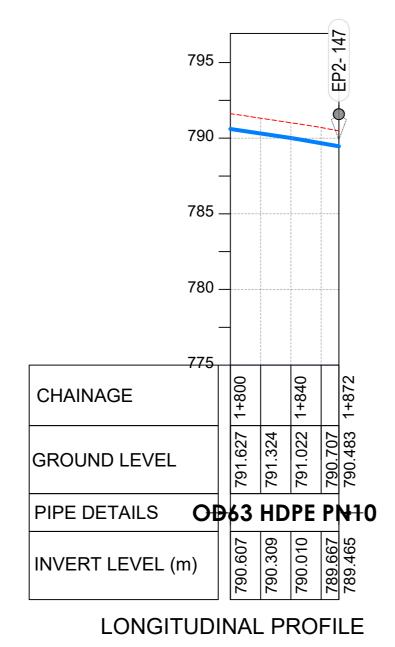

AMENDMENTS No Date Revision 1 7.28.2023 Draft Design

NOTES

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- 4. For Node details, see Dwg. MWE/GWE/5.0.0
- 5. All valves, hydrants and washout locations are identified by marker post in positions

6. For Standard details see sheets as follows

SD 220 Level Indicator Outfall Chamber SD 116 Marker Post SD 117 Thrust Blocks SD 118 SD 121 Pipe beddings

LEGEND



Transmission Mains Distribution Mains

Building/House

Contours Road

Tree Double Orifice Air Valve WO_2

Type 2 Washout

Node detail No. 101

CO-FINANCE BY

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THE WORLD BANK AND

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MINISTRY OF WATER AND ENVIRONMENT

DIRECTORATE OF WATER DEVELOPMENT (DWD)

RURAL WATER SUPPLY AND SANITATION DEPARTMENT

Plot 3 - 7 Kabalega Crescent Road, Luzira, Box 20026 Kampala

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Website: www.mwe.go.ug

Consultancy Services for the Feability Study, Detailed Engineering Design and Construction Supervision of Solar Powered Piped Water Supply Systems and Sanitation Facilities In Refugee Settlements and Host Districts In West Nile and Northern Uganda

- LOT 1 - MADI OKOLLO, TEREGO AND MOYO DISTRICTS -

CONSTRUCTION OF GWERE RGC WATER SUPPLY AND SANITATION SYSTEM

Consultant:



10 Philpot Lane, 1st Floor,

Drawing Title:


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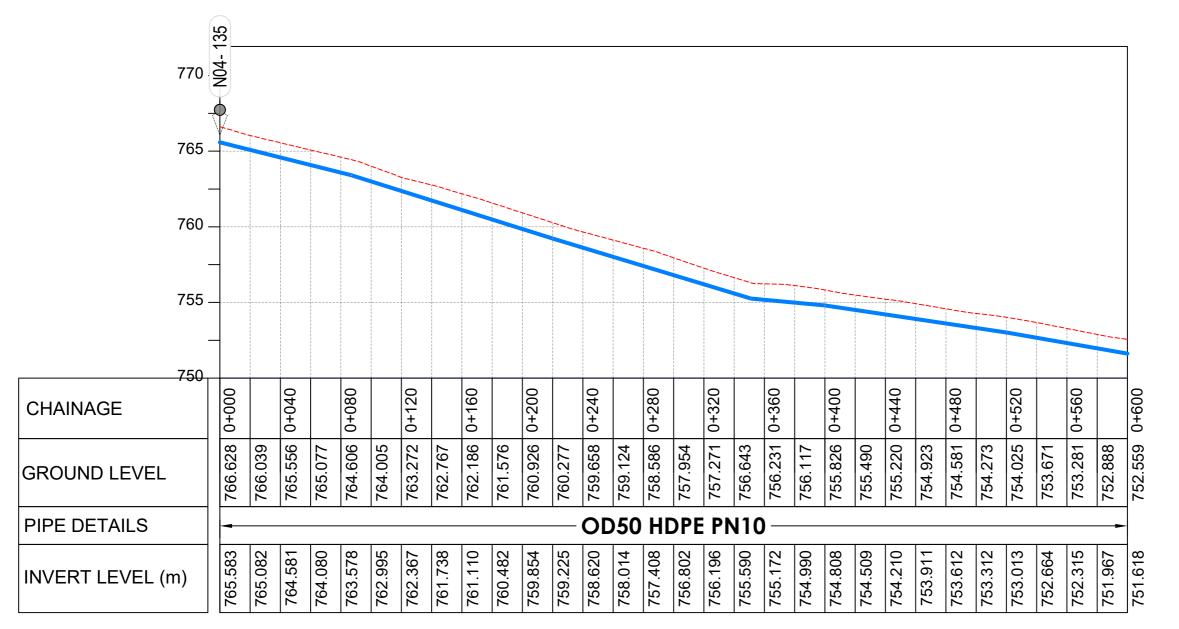
Distribution Line 02 (CH 1+800.00 - 1+871.76) Designed: O.R Daniel

Vertical Scale: 1:250 Horizontal Scale: 1:2500 Drawn: P.S Eyamu Checked: O.R Daniel Nov-2022 Approved: O.R Daniel

ENGINEERING DESIGN DRAWING

Drg No: MWE/GWE/4.2.4 Cad file No WSS<22_11>



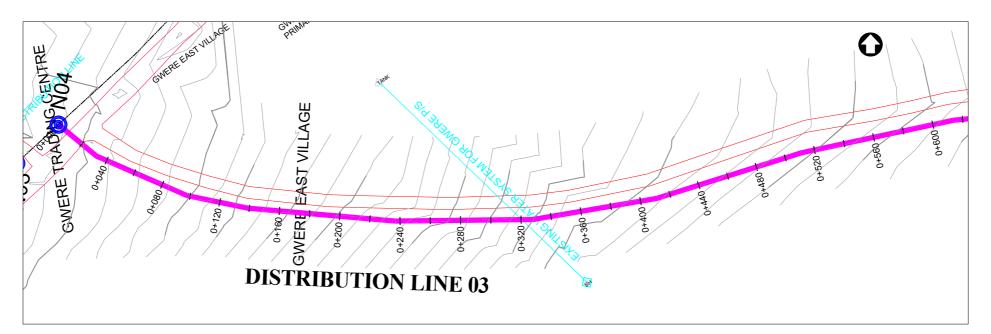

AMENDMENTS No Date Revision 1 7.28.2023 Draft Design

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Level Indicator SD 220 SD 116 Outfall Chamber SD 117

Thrust Blocks SD 118 Pipe beddings SD 121

LEGEND



Transmission Mains **Distribution Mains**

Building/House

Contours

Road

Double Orifice Air Valve WO_2

Tree Type 2 Washout

10 Node detail No. 101

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CONSTRUCTION OF GWERE RGC WATER **SUPPLY AND SANITATION SYSTEM**

Consultant:




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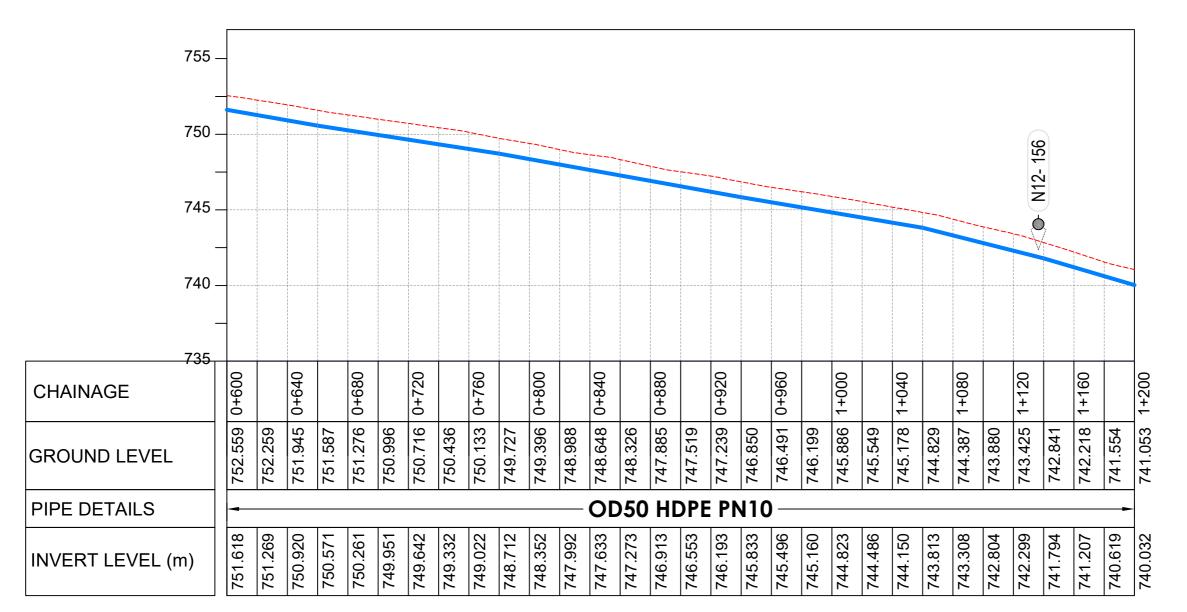
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ı	Scale: Vertical Scale: 1:250	Designed:	O.R Daniel
ı	Horizontal Scale: 1:2500	Drawn:	P.S Eyamu
ı	Date: Nov-2022	Checked:	O.R Daniel
۱		Approved:	O.R Daniel

ENGINEERING DESIGN DRAWING Drg No: MWE/GWE/4.3.1 Cad file No WSS<22_11>

LONGITUDINAL PROFILE



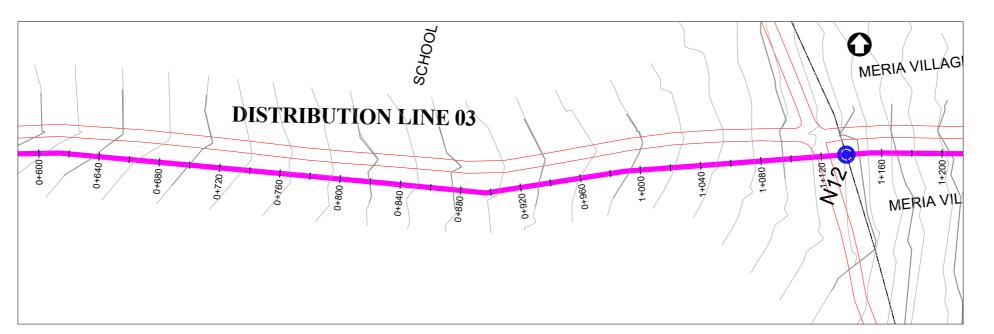

LONGITUDINAL PROFILE

AM	AMENDMENTS		
No	Date	Revision	
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LEGEND



Transmission Mains **Distribution Mains**

Building/House

Contours Road

Tree Double Orifice Air Valve Type 2 Washout

Node detail No. 101

CO-FINANCE BY

10

WO_2



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Consultant:




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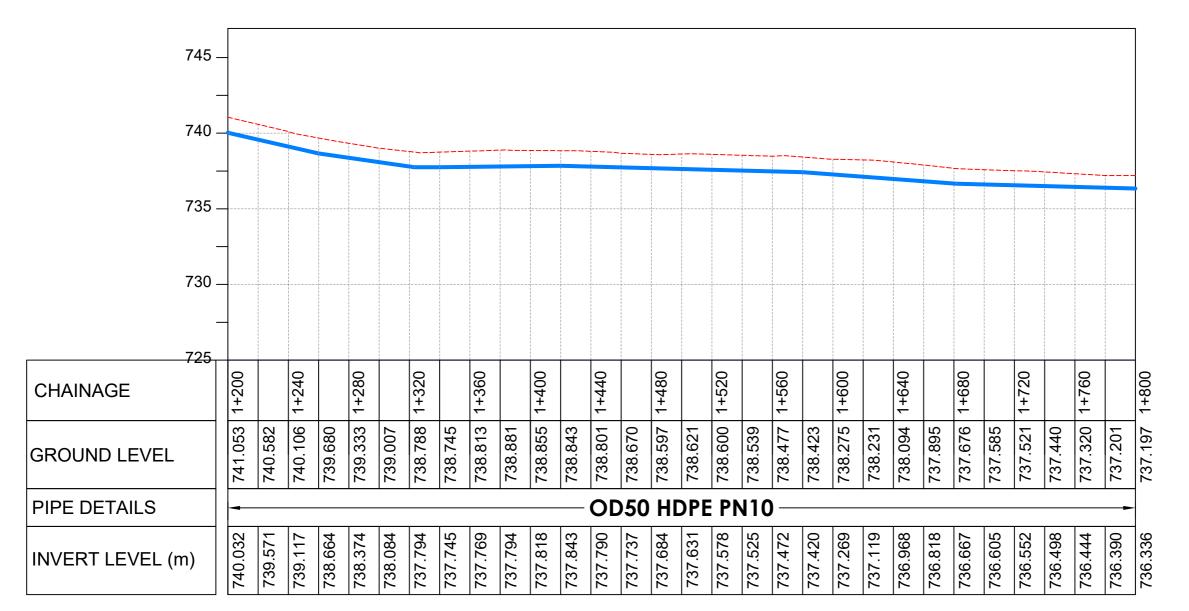
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Horizontal Scale: 1:2500	Drawn:	P.S Eyamu
Date: Nov-2022	Checked:	O.R Daniel
	Approved:	O.R Daniel

ENGINEERING DESIGN DRAWING

Drg No: MWE/GWE/4.3.2 | Cad file No WSS<22_11>



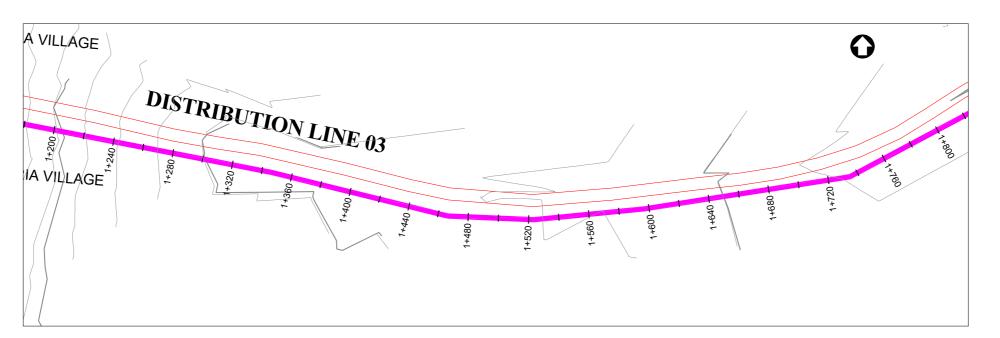

LONGITUDINAL PROFILE

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Level Indicator SD 220 SD 116 Outfall Chamber SD 117 Thrust Blocks SD 118 Pipe beddings SD 121

LEGEND



Distribution Mains

Contours

Road Tree

Double Orifice Air Valve WO_2 Type 2 Washout 10 Node detail No. 101

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Consultant:




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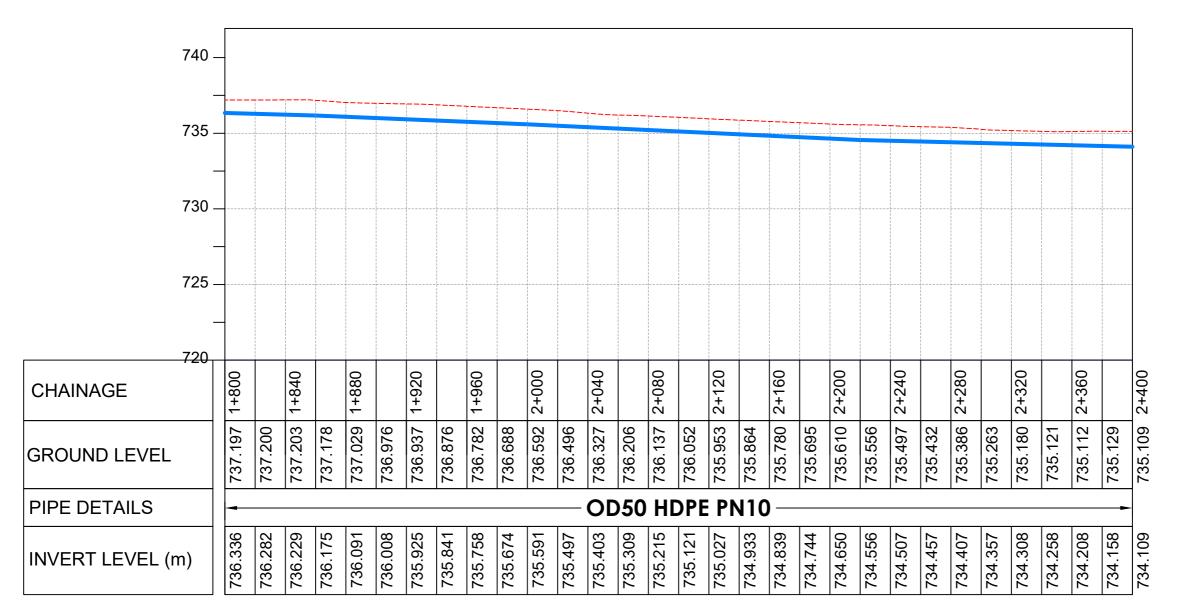
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Date:	Checked:	O.R Daniel
Nov-2022	Approved:	O.R Daniel

ENGINEERING DESIGN DRAWING

Drg No: MWE/GWE/4.3.3 | Cad file No WSS<22_11>



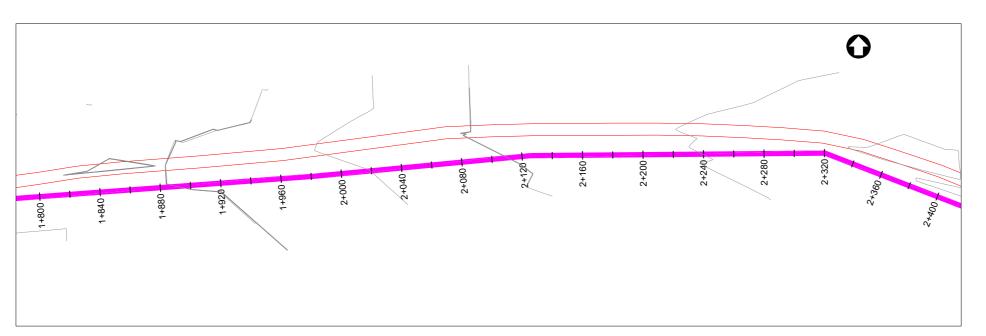

LONGITUDINAL PROFILE


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No	Date	Revision	
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Level Indicator SD 220 SD 116 Outfall Chamber SD 117 Thrust Blocks SD 118 Pipe beddings SD 121

LEGEND



Transmission Mains

Building/House

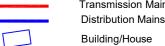

Contours Road

Tree

Double Orifice Air Valve

Type 2 Washout Node detail No. 101

10

WO_2



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CONSTRUCTION OF GWERE RGC WATER **SUPPLY AND SANITATION SYSTEM**

Consultant:





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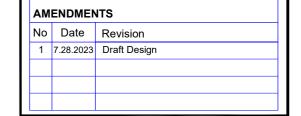
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	Checked:	O.R Daniel
	Approved:	O.R Daniel

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LONGITUDINAL PROFILE



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Level Indicator SD 220 SD 116 Outfall Chamber SD 117 Thrust Blocks SD 118 Pipe beddings SD 121

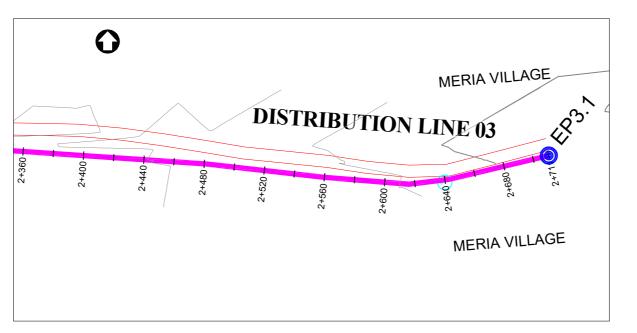LEGEND

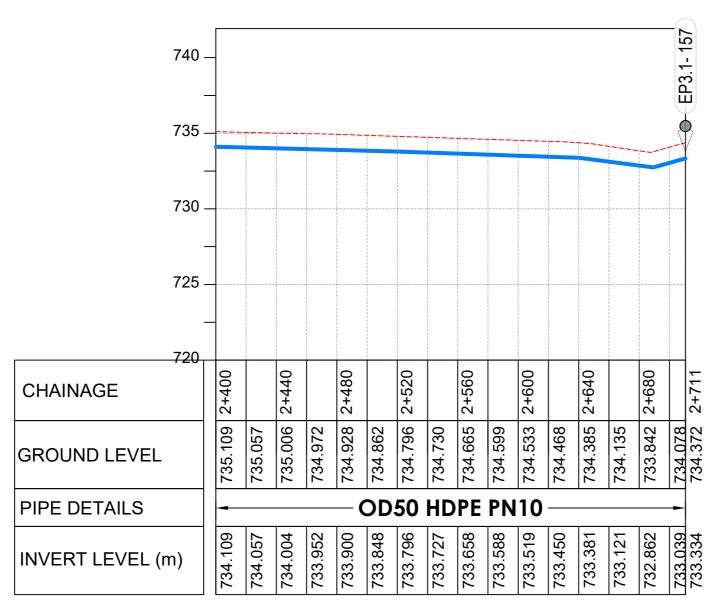

Transmission Mains

Distribution Mains Building/House



Contours Road

Tree Double Orifice Air Valve

WO_2 Type 2 Washout 10

Node detail No. 101

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CONSTRUCTION OF GWERE RGC WATER **SUPPLY AND SANITATION SYSTEM**

Consultant:




10 Philpot Lane, 1st Floor,

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Horizontal Scale: 1:2500 Date: Nov-2022	Drawn:	P.S Eyamu
	Checked:	O.R Daniel
	Approved:	O.R Daniel

ENGINEERING DESIGN DRAWING

Drg No: MWE/GWE/4.3.5 Cad file No WSS<22_11>

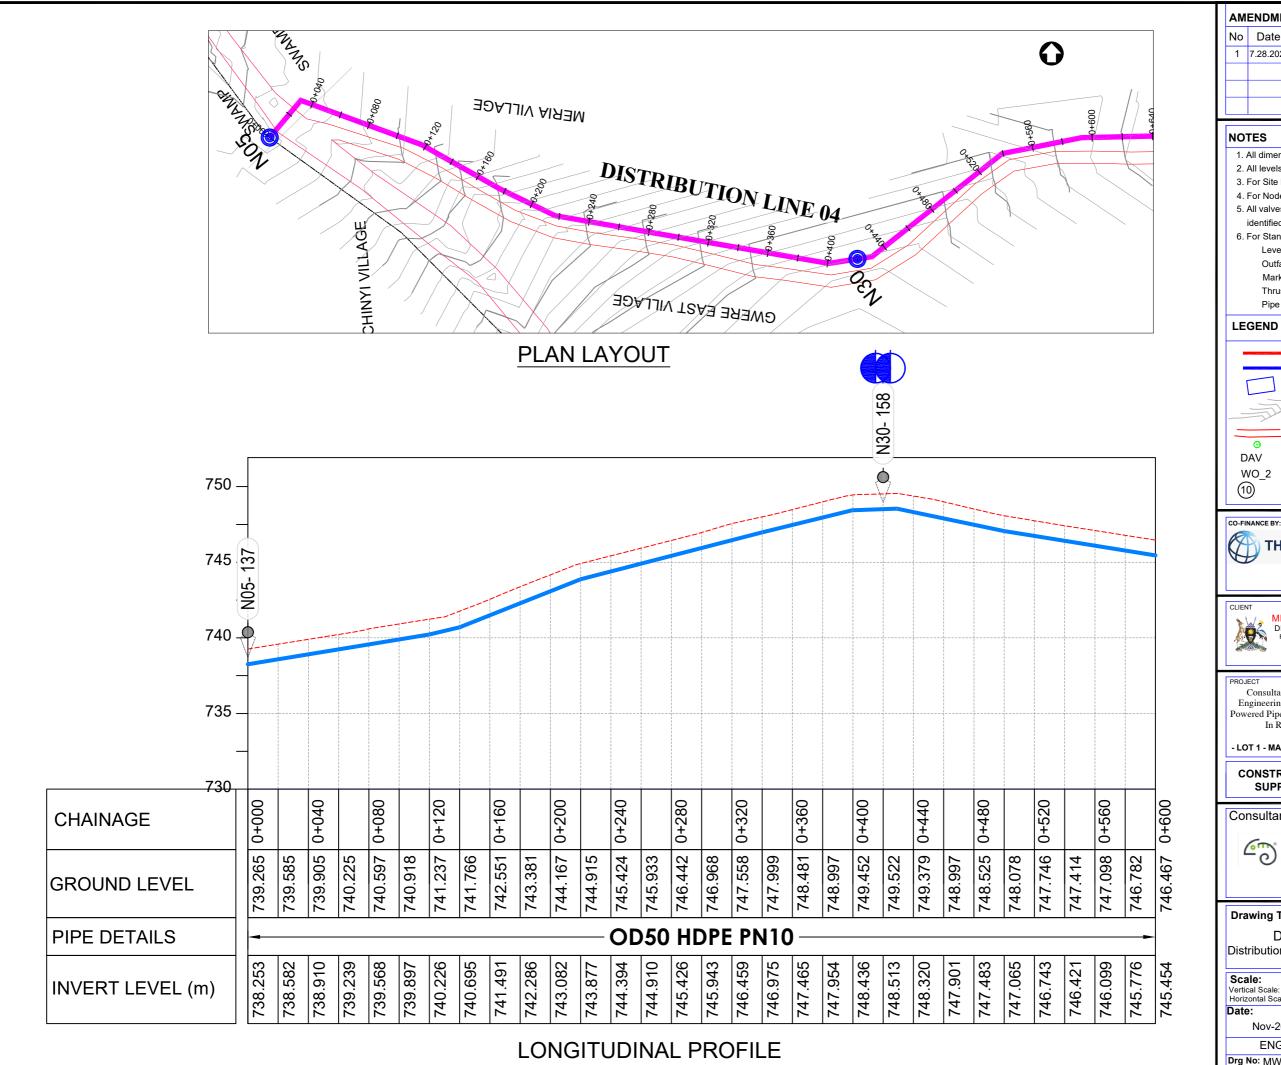

AMENDMENTS No Date Revision 1 7.28.2023 Draft Design

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Level Indicator SD 220 SD 116 Outfall Chamber SD 117

Thrust Blocks SD 118 Pipe beddings SD 121



Transmission Mains

Contours

Road Tree

Double Orifice Air Valve Type 2 Washout

Node detail No. 101

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GOVERNMENT OF UGANDA



DIRECTORATE OF WATER DEVELOPMENT (DWD)

RURAL WATER SUPPLY AND SANITATION DEPARTMENT

Plot 3 - 7 Kabalega Crescent Road, Luzira, Box 20026 Kampala

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- LOT 1 - MADI OKOLLO, TEREGO AND MOYO DISTRICTS -

CONSTRUCTION OF GWERE RGC WATER **SUPPLY AND SANITATION SYSTEM**

Consultant:




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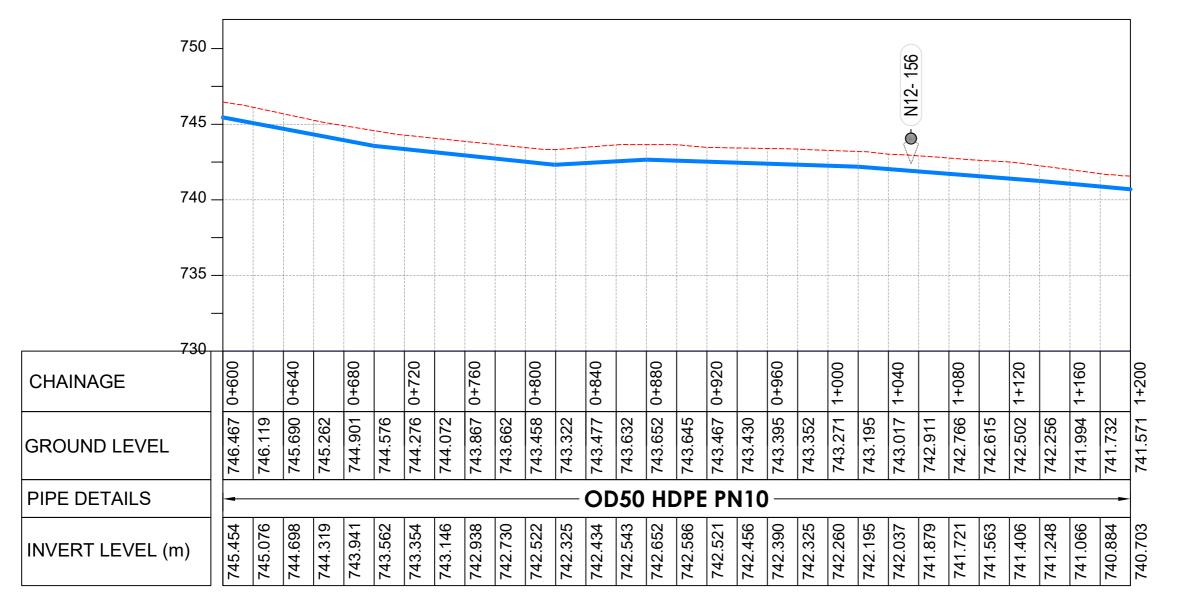
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Horizontal Scale: 1:2500	Drawn:	P.S Eyamu	
Date:	Checked:	O.R Daniel	
Nov-2022	Approved:	O.R Daniel	

ENGINEERING DESIGN DRAWING

Drg No: MWE/GWE/4.4.1 Cad file No WSS<22 11>



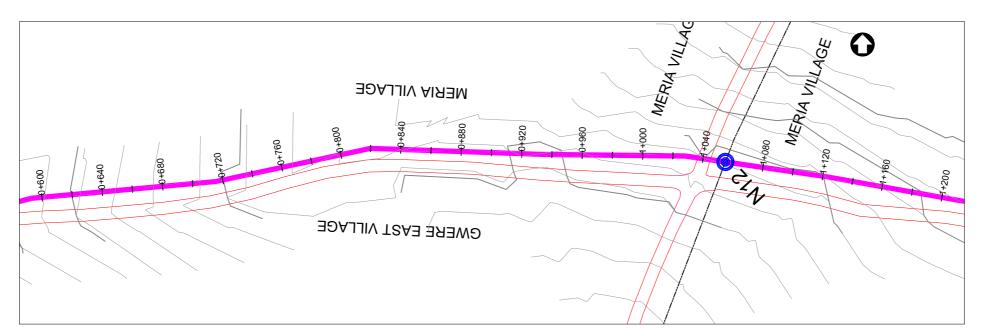

AMENDMENTS No Date Revision

1 7.28.2023 Draft Design

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Level Indicator SD 220 SD 116 Outfall Chamber SD 117 Thrust Blocks SD 118

LEGEND



Pipe beddings

Transmission Mains **Distribution Mains**

SD 121

Building/House

Contours Road

Tree

Double Orifice Air Valve WO_2 Type 2 Washout Node detail No. 101



10

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MINISTRY OF WATER AND ENVIRONMENT
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- LOT 1 - MADI OKOLLO, TEREGO AND MOYO DISTRICTS

CONSTRUCTION OF GWERE RGC WATER **SUPPLY AND SANITATION SYSTEM**

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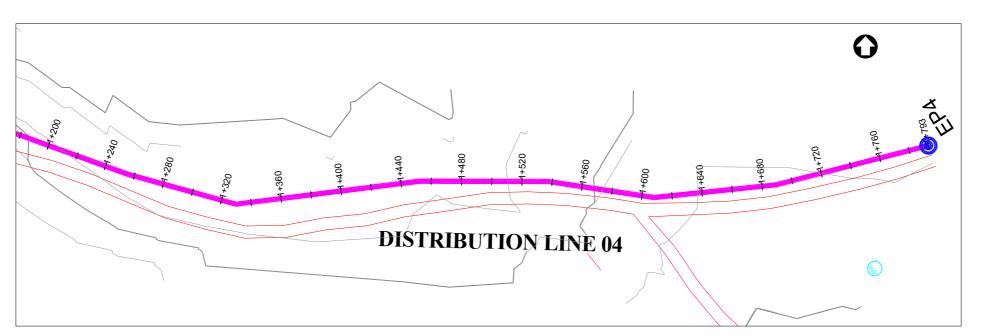
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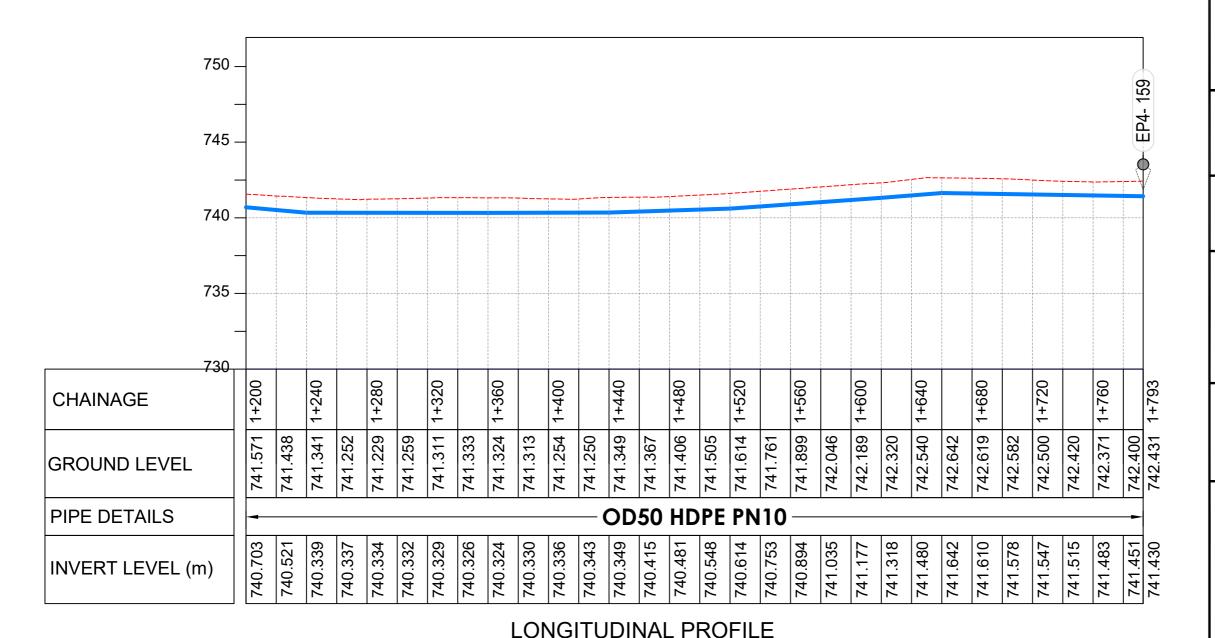
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	Drawn:	P.S Eyamu
Date: Nov-2022	Checked:	O.R Daniel
	Approved:	O.R Daniel
ENGINEERING DESIGN DRAWING		DRAWING

Drg No: MWE/GWE/4.4.2 Cad file No WSS<22_11>

LONGITUDINAL PROFILE





AMENDMENTS No Date Revision 1 7.28.2023 Draft Design

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Level Indicator SD 220 SD 116 Outfall Chamber SD 117 Thrust Blocks SD 118 Pipe beddings SD 121

LEGEND



Transmission Mains **Distribution Mains**

Building/House

Contours Road

Double Orifice Air Valve WO_2 Type 2 Washout

Node detail No. 101

Tree

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Consultant:



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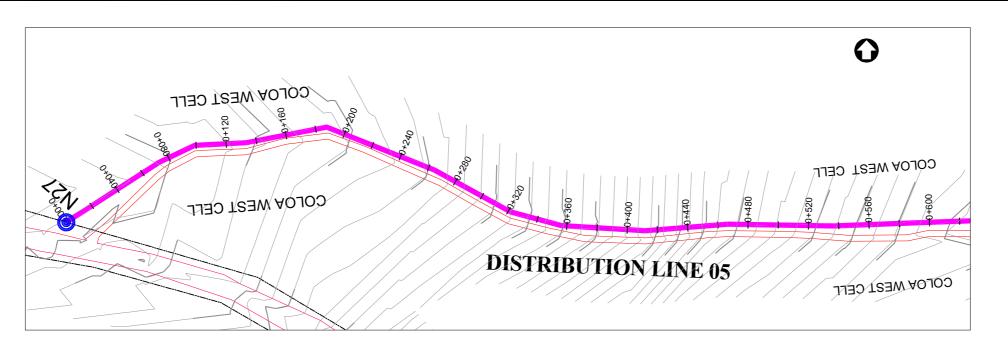
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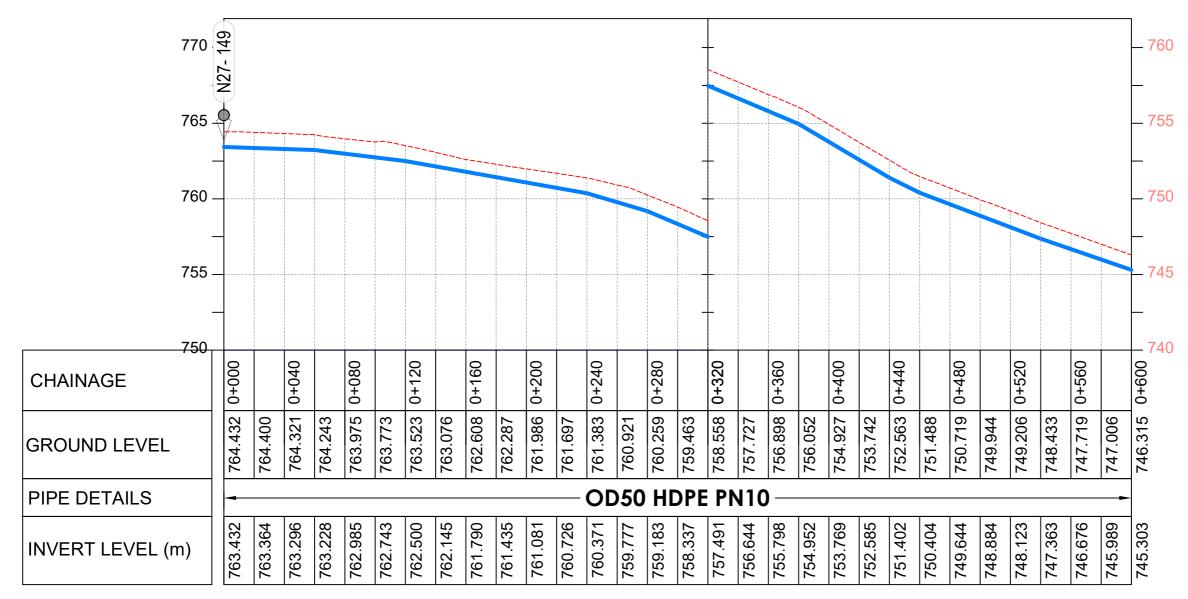
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Horizontal Scale: 1:2500	Drawn:	P.S Eyamu
Date: Nov-2022	Checked:	O.R Daniel
	Approved:	O.R Daniel

ENGINEERING DESIGN DRAWING

Drg No: MWE/GWE/4.4.3 | Cad file No WSS<22_11>





LONGITUDINAL PROFILE

ΑM	AMENDMENTS		
No	Date	Revision	
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Level Indicator SD 220 SD 116 Outfall Chamber SD 117

Thrust Blocks SD 118 Pipe beddings SD 121

LEGEND



Transmission Mains

Building/House

Contours

Road Tree

Double Orifice Air Valve WO_2 Type 2 Washout

10 Node detail No. 101

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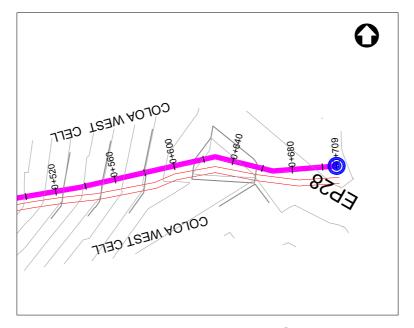
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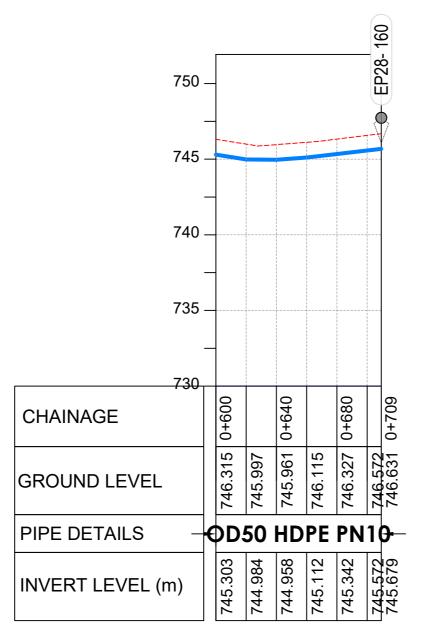
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Date: Nov-2022	Checked:	O.R Daniel	
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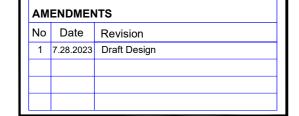
ENGINEERING DESIGN DRAWING

Drg No: MWE/GWE/4.5.1 Cad file No WSS<22_11>





LONGITUDINAL PROFILE



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SD 220 Level Indicator Outfall Chamber SD 116 Marker Post SD 117 Thrust Blocks SD 118

SD 121 Pipe beddings

LEGEND



Transmission Mains

Distribution Mains Building/House



Contours Road

Tree Double Orifice Air Valve WO_2

Type 2 Washout

Node detail No. 101

10



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Consultant:



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Drawing Title:


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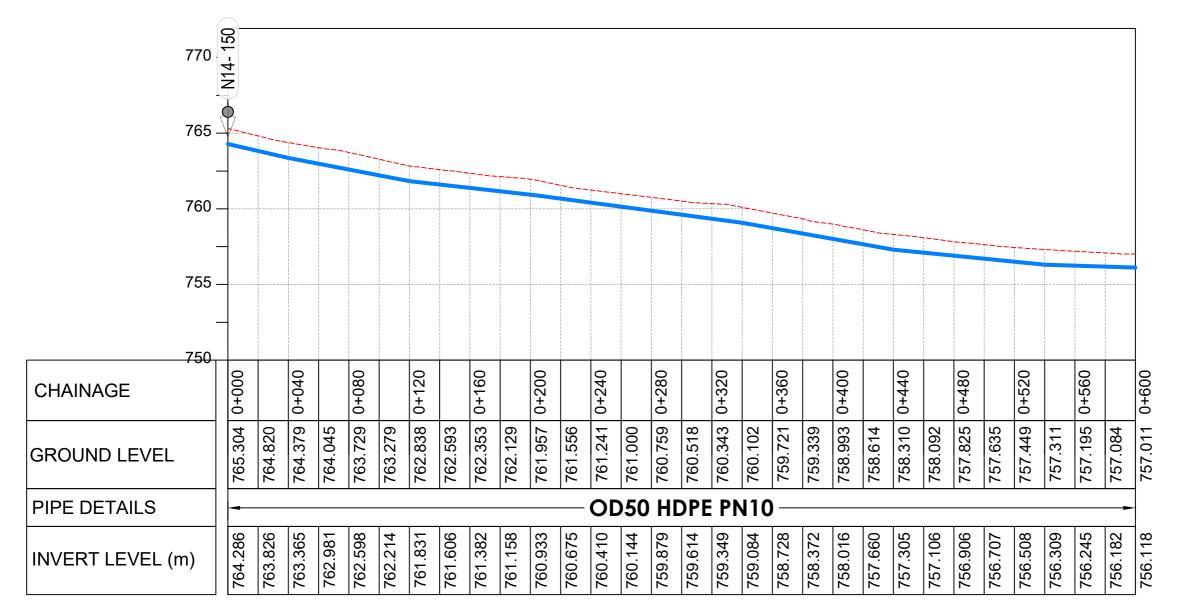
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Designed: O.R Daniel Vertical Scale: 1:250 Horizontal Scale: 1:2500 Drawn: P.S Eyamu Checked: O.R Daniel Nov-2022 Approved: O.R Daniel

ENGINEERING DESIGN DRAWING

Drg No: MWE/GWE/4.5.2 Cad file No WSS<22_11>



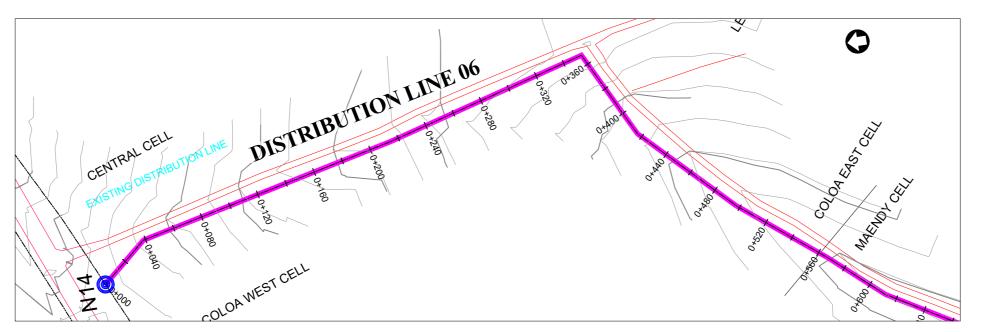

LONGITUDINAL PROFILE

ΑM	MENDMENTS		
No	Date	Revision	
1	7.28.2023	Draft Design	

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Level Indicator SD 220 SD 116 Outfall Chamber SD 117 Thrust Blocks SD 118

LEGEND

Pipe beddings



Transmission Mains

SD 121

Building/House

Contours

Road

Double Orifice Air Valve WO_2 Type 2 Washout

Node detail No. 101

Tree

10



GOVERNMENT OF UGANDA



MINISTRY OF WATER AND ENVIRONMENT
DIRECTORATE OF WATER DEVELOPMENT (DWD)
RURAL WATER SUPPLY AND SANITATION DEPARTMENT
Plot 3 - 7 Kabalega Crescent Road, Luzira, Box 20026 Kampala
Tel: +256 417 889 400, Email: mwe@mwe.go.ug
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Consultancy Services for the Feability Study, Detailed Engineering Design and Construction Supervision of Solar Powered Piped Water Supply Systems and Sanitation Facilities In Refugee Settlements and Host Districts In West Nile and Northern Uganda

- LOT 1 - MADI OKOLLO, TEREGO AND MOYO DISTRICTS

CONSTRUCTION OF GWERE RGC WATER **SUPPLY AND SANITATION SYSTEM**

Consultant:




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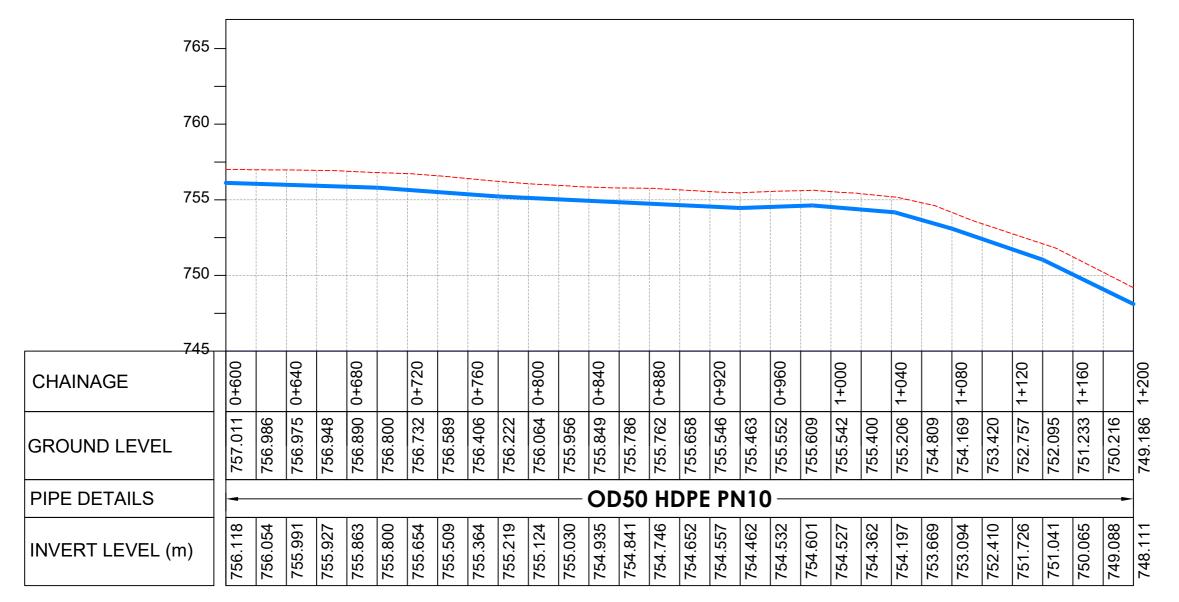
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		Drawn:	P.S Eyamu	
	Date: Nov-2022	Checked:	O.R Daniel	
		Approved:	O.R Daniel	

ENGINEERING DESIGN DRAWING

Drg No: MWE/GWE/4.6.1 Cad file No WSS<22_11>



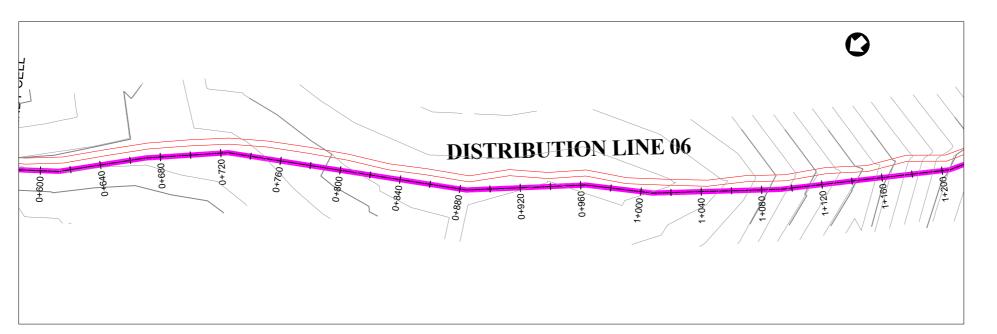

AMENDMENTS No Date Revision

1 7.28.2023 Draft Design

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Level Indicator SD 220 SD 116 Outfall Chamber SD 117 Thrust Blocks SD 118 Pipe beddings SD 121

LEGEND



Transmission Mains **Distribution Mains**

Building/House

Contours Road

Double Orifice Air Valve WO_2

Type 2 Washout

Tree

Node detail No. 101

CO-FINANCE BY

10



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MINISTRY OF WATER AND ENVIRONMENT
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CONSTRUCTION OF GWERE RGC WATER **SUPPLY AND SANITATION SYSTEM**

Consultant:




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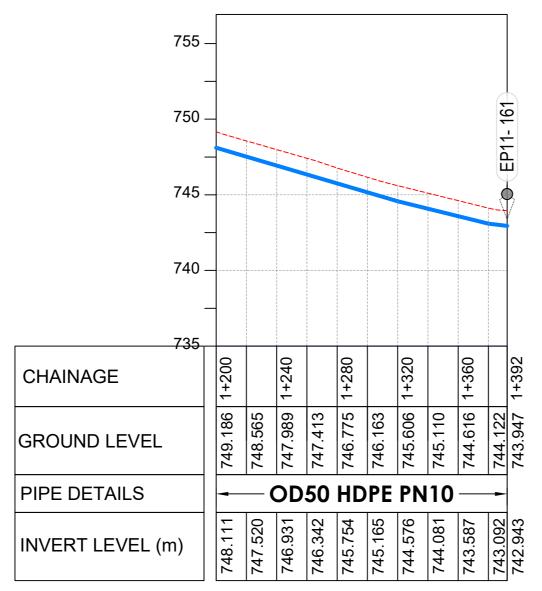
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Date: Nov-2022	Checked:	O.R Daniel
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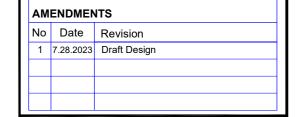
LONGITUDINAL PROFILE



PLAN LAYOUT



LONGITUDINAL PROFILE

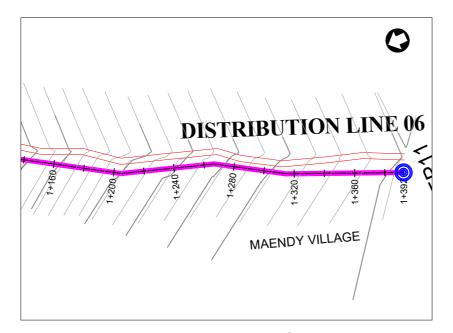

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 Level Indicator
 SD 220

 Outfall Chamber
 SD 116

 Marker Post
 SD 117

 Thrust Blocks
 SD 118

 Pipe beddings
 SD 121

LEGEND



Transmission Mains

Distribution Mains

Building/House

Contours Road

Tree

DAV Double Orifice Air Valve WO_2 Type 2 Washout

Node detail No. 101

CO-FINANCE BY:

10



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MINISTRY OF WATER AND ENVIRONMENT

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CONSTRUCTION OF GWERE RGC WATER SUPPLY AND SANITATION SYSTEM

Consultant:



Corporate Headquarte 10 Philpot Lane, 1st Floor, London EC3M 8AA, United Kingdom


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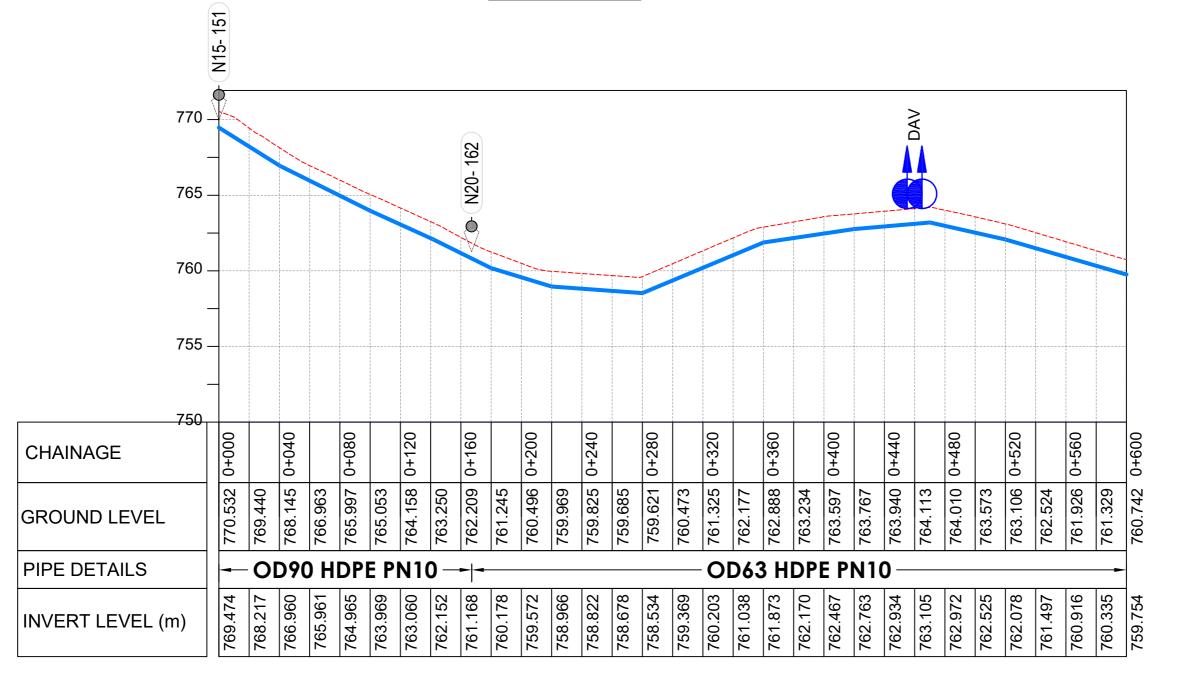
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Distribution Line 06 (CH 1+200.00 - 1+392.35)

Scale: Vertical Scale: 1:250 Horizontal Scale: 1:2500	Designed:	O.R Daniel
	Drawn:	P.S Eyamu
Date: Nov-2022	Checked:	O.R Daniel
	Approved:	O.R Daniel

ENGINEERING DESIGN DRAWING

Drg No: MWE/GWE/4.6.3 | Cad file No WSS<22_11>



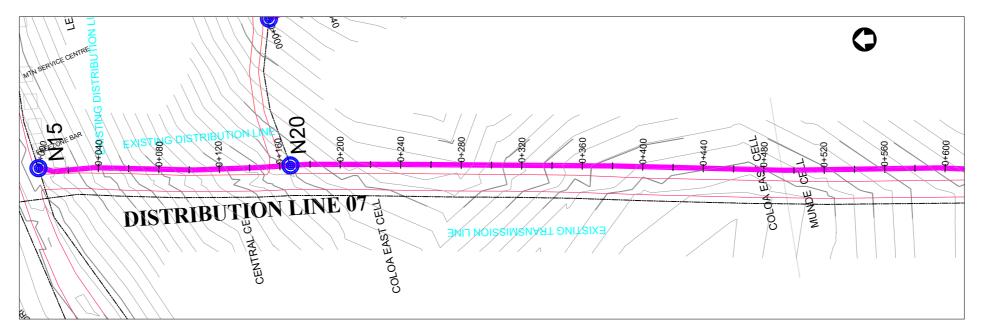

LONGITUDINAL PROFILE

AM	AMENDMENTS		
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Level Indicator SD 220 SD 116 Outfall Chamber SD 117 Thrust Blocks SD 118 Pipe beddings SD 121

LEGEND



Transmission Mains

Distribution Mains Building/House

Contours

Road

Tree Double Orifice Air Valve WO_2 Type 2 Washout

Node detail No. 101

CO-FINANCE BY

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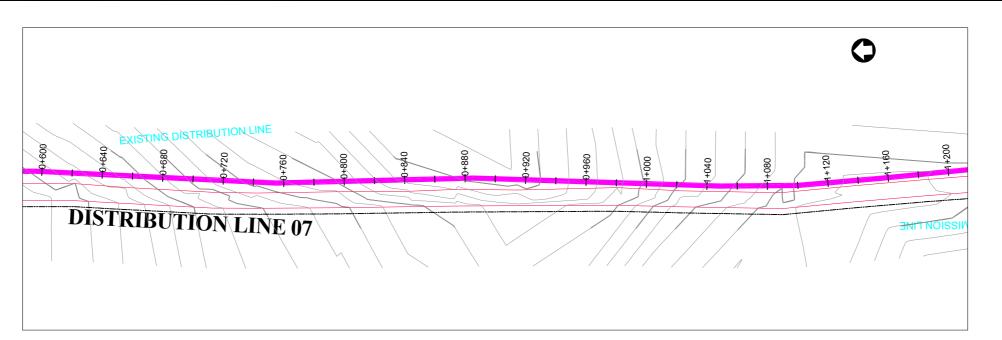
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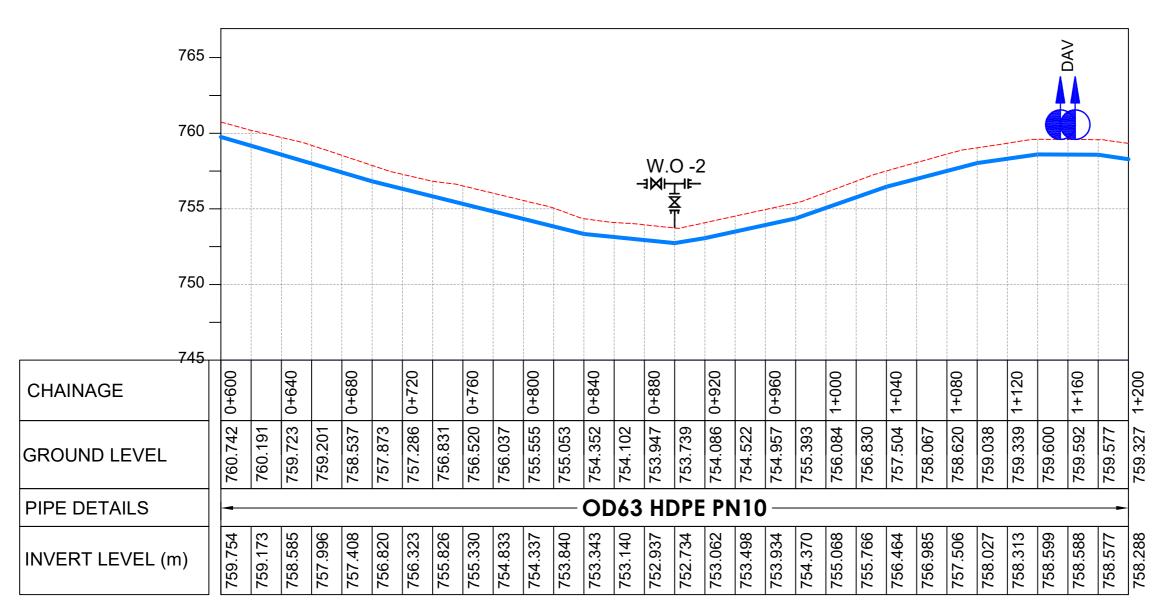
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Horizontal Scale: 1:2500	Drawn:	P.S Eyamu	
Date:	Checked:	O.R Daniel	
Nov-2022	Approved:	O.R Daniel	

ENGINEERING DESIGN DRAWING

Drg No: MWE/GWE/4.7.1 | Cad file No WSS<22_11>





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l	No	Date	Revision
l	1	7.28.2023	Draft Design
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Level Indicator SD 220 SD 116 Outfall Chamber SD 117 Thrust Blocks SD 118

Pipe beddings SD 121

LEGEND



Transmission Mains

Distribution Mains Building/House

Contours Road

Tree Double Orifice Air Valve

WO_2 Type 2 Washout

CO-FINANCE BY

10





Node detail No. 101

GOVERNMENT OF UGANDA



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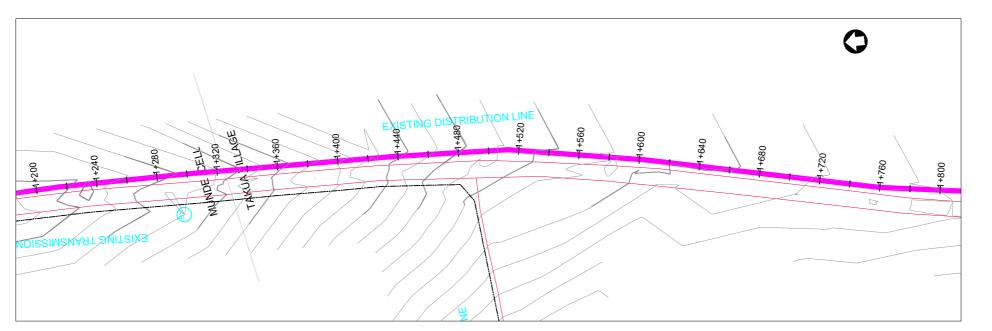
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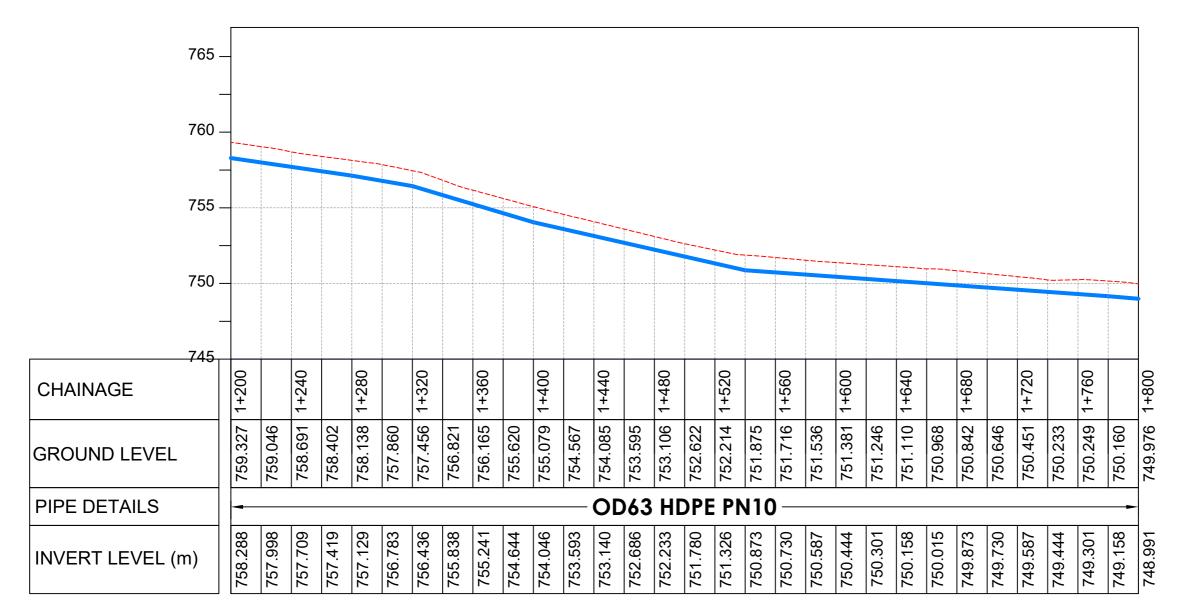
DISTRIBUTION LINE 07 Distribution Line 07 (CH 0+600.00 - 1+200.00)

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l	Horizontal Scale: 1:250	Drawn:	P.S Eyamu
l	Date:	Checked:	O.R Daniel
l	Nov-2022	Approved:	O.R Daniel

ENGINEERING DESIGN DRAWING Drg No: MWE/GWE/4.7.2 Cad file No WSS<22_11>

LONGITUDINAL PROFILE





LONGITUDINAL PROFILE

l	AM	AMENDMENTS	
l	No	Date	Revision
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Level Indicator SD 220 SD 116 Outfall Chamber SD 117 Thrust Blocks SD 118 Pipe beddings SD 121

LEGEND



Transmission Mains Distribution Mains

Building/House

Contours

Road Tree

Double Orifice Air Valve WO_2 Type 2 Washout

10



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Node detail No. 101

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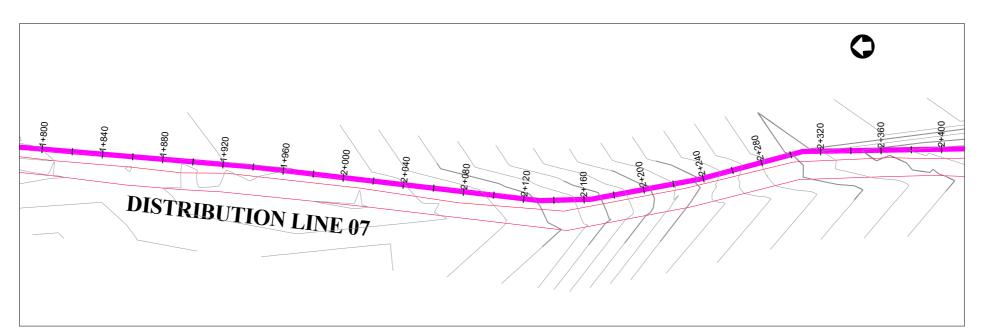



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ı	Horizontal Scale: 1:2500	Drawn:	P.S Eyamu
ı	Date:	Checked:	O.R Daniel
۱	Nov-2022	Approved:	O.R Daniel

ENGINEERING DESIGN DRAWING Drg No: MWE/GWE/4.7.3 Cad file No WSS<22_11>





LONGITUDINAL PROFILE
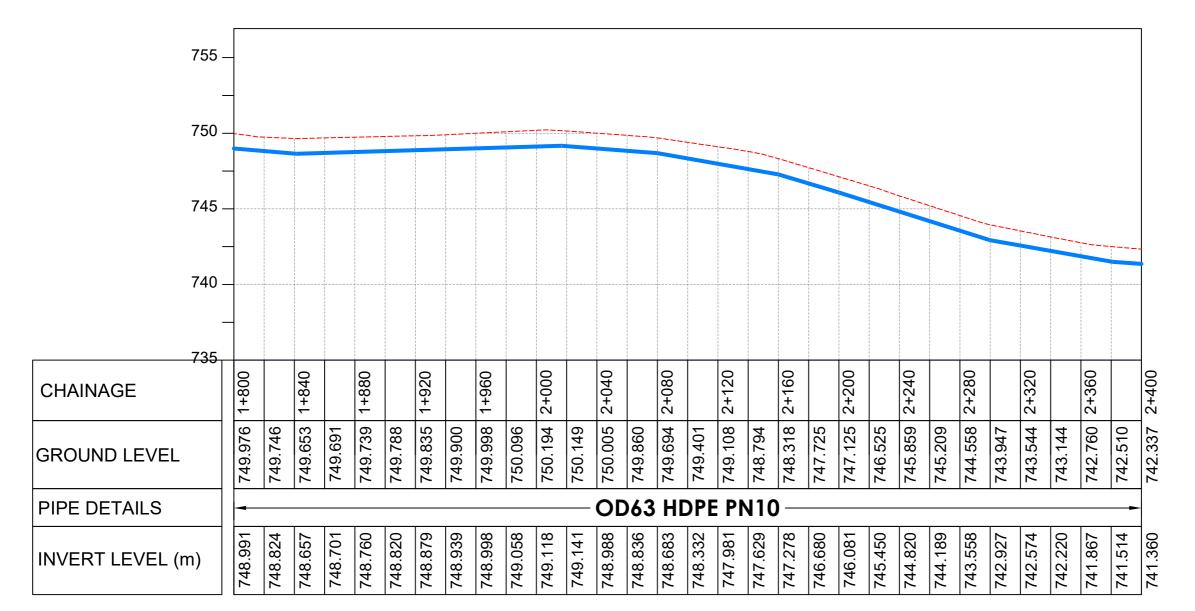
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Level Indicator SD 220
Outfall Chamber SD 116
Marker Post SD 117
Throat Plants

Thrust Blocks SD 118
Pipe beddings SD 121

LEGEND



Transmission Mains
Distribution Mains

Building/House

Contours

Road Tree

DAV Double Orifice Air Valve WO_2 Type 2 Washout

Node detail No. 101

CO-FINANCE BY:

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MINISTRY OF WATER AND ENVIRONMENT

DIRECTORATE OF WATER DEVELOPMENT (DWD)

RURAL WATER SUPPLY AND SANITATION DEPARTMENT

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CONSTRUCTION OF GWERE RGC WATER SUPPLY AND SANITATION SYSTEM

Consultant:



Corporate Headquarter 10 Philpot Lane, 1st Floor, London EC3M 8AA, United Kingdom


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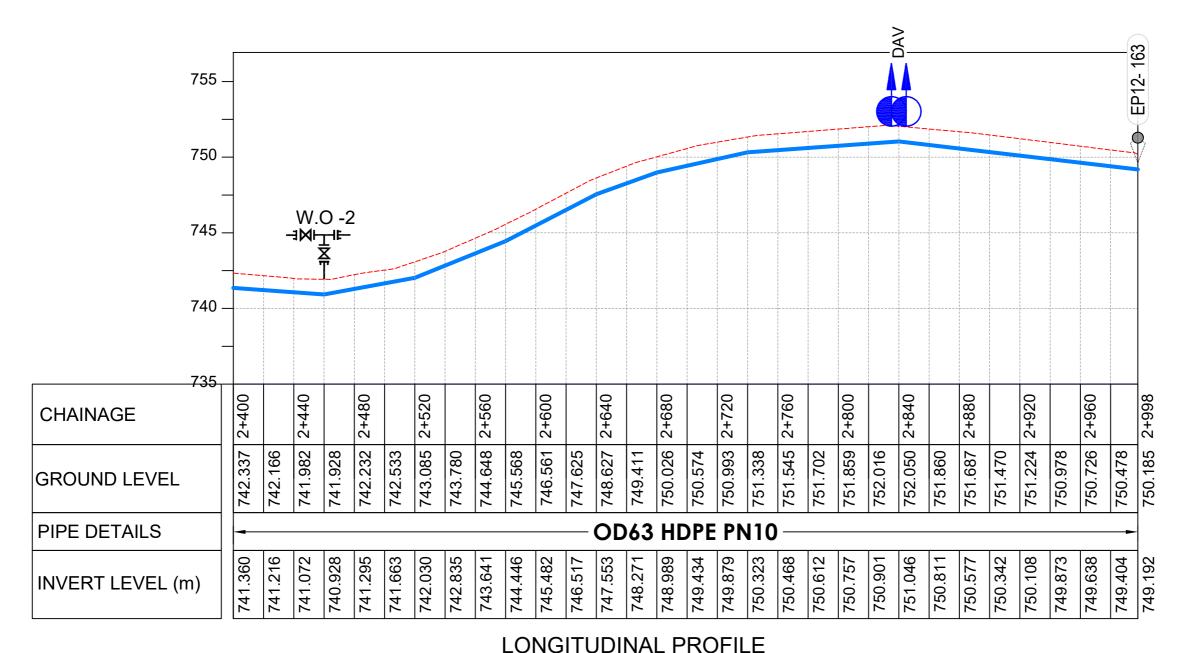
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Horizontal Scale: 1:2500	Drawn:	P.S Eyamu
Date:	Checked:	O.R Daniel
Nov-2022	Approved:	O.R Daniel

ENGINEERING DESIGN DRAWING

Drg No: MWE/GWE/4.7.4 | Cad file No WSS<22_11>



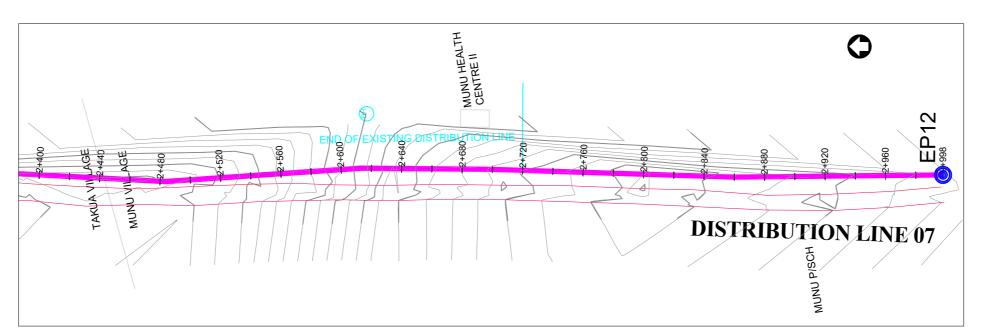

AMENDMENTS No Date Revision 1 7.28.2023 Draft Design

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Level Indicator SD 220 SD 116 Outfall Chamber SD 117 Thrust Blocks SD 118 Pipe beddings SD 121

LEGEND



Transmission Mains

Distribution Mains Building/House

Contours

Road

Tree Double Orifice Air Valve

Type 2 Washout Node detail No. 101

CO-FINANCE BY

10

DAV

WO_2



MINISTRY OF WATER AND ENVIRONMENT
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Consultant:



10 Philpot Lane, 1st Floor, London EC3M 8AA,

DISTRIBUTION LINE 07 Distribution Line 07 (CH 2+400.00 - 2+998.02)


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Vertical Scale: 1:250 Horizontal Scale: 1:2500	Drawn:	P.S Eyamu	
Date:	Checked:	O.R Daniel	
Nov-2022	Approved:	O.R Daniel	

ENGINEERING DESIGN DRAWING

Drg No: MWE/GWE/4.7.5 Cad file No WSS<22_11>

нояпно опритися MARIAGU WĘST CÉLL Reservoir Tank Existing efori DISTRIBUTION LANE 08 MARIANGU EAST CELL

PLAN LAYOUT

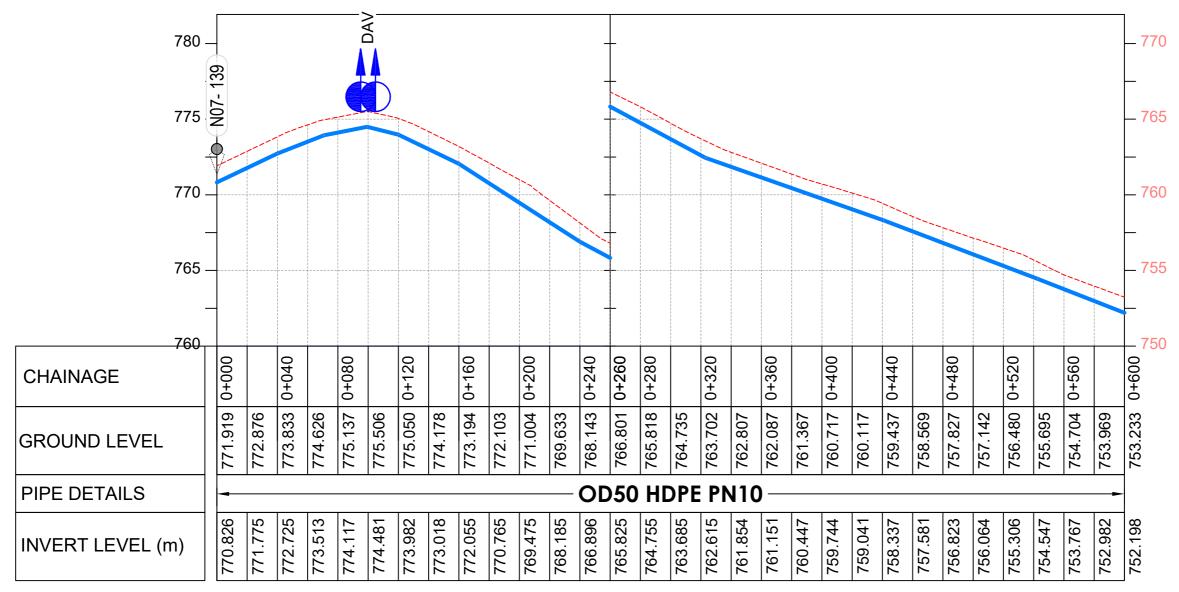

LONGITUDINAL PROFILE

ΑМ	AMENDMENTS		
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Level Indicator SD 220 SD 116 Outfall Chamber SD 117 Thrust Blocks SD 118 Pipe beddings SD 121

LEGEND



Contours Road Tree

Double Orifice Air Valve WO_2 Type 2 Washout 10 Node detail No. 101

③



GOVERNMENT OF UGANDA

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10 Philpot Lane, 1st Floor,


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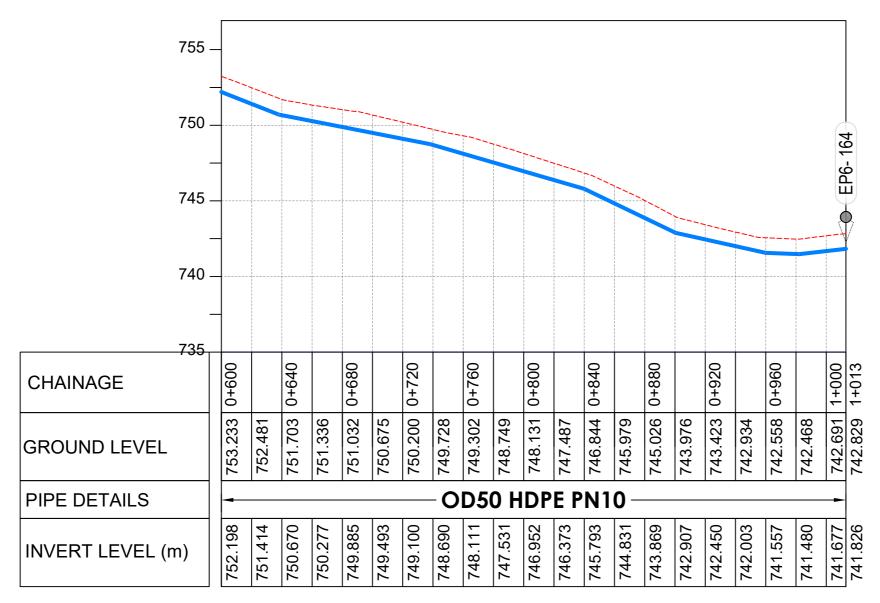
DISTRIBUTION LINE 08 Distribution Line 08 (CH 0+000.00 - 0+600.00) (1

Designed: O.R Daniel Vertical Scale: 1:250 Horizontal Scale: 1:2500 Drawn: P.S Eyamu Checked: O.R Daniel Approved: O.R Daniel

ENGINEERING DESIGN DRAWING

Drg No: MWE/GWE/4.8.1 Cad file No WSS<22 11>



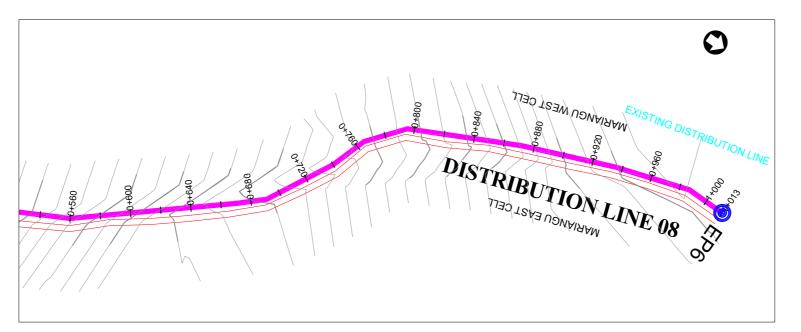

No Date Revision 1 7.28.2023 Draft Design

NOTES

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Level Indicator SD 220 SD 116 Outfall Chamber SD 117 Thrust Blocks SD 118 Pipe beddings SD 121

LEGEND



Transmission Mains

Distribution Mains Building/House

Contours Road

Tree Double Orifice Air Valve

Type 2 Washout

Node detail No. 101

CO-FINANCE BY

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DAV

WO_2



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Consultant:




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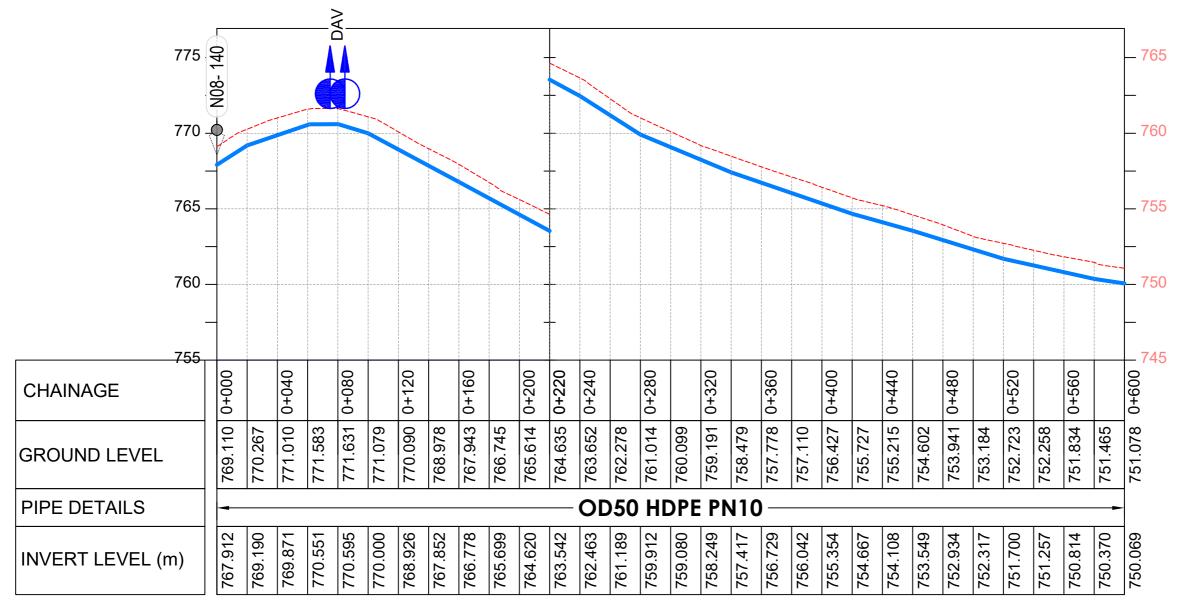
DISTRIBUTION LINE 08 Distribution Line 08 (CH 0+600.00 - 1+013.01)

l	Scale: Vertical Scale: 1:250	Designed:	O.R Daniel
l	Horizontal Scale: 1:2500	Drawn:	P.S Eyamu
	Date:	Checked:	O.R Daniel
l	Nov-2022	Approved:	O.R Daniel

ENGINEERING DESIGN DRAWING Drg No: MWE/GWE/4.8.2 Cad file No WSS<22_11>

LONGITUDINAL PROFILE



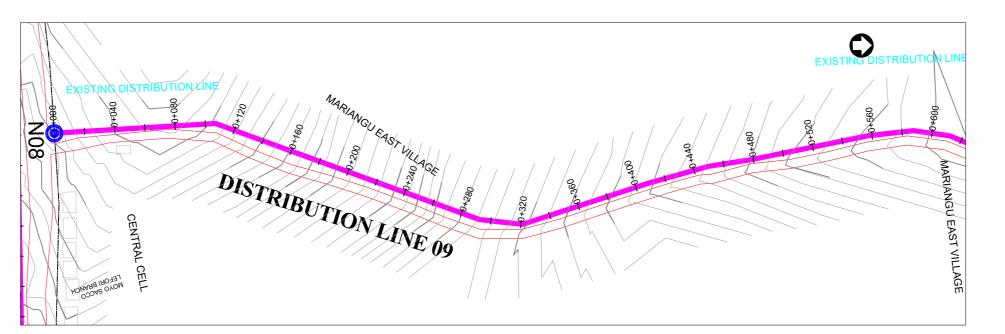

LONGITUDINAL PROFILE


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Level Indicator SD 220 SD 116 Outfall Chamber SD 117 Thrust Blocks SD 118

Pipe beddings **LEGEND**



SD 121

Contours Road Tree

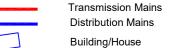Double Orifice Air Valve WO_2 Type 2 Washout 10 Node detail No. 101



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CONSTRUCTION OF GWERE RGC WATER **SUPPLY AND SANITATION SYSTEM**

Consultant:




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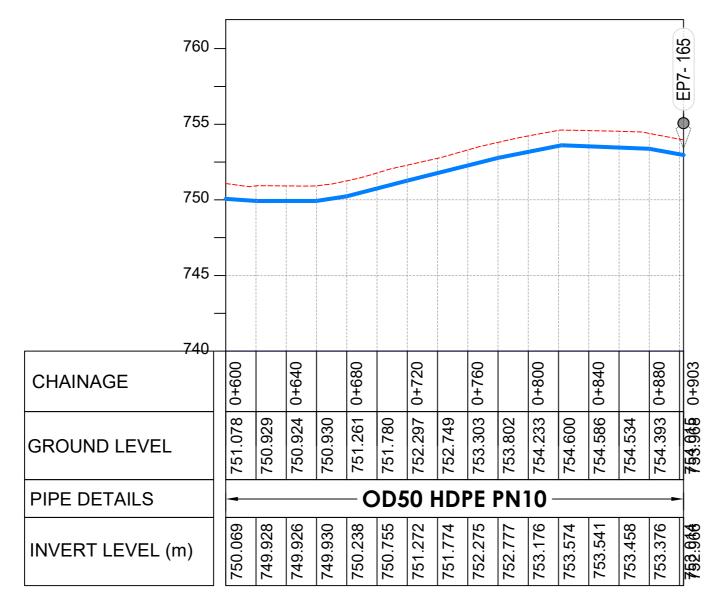
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Scale: Vertical Scale: 1:250 Horizontal Scale: 1:2500 Date: Nov-2022	Designed:	O.R Daniel
	Drawn:	P.S Eyamu
	Checked:	O.R Daniel
	Approved:	O.R Daniel


ENGINEERING DESIGN DRAWING

Drg No: MWE/GWE/4.9.1 Cad file No WSS<22 11>



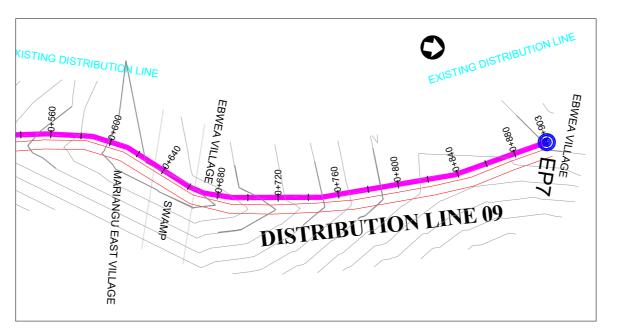

LONGITUDINAL PROFILE

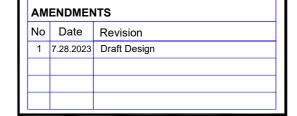

NOTES

- 1. All dimensions are in metres unless stated otherwise.
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- 3. For Site location see Dwg. MWE/GWE/0.0.0
- 4. For Node details, see Dwg. MWE/GWE/5.0.0 5. All valves, hydrants and washout locations are
- identified by marker post in positions

6. For Standard details see sheets as follows Level Indicator SD 220

SD 116 Outfall Chamber SD 117 Thrust Blocks SD 118 SD 121 Pipe beddings

LEGEND



Transmission Mains

Distribution Mains

Building/House

Contours Road

Tree Double Orifice Air Valve

WO_2 Type 2 Washout

10 Node detail No. 101

CO-FINANCE BY

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GOVERNMENT OF UGANDA



MINISTRY OF WATER AND ENVIRONMENT
DIRECTORATE OF WATER DEVELOPMENT (DWD)
RURAL WATER SUPPLY AND SANITATION DEPARTMENT
Plot 3 - 7 Kabalega Crescent Road, Luzira, Box 20026 Kampala
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Consultancy Services for the Feability Study, Detailed Engineering Design and Construction Supervision of Solar Powered Piped Water Supply Systems and Sanitation Facilities In Refugee Settlements and Host Districts In West Nile and Northern Uganda

- LOT 1 - MADI OKOLLO, TEREGO AND MOYO DISTRICTS -

CONSTRUCTION OF GWERE RGC WATER **SUPPLY AND SANITATION SYSTEM**

Consultant:




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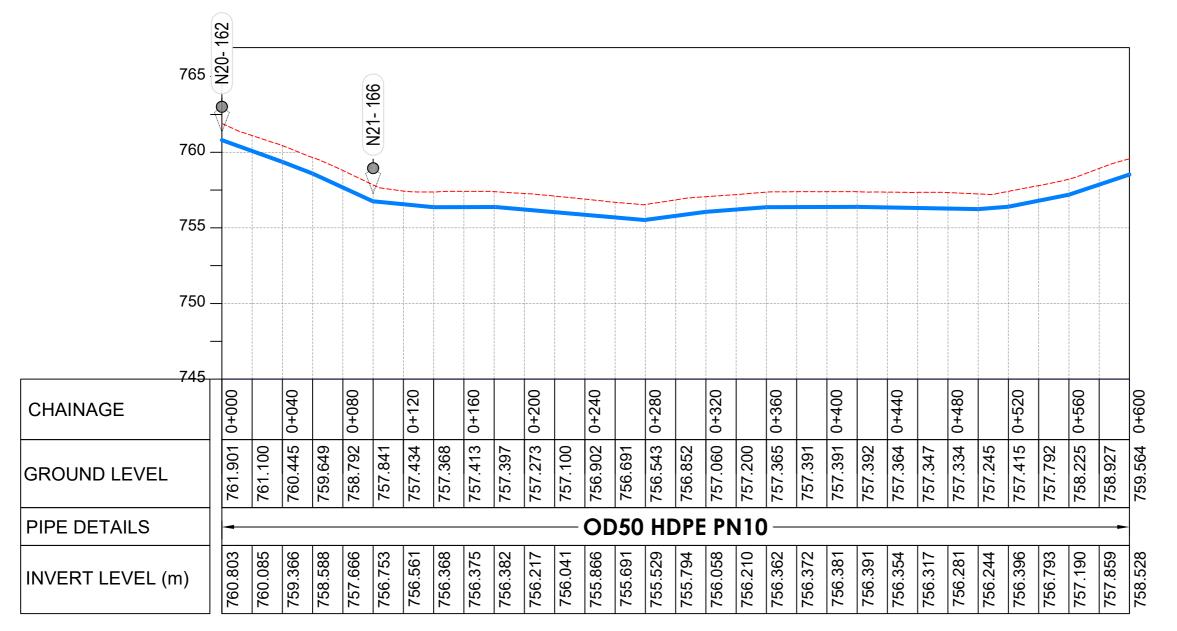
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ı	Horizontal Scale: 1:2500	Drawn:	P.S Eyamu
ı	Date:	Checked:	O.R Daniel
ı	Nov-2022	Approved: O.R Daniel	O.R Daniel

ENGINEERING DESIGN DRAWING

Drg No: MWE/GWE/4.9.2 Cad file No WSS<22_11>



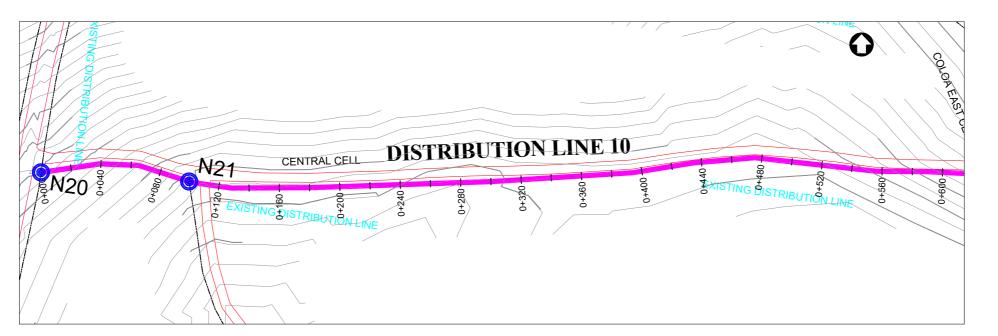

AMENDMENTS

No	Date	Revision
1	7.28.2023	Draft Design

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Level Indicator SD 220 SD 116 Outfall Chamber SD 117 Thrust Blocks SD 118 Pipe beddings SD 121

LEGEND



Transmission Mains

Distribution Mains

Building/House Contours

Road Tree

Double Orifice Air Valve WO_2 Type 2 Washout

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THE WORLD BANK AND

Node detail No. 101

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CONSTRUCTION OF GWERE RGC WATER **SUPPLY AND SANITATION SYSTEM**

Consultant:



10 Philpot Lane, 1st Floor, London EC3M 8AA,


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Horizontal Scale: 1:2500 Date: Nov-2022	Drawn:	P.S Eyamu	
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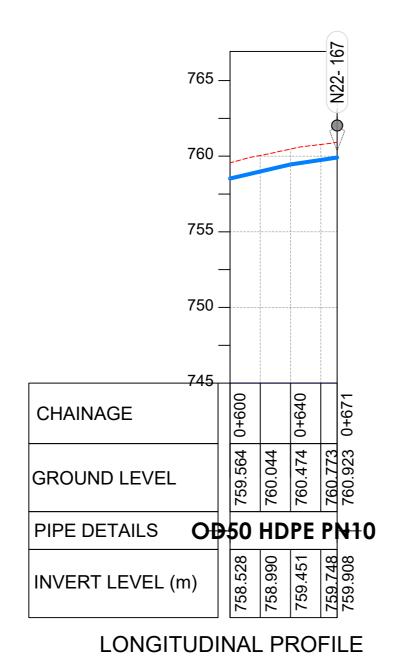
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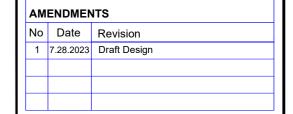
Drg No: MWE/GWE/4.10.1 Cad file No WSS<22_11>

LONGITUDINAL PROFILE



PLAN LAYOUT



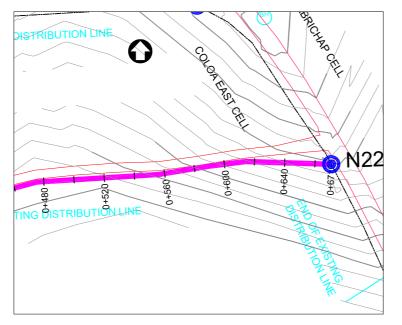

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SD 220 Level Indicator Outfall Chamber SD 116 SD 117 Thrust Blocks SD 118 SD 121 Pipe beddings

LEGEND



Transmission Mains

Distribution Mains

Building/House

Contours Road

Tree

Double Orifice Air Valve Type 2 Washout

Node detail No. 101

10

DAV

WO_2

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CONSTRUCTION OF GWERE RGC WATER SUPPLY AND SANITATION SYSTEM

Consultant:



Corporate Headquarter 10 Philpot Lane, 1st Floor,


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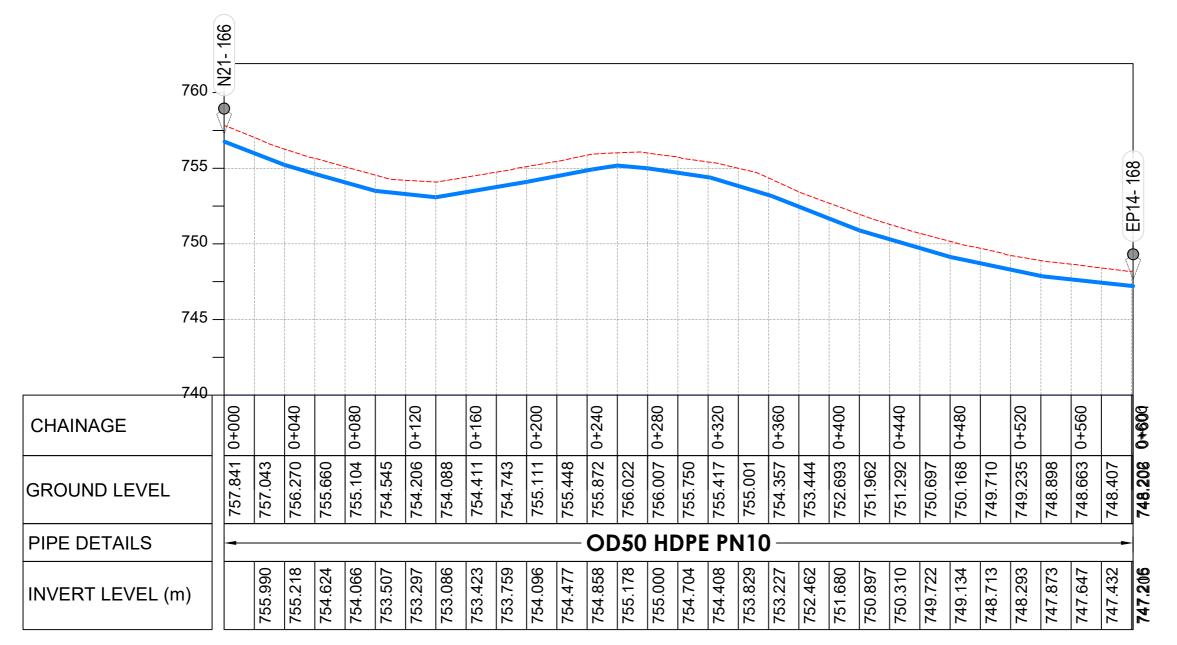
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Scale: Vertical Scale: 1:250	Designed:	O.R Daniel
Horizontal Scale: 1:2500	Drawn:	P.S Eyamu
Date:	Checked:	O.R Daniel
Nov-2022	Approved:	O.R Daniel

ENGINEERING DESIGN DRAWING

Drg No: MWE/GWE/4.10.2 Cad file No WSS<22_11>



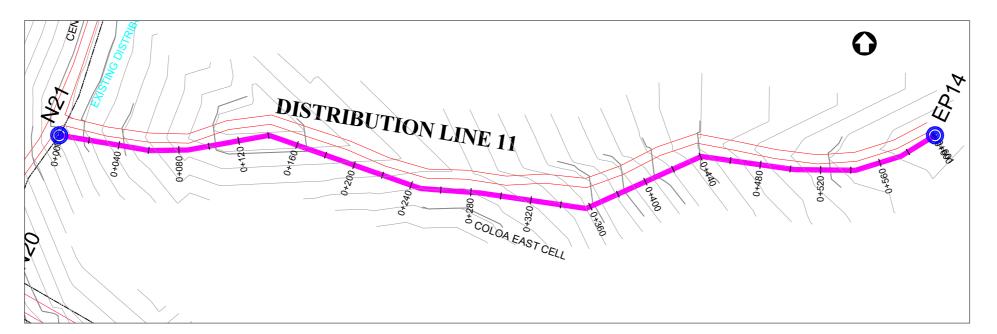

LONGITUDINAL PROFILE

AM	AMENDMENTS		
No	Date	Revision	
1	7.28.2023	Draft Design	

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Level Indicator SD 220 SD 116 Outfall Chamber SD 117 Thrust Blocks SD 118

Pipe beddings SD 121

LEGEND



Transmission Mains **Distribution Mains**

Building/House

Contours Road

Tree

Double Orifice Air Valve WO_2 Type 2 Washout

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THE WORLD BANK AND

Node detail No. 101

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CONSTRUCTION OF GWERE RGC WATER **SUPPLY AND SANITATION SYSTEM**

Consultant:




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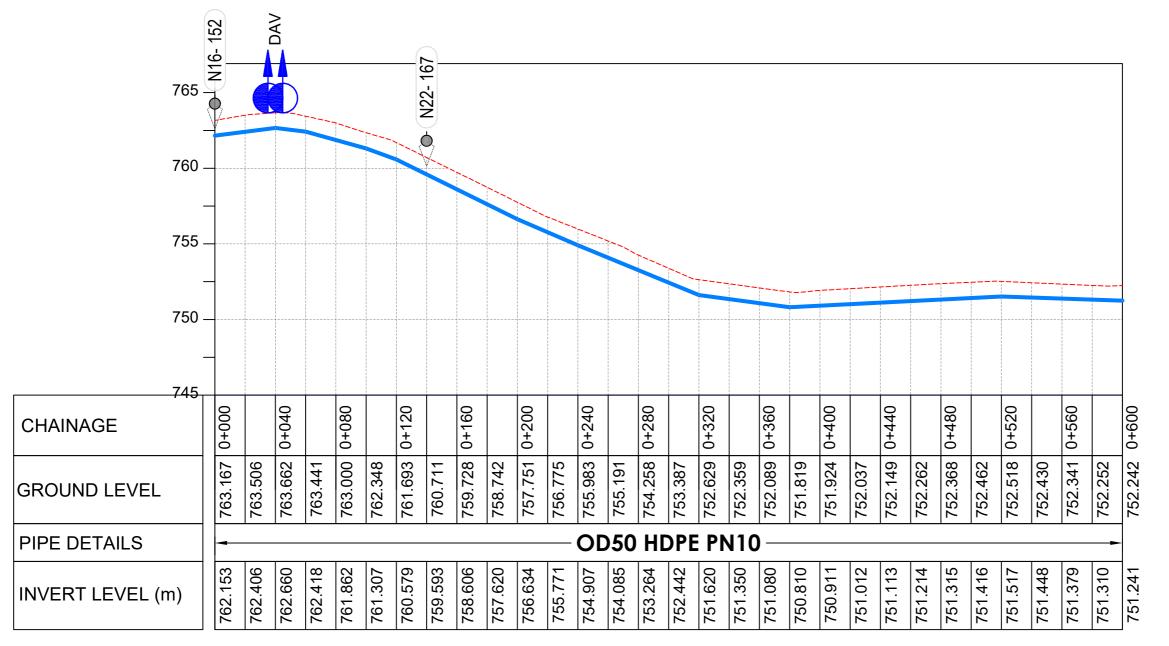
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Horizontal Scale: 1:2500	Drawn:	P.S Eyamu
Date:	Checked:	O.R Daniel
Nov-2022	Approved:	O.R Daniel

ENGINEERING DESIGN DRAWING

Drg No: MWE/GWE/4.11.1 Cad file No WSS<22_11>



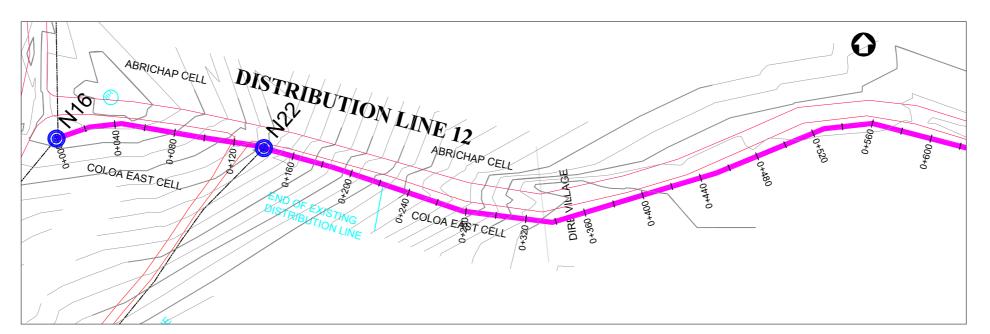

LONGITUDINAL PROFILE

AMENDMENTS		NTS
No	Date	Revision
1	7.28.2023	Draft Design

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Level Indicator SD 220 SD 116 Outfall Chamber SD 117 Thrust Blocks SD 118

Pipe beddings SD 121

LEGEND



Contours Road

Tree Double Orifice Air Valve WO_2 Type 2 Washout

10 Node detail No. 101

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DIRECTORATE OF WATER DEVELOPMENT (DWD)
RURAL WATER SUPPLY AND SANITATION DEPARTMENT
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GOVERNMENT OF UGANDA

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- LOT 1 - MADI OKOLLO, TEREGO AND MOYO DISTRICTS -

CONSTRUCTION OF GWERE RGC WATER **SUPPLY AND SANITATION SYSTEM**

Consultant:




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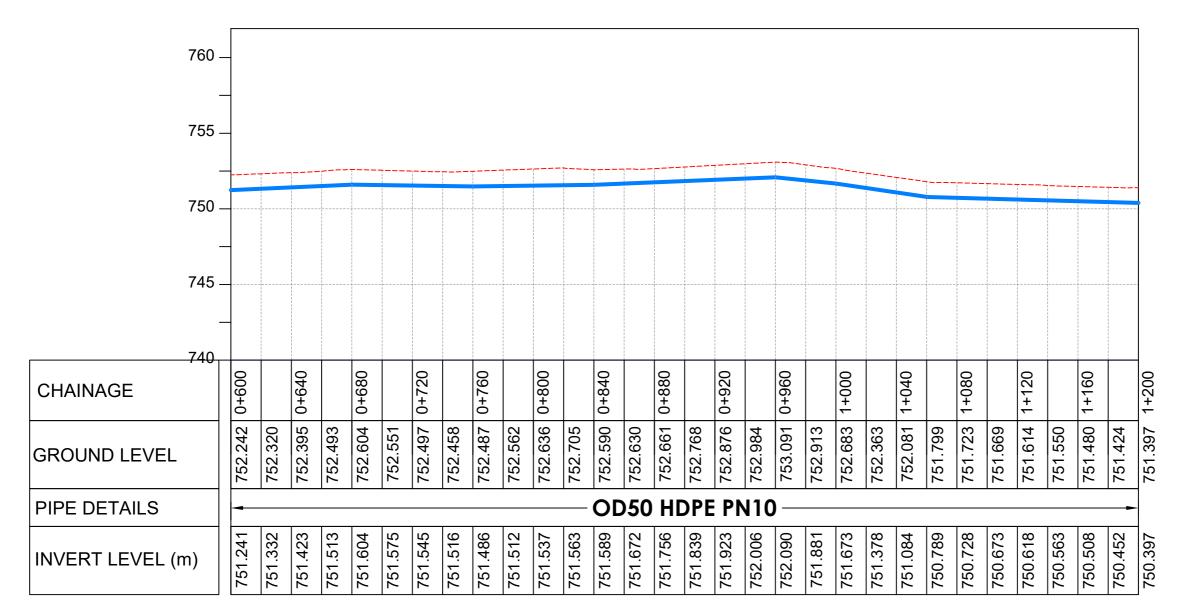
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Scale: Vertical Scale: 1:250	Designed:	O.R Daniel
Horizontal Scale: 1:2500	Drawn:	P.S Eyamu
Date:	Checked:	O.R Daniel
Nov-2022	Approved:	O.R Daniel

ENGINEERING DESIGN DRAWING

Drg No: MWE/GWE/4.12.1 Cad file No WSS<22_11>



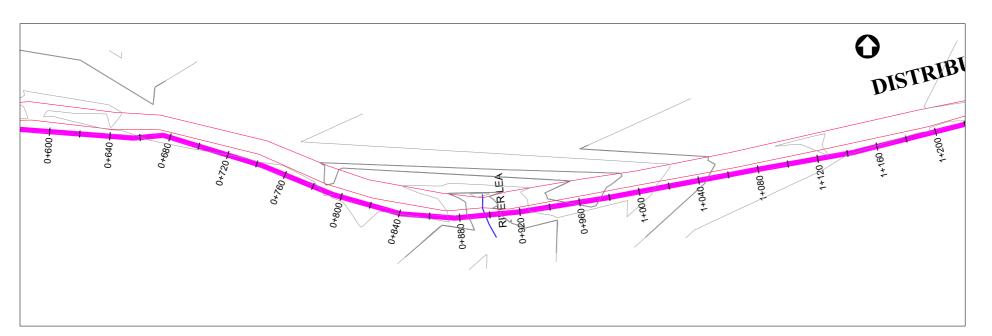

AMENDMENTS No Date Revision 1 7.28.2023 Draft Design

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Level Indicator SD 220 SD 116 Outfall Chamber SD 117 Thrust Blocks SD 118 Pipe beddings SD 121

LEGEND



Transmission Mains

Distribution Mains Building/House

Contours Road

Tree Double Orifice Air Valve WO_2

Type 2 Washout Node detail No. 101

10



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MINISTRY OF WATER AND ENVIRONMENT
DIRECTORATE OF WATER DEVELOPMENT (DWD)
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- LOT 1 - MADI OKOLLO, TEREGO AND MOYO DISTRICTS -

CONSTRUCTION OF GWERE RGC WATER **SUPPLY AND SANITATION SYSTEM**

Consultant:




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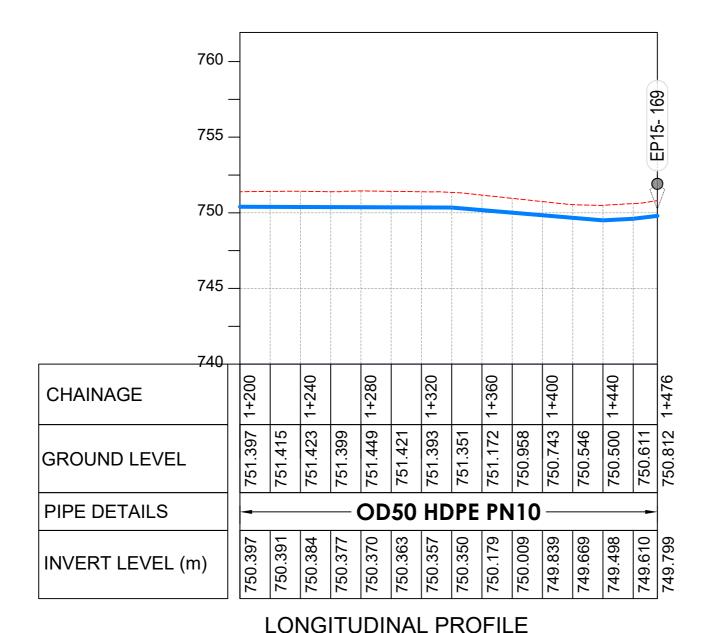
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ı	Horizontal Scale: 1:250	Drawn:	P.S Eyamu
ı	Date:	e: Checked: O.R Da	O.R Daniel
ı	Nov-2022	Approved:	O.R Daniel

ENGINEERING DESIGN DRAWING Drg No: MWE/GWE/4.12.2 Cad file No WSS<22_11>

LONGITUDINAL PROFILE



PLAN LAYOUT

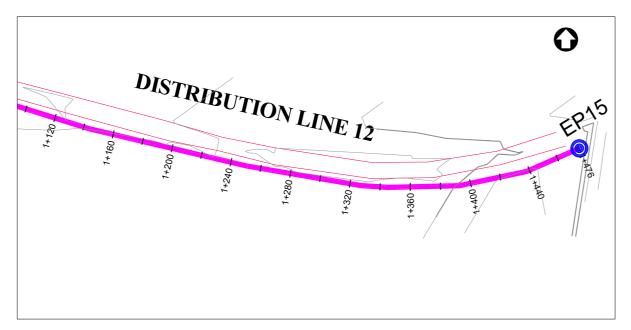

AMENDMENTS No Date Revision 1 7.28.2023 Draft Design

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SD 220 Level Indicator Outfall Chamber SD 116 Marker Post SD 117 Thrust Blocks SD 118 SD 121 Pipe beddings

LEGEND



Transmission Mains

Distribution Mains Building/House



Contours

Road Tree

Double Orifice Air Valve

Type 2 Washout

Node detail No. 101

CO-FINANCE BY

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10

WO_2



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MINISTRY OF WATER AND ENVIRONMENT

DIRECTORATE OF WATER DEVELOPMENT (DWD)

RURAL WATER SUPPLY AND SANITATION DEPARTMENT

Plot 3 - 7 Kabalega Crescent Road, Luzira, Box 20026 Kampala

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CONSTRUCTION OF GWERE RGC WATER **SUPPLY AND SANITATION SYSTEM**

Consultant:




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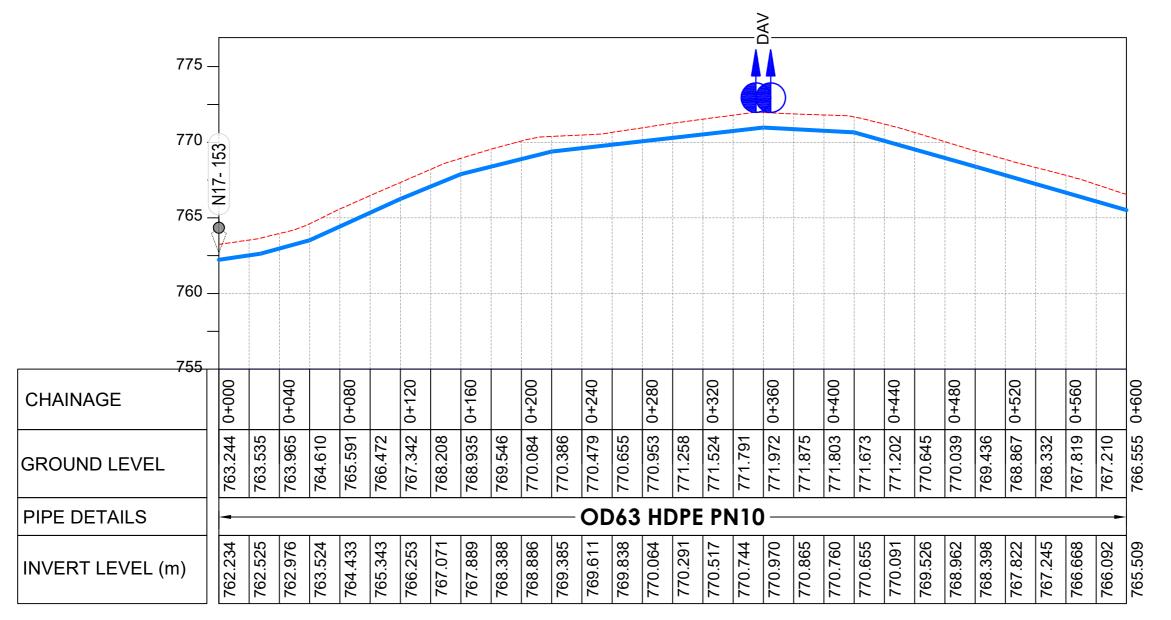
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Vertical Scale: 1:250 Horizontal Scale: 1:2500 Date: Nov-2022	Designed:	O.R Daniel
	Drawn:	P.S Eyamu
	Checked:	O.R Daniel
	Approved:	O.R Daniel

ENGINEERING DESIGN DRAWING

Drg No: MWE/GWE/4.12.3 Cad file No WSS<22_11>



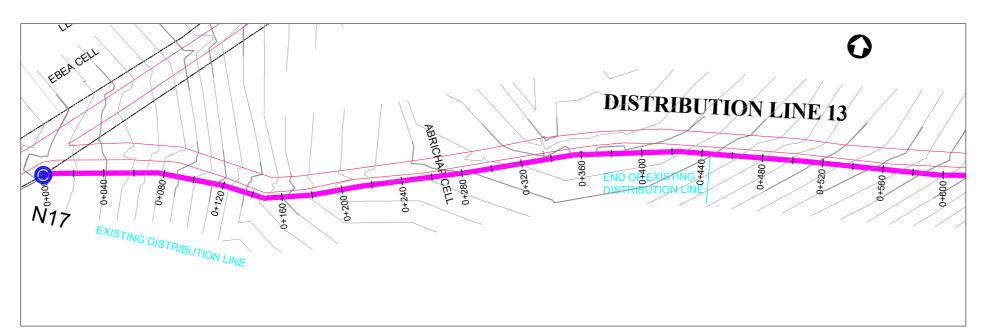

LONGITUDINAL PROFILE

ΑM	AMENDMENTS	
No	Date	Revision
1	7.28.2023	Draft Design

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Level Indicator SD 220 SD 116 Outfall Chamber SD 117 Thrust Blocks SD 118

LEGEND



Pipe beddings

Transmission Mains **Distribution Mains**

SD 121

Building/House

Contours

Road

Double Orifice Air Valve WO_2 Type 2 Washout

Node detail No. 101

Tree

CO-FINANCE BY

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GOVERNMENT OF UGANDA



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CONSTRUCTION OF GWERE RGC WATER **SUPPLY AND SANITATION SYSTEM**

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10 Philpot Lane, 1st Floor,


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Horizontal Scale: 1:250	Drawn:	P.S Eyamu
Date:	Checked:	O.R Daniel
Nov-2022	Approved:	O.R Daniel

ENGINEERING DESIGN DRAWING Drg No: MWE/GWE/4.13.1 Cad file No WSS<22_11>

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PLAN LAYOUT



LONGITUDINAL PROFILE

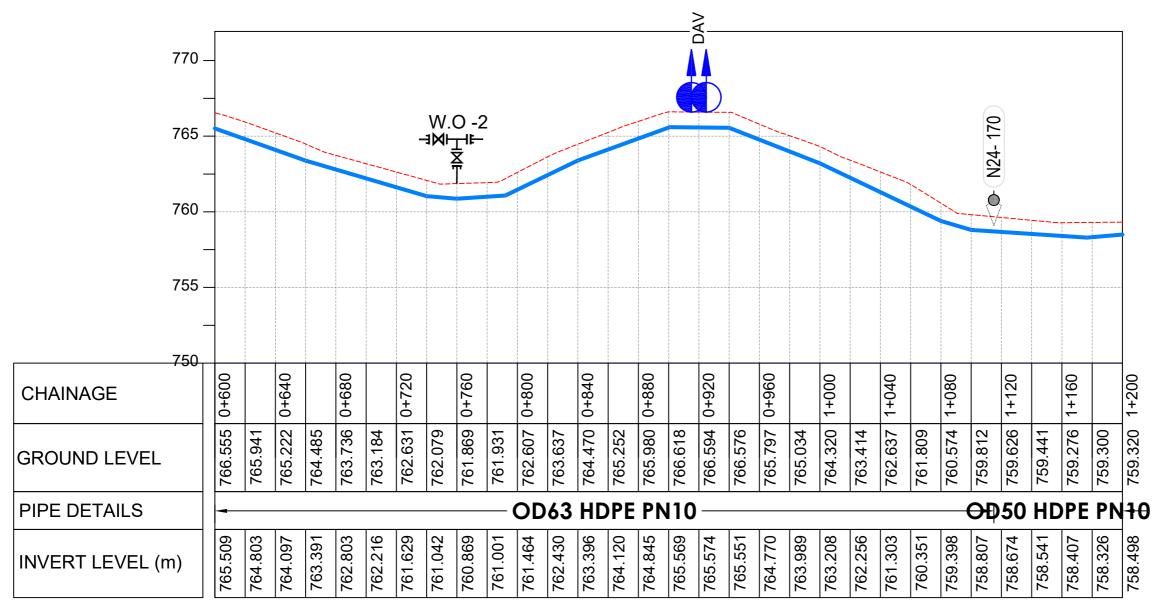AMENDMENTS		
No	Date	Revision
1	7.28.2023	Draft Design

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Pipe beddings SD 121

LEGEND



Transmission Mains

Distribution Mains Building/House

Contours

Road Tree

Double Orifice Air Valve WO_2 Type 2 Washout

Node detail No. 101

10



GOVERNMENT OF UGANDA



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- LOT 1 - MADI OKOLLO, TEREGO AND MOYO DISTRICTS -

CONSTRUCTION OF GWERE RGC WATER **SUPPLY AND SANITATION SYSTEM**

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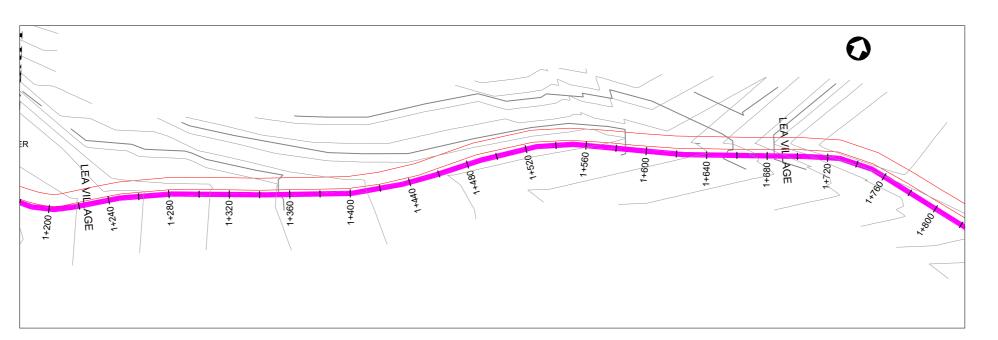



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Vertical Scale: 1:250 Horizontal Scale: 1:2500	Drawn:	P.S Eyamu
Date:	Checked:	O.R Daniel
Nov-2022	Approved:	O.R Daniel

ENGINEERING DESIGN DRAWING Drg No: MWE/GWE/4.13.2 Cad file No WSS<22_11>





AMENDMENTS No Date Revision 1 7.28.2023 Draft Design
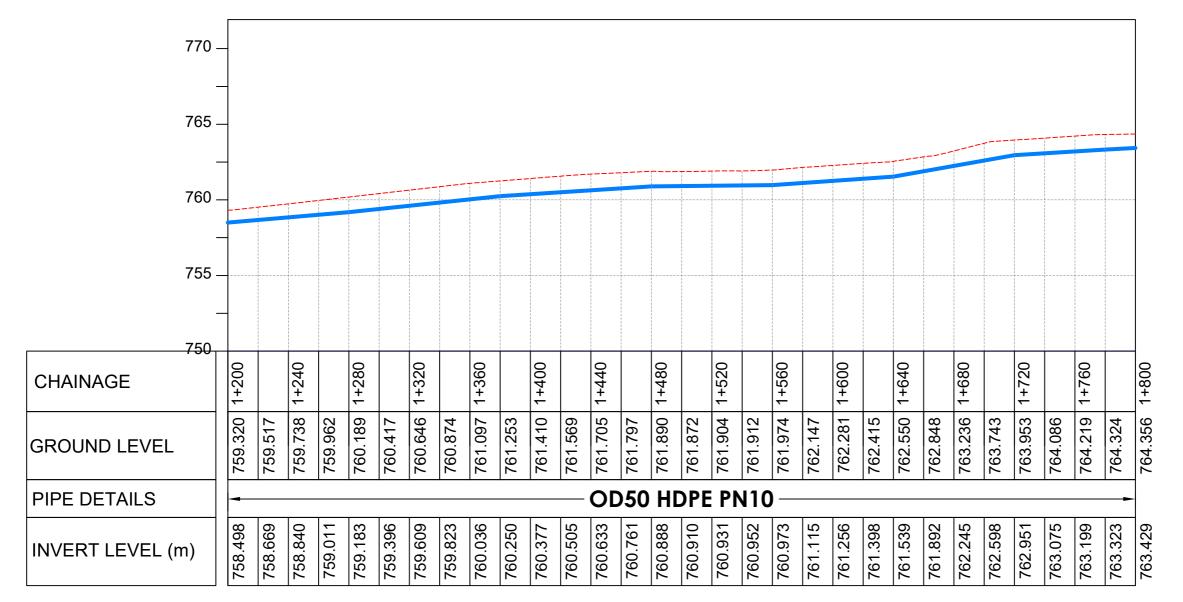
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LEGEND



Transmission Mains Distribution Mains

Building/House

Contours

Road Tree

Double Orifice Air Valve WO_2

Type 2 Washout Node detail No. 101

10



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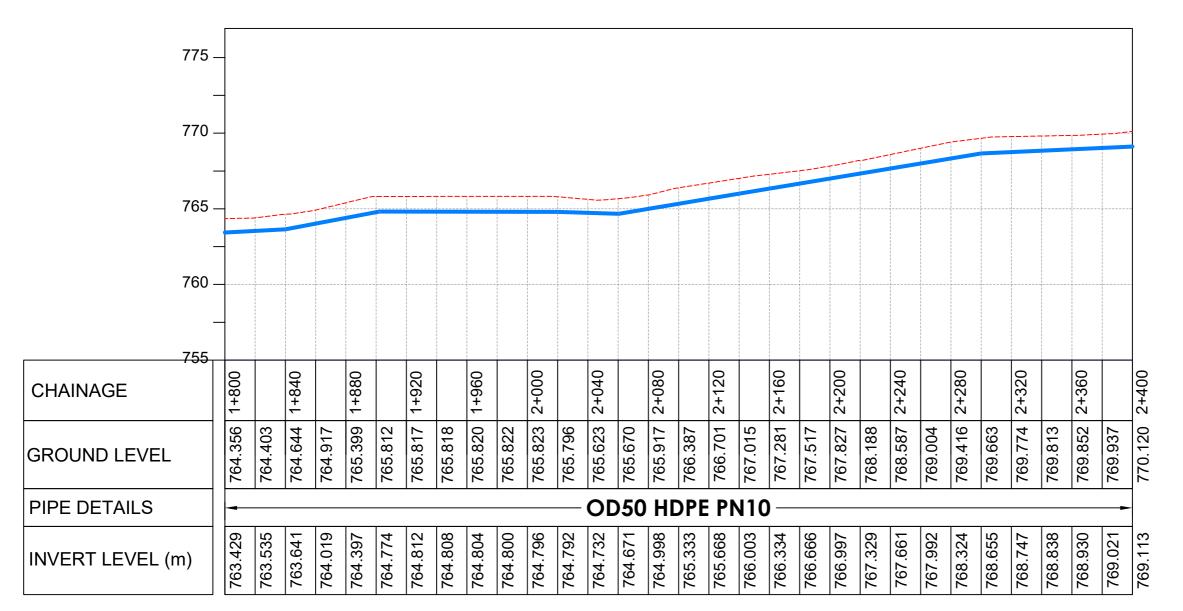
DISTRIBUTION LINE 13 Distribution Line 13 (CH 1+200.00 - 1+800.00)

Scale: Vertical Scale: 1:250	Designed:	O.R Daniel
Horizontal Scale: 1:250	Drawn:	P.S Eyamu
Date:	Checked:	O.R Daniel
Nov-2022	Approved:	O.R Daniel

ENGINEERING DESIGN DRAWING Drg No: MWE/GWE/4.13.3 Cad file No WSS<22_11>

LONGITUDINAL PROFILE





LONGITUDINAL PROFILE

AM	AMENDMENTS	
No	Date	Revision
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LEGEND



Transmission Mains

Distribution Mains Building/House

Contours

Road

Tree Double Orifice Air Valve

Type 2 Washout Node detail No. 101

CO-FINANCE BY

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WO_2





MINISTRY OF WATER AND ENVIRONMENT
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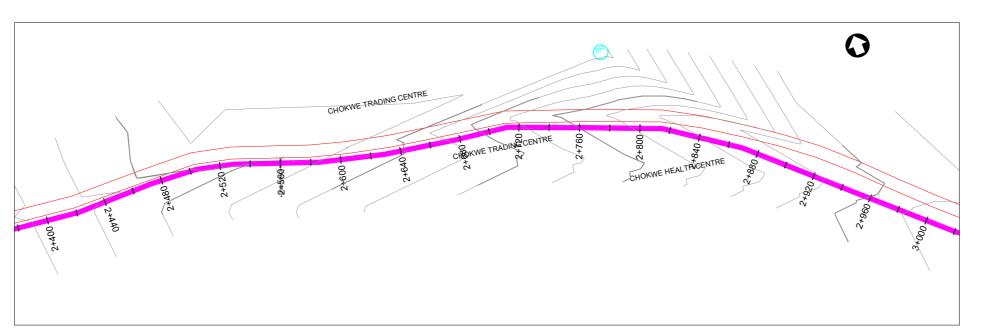
10 Philpot Lane, 1st Floor, London EC3M 8AA,


DISTRIBUTION LINE 13 Distribution Line 13 (CH 1+800.00 - 2+400.00)

Designed:	O.R Daniel
Drawn:	P.S Eyamu
Checked:	O.R Daniel
Approved:	O.R Daniel
	Drawn: Checked:

ENGINEERING DESIGN DRAWING

Drg No: MWE/GWE/4.13.4 Cad file No WSS<22_11>



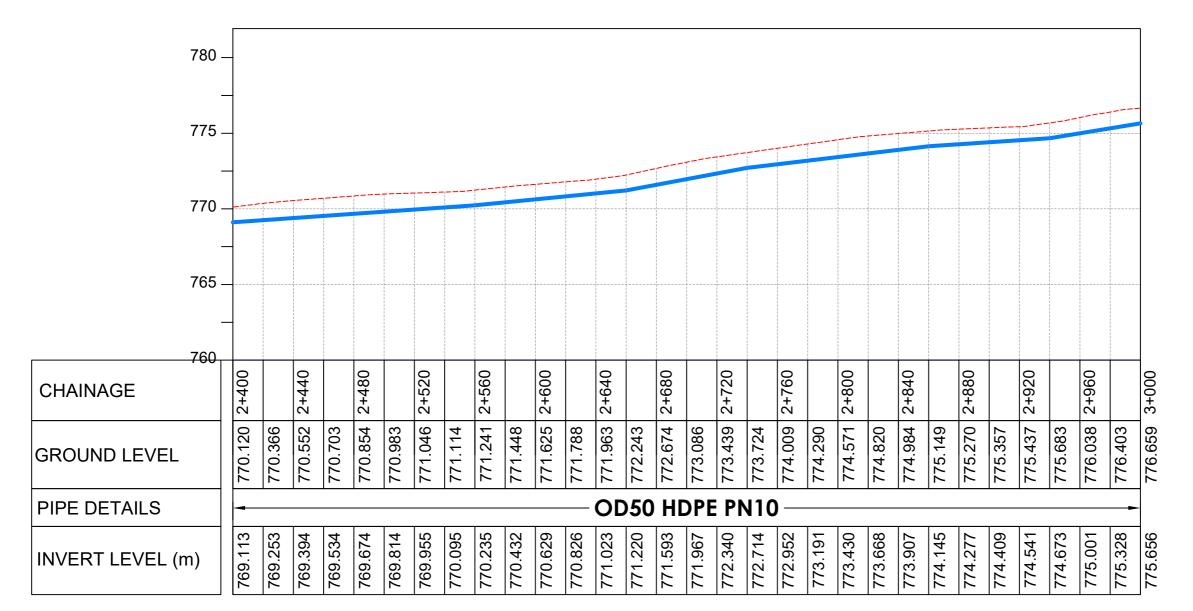

LONGITUDINAL PROFILE

AM	AMENDMENTS	
No	Date	Revision
1	7.28.2023	Draft Design

NOTES

- 1. All dimensions are in metres unless stated otherwise
- 2. All levels are in metres above sea level.
- 3. For Site location see Dwg. MWE/GWE/0.0.0
- 4. For Node details, see Dwg. MWE/GWE/5.0.0
- 6. For Standard details see sheets as follows

Level Indicator SD 220 SD 116 Outfall Chamber SD 117 Thrust Blocks SD 118 Pipe beddings SD 121

LEGEND



Transmission Mains

Distribution Mains

Building/House

Contours Road

Tree Double Orifice Air Valve WO_2

Type 2 Washout

10 Node detail No. 101



GOVERNMENT OF UGANDA



MINISTRY OF WATER AND ENVIRONMENT
DIRECTORATE OF WATER DEVELOPMENT (DWD)
RURAL WATER SUPPLY AND SANITATION DEPARTMENT
Plot 3 - 7 Kabalega Crescent Road, Luzira, Box 20026 Kampala
Tel: +256 417 889 400, Email: mwe@mwe.go.ug
Website: www.mwe.go.ug

Consultancy Services for the Feability Study, Detailed Engineering Design and Construction Supervision of Solar Powered Piped Water Supply Systems and Sanitation Facilities In Refugee Settlements and Host Districts In West Nile and Northern Uganda

- LOT 1 - MADI OKOLLO, TEREGO AND MOYO DISTRICTS -

CONSTRUCTION OF GWERE RGC WATER **SUPPLY AND SANITATION SYSTEM**

Consultant:




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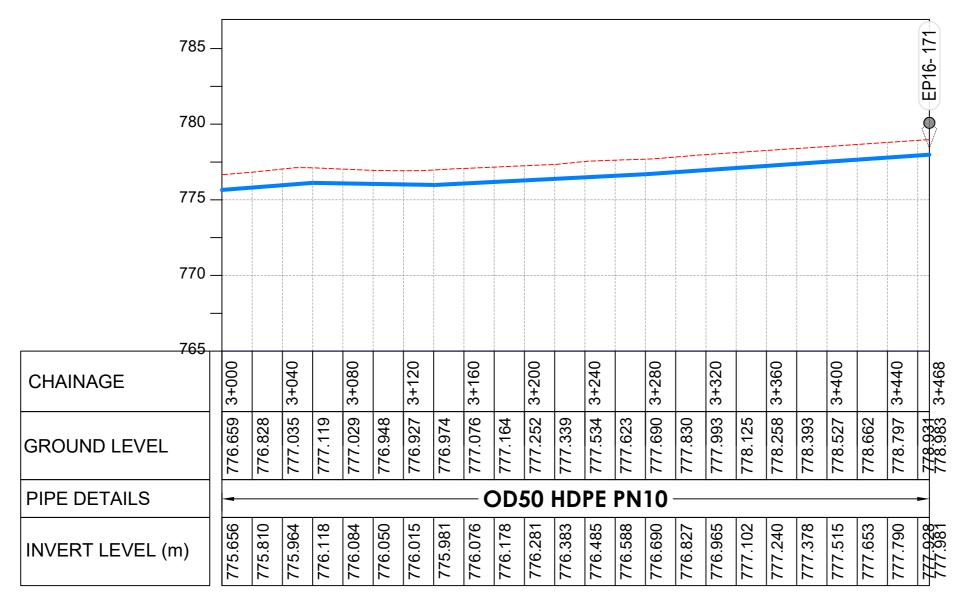
DISTRIBUTION LINE 13 Distribution Line 13 (CH 2+400.00 - 3+000.00)

Designed:	O.R Daniel
Drawn:	P.S Eyamu
Checked:	O.R Daniel
Approved:	O.R Daniel
	Drawn: Checked:

ENGINEERING DESIGN DRAWING

Drg No: MWE/GWE/4.13.5 Cad file No WSS<22_11>



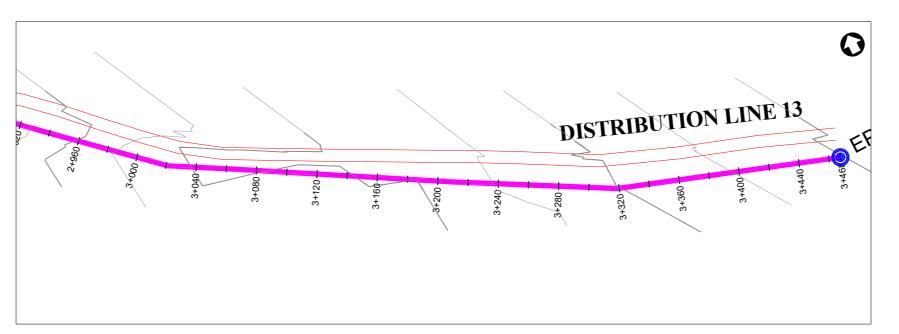

LONGITUDINAL PROFILE

AM	AMENDMENTS	
No	Date	Revision
1	7.28.2023	Draft Design

NOTES

- 1. All dimensions are in metres unless stated otherwise.
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- 3. For Site location see Dwg. MWE/GWE/0.0.0
- 4. For Node details, see Dwg. MWE/GWE/5.0.0
- All valves, hydrants and washout locations are identified by marker post in positions.
- 6. For Standard details see sheets as follows

Level Indicator SD 220
Outfall Chamber SD 116
Marker Post SD 117
Thrust Blocks SD 118
Pipe beddings SD 121

LEGEND



Transmission Mains

Distribution Mains Building/House

Co

Contours Road

Tree Double Orific

Double Orifice Air Valve

Type 2 Washout Node detail No. 101

CO-FINANCE BY:

DAV

WO_2



10

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GOVERNMENT OF UGANDA

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MINISTRY OF WATER AND ENVIRONMENT

DIRECTORATE OF WATER DEVELOPMENT (DWD)

RURAL WATER SUPPLY AND SANITATION DEPARTMENT

Plot 3 - 7 Kabalega Crescent Road, Luzira, Box 20026 Kampala

Tel: +256 417 889 400, Email: mwe@mwe.go.ug

Website: www.mwe.go.ug

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Consultancy Services for the Feability Study, Detailed Engineering Design and Construction Supervision of Solar Powered Piped Water Supply Systems and Sanitation Facilities In Refugee Settlements and Host Districts In West Nile and Northern Uganda

- LOT 1 - MADI OKOLLO, TEREGO AND MOYO DISTRICTS -

CONSTRUCTION OF GWERE RGC WATER SUPPLY AND SANITATION SYSTEM

Consultant:



Corporate Headquarte 10 Philpot Lane, 1st Floor, London EC3M 8AA,


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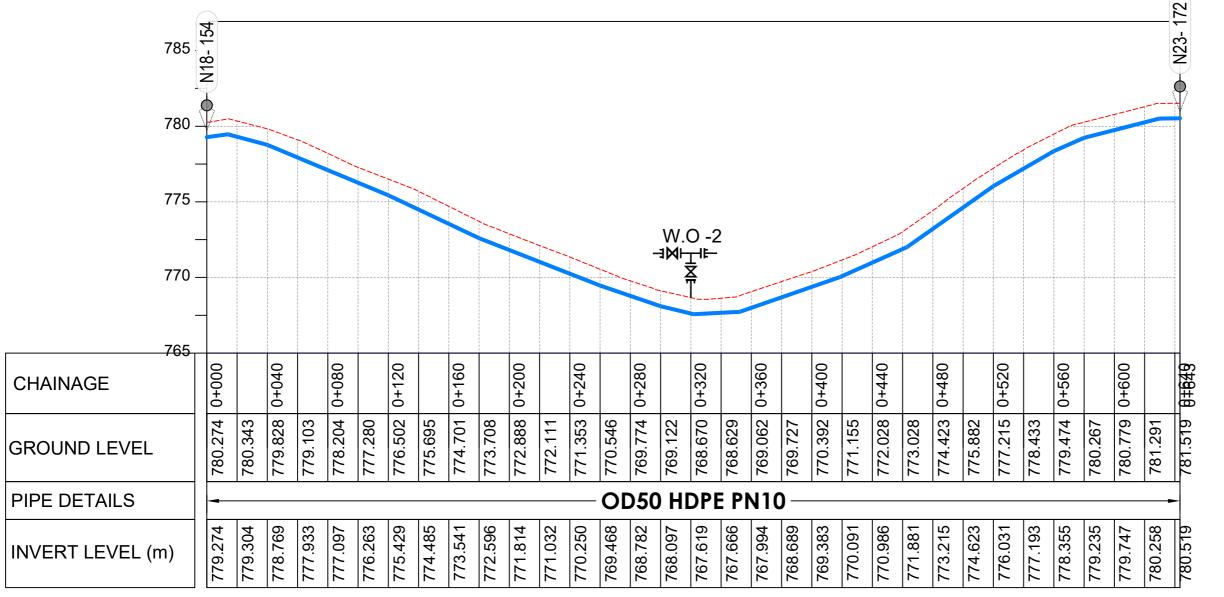
DISTRIBUTION LINE 13
Distribution Line 13 (CH 3+000.00 - 3+467.73)

Scale: Vertical Scale: 1:250	Designed:	O.R Daniel	
Horizontal Scale: 1:2500	Drawn:	P.S Eyamu	
Date:	Checked:	O.R Daniel	
Nov-2022	Approved:	O.R Daniel	

ENGINEERING DESIGN DRAWING

Drg No: MWE/GWE/4.13.6 Cad file No WSS<22_11>



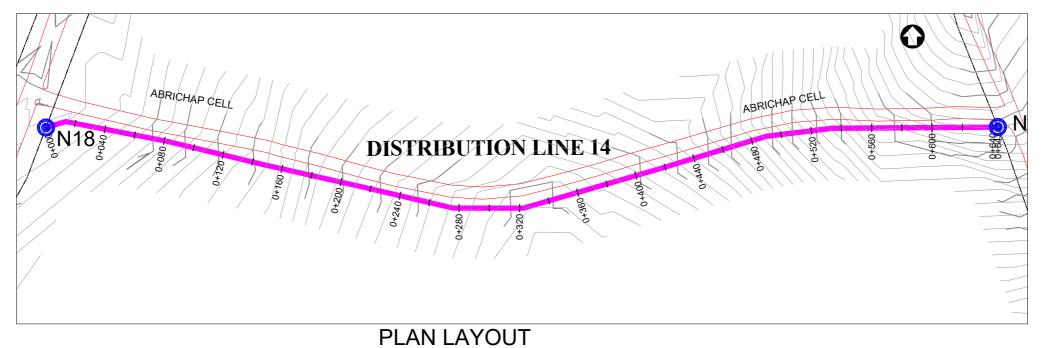

LONGITUDINAL PROFILE

AMENDMENTS No Date Revision 1 7.28.2023 Draft Design

NOTES

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- 4. For Node details, see Dwg. MWE/GWE/5.0.0
- 5. All valves, hydrants and washout locations are

SD 220 Level Indicator SD 116 Outfall Chamber SD 117 Thrust Blocks SD 118 Pipe beddings SD 121

LEGEND



Transmission Mains

Distribution Mains

Building/House

Contours Road

Tree

Double Orifice Air Valve WO_2

Type 2 Washout

Node detail No. 101



10

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MINISTRY OF WATER AND ENVIRONMENT
DIRECTORATE OF WATER DEVELOPMENT (DWD)
RURAL WATER SUPPLY AND SANITATION DEPARTMENT
Plot 3 - 7 Kabalega Crescent Road, Luzira, Box 20026 Kampala
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GOVERNMENT OF UGANDA

Consultancy Services for the Feability Study, Detailed Engineering Design and Construction Supervision of Solar Powered Piped Water Supply Systems and Sanitation Facilities In Refugee Settlements and Host Districts In West Nile and Northern Uganda

LOT 1 - MADI OKOLLO, TEREGO AND MOYO DISTRICTS

CONSTRUCTION OF GWERE RGC WATER **SUPPLY AND SANITATION SYSTEM**

Consultant:





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Scale:	Designed:	O.R Daniel		
Vertical Scale: 1:250 Horizontal Scale: 1:2500	Drawn:	P.S Eyamu		
Date:	Checked:	O.R Daniel		
Nov-2022	Approved:	O.R Daniel		


ENGINEERING DESIGN DRAWING

Drg No: MWE/GWE/4.14.1 Cad file No WSS<22_11>



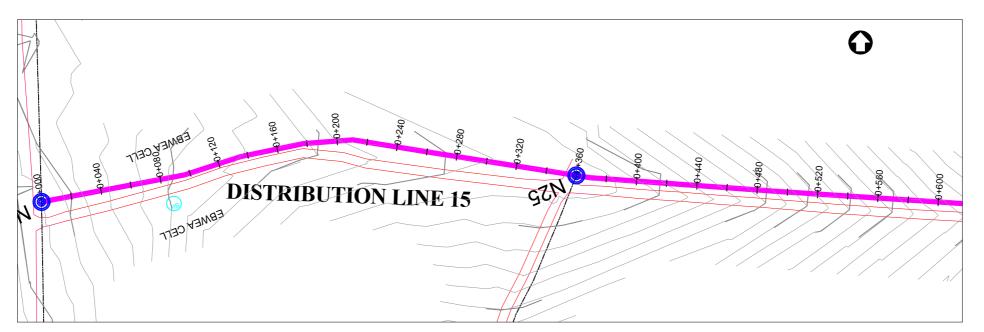

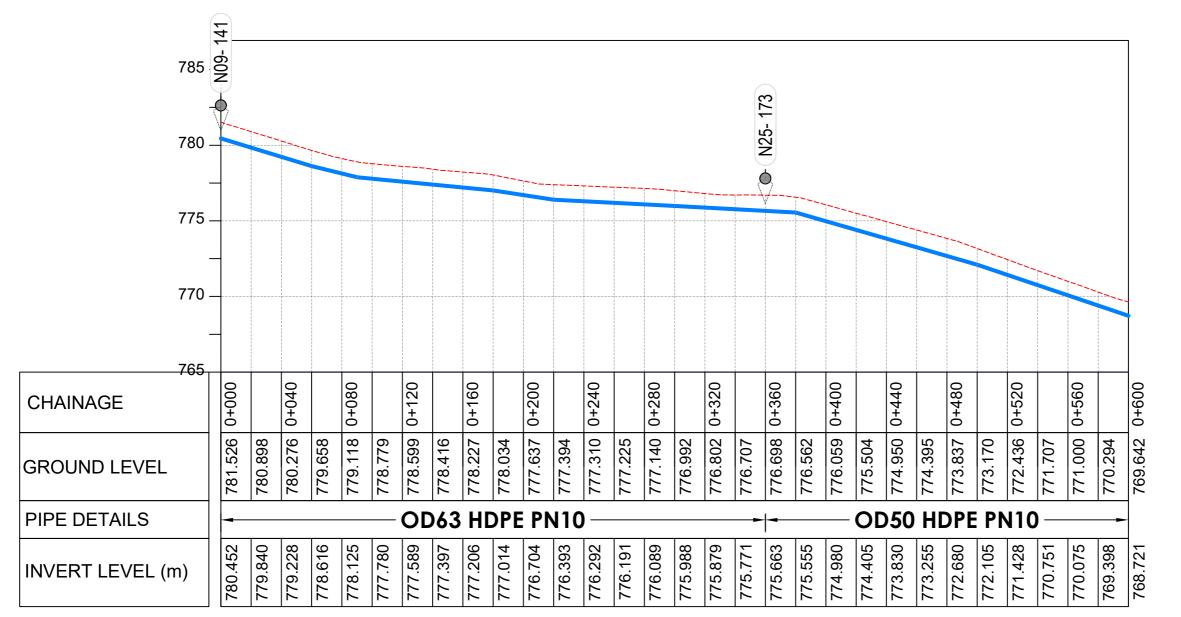LONGITUDINAL PROFILE

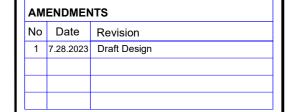

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- 3. For Site location see Dwg. MWE/GWE/0.0.0
- 4. For Node details, see Dwg. MWE/GWE/5.0.0 5. All valves, hydrants and washout locations are

Level Indicator SD 220 SD 116 Outfall Chamber SD 117 Thrust Blocks SD 118

LEGEND



Pipe beddings

Transmission Mains **Distribution Mains**

SD 121

Building/House

Contours

Road

Double Orifice Air Valve WO_2

Type 2 Washout

Tree

10 Node detail No. 101

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DIRECTORATE OF WATER DEVELOPMENT (DWD)

RURAL WATER SUPPLY AND SANITATION DEPARTMENT

Plot 3 - 7 Kabalega Crescent Road, Luzira, Box 20026 Kampala

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- LOT 1 - MADI OKOLLO, TEREGO AND MOYO DISTRICTS

CONSTRUCTION OF GWERE RGC WATER **SUPPLY AND SANITATION SYSTEM**

Consultant:




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DISTRIBUTION LINE 15 Distribution Line 15 (CH 0+000.00 - 0+600.00)


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Horizontal Scale: 1:2500	Drawn:	P.S Eyamu
Date:	Checked:	O.R Daniel
Nov-2022	Approved:	O.R Daniel

ENGINEERING DESIGN DRAWING

Drg No: MWE/GWE/4.15.1 Cad file No WSS<22_11>

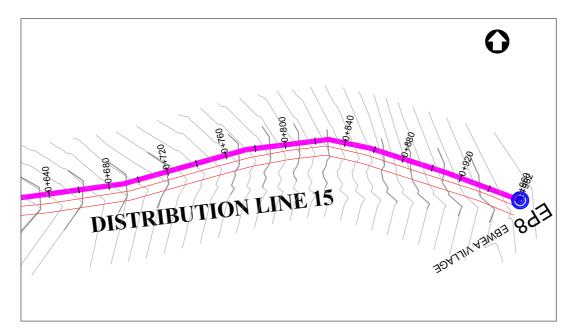

PLAN LAYOUT

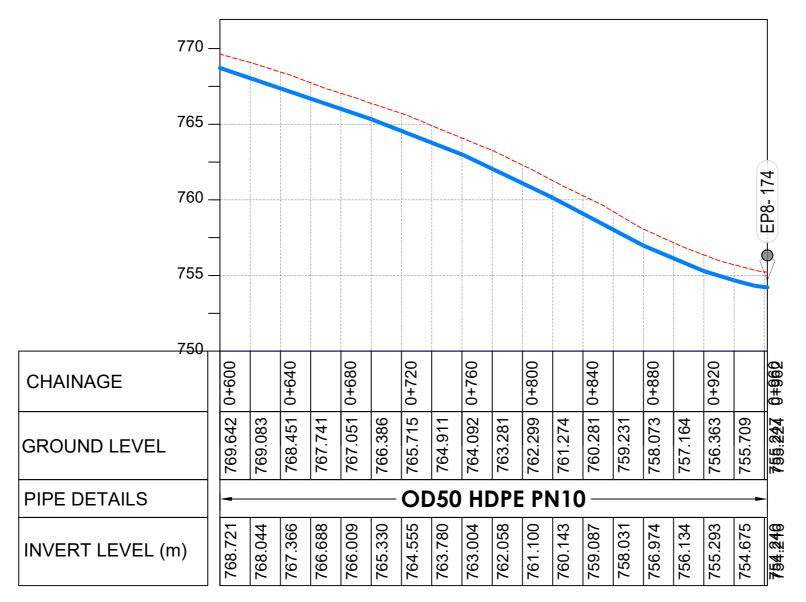

LONGITUDINAL PROFILE

AM	AMENDMENTS		
No	Date	Revision	
1	7.28.2023	Draft Design	

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- 4. For Node details, see Dwg. MWE/GWE/5.0.0
- 5. All valves, hydrants and washout locations are
- 6. For Standard details see sheets as follows

Level Indicator SD 220 SD 116 Outfall Chamber SD 117 Thrust Blocks SD 118 SD 121 Pipe beddings

LEGEND



Transmission Mains

Distribution Mains

Building/House Contours

Road Tree

DAV Double Orifice Air Valve WO_2 Type 2 Washout

10



THE WORLD BANK AND

Node detail No. 101

GOVERNMENT OF UGANDA

MINISTRY OF WATER AND ENVIRONMENT
DIRECTORATE OF WATER DEVELOPMENT (DWD)
RURAL WATER SUPPLY AND SANITATION DEPARTMENT
Plot 3 - 7 Kabalega Crescent Road, Luzira, Box 20026 Kampala
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Consultancy Services for the Feability Study, Detailed Engineering Design and Construction Supervision of Solar Powered Piped Water Supply Systems and Sanitation Facilities In Refugee Settlements and Host Districts In West Nile and Northern Uganda

- LOT 1 - MADI OKOLLO, TEREGO AND MOYO DISTRICTS -

CONSTRUCTION OF GWERE RGC WATER SUPPLY AND SANITATION SYSTEM

Consultant:





10 Philpot Lane, 1st Floor,

DISTRIBUTION LINE 15 Distribution Line 15 (CH 0+600.00 - 0+961.96)

Scale:	Designed:	O.R Daniel
Vertical Scale: 1:250 Horizontal Scale: 1:2500	Drawn:	P.S Eyamu
Date:	Checked:	O.R Daniel
Nov-2022	Approved:	O.R Daniel

ENGINEERING DESIGN DRAWING Drg No: MWE/GWE/4.15.2 Cad file No WSS<22_11>

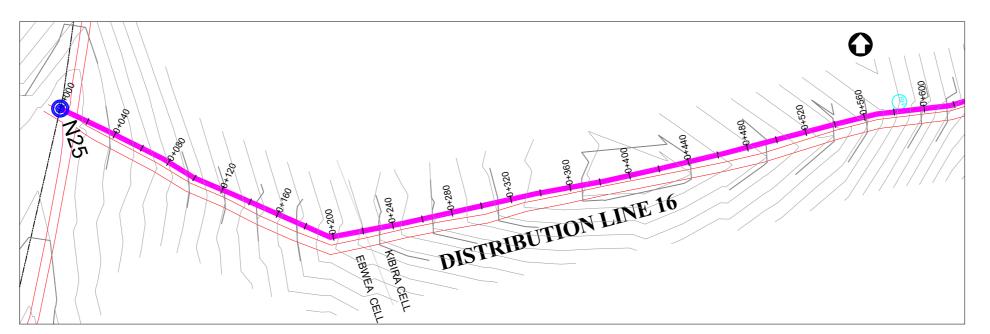

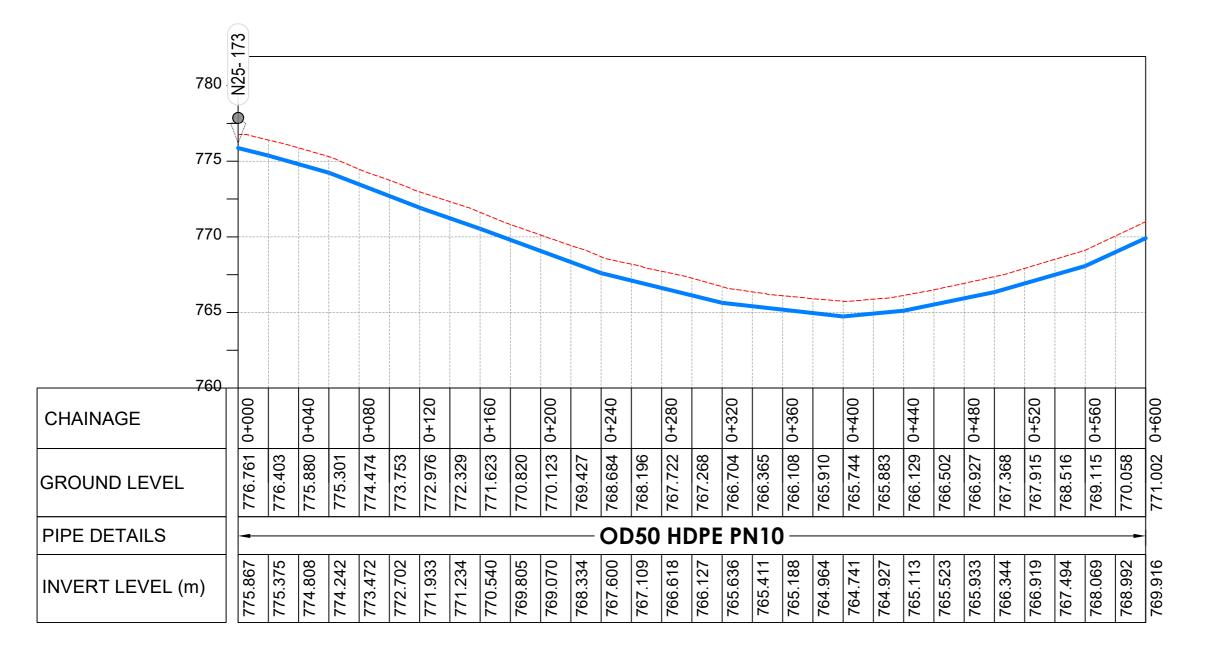

LONGITUDINAL PROFILE

A۱	AMENDMENTS		
No	Date	Revision	
1	7.30.2023	Draft Design	

NOTES

- 1. All dimensions are in metres unless stated otherwise.
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- 3. For Site location see Dwg. MWE/GWE/0.0.0
- 4. For Node details, see Dwg. MWE/GWE/5.0.0
- 5. All valves, hydrants and washout locations are
- 6. For Standard details see sheets as follows

Level Indicator SD 220 SD 116 Outfall Chamber SD 117 Thrust Blocks SD 118 Pipe beddings SD 121

LEGEND



Transmission Mains

Distribution Mains Building/House

Contours

Road Tree

Double Orifice Air Valve Type 2 Washout

Node detail No. 101

WO_2

10



GOVERNMENT OF UGANDA



MINISTRY OF WATER AND ENVIRONMENT
DIRECTORATE OF WATER DEVELOPMENT (DWD)
RURAL WATER SUPPLY AND SANITATION DEPARTMENT
Plot 3 - 7 Kabalega Crescent Road, Luzira, Box 20026 Kampala
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- LOT 1 - MADI OKOLLO, TEREGO AND MOYO DISTRICTS -

CONSTRUCTION OF GWERE RGC WATER **SUPPLY AND SANITATION SYSTEM**

Consultant:



10 Philpot Lane, 1st Floor,


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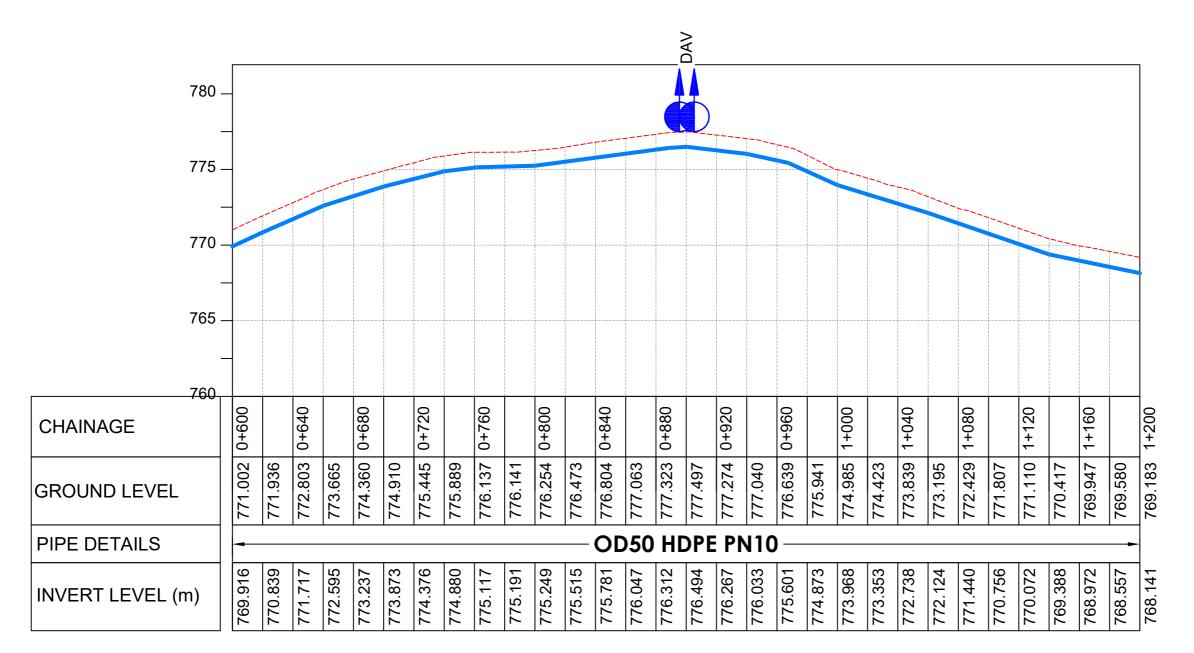
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Scale: Vertical Scale: 1:250	Designed:	O.R Daniel
Horizontal Scale: 1:2500	Drawn:	P.S Eyamu
Date:	Checked:	O.R Daniel
Nov-2022	Approved:	O.R Daniel

ENGINEERING DESIGN DRAWING

Drg No: MWE/GWE/4.16.1 Cad file No WSS<22_11>



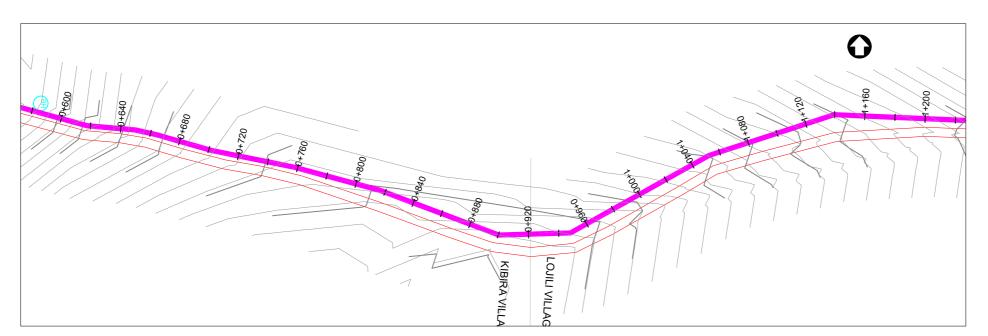

LONGITUDINAL PROFILE

ΑM	AMENDMENTS		
No	Date	Revision	
1	7.30.2023	Draft Design	

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- 3. For Site location see Dwg. MWE/GWE/0.0.0
- 4. For Node details, see Dwg. MWE/GWE/5.0.0
- 5. All valves, hydrants and washout locations are
- 6. For Standard details see sheets as follows

SD 220 Level Indicator SD 116 Outfall Chamber SD 117 Thrust Blocks SD 118 Pipe beddings SD 121

LEGEND



Transmission Mains Distribution Mains

Building/House

Contours Road

Double Orifice Air Valve WO_2

Type 2 Washout

Tree

10 Node detail No. 101

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MINISTRY OF WATER AND ENVIRONMENT
DIRECTORATE OF WATER DEVELOPMENT (DWD)
RURAL WATER SUPPLY AND SANITATION DEPARTMENT
Plot 3 - 7 Kabalega Crescent Road, Luzira, Box 20026 Kampala
Tel: +256 417 889 400, Email: mwe@mwe.go.ug
Website: www.mwe.go.ug

Consultancy Services for the Feability Study, Detailed Engineering Design and Construction Supervision of Solar Powered Piped Water Supply Systems and Sanitation Facilities In Refugee Settlements and Host Districts In West Nile and Northern Uganda

- LOT 1 - MADI OKOLLO, TEREGO AND MOYO DISTRICTS -

CONSTRUCTION OF GWERE RGC WATER **SUPPLY AND SANITATION SYSTEM**

Consultant:



10 Philpot Lane, 1st Floor,


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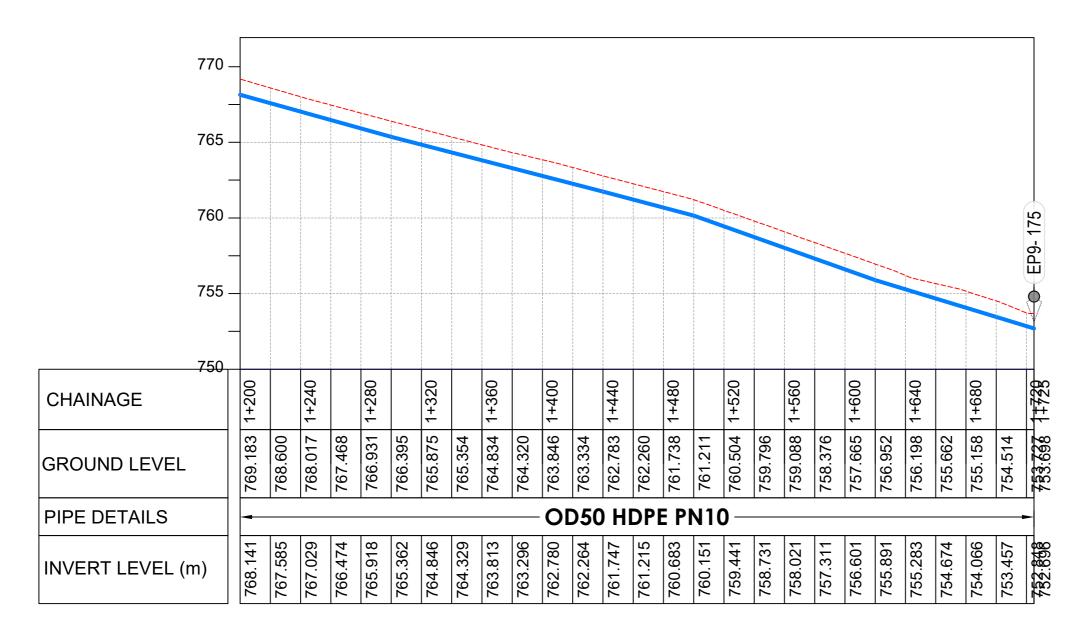
DISTRIBUTION LINE 16 Distribution Line 16 (CH 0+600.00 - 1+200.00)

Scale: Vertical Scale: 1:250	Designed:	O.R Daniel		
Horizontal Scale: 1:2500	Drawn:	P.S Eyamu		
Date:	Checked:	O.R Daniel		
Nov-2022	Approved:	O.R Daniel		

ENGINEERING DESIGN DRAWING

Drg No: MWE/GWE/4.16.2 Cad file No WSS<22_11>



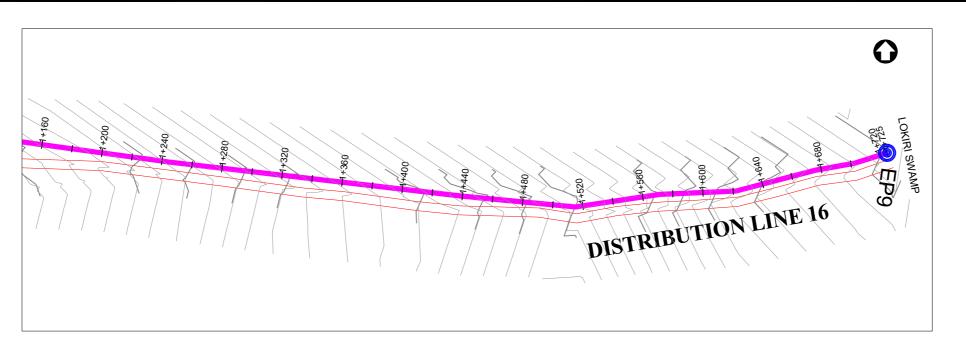

LONGITUDINAL PROFILE

AM	AMENDMENTS		
No	Date	Revision	
1	7.30.2023	Draft Design	

NOTES

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- 4. For Node details, see Dwg. MWE/GWE/5.0.0
- 6. For Standard details see sheets as follows

Level Indicator SD 220 SD 116 Outfall Chamber SD 117 Thrust Blocks SD 118 Pipe beddings SD 121

LEGEND



Transmission Mains

Distribution Mains

Building/House

Contours Road

Tree Double Orifice Air Valve

WO_2 Type 2 Washout Node detail No. 101

CO-FINANCE BY

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GOVERNMENT OF UGANDA



DIRECTORATE OF WATER DEVELOPMENT (DWD)

RURAL WATER SUPPLY AND SANITATION DEPARTMENT

Plot 3 - 7 Kabalega Crescent Road, Luzira, Box 20026 Kampala

Tel: +256 417 889 400, Email: mwe@mwe.go.ug

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Consultancy Services for the Feability Study, Detailed Engineering Design and Construction Supervision of Solar Powered Piped Water Supply Systems and Sanitation Facilities In Refugee Settlements and Host Districts In West Nile and Northern Uganda

- LOT 1 - MADI OKOLLO, TEREGO AND MOYO DISTRICTS -

CONSTRUCTION OF GWERE RGC WATER **SUPPLY AND SANITATION SYSTEM**

Consultant:



10 Philpot Lane, 1st Floor,


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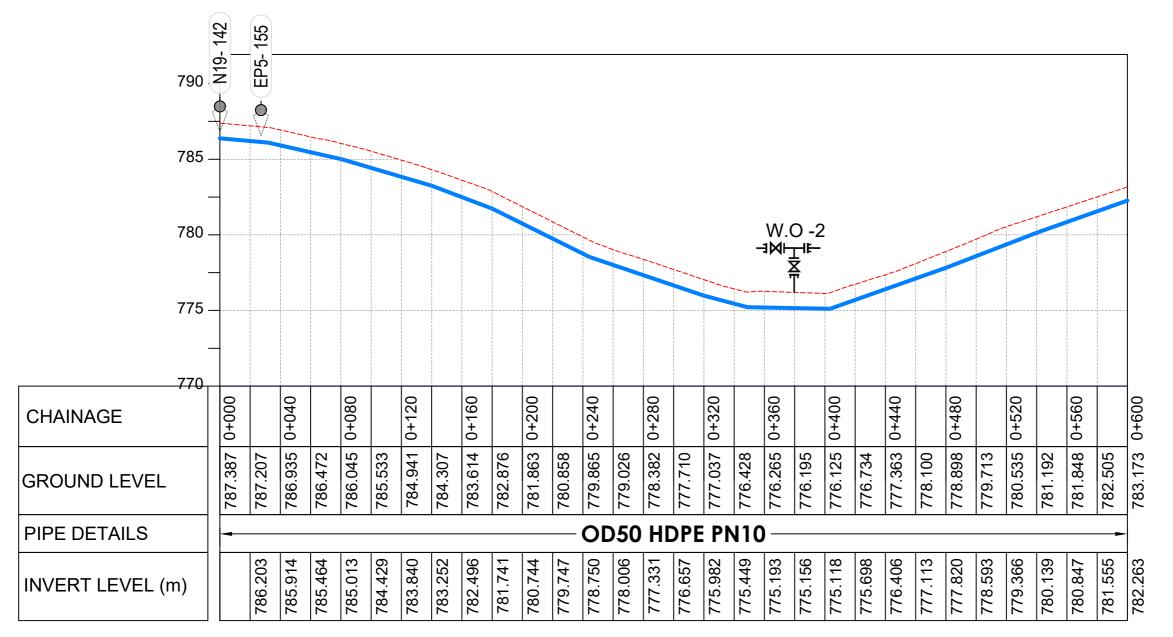
DISTRIBUTION LINE 16 Distribution Line 16 (CH 1+200.00 - 1+725.00)

Scale: Vertical Scale: 1:250	Designed:	O.R Daniel		
Horizontal Scale: 1:2500	Drawn:	P.S Eyamu		
Date:	Checked:	O.R Daniel		
Nov-2022	Approved:	O.R Daniel		
ENCINEEDING DECICAL DRAWING				

ENGINEERING DESIGN DRAWING

Drg No: MWE/GWE/4.16.3 Cad file No WSS<22_11>



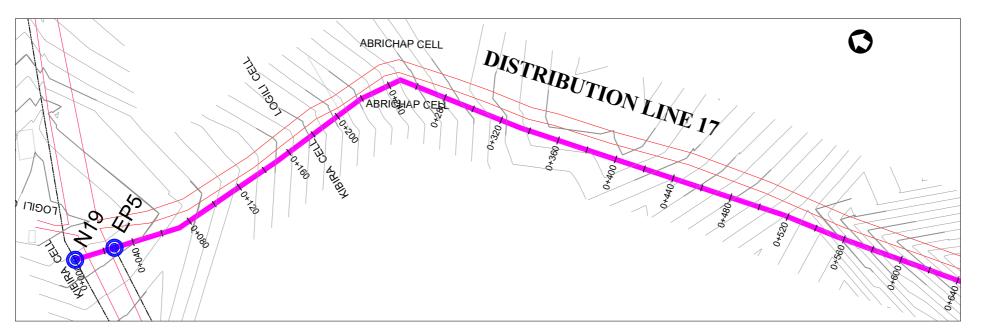

LONGITUDINAL PROFILE

AM	MENDMENTS		
No	Date	Revision	
1	7.28.2023	Draft Design	

NOTES

- 1. All dimensions are in metres unless stated otherwise.
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- 3. For Site location see Dwg. MWE/GWE/0.0.0
- 4. For Node details, see Dwg. MWE/GWE/5.0.0
- 5. All valves, hydrants and washout locations are

Level Indicator SD 220 SD 116 Outfall Chamber SD 117

Thrust Blocks SD 118 Pipe beddings SD 121

LEGEND



Transmission Mains **Distribution Mains**

Building/House

Contours Road

Tree WO_2

Double Orifice Air Valve Type 2 Washout

Node detail No. 101

CO-FINANCE BY

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MINISTRY OF WATER AND ENVIRONMENT
DIRECTORATE OF WATER DEVELOPMENT (DWD)
RURAL WATER SUPPLY AND SANITATION DEPARTMENT
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- LOT 1 - MADI OKOLLO, TEREGO AND MOYO DISTRICTS

CONSTRUCTION OF GWERE RGC WATER **SUPPLY AND SANITATION SYSTEM**

Consultant:



10 Philpot Lane, 1st Floor,


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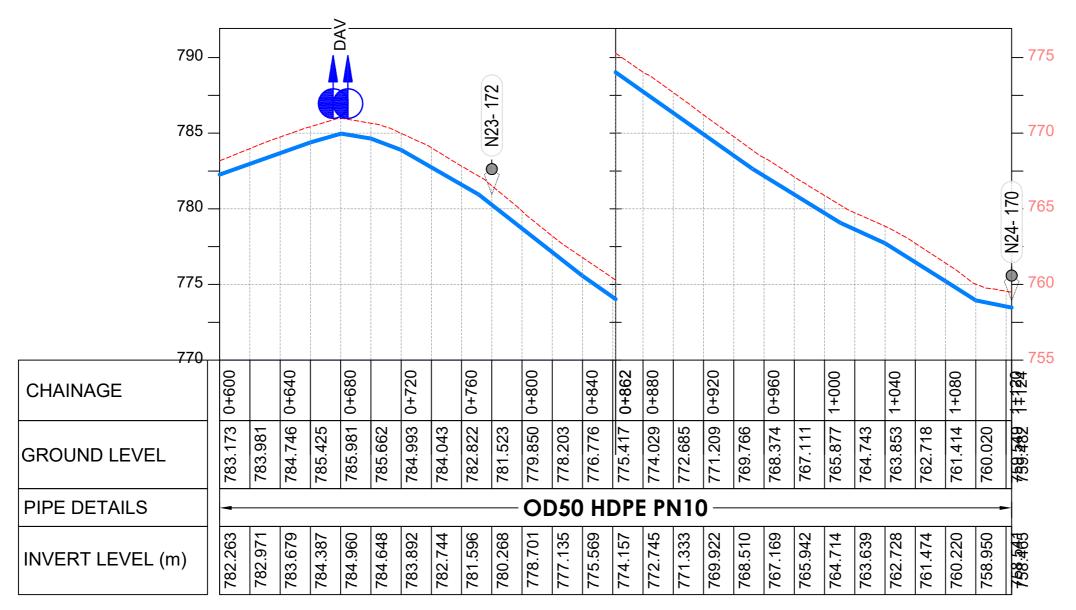
DISTRIBUTION LINE 17 Distribution Line 17 (CH 0+000.00 - 0+600.00)

Scale: Vertical Scale: 1:250	Designed:	O.R Daniel
Horizontal Scale: 1:2500	Drawn:	P.S Eyamu
Date:	Checked:	O.R Daniel
Nov-2022	Approved:	O.R Daniel

ENGINEERING DESIGN DRAWING

Drg No: MWE/GWE/4.17.1 Cad file No WSS<22_11>



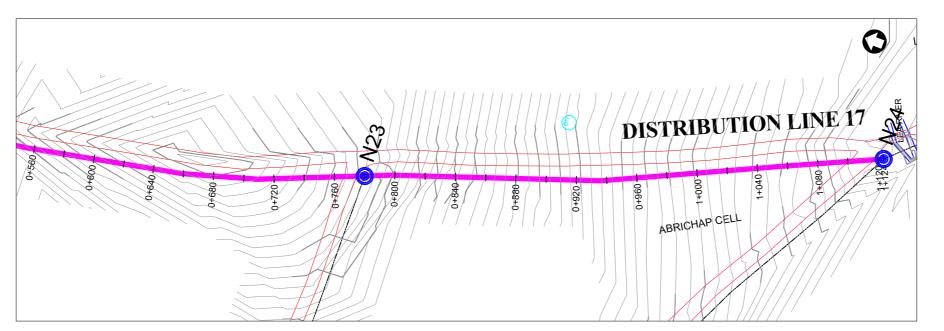

LONGITUDINAL PROFILE

1	AMENDMENTS		
1	No	Date	Revision
	1	7.28.2023	Draft Design

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- 4. For Node details, see Dwg. MWE/GWE/5.0.0
- 5. All valves, hydrants and washout locations are
- 6. For Standard details see sheets as follows

Level Indicator SD 220 SD 116 Outfall Chamber SD 117 Thrust Blocks SD 118 Pipe beddings SD 121

LEGEND



Transmission Mains

Distribution Mains

Building/House

Contours Road

Tree DAV Double Orifice Air Valve WO_2 Type 2 Washout

Node detail No. 101

CO-FINANCE BY

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GOVERNMENT OF UGANDA

MINISTRY OF WATER AND ENVIRONMENT
DIRECTORATE OF WATER DEVELOPMENT (DWD)
RURAL WATER SUPPLY AND SANITATION DEPARTMENT
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- LOT 1 - MADI OKOLLO, TEREGO AND MOYO DISTRICTS -

CONSTRUCTION OF GWERE RGC WATER **SUPPLY AND SANITATION SYSTEM**

Consultant:



10 Philpot Lane, 1st Floor, London EC3M 8AA,


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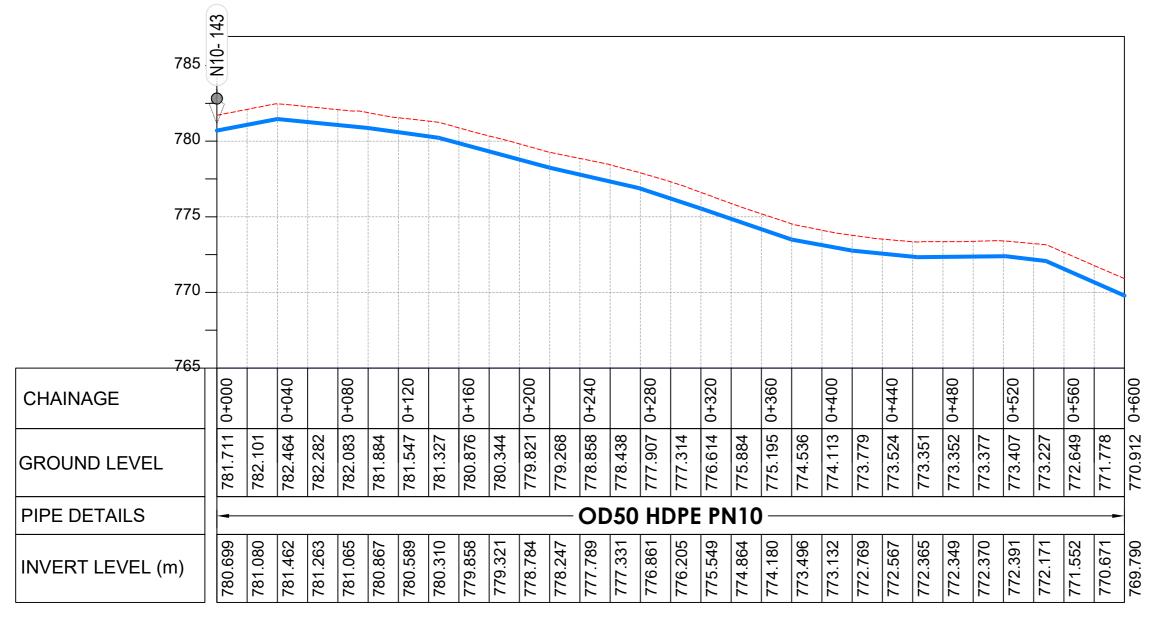
DISTRIBUTION LINE 17 Distribution Line 17 (CH 0+600.00 - 1+123.70)

Designed:	O.R Daniel
Drawn:	P.S Eyamu
Checked:	O.R Daniel
Approved:	O.R Daniel
	Drawn: Checked:

ENGINEERING DESIGN DRAWING

Drg No: MWE/GWE/4.17.2 Cad file No WSS<22_11>



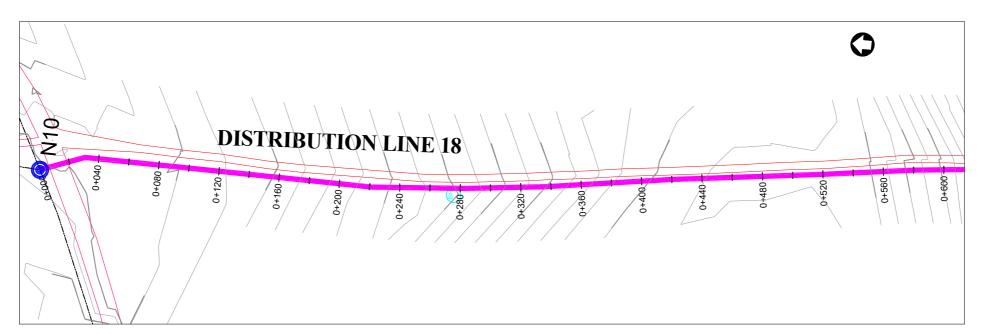

LONGITUDINAL PROFILE

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Level Indicator SD 220 SD 116 Outfall Chamber SD 117 Thrust Blocks SD 118 Pipe beddings SD 121

LEGEND



Transmission Mains

Distribution Mains Building/House

Contours

Road Tree

Double Orifice Air Valve WO_2 Type 2 Washout

10 Node detail No. 101

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Consultant:




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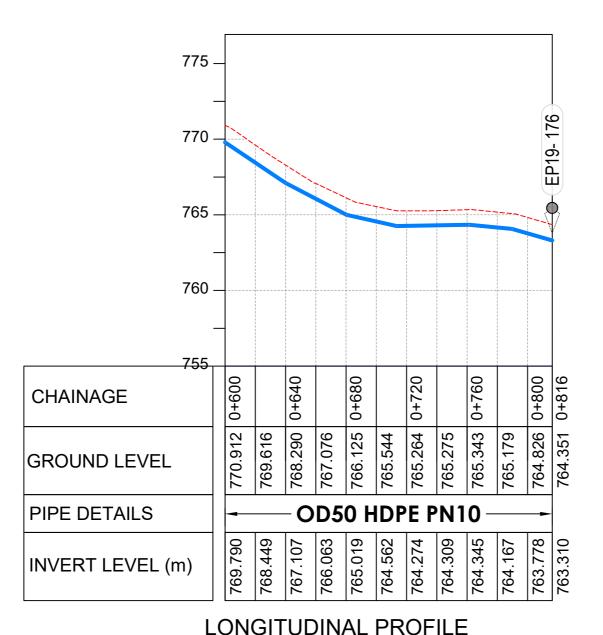
DISTRIBUTION LINE 18 Distribution Line 18 (CH 0+000.00 - 0+600.00)

Scale: Vertical Scale: 1:250	Designed:	O.R Daniel			
Horizontal Scale: 1:2500	Drawn:	P.S Eyamu			
Date:	Checked:	O.R Daniel			
Nov-2022	Approved:	O.R Daniel			

ENGINEERING DESIGN DRAWING

Drg No: MWE/GWE/4.18.1 Cad file No WSS<22_11>



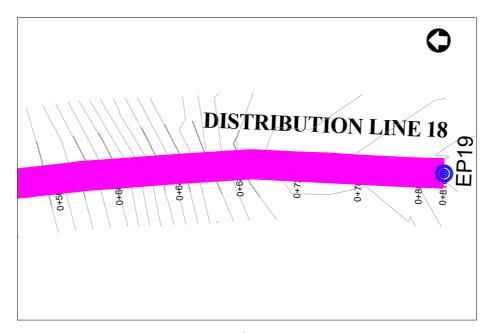

AMENDMENTS No Date Revision 1 7.28.2023 Draft Design

NOTES

- 1. All dimensions are in metres unless stated otherwise.
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- 3. For Site location see Dwg. MWE/GWE/0.0.0
- 4. For Node details, see Dwg. MWE/GWE/5.0.0 5. All valves, hydrants and washout locations are
- identified by marker post in positions 6. For Standard details see sheets as follows

SD 220 Level Indicator Outfall Chamber SD 116 Marker Post SD 117 Thrust Blocks SD 118

SD 121 Pipe beddings

LEGEND



Transmission Mains

Distribution Mains Building/House

Contours Road

Tree

Double Orifice Air Valve

Type 2 Washout Node detail No. 101

CO-FINANCE BY

10

DAV

WO_2



THE WORLD BANK AND

GOVERNMENT OF UGANDA



MINISTRY OF WATER AND ENVIRONMENT
DIRECTORATE OF WATER DEVELOPMENT (DWD)
RURAL WATER SUPPLY AND SANITATION DEPARTMENT
Plot 3 - 7 Kabalega Crescent Road, Luzira, Box 20026 Kampala
Tel: +256 417 889 400, Email: mwe@mwe.go.ug
Website: www.mwe.go.ug

Consultancy Services for the Feability Study, Detailed Engineering Design and Construction Supervision of Solar Powered Piped Water Supply Systems and Sanitation Facilities In Refugee Settlements and Host Districts In West Nile and Northern Uganda

- LOT 1 - MADI OKOLLO, TEREGO AND MOYO DISTRICTS -

CONSTRUCTION OF GWERE RGC WATER SUPPLY AND SANITATION SYSTEM

Consultant:



10 Philpot Lane, 1st Floor,


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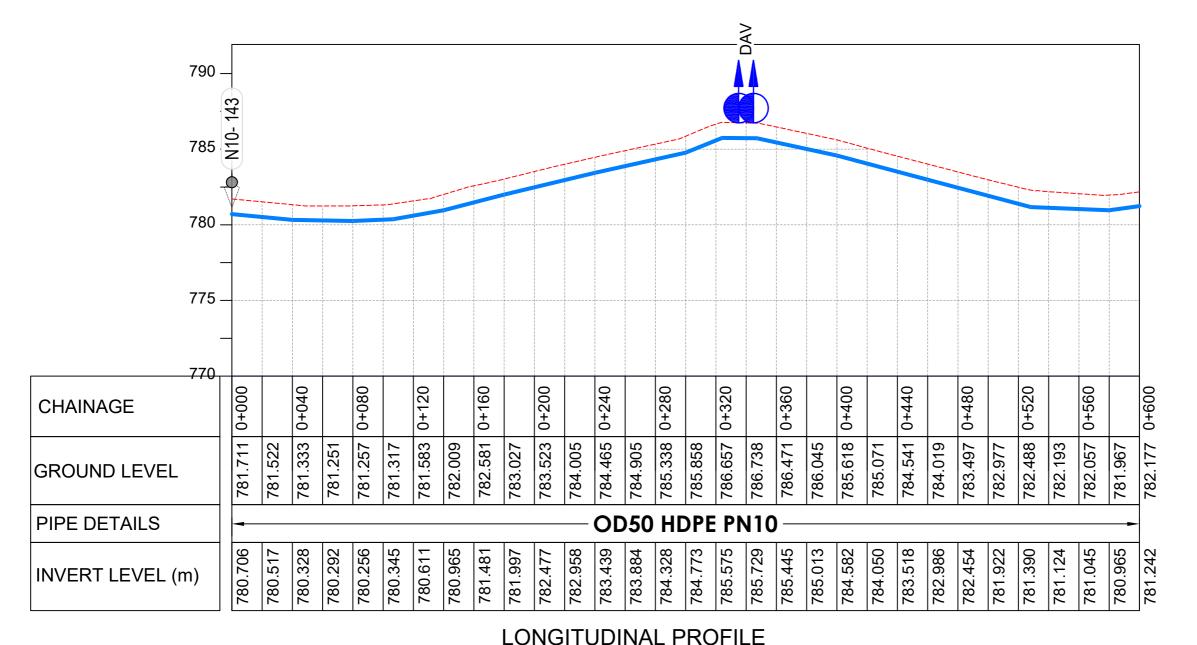
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Horizontal Scale: 1:2500	Drawn:	P.S Eyamu
Date:	Checked:	O.R Daniel
Nov-2022	Approved:	O.R Daniel

ENGINEERING DESIGN DRAWING

Drg No: MWE/GWE/4.18.2 Cad file No WSS<22_11>



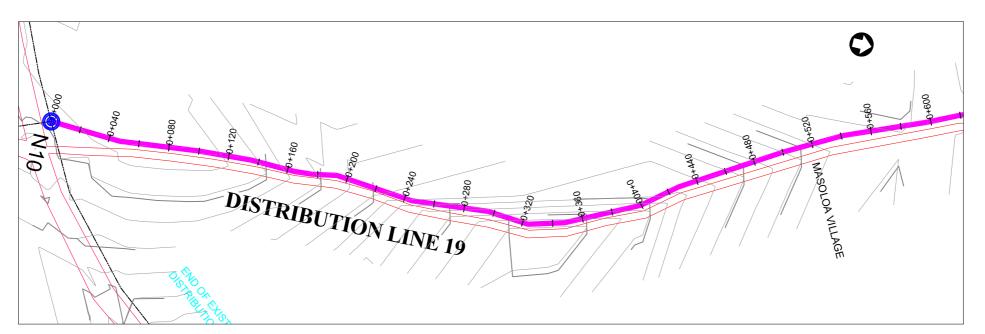

AMENDMENTS No Date Revision 1 7.28.2023 Draft Design

NOTES

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- 4. For Node details, see Dwg. MWE/GWE/5.0.0
- 5. All valves, hydrants and washout locations are
- 6. For Standard details see sheets as follows

Level Indicator SD 220 SD 116 Outfall Chamber SD 117 Thrust Blocks

SD 118 Pipe beddings SD 121

LEGEND



Transmission Mains

Distribution Mains Building/House

Contours

Road

Double Orifice Air Valve WO_2 Type 2 Washout

Node detail No. 101

Tree

CO-FINANCE BY

10



THE WORLD BANK AND

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MINISTRY OF WATER AND ENVIRONMENT
DIRECTORATE OF WATER DEVELOPMENT (DWD)
RURAL WATER SUPPLY AND SANITATION DEPARTMENT
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- LOT 1 - MADI OKOLLO, TEREGO AND MOYO DISTRICTS

CONSTRUCTION OF GWERE RGC WATER **SUPPLY AND SANITATION SYSTEM**

Consultant:




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DISTRIBUTION LINE 19 Distribution Line 19 (CH 0+000.00 - 0+600.00)


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Vertical Scale: 1:250 Horizontal Scale: 1:2500	Drawn:	P.S Eyamu			
Date:	Checked:	O.R Daniel			
Nov-2022	Approved:	O.R Daniel			

ENGINEERING DESIGN DRAWING

Drg No: MWE/GWE/4.19.1 Cad file No WSS<22_11>

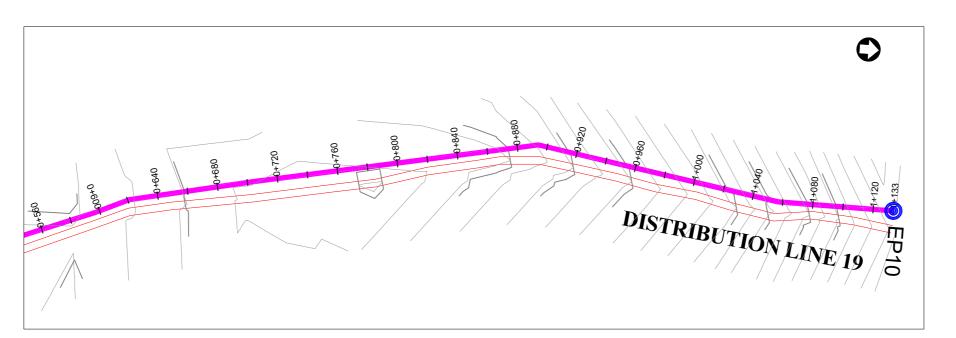

PLAN LAYOUT

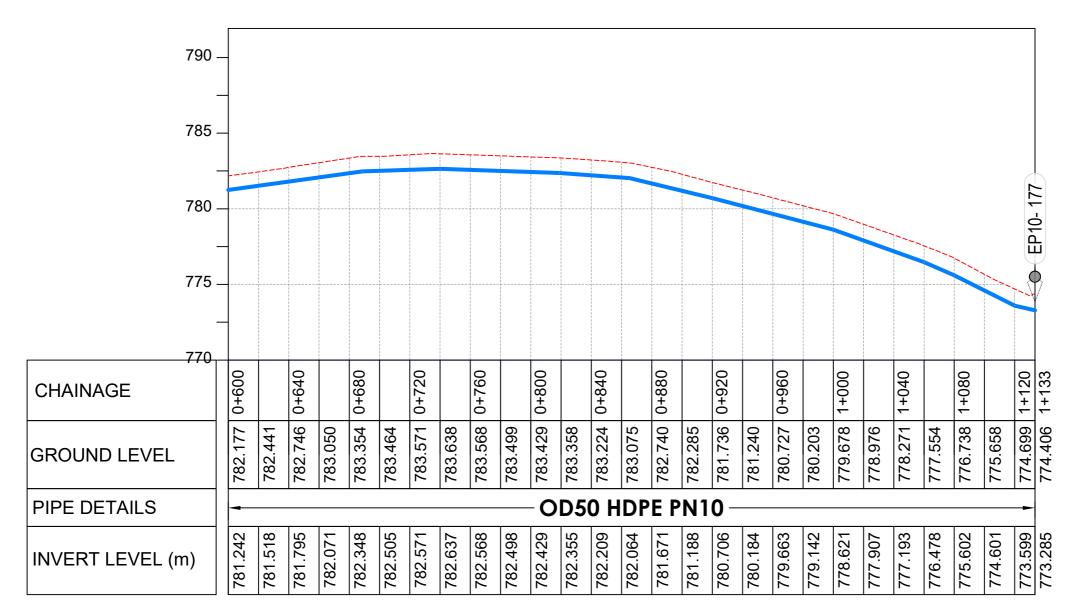

LONGITUDINAL PROFILE

AM	AMENDMENTS		
No	Date	Revision	
1	7.28.2023	Draft Design	

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Level Indicator SD 220 SD 116 Outfall Chamber SD 117 Thrust Blocks SD 118 Pipe beddings SD 121

LEGEND



Transmission Mains

Distribution Mains

Building/House

Contours Road Tree

Node detail No. 101

Double Orifice Air Valve WO_2 Type 2 Washout

CO-FINANCE BY

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THE WORLD BANK AND

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MINISTRY OF WATER AND ENVIRONMENT
DIRECTORATE OF WATER DEVELOPMENT (DWD)
RURAL WATER SUPPLY AND SANITATION DEPARTMENT
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- LOT 1 - MADI OKOLLO, TEREGO AND MOYO DISTRICTS -

CONSTRUCTION OF GWERE RGC WATER **SUPPLY AND SANITATION SYSTEM**

Consultant:




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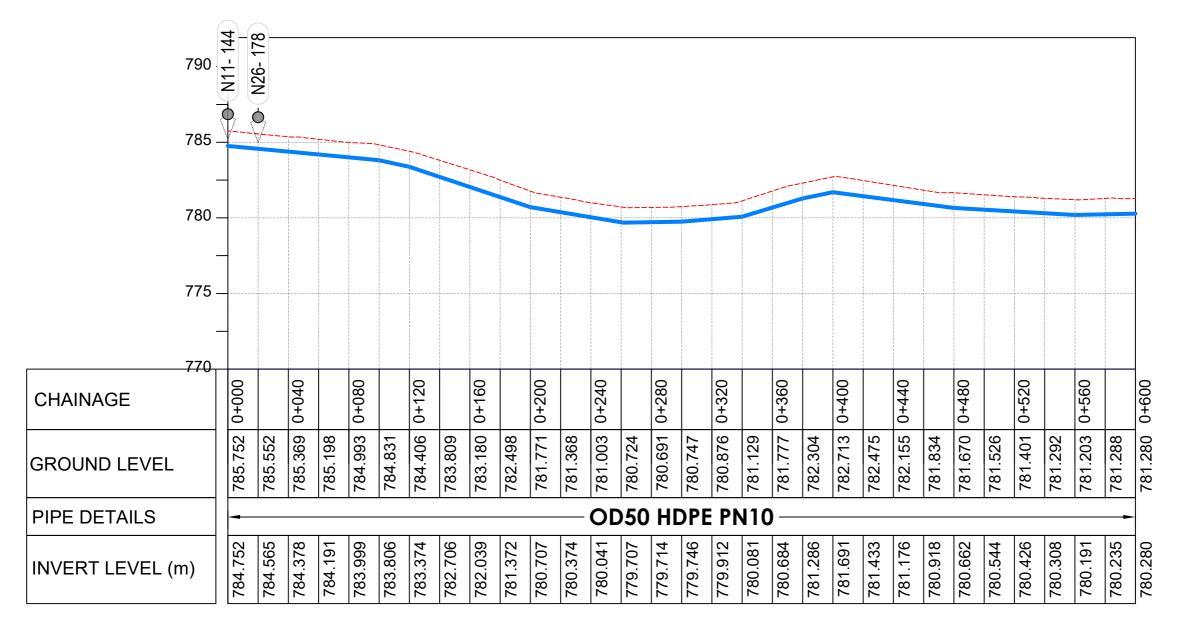
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DISTRIBUTION LINE 19 Distribution Line 19 (CH 0+600.00 - 1+133.37)

Scale: Vertical Scale: 1:250	Designed:	O.R Daniel		
Horizontal Scale: 1:250	Drawn:	P.S Eyamu		
Date:	Checked:	O.R Daniel		
Nov-2022	Approved:	O.R Daniel		

ENGINEERING DESIGN DRAWING Drg No: MWE/GWE/4.19.2 Cad file No WSS<22_11>



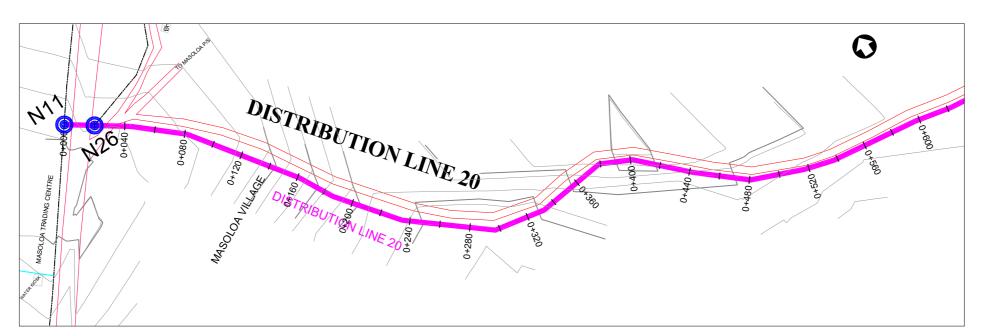

LONGITUDINAL PROFILE

AM	AMENDMENTS		
No	Date	Revision	
1	7.28.2023	Draft Design	

NOTES

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Level Indicator SD 220 SD 116 Outfall Chamber SD 117 Thrust Blocks SD 118

Pipe beddings SD 121

LEGEND



Transmission Mains **Distribution Mains**

Building/House

Contours

Road

Double Orifice Air Valve WO_2

Type 2 Washout Node detail No. 101

Tree



10

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MINISTRY OF WATER AND ENVIRONMENT
DIRECTORATE OF WATER DEVELOPMENT (DWD)
RURAL WATER SUPPLY AND SANITATION DEPARTMENT
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Consultancy Services for the Feability Study, Detailed Engineering Design and Construction Supervision of Solar Powered Piped Water Supply Systems and Sanitation Facilities In Refugee Settlements and Host Districts In West Nile and Northern Uganda

- LOT 1 - MADI OKOLLO, TEREGO AND MOYO DISTRICTS

CONSTRUCTION OF GWERE RGC WATER **SUPPLY AND SANITATION SYSTEM**

Consultant:




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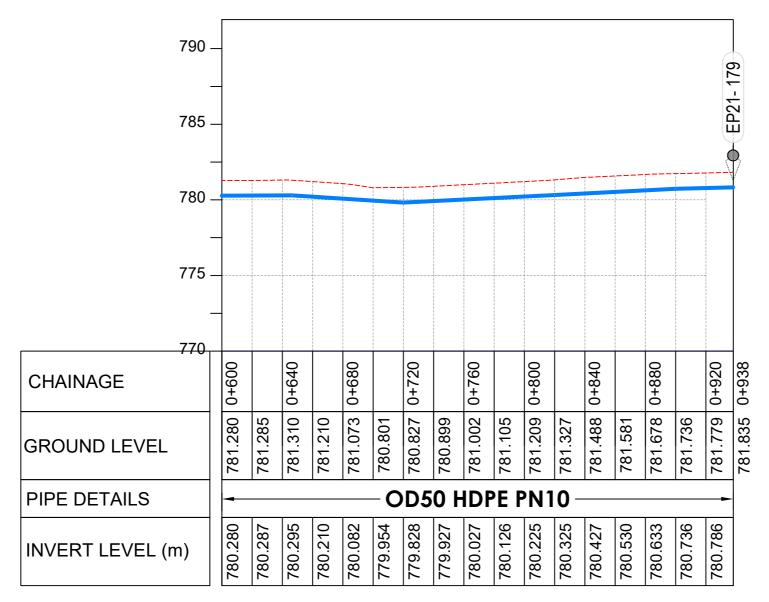
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Horizontal Scale: 1:2500	Drawn:	P.S Eyamu			
Date:	Checked:	O.R Daniel			
Nov-2022	Approved:	O.R Daniel			

ENGINEERING DESIGN DRAWING

Drg No: MWE/GWE/4.20.1 Cad file No WSS<22_11>



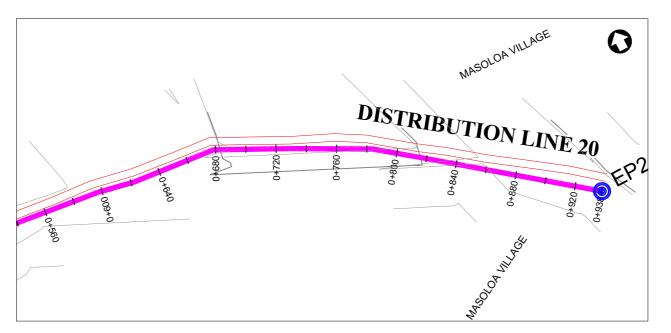

LONGITUDINAL PROFILE

AM	AMENDMENTS		
No	Date	Revision	
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Level Indicator SD 220 SD 116 Outfall Chamber SD 117 SD 118

Thrust Blocks Pipe beddings SD 121

LEGEND



Transmission Mains **Distribution Mains**

Building/House

Contours

Road

Tree DAV Double Orifice Air Valve

WO_2 Type 2 Washout Node detail No. 101



10

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MINISTRY OF WATER AND ENVIRONMENT
DIRECTORATE OF WATER DEVELOPMENT (DWD)
RURAL WATER SUPPLY AND SANITATION DEPARTMENT
Plot 3 - 7 Kabalega Crescent Road, Luzira, Box 20026 Kampala
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Website: www.mwe.go.ug

GOVERNMENT OF UGANDA

Consultancy Services for the Feability Study, Detailed Engineering Design and Construction Supervision of Solar Powered Piped Water Supply Systems and Sanitation Facilities In Refugee Settlements and Host Districts In West Nile and Northern Uganda

- LOT 1 - MADI OKOLLO, TEREGO AND MOYO DISTRICTS -

CONSTRUCTION OF GWERE RGC WATER **SUPPLY AND SANITATION SYSTEM**

Consultant:



10 Philpot Lane, 1st Floor,


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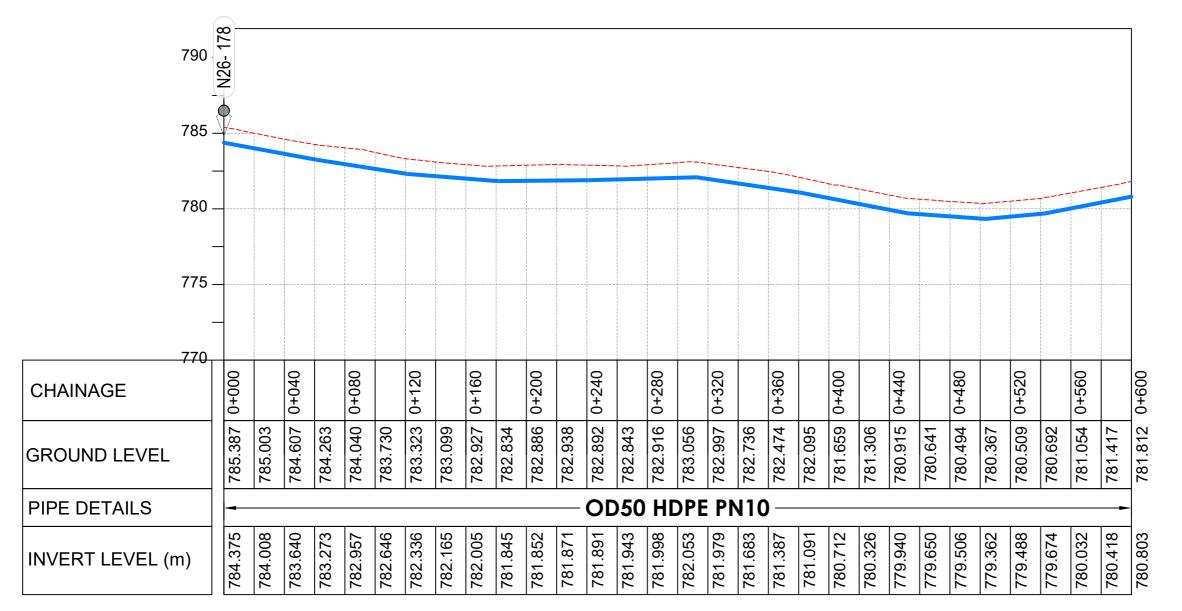
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Designed: O.R Daniel Vertical Scale: 1:250 Horizontal Scale: 1:2500 Drawn: P.S Eyamu Checked: O.R Daniel Approved: O.R Daniel

ENGINEERING DESIGN DRAWING

Drg No: MWE/GWE/4.20.2 Cad file No WSS<22_11>



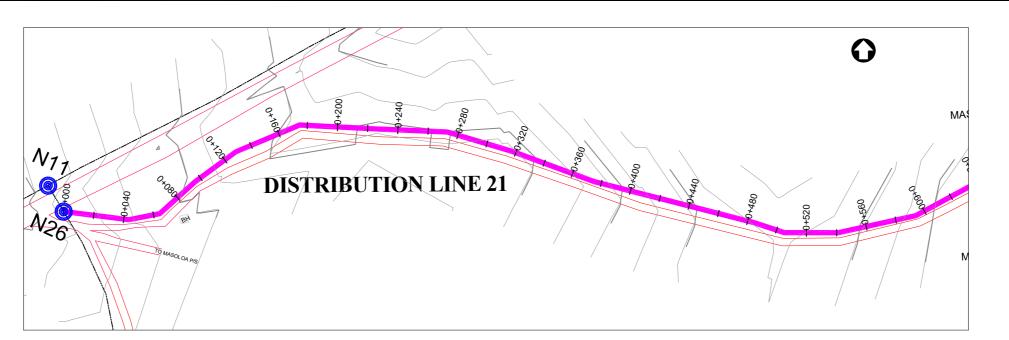

LONGITUDINAL PROFILE

AM	AMENDMENTS		
No	Date	Revision	
1	7.28.2023	Draft Design	

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- 4. For Node details, see Dwg. MWE/GWE/5.0.0
- 5. All valves, hydrants and washout locations are

Level Indicator SD 220 SD 116 Outfall Chamber SD 117 Thrust Blocks SD 118 Pipe beddings SD 121

LEGEND



Transmission Mains **Distribution Mains**

Building/House

Contours Road

Tree Double Orifice Air Valve WO_2

Type 2 Washout

Node detail No. 101

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MINISTRY OF WATER AND ENVIRONMENT
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- LOT 1 - MADI OKOLLO, TEREGO AND MOYO DISTRICTS -

CONSTRUCTION OF GWERE RGC WATER **SUPPLY AND SANITATION SYSTEM**

Consultant:




10 Philpot Lane, 1st Floor,

DISTRIBUTION LINE 21 Distribution Line 21 (CH 0+000.00 - 0+600.00)


Scale: Vertical Scale: 1:250	Designed:	O.R Daniel		
Horizontal Scale: 1:2500	Drawn:	P.S Eyamu		
Date:	Checked:	O.R Daniel		
Nov-2022	Approved:	O.R Daniel		

ENGINEERING DESIGN DRAWING

Drg No: MWE/GWE/4.21.1 Cad file No WSS<22_11>

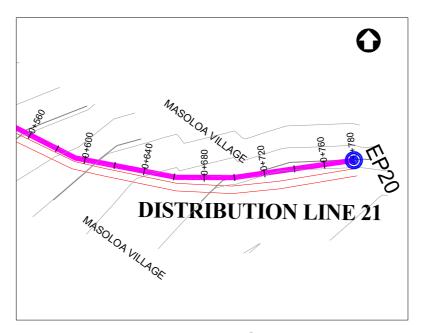

PLAN LAYOUT

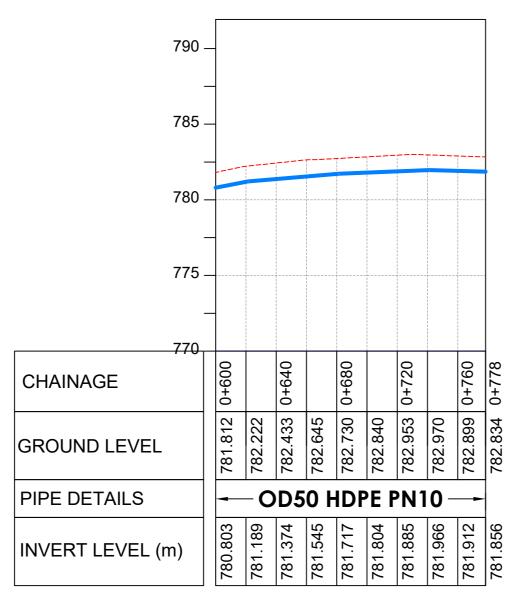

LONGITUDINAL PROFILE

ΑM	ENDMEN	ITS
No	Date	Revision
1	7.28.2023	Draft Design

NOTES

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- 4. For Node details, see Dwg. MWE/GWE/5.0.0
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SD 220 Level Indicator Outfall Chamber SD 116 Marker Post SD 117 Thrust Blocks SD 118 SD 121 Pipe beddings

LEGEND



Transmission Mains

Distribution Mains Building/House



Contours

Road Tree

Double Orifice Air Valve

Type 2 Washout

Node detail No. 101

CO-FINANCE BY

10

DAV

WO_2



GOVERNMENT OF UGANDA



MINISTRY OF WATER AND ENVIRONMENT
DIRECTORATE OF WATER DEVELOPMENT (DWD)
RURAL WATER SUPPLY AND SANITATION DEPARTMENT
Plot 3 - 7 Kabalega Crescent Road, Luzira, Box 20026 Kampala
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- LOT 1 - MADI OKOLLO, TEREGO AND MOYO DISTRICTS -

CONSTRUCTION OF GWERE RGC WATER SUPPLY AND SANITATION SYSTEM

Consultant:



10 Philpot Lane, 1st Floor,


Drawing Title:

DISTRIBUTION LINE 21 Distribution Line 21 (CH 0+600.00 - 0+778.39)

Scale:	Designed:	O.R Daniel
Vertical Scale: 1:250 Horizontal Scale: 1:2500	Drawn:	P.S Eyamu
Date:	Checked:	O.R Daniel
Nov-2022	Approved:	O.R Daniel

ENGINEERING DESIGN DRAWING


Drg No: MWE/GWE/4.21.2 Cad file No WSS<22_11>

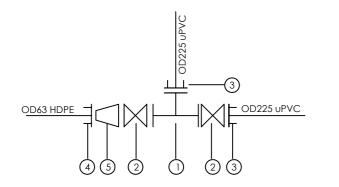

SCHEDULE OF PIPEWORK & FITTINGS

ITEM	DESCRIPTION	SIZE(DN)	QTY.	PN
1.	CI ALL FLANGED TEE	200/200	1	10
2.	CI FLANGED GATE VALVE	200	2	10
3.	CI FLANGED ADAPTOR (MAXI TYPE OR SIMILAR)	200	2	10
4.	COMPRESSION FLANGED ADAPTOR (MAXITYPE OR SIMILAR)	50	1	10
5.	CI FLANGED TAPER	200/50	1	10


NODE NO4

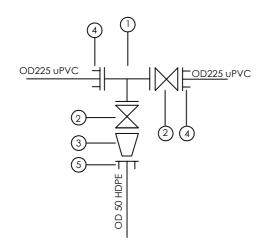

SCHEDULE OF PIPEWORK & FITTINGS

ITEM	DESCRIPTION	SIZE(DN)	QTY.	PN
1.	CI ALL FLANGED TEE	200/200	1	10
2.	CI FLANGED GATE VALVE	200	2	10
3.	CI FLANGED TAPER	200/40	1	10
4.	CI FLANGED ADAPTOR (MAXI TYPE OR SIMILAR)	200	2	10
5.	COMPRESSION FLANGED ADAPTOR (MAXITYPE OR SIMILAR)	40	1	10


NODE NO5

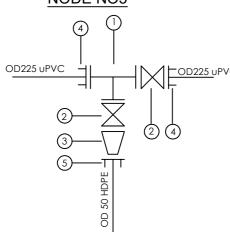

SCHEDULE OF PIPEWORK & FITTINGS

ITEM	DESCRIPTION	SIZE(DN	QTY.	PN
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2.	CI FLANGED GATE VALVE	200	2	10
3.	CI FLANGED TAPER	200/40	1	10
4.	CI FLANGED ADAPTOR (MAXI TYPE OR SIMILAR)	200	2	10
5.	COMPRESSION FLANGED ADAPTOR (MAXI TYPE OR SIMILAR)	40	1	10

NODE N06

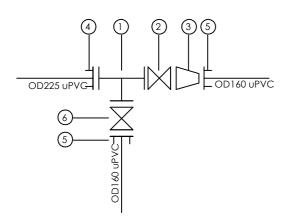

SCHEDULE OF PIPEWORK & FITTINGS

ITEM	DESCRIPTION	SIZE(DN)	QTY.	PN
1.	CI ALL FLANGED TEE	200/150	1	10
2.	CI FLANGED GATE VALVE	200	2	10
3.	CI FLANGED TAPER	200/150	1	10
4.	CI FLANGED ADAPTOR (MAXI TYPE OR SIMILAR)	200	1	10
5.	CI FLANGED ADAPTOR (MAXI TYPE OR SIMILAR)	150	2	10
6	CI FLANGED GATE VALVE	150	1	10

AM	AMENDMENTS				
No	Date	Revision			
1	7.28.2023	Draft Design			

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- 4. For Node details, see Dwg. MWE/GWE/5.0.0 5. All valves, hydrants and washout locations are
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LEGEND





GOVERNMENT OF UGANDA



MINISTRY OF WATER AND ENVIRONMENT DIRECTORATE OF WATER DEVELOPMENT (DWD)

RURAL WATER SUPPLY AND SANITATION DEPARTMENT

Plot 3 - 7 Kabalega Crescent Road, Luzira, Box 20026 Kampala

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West Nile and Northern Uganda

- LOT 1 - MADI OKOLLO, TEREGO AND MOYO DISTRICTS -

CONSTRUCTION OF GWERE RGC WATER SUPPLY AND SANITATION SYSTEM

Consultant:



10 Philpot Lane, 1st Floor, London EC3M 8AA,


Drawing Title:

DISTRIBUTION MAINS - NODE DETAILS Node Details A

Scale:	Designed:	O.R Daniel		
	Drawn:	P.S Eyamu		
Date:	Checked:	O.R Daniel		
Feb-2023	Approved:	O.R Daniel		
ENGINEERING DESIGN DRAWING				


Drg No: MWE/GWE/5.0.1 | Cad file No WSS<22_11>

SCHEDULE OF PIPEWORK & FITTINGS

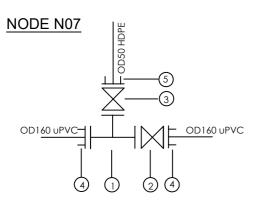

ITEM	DESCRIPTION	SIZE(DN)	QTY.	PN
1.	CI ALL FLANGED TEE	150/40	1	10
2.	CI FLANGED GATE VALVE	150	1	10
3.	CI FLANGED GATE VALVE	40	1	10
4.	CI FLANGED ADAPTOR (MAXI TYPE OR SIMILAR)	150	2	10
5.	COMPRESSION FLANGED ADAPTOR (MAXI TYPE OR SIMILAR)	40	1	10


NODE N08

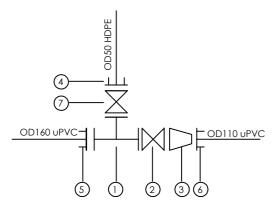

SCHEDULE OF PIPEWORK & FITTINGS


ITEM	DESCRIPTION	SIZE(DN)	QTY.	PN
1.	CI ALL FLANGED TEE	150/40	1	10
2.	CI FLANGED GATE VALVE	150	1	10
3.	CI FLANGED TAPER	150/100	1	10
4.	COMPRESSION FLANGED ADAPTOR (MAXI TYPE OR SIMILAR)	40	1	10
5.	CI FLANGED ADAPTOR (MAXI TYPE OR SIMILAR)	150	1	10
6.	CI FLANGED ADAPTOR (MAXI TYPE OR SIMILAR)	100	1	10
7.	CI FLANGED GATE VALVE	40	1	10

NODE N09

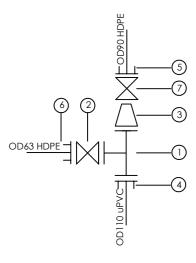

SCHEDULE OF PIPEWORK & FITTINGS

ITEM	DESCRIPTION	SIZE(DN)	QTY.	PN
1.	CI ALL FLANGED TEE	100/50	1	10
2.	CI FLANGED GATE VALVE	50	1	10
3.	CI FLANGED TAPER	100/80	1	10
4.	CI ADAPTOR (MAXI TYPE OR SIMILAR)	100	1	10
5.	COMPRESSION FLANGED ADAPTOR (MAXI TYPE OR SIMILAR)	80	1	10
6.	COMPRESSION FLANGED ADAPTOR (MAXI TYPE OR SIMILAR)	50	1	10
7.	CI FLANGED GATE VALVE	80	1	10

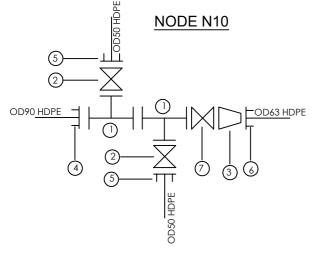

SCHEDULE OF PIPEWORK & FITTINGS

ITEM	DESCRIPTION	SIZE(ND	QTY.	PN
1.	CI ALL FLANGED TEE	80/40	2	10
2.	CI FLANGED GATE VALVE	40	2	10
3.	CI FLANGED TAPER	80/50	1	10
4.	COMPRESSION FLANGED ADAPTOR (MAXI TYPE OR SIMILAR)	80	1	10
5.	COMPRESSION FLANGED ADAPTOR (MAXI TYPE OR SIMILAR)	40	2	10
6.	COMPRESSION FLANGED ADAPTOR (MAXI TYPE OR SIMILAR)	50	1	10
7.	CI FLANGED GATE VALVE	80	1	10

AM	AMENDMENTS			
No	Date	Revision		
1	7.28.2023	Draft Design		

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- 4. For Node details, see Dwg. MWE/GWE/5.0.05. All valves, hydrants and washout locations are identified by marker post in positions.

LEGEND





GOVERNMENT OF UGANDA

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MINISTRY OF WATER AND ENVIRONMENT
DIRECTORATE OF WATER DEVELOPMENT (DWD)
RURAL WATER SUPPLY AND SANITATION DEPARTMENT
Plot 3 - 7 Kabalega Crescent Road, Luzira, Box 20026 Kampala
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Website: www.mwe.go.ug

PROJEC1

Consultancy Services for the Feability Study, Detailed Engineering Design and Construction Supervision of Solar Powered Piped Water Supply Systems and Sanitation Facilities In Refugee Settlements and Host Districts In West Nile and Northern Uganda

- LOT 1 - MADI OKOLLO, TEREGO AND MOYO DISTRICTS -

CONSTRUCTION OF GWERE RGC WATER SUPPLY AND SANITATION SYSTEM

Consultant:




Corporate Headquarter 10 Philpot Lane, 1st Floor, London EC3M 8AA, United Kingdom

Drawing Title:


DISTRIBUTION MAINS - NODE DETAILS Node Details B

Scale:	Designed:		O.R Daniel	
	Drav	vn:	P.S Eyamu	
Date:	Checked:		O.R Daniel	
Feb-2023	App	roved:	O.R Daniel	
ENGINEERIN	1G DI	esign [DRAWING	
Drg No: MWE/GWE/	5.0.2	Cad file	No WSS<22_11>	

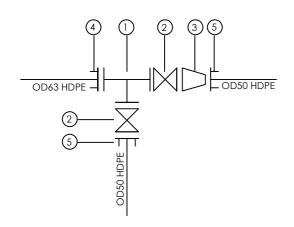

SCHEDULE OF PIPEWORK & FITTINGS


ITEM	DESCRIPTION	SIZE(DN)	QTY.	PN
1.	CI ALL FLANGED TEE	50/40	1	10
2.	CI FLANGED GATE VALVE	40	1	10
3.	CI FLANGED TAPER	50/40	1	10
4.	COMPRESSION FLANGED ADAPTOR (MAXI TYPE OR SIMILAR)	50	1	10
5.	COMPRESSION FLANGED ADAPTOR (MAXI TYPE OR SIMILAR)	40	2	10

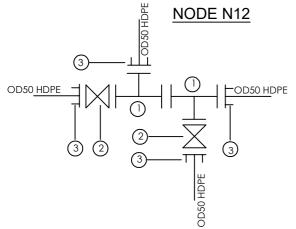

SCHEDULE OF PIPEWORK & FITTINGS

ITEM	DESCRIPTION	SIZE(ND	QTY.	PN
1.	CI ALL FLANGED TEE	40/40	2	10
2.	CI FLANGED GATE VALVE	40	2	10
3.	COMPRESSION FLANGED ADAPTOR (MAXI TYPE OR SIMILAR)	40	4	10


NODE N14

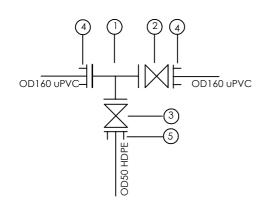

SCHEDULE OF PIPEWORK & FITTINGS

ITEM	DESCRIPTION	SIZE(DN)	QTY.	PN
1.	CI ALL FLANGED TEE	150/40	1	10
2.	CI FLANGED GATE VALVE	150	1	10
3.	CI FLANGED GATE VALVE	40	1	10
4.	CI FLANGED ADAPTOR (MAXI TYPE OR SIMILAR)	150	2	10
5.	COMPRESSION FLANGED ADAPTOR (MAXI TYPE OR SIMILAR)	40	1	10

NODE N15

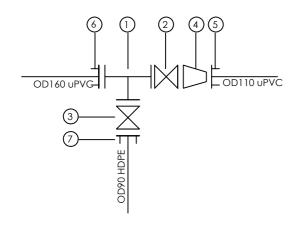

SCHEDULE OF PIPEWORK & FITTINGS

ITEM	DESCRIPTION	SIZE(DN)	QTY.	PN
1.	CI ALL FLANGED TEE	150/80	1	10
2.	CI FLANGED GATE VALVE	150	1	10
3.	CI FLANGED GATE VALVE	80	1	10
4.	CI FLANGED TAPER	150/100	1	10
5.	CI FLANGED ADAPTOR (MAXI TYPE OR SIMILAR)	100	1	10
6.	CI FLANGED ADAPTOR (MAXI TYPE OR SIMILAR)	150	1	10
7.	COMPRESSION FLANGED ADAPTOR (MAXI TYPE OR SIMILAR)	80	1	10

AM	AMENDMENTS				
No	Date	Revision			
1	7.28.2023	Draft Design			

NOTES

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- 3. For Site location see Dwg. MWE/GWE/0.0.0
- 4. For Node details, see Dwg. MWE/GWE/5.0.0 5. All valves, hydrants and washout locations are identified by marker post in positions.
- **LEGEND**







MINISTRY OF WATER AND ENVIRONMENT DIRECTORATE OF WATER DEVELOPMENT (DWD)

RURAL WATER SUPPLY AND SANITATION DEPARTMENT

Plot 3 - 7 Kabalega Crescent Road, Luzira, Box 20026 Kampala

Tel : +256 417 889 400, Email: mwe@mwe.go.ug

Website: www.mwe.go.ug

Consultancy Services for the Feability Study, Detailed Engineering Design and Construction Supervision of Solar Powered Piped Water Supply Systems and Sanitation Facilities In Refugee Settlements and Host Districts In West Nile and Northern Uganda

- LOT 1 - MADI OKOLLO, TEREGO AND MOYO DISTRICTS -

CONSTRUCTION OF GWERE RGC WATER SUPPLY AND SANITATION SYSTEM

Consultant:




10 Philpot Lane, 1st Floor, London EC3M 8AA,

Drawing Title:

DISTRIBUTION MAINS - NODE DETAILS Node Details C

Scale:	Designed:	O.R Daniel		
	Drawn:	P.S Eyamu		
Date:	Checked:	O.R Daniel		
Feb-2023	Approved:	O.R Daniel		
ENGINEERING DESIGN DRAWING				


Drg No: MWE/GWE/5.0.3 | Cad file No WSS<22_11>

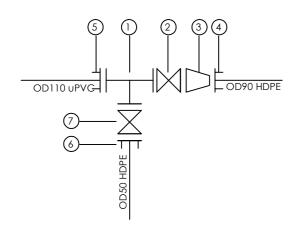

SCHEDULE OF PIPEWORK & FITTINGS

ITEM	DESCRIPTION	SIZE(DN)	QTY.	PN
1.	CI ALL FLANGED TEE	100/40	1	10
2.	CI FLANGED GATE VALVE	100	2	10
3.	CI FLANGED TAPER	100/80	1	10
4.	COMPRESSION FLANGED ADAPTOR (MAXI TYPE OR SIMILAR)	80	1	10
5.	CI FLANGED ADAPTOR (MAXI TYPE OR SIMILAR)	100	1	10
6.	COMPRESSION FLANGED ADAPTOR (MAXI TYPE OR SIMILAR)	40	1	10
7.	CI FLANGED GATE VALVE	40	1	10


NODE N17

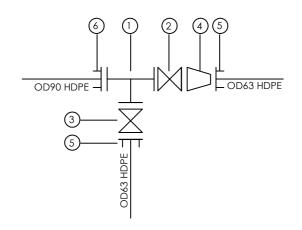

SCHEDULE OF PIPEWORK & FITTINGS

ITEM	DESCRIPTION	SIZE(DN)	QTY.	PN
1.	CI ALL FLANGED TEE	80/50	1	10
2.	CI FLANGED GATE VALVE	80	1	10
3.	CI FLANGED GATE VALVE	50	1	10
4.	CI FLANGED TAPER	80/50	1	10
5.	COMPRESSION FLANGED ADAPTOR (MAXI TYPE OR SIMILAR)	50	2	10
6.	COMPRESSION FLANGED ADAPTOR (MAXI TYPE OR SIMILAR)	80	1	10

NODE N18

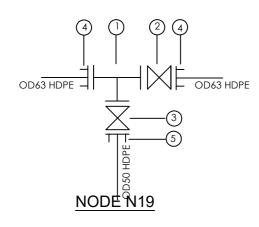

SCHEDULE OF PIPEWORK & FITTINGS

ITEM	DESCRIPTION	SIZE(DN)	QTY.	PN
1.	CI ALL FLANGED TEE	50/40	1	10
2.	CI FLANGED GATE VALVE	50	1	10
3.	CI FLANGED GATE VALVE	40	1	10
4.	CI FLANGED ADAPTOR (MAXI TYPE OR SIMILAR)	50	2	10
5.	COMPRESSION FLANGED ADAPTOR (MAXI TYPE OR SIMILAR)	40	1	10

SCHEDULE OF PIPEWORK & FITTINGS

ITEM	DESCRIPTION	SIZE(DN)	QTY.	PN
1.	CI ALL FLANGED TEE	40/50	1	10
2.	CI FLANGED GATE VALVE	80	1	10
3.	CI FLANGED TAPER	80/40	1	10
4.	COMPRESSION FLANGED ADAPTOR (MAXI TYPE OR SIMILAR)	80	1	10
5.	COMPRESSION FLANGED ADAPTOR (MAXI TYPE OR SIMILAR)	40	1	10
6.	COMPRESSION FLANGED ADAPTOR (MAXI TYPE OR SIMILAR)	50	1	10

	AMENDMENTS			
ı	No	Date	Revision	
l	1	7.28.2023	Draft Design	
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NOTES

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- 3. For Site location see Dwg. MWE/GWE/0.0.0
- 4. For Node details, see Dwg. MWE/GWE/5.0.0
- 5. All valves, hydrants and washout locations are identified by marker post in positions.

LEGEND



GOVERNMENT OF UGANDA

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MINISTRY OF WATER AND ENVIRONMENT
DIRECTORATE OF WATER DEVELOPMENT (DWD)
RURAL WATER SUPPLY AND SANITATION DEPARTMENT
Plot 3 - 7 Kabalega Crescent Road, Luzira, Box 20026 Kampala
Tel: +256 417 889 400, Email: mwe@mwe.go.ug
Website: www.mwe.go.ug

PROJEC1

Consultancy Services for the Feability Study, Detailed Engineering Design and Construction Supervision of Solar Powered Piped Water Supply Systems and Sanitation Facilities In Refugee Settlements and Host Districts In West Nile and Northern Uganda

- LOT 1 - MADI OKOLLO, TEREGO AND MOYO DISTRICTS -

CONSTRUCTION OF GWERE RGC WATER SUPPLY AND SANITATION SYSTEM

Consultant:




Corporate Headquarter
10 Philpot Lane, 1st Floor,
London EC3M 8AA,
United Kingdom

Drawing Title:

DISTRIBUTION MAINS - NODE DETAILS Node Details D

Scale:	Desi	gned:	O.R Daniel
	Drav	vn:	P.S Eyamu
Date:	Chec	cked:	O.R Daniel
Feb-2023	App	roved:	O.R Daniel
ENGINEERIN	IG DI	ESIGN [DRAWING
Drg No: MWE/GWE/	5.0.4	Cad file	No WSS<22_11>


OD90 HDPE OD50 HDPE TT 6.

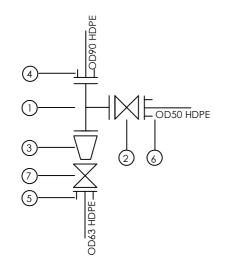

SCHEDULE OF PIPEWORK & FITTINGS

ITEM	DESCRIPTION	SIZE(DN)	QTY.	PN
1.	CI ALL FLANGED TEE	80/40	1	10
2.	CI FLANGED GATE VALVE	40	1	10
3.	CI FLANGED TAPER	80/50	1	10
4.	COMPRESSION FLANGED ADAPTOR (MAXI TYPE OR SIMILAR)	80	1	10
5.	COMPRESSION FLANGED ADAPTOR (MAXI TYPE OR SIMILAR)	50	1	10
6.	COMPRESSION FLANGED ADAPTOR (MAXI TYPE OR SIMILAR)	40	1	10
7.	CI FLANGED GATE VALVE	50	1	10


NODE N21

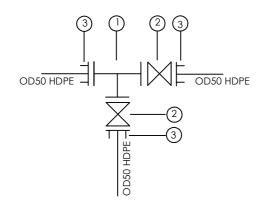

SCHEDULE OF PIPEWORK & FITTINGS

ITEM	DESCRIPTION	SIZE(DN)	QTY.	PN
1.	CI ALL FLANGED TEE	40/40	1	10
2.	CI FLANGED GATE VALVE	40	2	10
3.	COMPRESSION FLANGED ADAPTOR (MAXI TYPE OR SIMILAR)	40	3	10

NODE N22

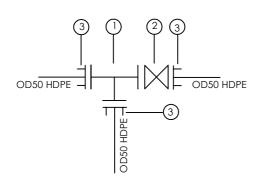

SCHEDULE OF PIPEWORK & FITTINGS

ITEM	DESCRIPTION	SIZE(DN)	QTY.	PN
1.	CI ALL FLANGED TEE	40/40	1	10
2.	CI FLANGED GATE VALVE	40	1	10
3.	COMPRESSION FLANGED ADAPTOR (MAXI TYPE OR SIMILAR)	40	3	10

SCHEDULE OF PIPEWORK & FITTINGS

ITEM	DESCRIPTION	SIZE(DN)	QTY.	PN
1.	CI ALL FLANGED TEE	40/40	1	10
2.	CI FLANGED GATE VALVE	40	1	10
3.	COMPRESSION FLANGED ADAPTOR (MAXI TYPE OR SIMILAR)	40	3	10

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No	Date	Revision	
1	7.28.2023	Draft Design	

NOTES

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- 4. For Node details, see Dwg. MWE/GWE/5.0.05. All valves, hydrants and washout locations are
- identified by marker post in positions.

LEGEND





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MINISTRY OF WATER AND ENVIRONMENT
DIRECTORATE OF WATER DEVELOPMENT (DWD)
RURAL WATER SUPPLY AND SANITATION DEPARTMENT
Plot 3 - 7 Kabalega Crescent Road, Luzira, Box 20026 Kampala
Tel: +256 417 888 400, Emai: mwe@mwe.go.ug
Website: www.mwe.go.ug

PROJECT

Consultancy Services for the Feability Study, Detailed Engineering Design and Construction Supervision of Solar Powered Piped Water Supply Systems and Sanitation Facilities In Refugee Settlements and Host Districts In West Nile and Northern Uganda

- LOT 1 - MADI OKOLLO, TEREGO AND MOYO DISTRICTS -

CONSTRUCTION OF GWERE RGC WATER SUPPLY AND SANITATION SYSTEM

Consultant:




Corporate Headquarter 10 Philpot Lane, 1st Floor, London EC3M 8AA, United Kingdom

Drawing Title:

DISTRIBUTION MAINS - NODE DETAILS Node Details E

Scale:	Designed:	O.R Daniel		
	Drawn:	P.S Eyamu		
Date:	Checked:	O.R Daniel		
Feb-2023	Approved:	O.R Daniel		
ENGINEERING DESIGN DRAWING				

Drg No: MWE/GWE/5.0.5 | Cad file No WSS<22_11>

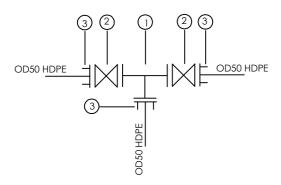


SCHEDULE OF PIPEWORK & FITTINGS

ITEM	DESCRIPTION	SIZE(ND	QTY.	PN
1.	CI ALL FLANGED TEE	40/40	1	10
2.	CI FLANGED GATE VALVE	40	2	10
3.	COMPRESSION FLANGED ADAPTOR (MAXI TYPE OR SIMILAR)	40	3	10

3 2 OD50 HDPE - OD50 HDPE 3 2 1 3

SCHEDULE OF PIPEWORK & FITTINGS

ITEM	DESCRIPTION	SIZE(DN)	QTY.	PN
1.	CI ALL FLANGED TEE	40/40	1	10
2.	CI FLANGED GATE VALVE	40	2	10
3.	COMPRESSION FLANGED ADAPTOR (MAXI TYPE OR SIMILAR)	40	3	10

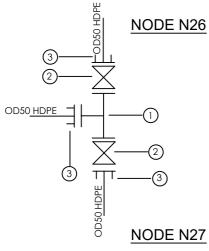

SCHEDULE OF PIPEWORK & FITTINGS

ITEM	DESCRIPTION	SIZE(ND	QTY.	PN
1.	CI ALL FLANGED TEE	40/40	1	10
2.	CI FLANGED GATE VALVE	40	2	10
3.	COMPRESSION FLANGED ADAPTOR (MAXI TYPE OR SIMILAR)	40	3	10

SCHEDULE OF PIPEWORK & FITTINGS

ITEM	DESCRIPTION	SIZE(DN)	QTY.	PN
1.	CI ALL FLANGED TEE	150/40	1	10
2.	CI FLANGED GATE VALVE	150	1	10
3.	CI FLANGED ADAPTOR (MAXI TYPE OR SIMILAR)	150	2	10
4.	COMPRESSION FLANGED ADAPTOR (MAXI TYPE OR SIMILAR)	40	1	10
5.	CI FLANGED GATE VALVE	40	1	10

NODE EP4,EP28,EP11,EP14, EP6,EP7,EP8,EP9,EP10,EP1, EP20,EP21,EP19,EP16,EP3.1



SCHEDULE OF PIPEWORK & FITTINGS

ITEM	DESCRIPTION	SIZE(DN	QTY.	PN
1.	END CAP	40	15	10

NODE EP2&EP12



SCHEDULE OF PIPEWORK & FITTINGS

ITEM	DESCRIPTION	SIZE(DN)	QTY.	PN	
1.	END CAP	50	2	10	

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No	Date	Revision	
1	7.28.2023	Draft Design	

NOTES

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- 4. For Node details, see Dwg. MWE/GWE/5.0.0
- 5. All valves, hydrants and washout locations are identified by marker post in positions.

LEGEND



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MINISTRY OF WATER AND ENVIRONMENT
DIRECTORATE OF WATER DEVELOPMENT (DWD)
RURAL WATER SUPPLY AND SANITATION DEPARTMENT
Plot 3 - 7 Kabalega Crescent Road, Luzira, Box 20026 Kampala
Tel: +256 417 889 400, Email: mwe@mwe.go.u.g
Website: www.mwe.go.u.g

PROJECT

Consultancy Services for the Feability Study, Detailed Engineering Design and Construction Supervision of Solar Powered Piped Water Supply Systems and Sanitation Facilities In Refugee Settlements and Host Districts In West Nile and Northern Uganda

- LOT 1 - MADI OKOLLO, TEREGO AND MOYO DISTRICTS -

CONSTRUCTION OF GWERE RGC WATER SUPPLY AND SANITATION SYSTEM

Consultant:




Corporate Headquarter 10 Philpot Lane, 1st Floor, London EC3M 8AA, United Kingdom

Drawing Title:


DISTRIBUTION MAINS - NODE DETAILS Node Details F

Scale:	Designed:	O.R Daniel		
	Drawn:	P.S Eyamu		
Date:	Checked:	O.R Daniel		
Feb-2023	Approved:	O.R Daniel		
ENGINEERING DESIGN DRAWING				

Drg No: MWE/GWE/5.0.6 | Cad file No WSS<22_11>

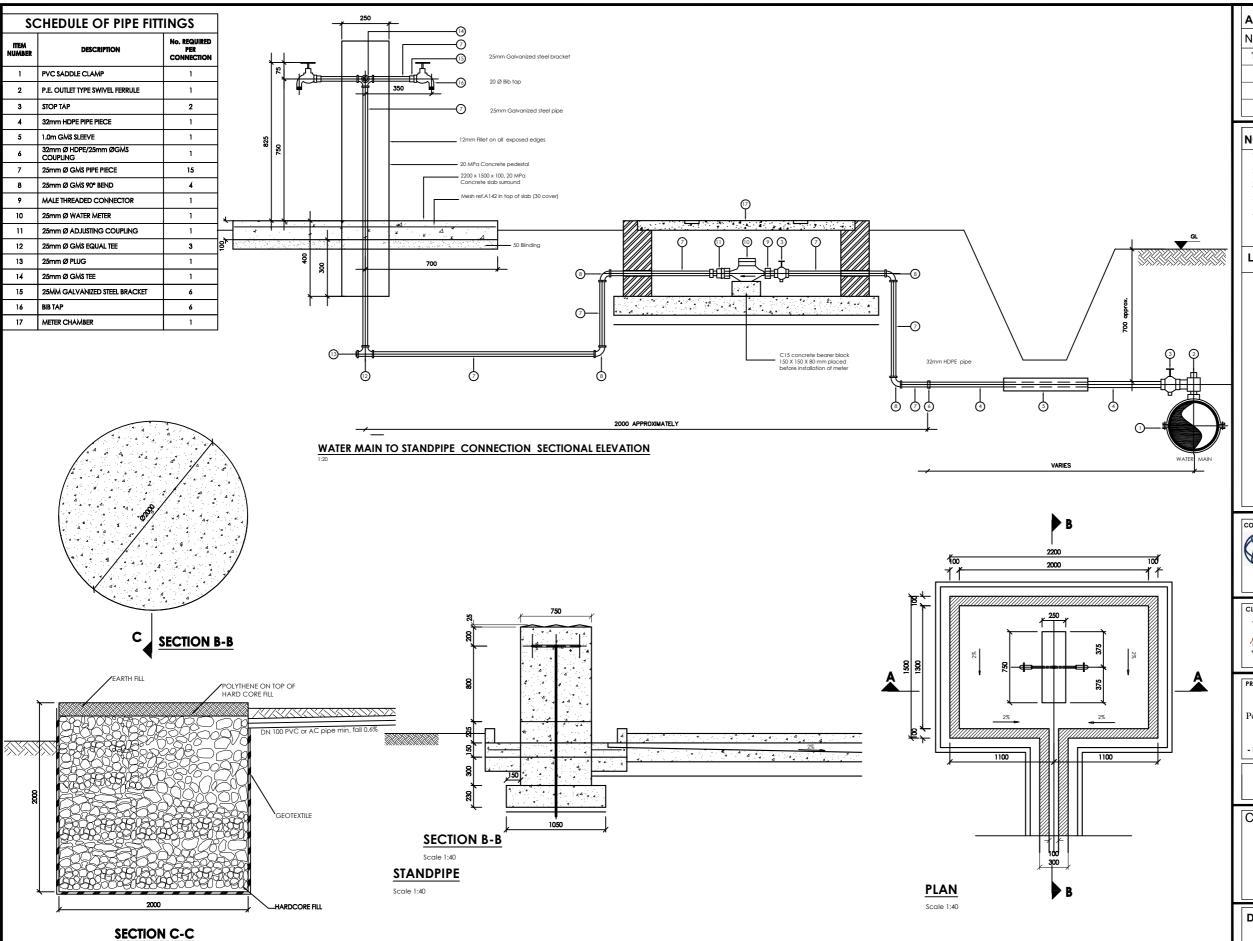

SOAKAWAY

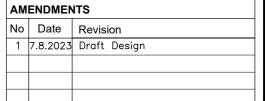

NOTES

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- 2. All levels are in metres above sea level.
- 3. For Site location see Dwg. MWE/GWE/0.0.0 4. For Node details, see Dwg. MWE/GWE/5.0.0
- 5. All valves, hydrants and washout locations are identified by marker post in positions.

LEGEND





GOVERNMENT OF UGANDA



MINISTRY OF WATER AND ENVIRONMENT DIRECTORATE OF WATER DEVELOPMENT (DWD)

RURAL WATER SUPPLY AND SANITATION DEPARTMENT

Plot 3 - 7 Kabalega Crescent Road, Luzira, Box 20026 Kampala

Tel : +256 417 889 400, Email: mwe@mwe.go.ug

Website: www.mwe.go.ug

Consultancy Services for the Feability Study, Detailed Engineering Design and Construction Supervision of Solar Powered Piped Water Supply Systems and Sanitation Facilities In Refugee Settlements and Host Districts In West Nile and Northern Uganda

- LOT 1 - MADI OKOLLO, TEREGO AND MOYO DISTRICTS -

CONSTRUCTION OF GWERE RGC WATER **SUPPLY AND SANITATION SYSTEM**

Consultant:




10 Philpot Lane, 1st Floor,

Drawing Title:

TYPICAL SAND POST Plan and Sections

Scale:	Desig	ned:	O.R Daniel
	Drawı	n:	P.S Eyamu
Date:	Checl	ked:	O.R Daniel
Dec-2022	Appro	oved:	O.R Daniel
ENGINEERIN	IG DE	SIGN	DRAWING
Drg No: MWE/GWE/5	5.1.1	Cad file I	No WSS<22_11>

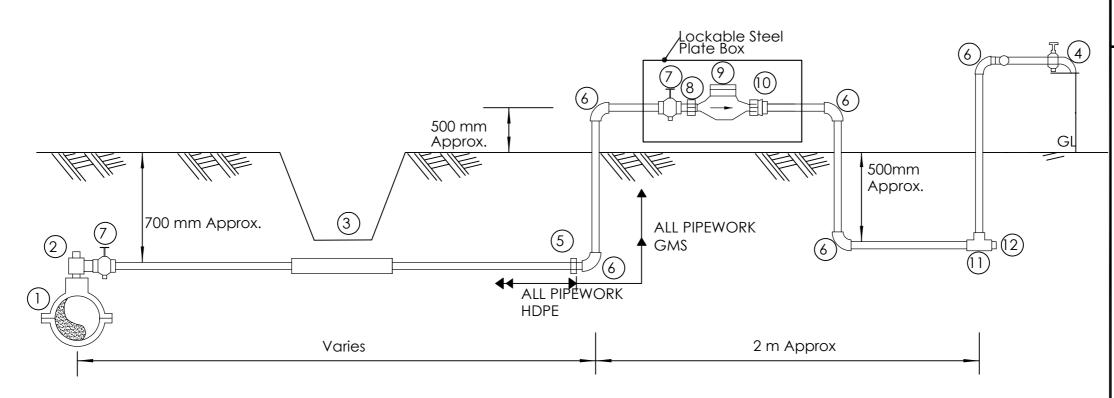

SCHEDULE OF FITTINGS

ITEM No	DESCRIPTION	No REQUIRED PER CONNECTION
1.	Saddle Clamp	1
2.	HDPE Outlet type swivel ferule	1
3.	1m Length GMS sleeve	1
4.	Brass Tap	1
5.	PE/GMS Adaptor	1
6.	GMS Elbow	5
7.	Brass Gate Valve	2
8.	Male threaded connector	1
9.	Water meter	1
10.	Adjusting coupling	1
11.	GMS equal tee	1
12.	Plug	1

NOTES

- 1. GMS pipe ends to be screwed with tapered threads to ISO R7 and to be supplied with sealing PTFE tape
- 2. GMS pipe fittings to be malleable cast iron to BS 143 and BS 1256 with female threaded ends
- 3. The adjusting coupling shall be made of bronze or brass with a threaded female connection at the outlet end. It shall incorporate sufficient adjustment to permit removal at the meter
- 4. All PE connections shall be of the compression type
- 5. Diameter of pipe varies

	AMENDMENTS				
I	No	Date	Revision		
	1	7.8.2023	Draft Design		

NOTES

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- 3. For Site location see Dwg. MWE/GWE/0.0.0
- 4. For Node details, see Dwg. MWE/GWE/5.0.0
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LEGEND





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MINISTRY OF WATER AND ENVIRONMENT DIRECTORATE OF WATER AND ENVIRONMENT DIRECTORATE OF WATER DEVELOPMENT (DWD)
RURAL WATER SUPPLY AND SANITATION DEPARTMENT
Plot 3 - 7 Kabalega Crescent Road, Luzira, Box 20026 Kampala
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- LOT 1 - MADI OKOLLO, TEREGO AND MOYO DISTRICTS -

CONSTRUCTION OF GWERE RGC WATER **SUPPLY AND SANITATION SYSTEM**

Consultant:




10 Philpot Lane. 1st Floor. London EC3M 8AA,

Drawing Title:

TYPICAL YARD CONNECTION Sectional Elevation

Scale:	Desig		O.R Daniel		
	Drav	vn:	P.S Eyamu		
Date:	Che	cked:	O.R Daniel		
Dec-2022	Арр	roved:	O.R Daniel		
ENGINEERIN	IG D	ESIGN	DRAWING		
Drg No: MWE/GWE/5	5.2.1	Cad file I	No WSS<22_11>		

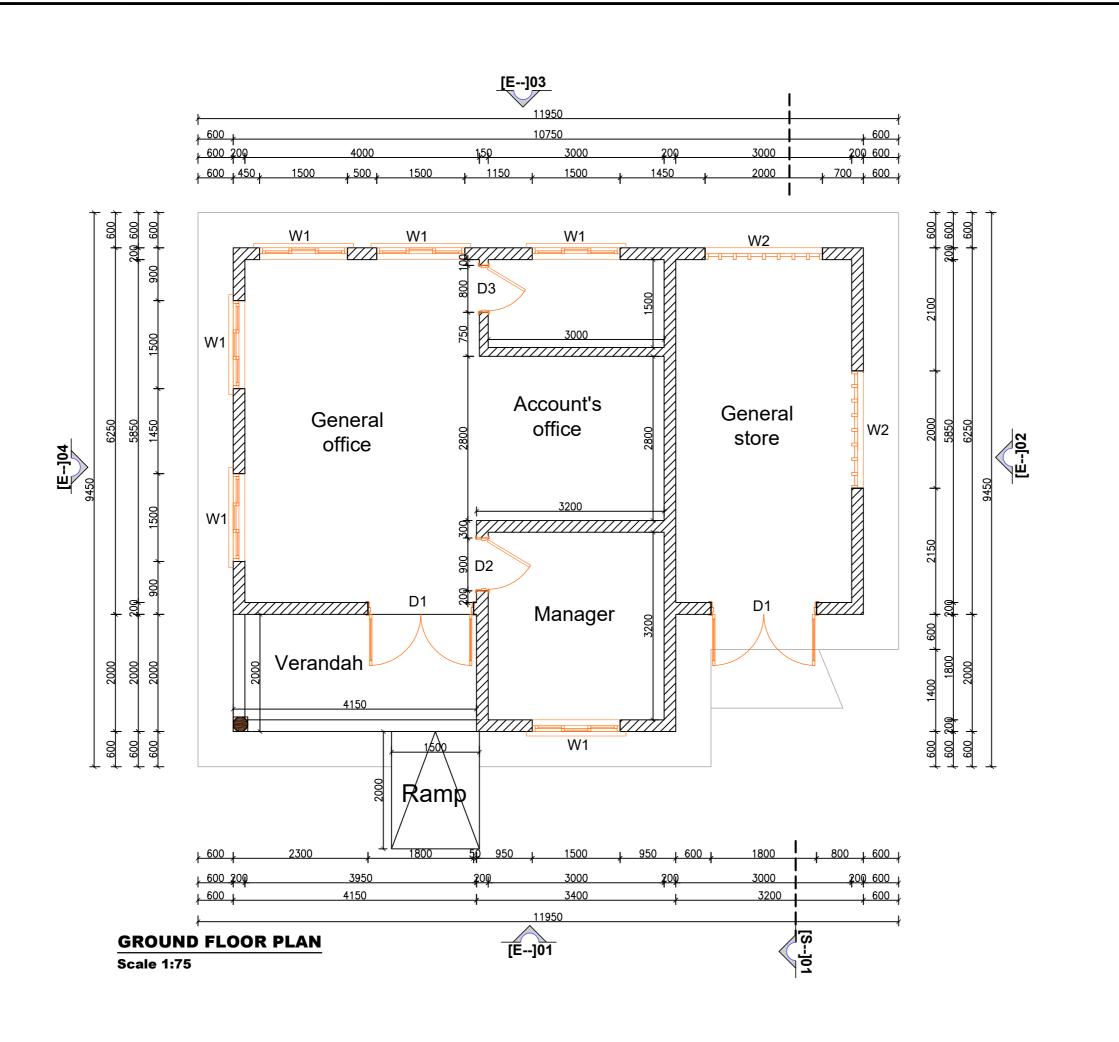

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ı	No	Date	Revision			
ı	1	7.8.2023	Draft Design			
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LEGEND





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MINISTRY OF WATER AND ENVIRONMENT DIRECTORATE OF WATER DEVELOPMENT (DWD) RURAL WATER SUPPLY AND SANITATION DEPARTMENT Plot 3 - 7 Kabalega Crescent Road, Luzira, Box 20026 Kampala Tel: +256 417 889 400, Email: mwe@mwe.go.ug

PROJEC

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- LOT 1 - MADI OKOLLO, TEREGO AND MOYO DISTRICTS -

CONSTRUCTION OF GWERE RGC WATER SUPPLY AND SANITATION SYSTEM

Consultant:



Corporate Headquarter 10 Philpot Lane, 1st Floor, London EC3M 8AA, United Kingdom


Drawing Title:

WATER OFFICE BLOCK Ground Floor Plan

Scale:	Designed:	O.R Daniel
	Drawn:	P.S Eyamu
Date:	Checked:	O.R Daniel
Dec-2022	Approved:	O.R Daniel
ENGINEERI	NG DESIGN	DRAWING

ENGINEERING DESIGN DRAWING

Drg No: MWE/GWE/6.1.1 | Cad file No WSS<22_11>

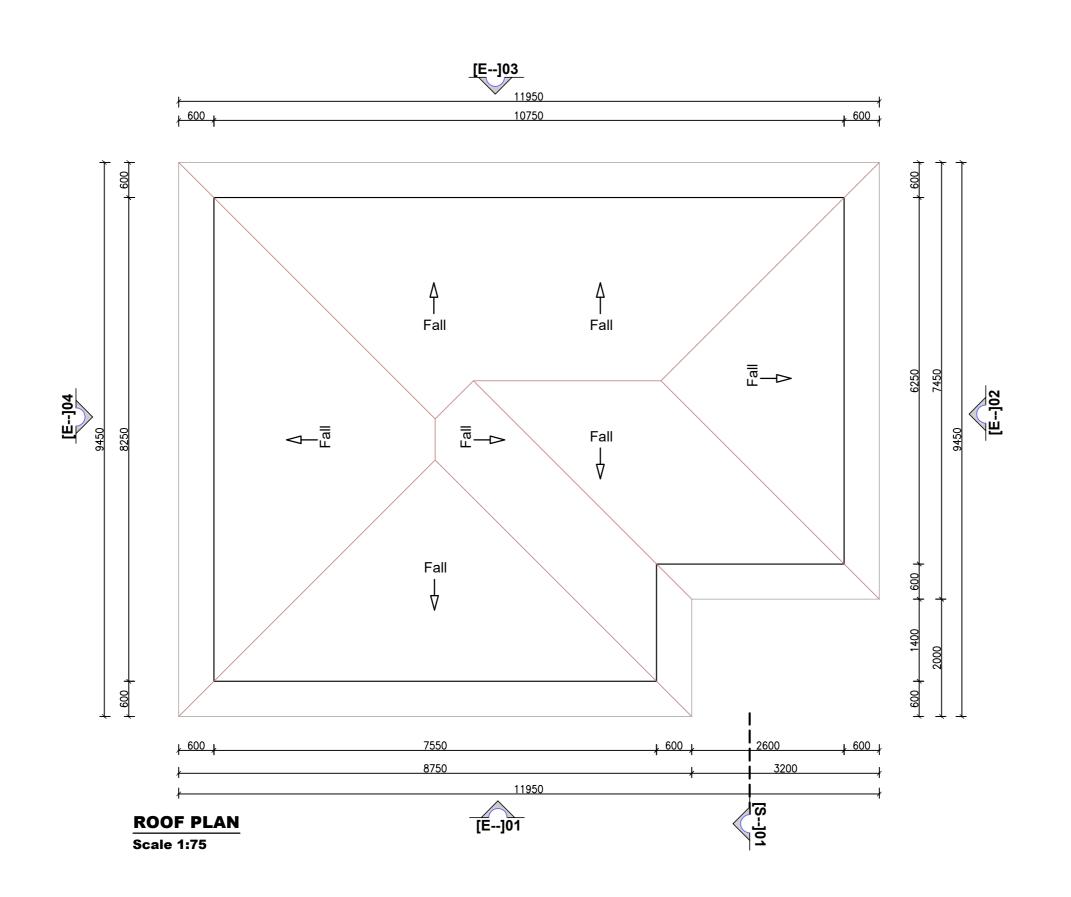

АМ	AMENDMENTS		
No	Date	Revision	
1	7.8.2023	Draft Design	

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- 3. For Site location see Dwg. MWE/GWE/0.0.0
- 4. For Node details, see Dwg. MWE/GWE/5.0.0
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LEGEND



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MINISTRY OF WATER AND ENVIRONMENT
DIRECTORATE OF WATER DEVELOPMENT (DWD)
RURAL WATER SUPPLY AND SANITATION DEPARTMENT
Plot 3 - 7 Kabalega Crescent Road, Luzira, Box 20026 Kampala
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CONSTRUCTION OF GWERE RGC WATER SUPPLY AND SANITATION SYSTEM

Consultant:



Corporate Headquarter 10 Philipot Lane, 1st Floor, London EC3M 8AA, United Kingdom


Drawing Title:

WATER OFFICE BLOCK Roof Plan

Scale:	Designed:	O.R Daniel		
	Drawn:	P.S Eyamu		
Date:	Checked:	O.R Daniel		
Dec-2022	Approved:	O.R Daniel		
ENGINEERING DESIGN DRAWING				

ENGINEERING DESIGN DRAWING

Drg No: MWE/GWE/6.1.2 | Cad file No WSS<22_11>

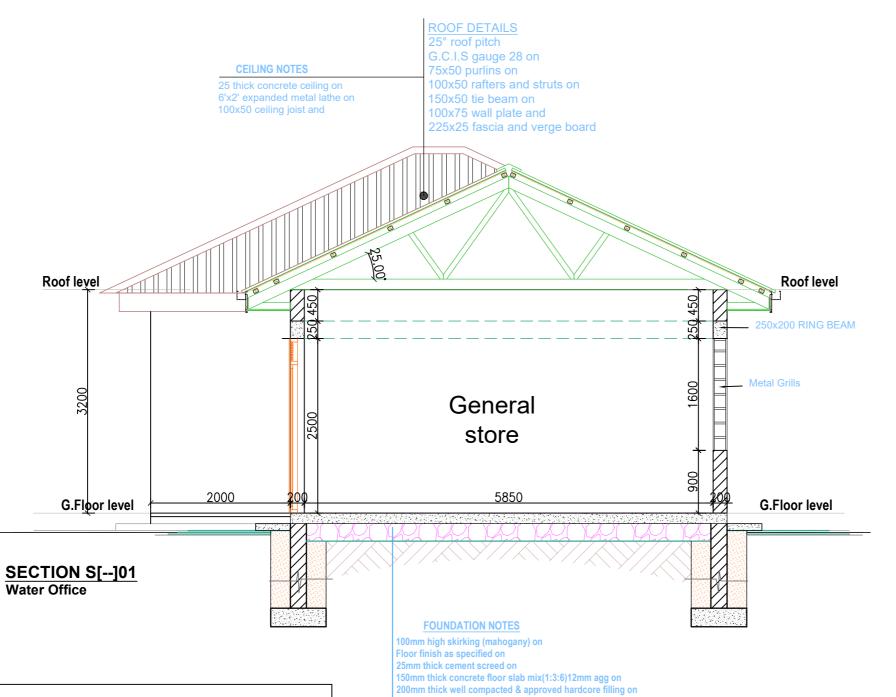

Consolidated murram

690 x230mm concrete strip foundation slab mix(1:3:6)19mm agg in

Levels are to be checked before ground breaking

Well levelled and rammed trenches whose depths are to be determined on site

DOORS AND WINDOWS SCHEDULE				
		DIMENSIONS		
NOTATION	NO	HEIGHT (mm)	WIDTH (mm)	REMARKS
D1	2	1800	2500	Steel casement door with PVO
D2	1	900	2500	Framed Ledge batten doors with PVO
D3	1	800	2500	Framed Ledge batten doors with PVO
W1	6	1500	1600	Steel casement window with PVO
W2	2	2000	1600	Opening with Metal grills

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l	No	Date	Revision
l	1	7.8.2023	Draft Design
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NOTES

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- 4. For Node details, see Dwg. MWE/GWE/5.0.0
- 5. All valves, hydrants and washout locations are identified by marker post in positions.

LEGEND



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MINISTRY OF WATER AND ENVIRONMENT DIRECTORATE OF WATER DEVELOPMENT (DWD)

RURAL WATER SUPPLY AND SANITATION DEPARTMENT

Plot 3 - 7 Kabalega Crescent Road, Luzira, Box 20026 Kampala

Tel : +256 417 889 400, Email: mwe@mwe.go.ug

Website: www.mwe.go.ug

Consultancy Services for the Feability Study, Detailed Engineering Design and Construction Supervision of Solar Powered Piped Water Supply Systems and Sanitation Facilities In Refugee Settlements and Host Districts In West Nile and Northern Uganda

- LOT 1 - MADI OKOLLO, TEREGO AND MOYO DISTRICTS -

CONSTRUCTION OF GWERE RGC WATER **SUPPLY AND SANITATION SYSTEM**

Consultant:




10 Philpot Lane, 1st Floor, London EC3M 8AA,

Drawing Title:

WATER OFFICE BLOCK Section S[01]


Scale:	Designed:	O.R Daniel
	Drawn:	P.S Eyamu
Date:	Checked:	O.R Daniel
Dec-2022	Approved:	O.R Daniel
ENGINEERING DESIGN DRAWING		

Drg No: MWE/GWE/6.1.3 | Cad file No WSS<22_11>

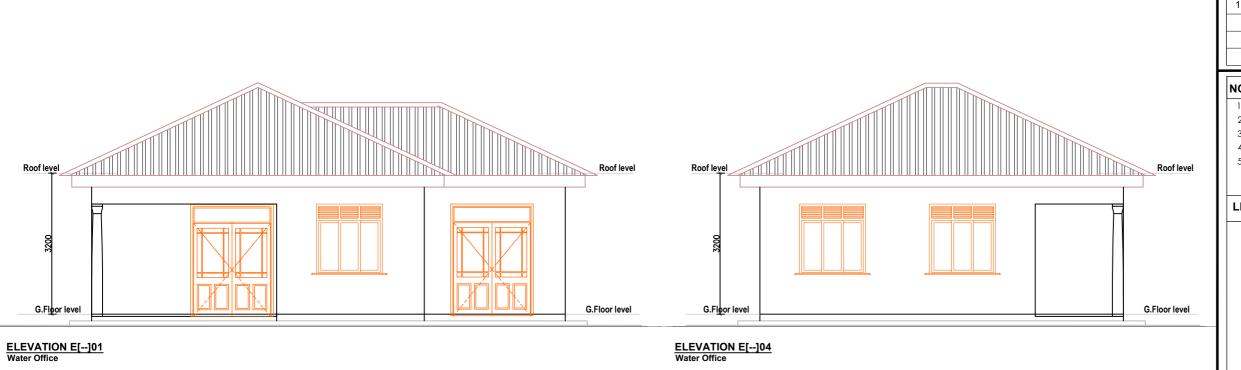

Roof level

G.Floor level

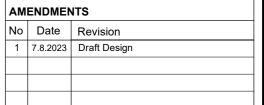

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MINISTRY OF WATER AND ENVIRONMENT DIRECTORATE OF WATER DEVELOPMENT (DWD) RURAL WATER SUPPLY AND SANITATION DEPARTMENT Plot 3 - 7 Kabalega Crescent Road, Luzira, a Dec 20026 Kampala Tel: +256 417 889 400, Emai: mwe@mwe.go.ug

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CONSTRUCTION OF GWERE RGC WATER **SUPPLY AND SANITATION SYSTEM**

Consultant:




10 Philpot Lane, 1st Floor, London EC3M 8AA,

Drawing Title:

WATER OFFICE BLOCK Elevations

Scale:	Designed:	O.R Daniel
	Drawn:	P.S Eyamu
Date:	Checked:	O.R Daniel
Dec-2022	Approved:	O.R Daniel
ENCINEEDING DESIGN DRAWING		


ENGINEERING DESIGN DRAWING Drg No: MWE/GWE/6.1.4 | Cad file No WSS<22_11>

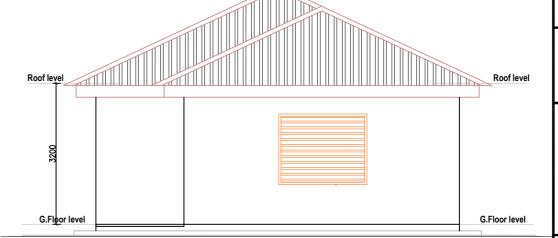

ELEVATION E[--]03 Water Office

G.Floor level

ELEVATION E[--]02

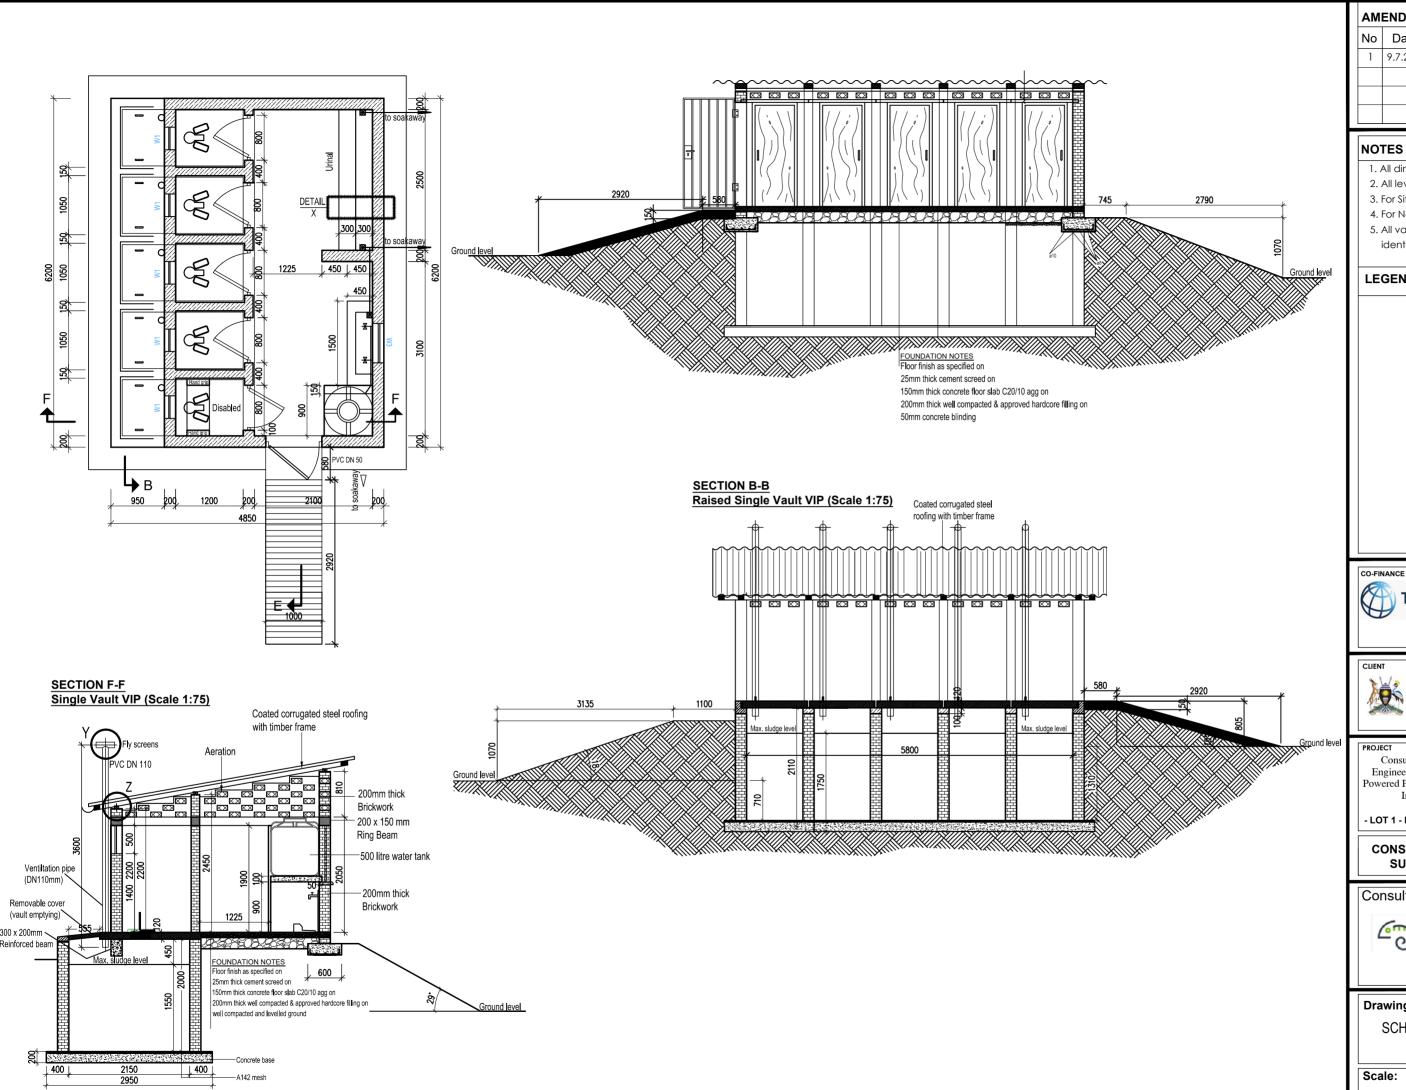

AM	AMENDMENTS			
No	Date	Revision		
1	9.7.2023	Draft Design		

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LEGEND





MINISTRY OF WATER AND ENVIRONMENT
DIRECTORATE OF WATER DEVELOPMENT (DWD)
RURAL WATER SUPPLY AND SANITATION DEPARTMENT
Plot 3 - 7 Kabalega Crescent Road, Luzira, Box 20026 Kampala
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LOT 1 - MADI OKOLLO, TEREGO AND MOYO DISTRICTS -

CONSTRUCTION OF GWERE RGC WATER SUPPLY AND SANITATION SYSTEM

Consultant:



Corporate Headquarter London EC3M 8AA,


Drawing Title:

SCHOOL TOILETS - BOYS AND GIRLS **Boys Toilet**

Scale:	Designed:	O.R Daniel
	Drawn:	P.S Eyamu
Date:	Checked:	O.R Daniel
Dec-2022	Approved:	O.R Daniel
ENGINEEDING DESIGN DRAWING		

ENGINEERING DESIGN DRAWING

Drg No: MWE/GWE/7.1.1 Cad file No WSS<22_11>

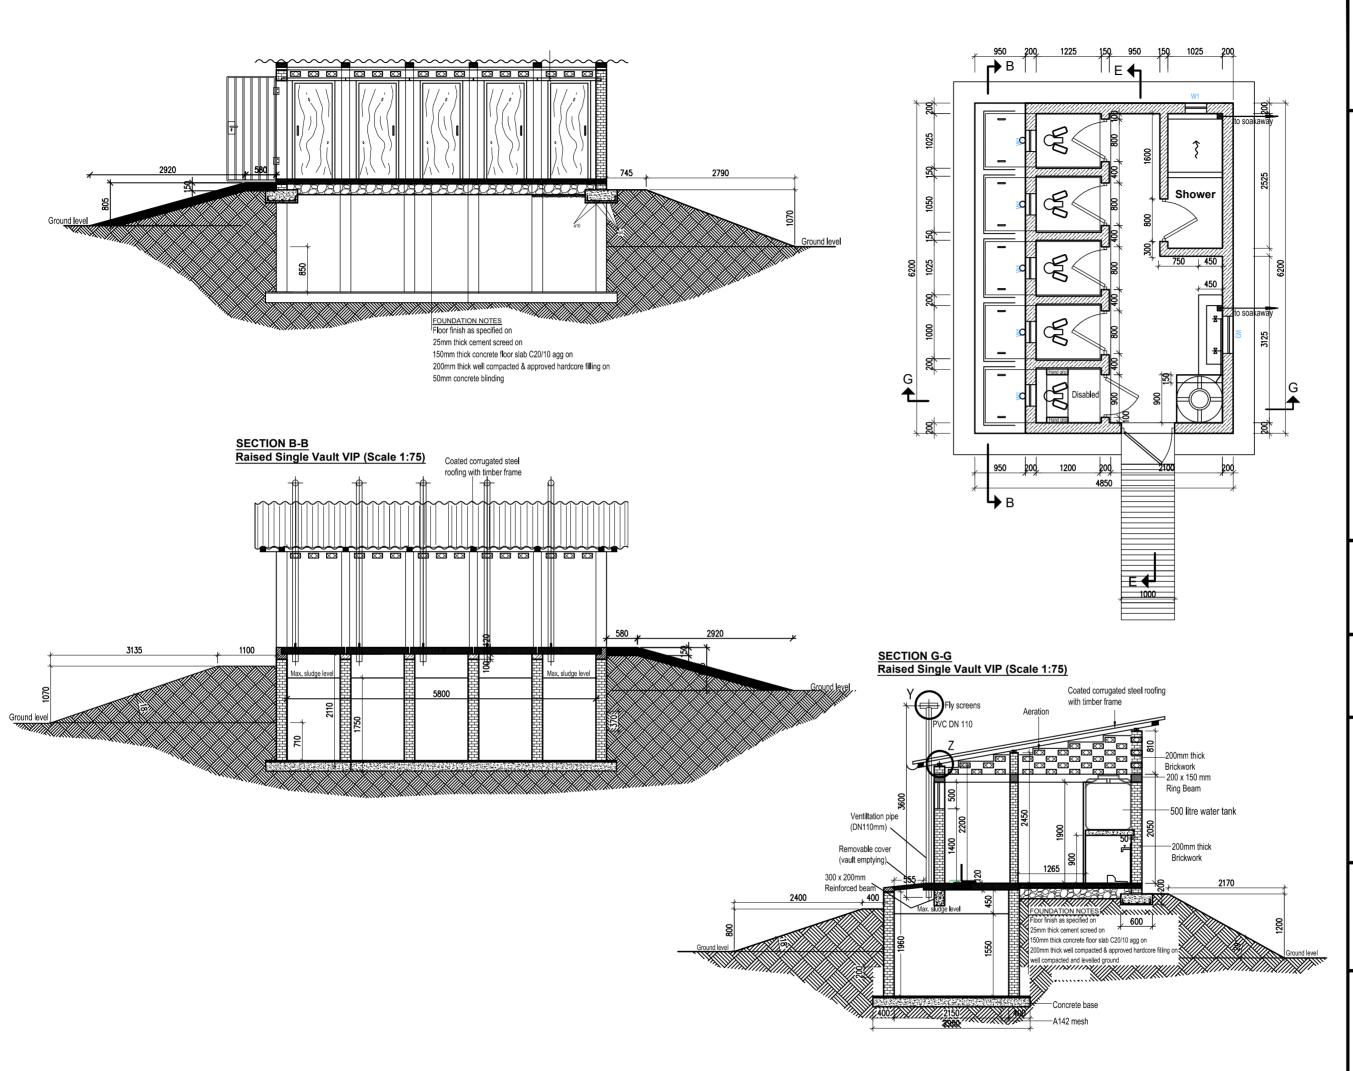

l	AM	AMENDMENTS	
ı	No	Date	Revision
ı	1	9.7.2023	Draft Design
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LEGEND





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DIRECTORATE OF WATER DEVELOPMENT (DWD)
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LOT 1 - MADI OKOLLO, TEREGO AND MOYO DISTRICTS -

CONSTRUCTION OF GWERE RGC WATER SUPPLY AND SANITATION SYSTEM

Consultant:




Corporate Headquarter London EC3M 8AA, United Kingdom

Drawing Title:

SCHOOL TOILETS - BOYS AND GIRLS Girls Toilet

Scale:	Designed:	O.R Daniel
	Drawn:	P.S Eyamu
Date:	Checked:	O.R Daniel
Dec-2022	Approved:	O.R Daniel
ENCINEEDING DESIGN DRAWING		

ENGINEERING DESIGN DRAWING Drg No: MWE/GWE/7.1.2 Cad file No WSS<22_11>

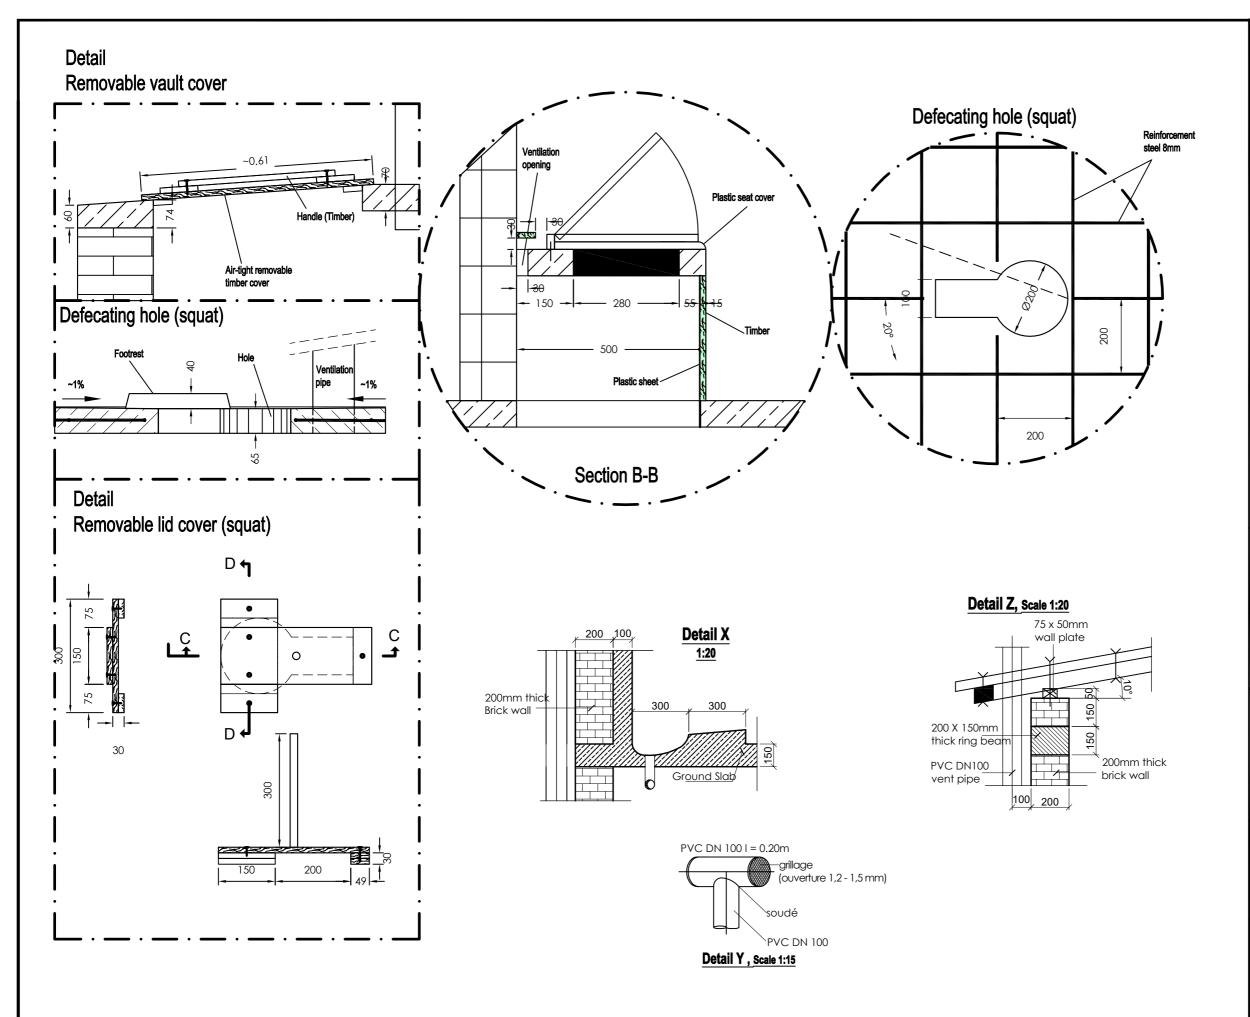

AMENDMENTS		
No	Date	Revision
1	7.8.2023	Draft Design

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MINISTRY OF WATER AND ENVIRONMENT
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RURAL WATER SUPPLY AND SANITATION DEPARTMENT
Plot 3 - 7 Kabalega Crescent Road, Luzira, Box 20026 Kampala
Tel: +256 147 889 400, Email: mwe@mwe.go.ug
Website: www.mwe.go.ug

ROJECT

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- LOT 1 - MADI OKOLLO, TEREGO AND MOYO DISTRICTS -

CONSTRUCTION OF GWERE RGC WATER SUPPLY AND SANITATION SYSTEM

Consultar




Corporate Headquarter 10 Philpot Lane, 1st Floor, London EC3M 8AA, United Kingdom

Drawing Title:

SCHOOL TOILETS - BOYS AND GIRLS Toilets-Details

Scale:	Designed:	O.R Daniel
	Drawn:	P.S Eyamu
Date:	Checked:	O.R Daniel
Dec-2022	Approved:	O.R Daniel
ENGINEERING DESIGN DRAWING		

Drg No: MWE/GWE/7.1.3 | Cad file No WSS<22_11>

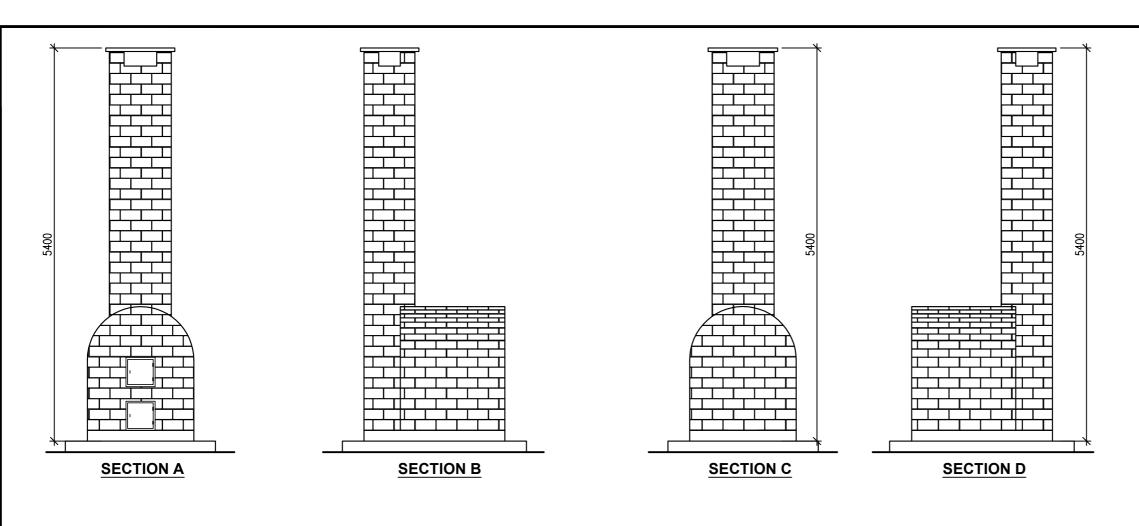

-KAJANSI TYPE BURNT

30mm CAVITY

430mm CAVITY

3 LAYERS **BUTIMEN DPM**

WALL

CLAY BRICK WALL

 $\triangleleft \bigcirc$


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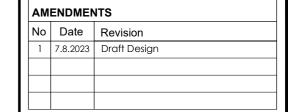
PLAN

100mm CONCRETE

100mm MASS

CONCRETE BASE



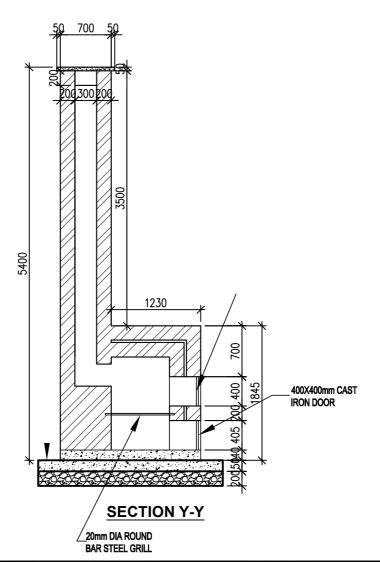

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Consultancy Services for the Feability Study, Detailed Engineering Design and Construction Supervision of Solar Powered Piped Water Supply Systems and Sanitation Facilities In Refugee Settlements and Host Districts In West Nile and Northern Uganda

- LOT 1 - MADI OKOLLO, TEREGO AND MOYO DISTRICTS -

CONSTRUCTION OF GWERE RGC WATER SUPPLY AND SANITATION SYSTEM

Consultant:



Corporate Headquarter 10 Philpot Lane, 1st Floor,


Drawing Title:

SCHOOL TOILETS - BOYS AND GIRLS

Scale:	Designed:	O.R Daniel
	Drawn:	P.S Eyamu
Date:	Checked:	O.R Daniel
Dec-2022	Approved:	O.R Daniel
ENGINEERING DESIGN DRAWING		

20mm HARDCORE FILLING ON WELL COMPACTED GROUND **SECTION X-X** Drg No: MWE/GWE/7.1.4 | Cad file No WSS<22_11>

6 STANCE Single Vault VIP Design (Scale 1:50)

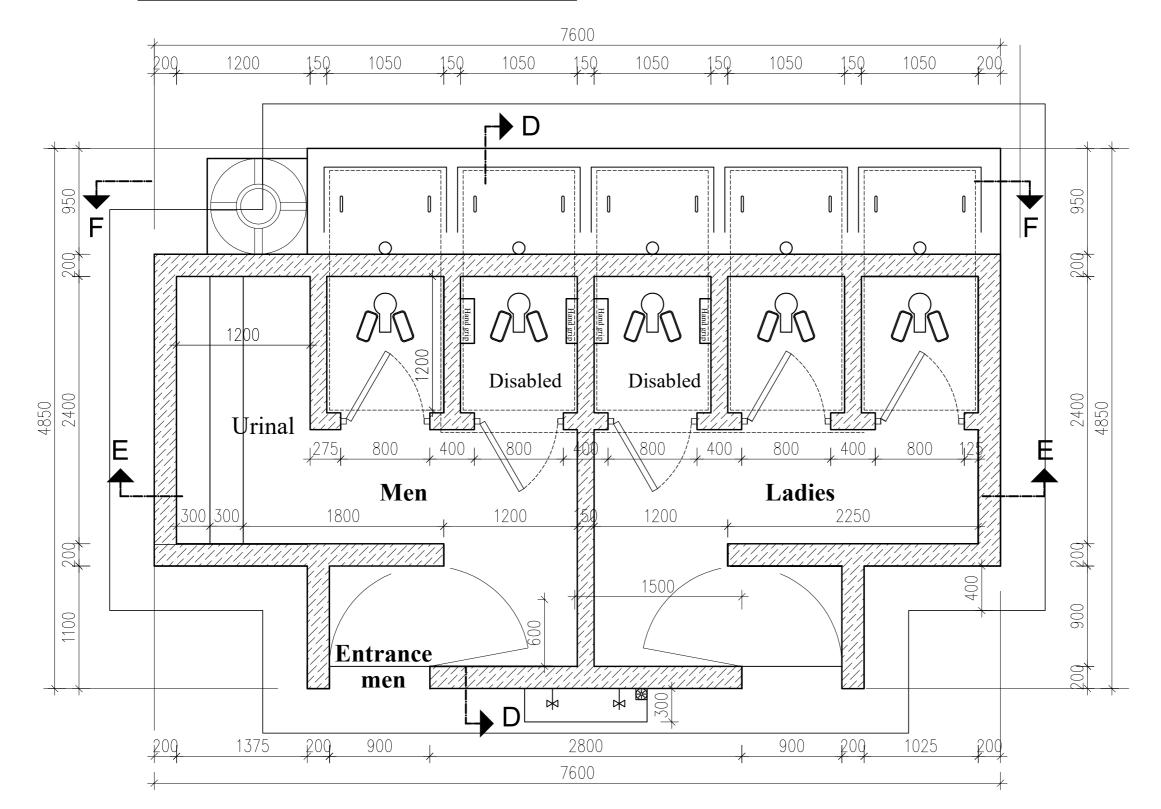

/	AMENDMENTS		
1	No	Date	Revision
	1	7.28.2023	Draft Design

NOTES

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LEGEND



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MINISTRY OF WATER AND ENVIRONMENT
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RURAL WATER SUPPLY AND SANITATION DEPARTMENT
Plot 3 - 7 Kabalega Crescent Road, Luzira, Box 20026 Kampala
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PROJECT

Consultancy Services for the Feability Study, Detailed Engineering Design and Construction Supervision of Solar Powered Piped Water Supply Systems and Sanitation Facilities In Refugee Settlements and Host Districts In West Nile and Northern Uganda

- LOT 1 - MADI OKOLLO, TEREGO AND MOYO DISTRICTS -

CONSTRUCTION OF GWERE RGC WATER SUPPLY AND SANITATION SYSTEM

Consultant:



Corporate Headquarter 10 Philpot Lane, 1st Floor, London EC3M 8AA, United Kingdom

Drawing Title


6 STANCED VIP PUBLIC TOILET Ground Floor Plan

Scale:	Designed:	O.R Daniel
	Drawn:	P.S Eyamu
Date:	Checked:	O.R Daniel
Nov-2022	Approved:	O.R Daniel

ENGINEERING DESIGN DRAWING

Drg No: MWE/GWE/7.2.1 | Cad file No WSS<22_11>

ROOF PLAN -6 STANCE Single Vault Design (Scale 1:75)

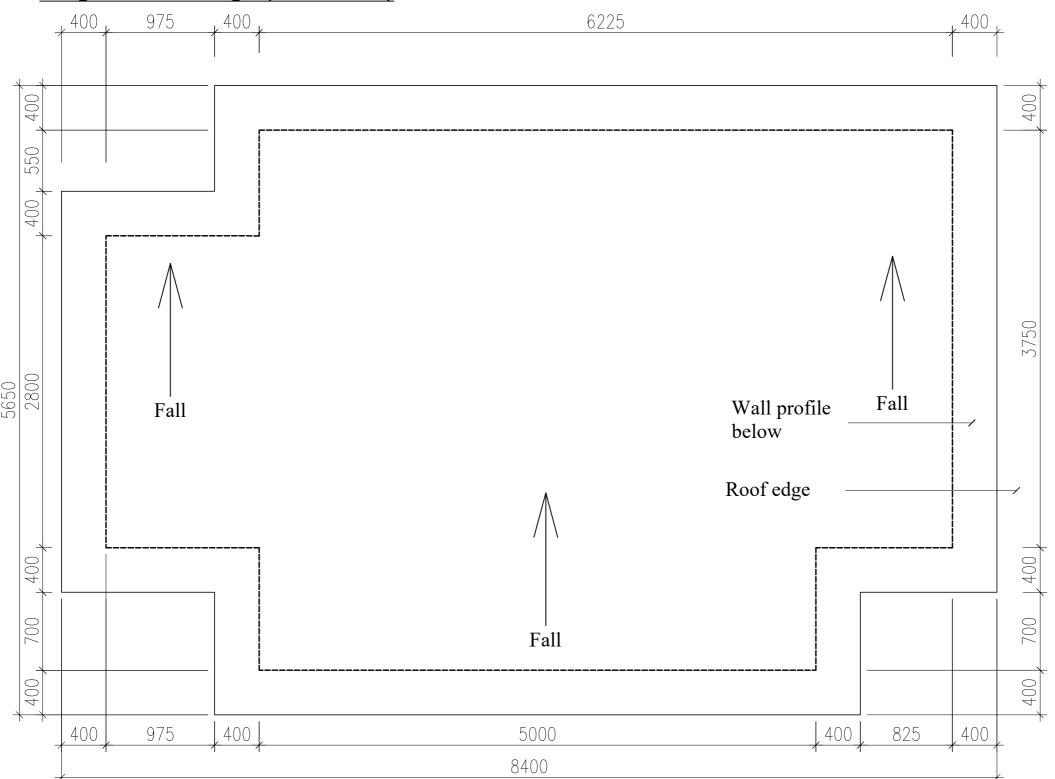

АМ	IENDMENTS		
No	Date	Revision	
1	7.28.2023	Draft Design	

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MINISTRY OF WATER AND ENVIRONMENT
DIRECTORATE OF WATER DEVELOPMENT (DWD)
RURAL WATER SUPPLY AND SANITATION DEPARTMENT
Plot 3 - 7 Kabalega Crescent Road, Luzira, Box 20026 Kampala
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Consultancy Services for the Feability Study, Detailed Engineering Design and Construction Supervision of Solar Powered Piped Water Supply Systems and Sanitation Facilities In Refugee Settlements and Host Districts In
West Nile and Northern Uganda

- LOT 1 - MADI OKOLLO, TEREGO AND MOYO DISTRICTS -

CONSTRUCTION OF GWERE RGC WATER SUPPLY AND SANITATION SYSTEM

Consultant:




Corporate Headquarter 10 Philpot Lane, 1st Floor, London EC3M 8AA,

6 STANCED VIP PUBLIC TOILET Roof Plan

Scale:	Designed:	O.R Daniel
	Drawn:	P.S Eyamu
Date:	Checked:	O.R Daniel
Nov-2022	Approved:	O.R Daniel

ENGINEERING DESIGN DRAWING

Drg No: MWE/GWE/7.2.2 | Cad file No WSS<22_11>

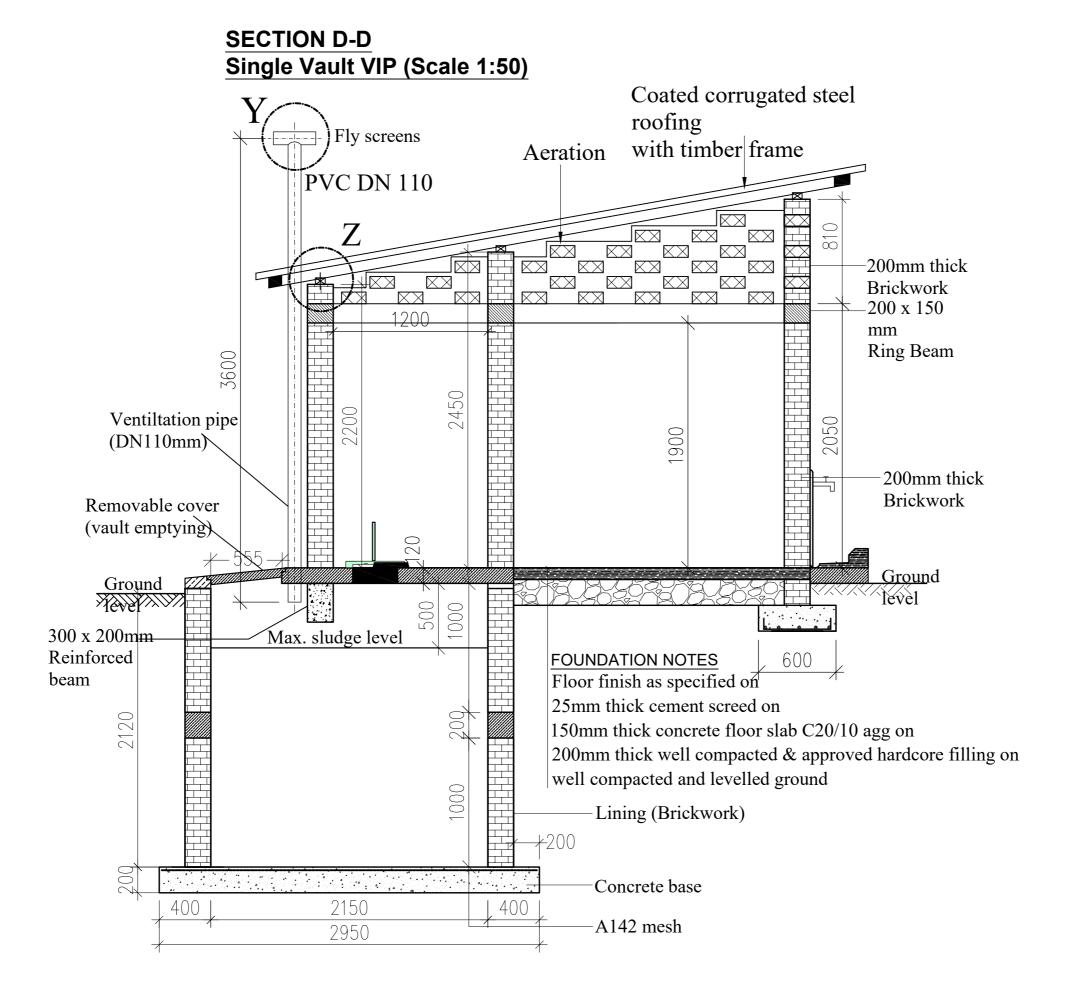

AMENDMENTS No Date Revision 1 7.28.2023 Draft Design

NOTES

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LEGEND



GOVERNMENT OF UGANDA

MINISTRY OF WATER AND ENVIRONMENT
DIRECTORATE OF WATER DEVELOPMENT (DWD)
RURAL WATER SUPPLY AND SANITATION DEPARTMENT
Plot3 - 7 Kabalega Crescent Road, Luzira, Box 20026 Kampala
Tel: +256 417 889 400, Emali: mwe@mwe.go.ug

PROJECT

Consultancy Services for the Feability Study, Detailed Engineering Design and Construction Supervision of Solar Powered Piped Water Supply Systems and Sanitation Facilities In Refugee Settlements and Host Districts In West Nile and Northern Uganda

- LOT 1 - MADI OKOLLO, TEREGO AND MOYO DISTRICTS

CONSTRUCTION OF GWERE RGC WATER SUPPLY AND SANITATION SYSTEM

Consultant:




Corporate Headquarter 10 Philpot Lane, 1st Floor, London EC3M 8AA, United Kingdom

Drawing Title:

6 STANCED VIP PUBLIC TOILET Section D_D

Scale:	Designed:	O.R Daniel
	Drawn:	P.S Eyamu
Date:	Checked:	O.R Daniel
Nov-2022	Approved:	O.R Daniel
ENGINEERING DESIGN DRAWING		

Drg No: MWE/GWE/7.2.3 | Cad file No WSS<22 11>

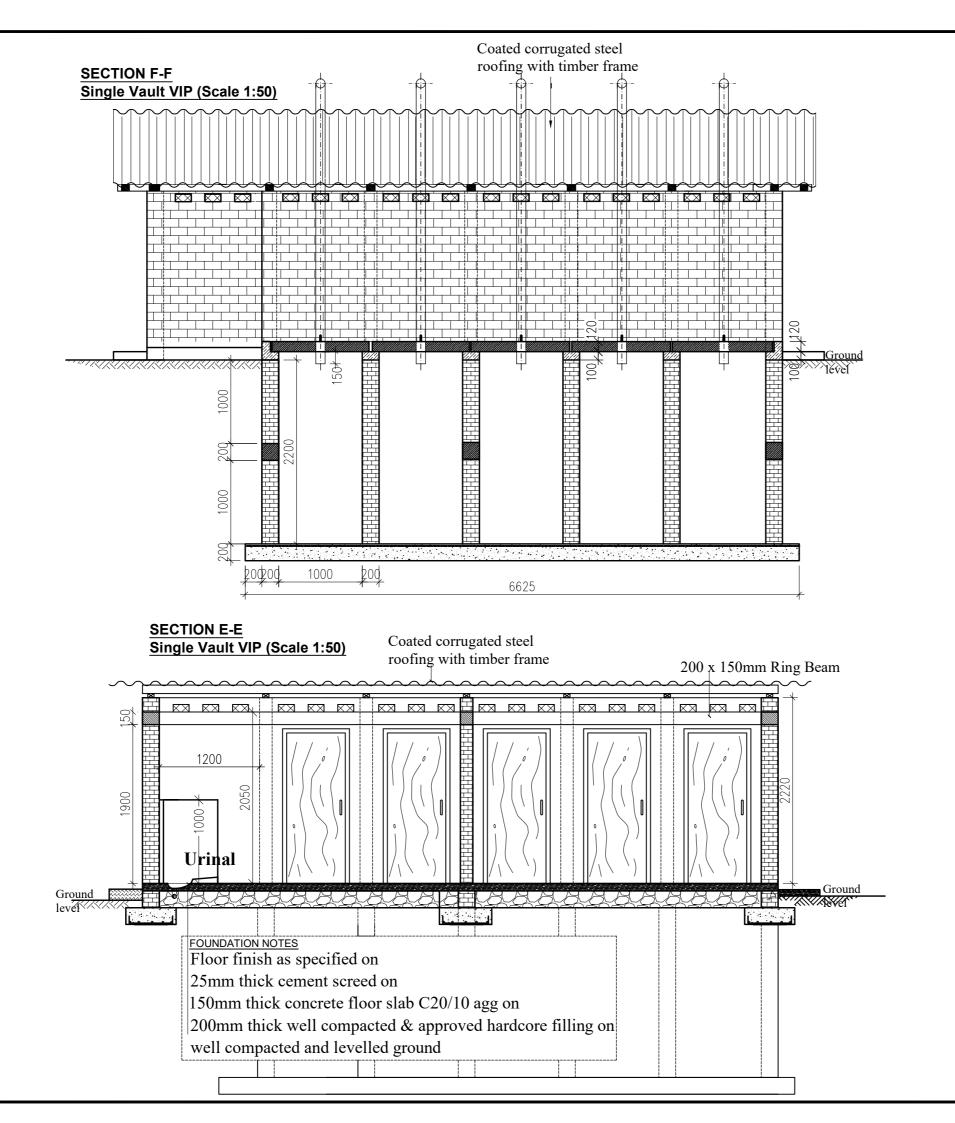

AMENDMENTS No Date Revision 1 7.28.2023 Draft Design

NOTES

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- 3. For Site location see Dwg. MWE/GWE/0.0.0
- 4. For Node details, see Dwg. MWE/GWE/5.0.0
- 5. All valves, hydrants and washout locations are identified by marker post in positions.

LEGEND





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PROJECT

Consultancy Services for the Feability Study, Detailed Engineering Design and Construction Supervision of Solar Powered Piped Water Supply Systems and Sanitation Facilities In Refugee Settlements and Host Districts In West Nile and Northern Uganda

- LOT 1 - MADI OKOLLO, TEREGO AND MOYO DISTRICTS -

CONSTRUCTION OF GWERE RGC WATER SUPPLY AND SANITATION SYSTEM

Consultant:



Corporate Headquarter 10 Philpot Lane, 1st Floor, London EC3M 8AA, United Kingdom


rawing Title:

6 STANCED VIP PUBLIC TOILET Section E_E and Section F_F

Scale:	Designed:	O.R Daniel
	Drawn:	P.S Eyamu
Date:	Checked:	O.R Daniel
Nov-2022	Approved:	O.R Daniel

ENGINEERING DESIGN DRAWING

Drg No: MWE/GWE/7.2.4 | Cad file No WSS<22_11>

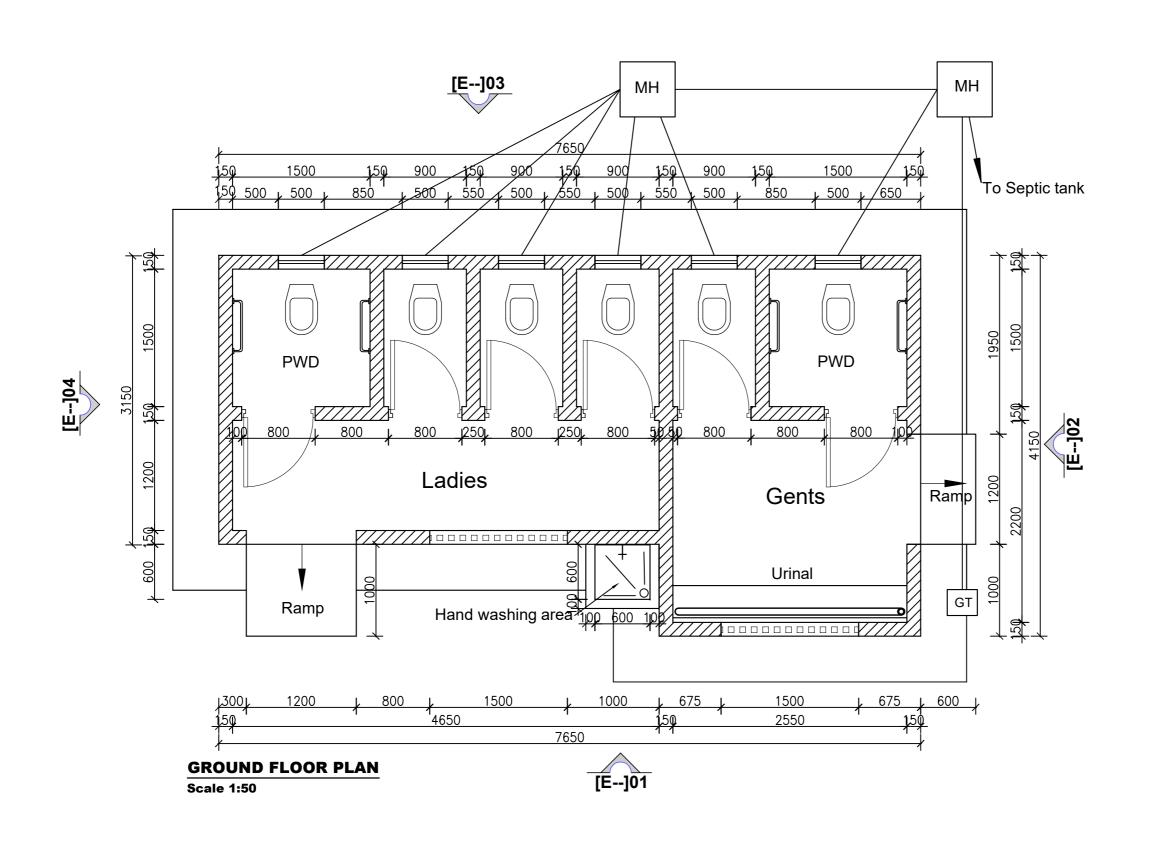

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No	Date	Revision
1	7.8.2023	Draft Design

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MINISTRY OF WATER AND ENVIRONMENT DIRECTORATE OF WATER DEVELOPMENT (DWD) RURAL WATER SUPPLY AND SANITATION DEPARTMENT Plot 3 - 7 Kabalega Crescent Road, Luzira, Box 20026 Kampala Tel: +256 417 889 400, Email: mwe@mwe.go.ug

PROJEC

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- LOT 1 - MADI OKOLLO, TEREGO AND MOYO DISTRICTS -

CONSTRUCTION OF GWERE RGC WATER SUPPLY AND SANITATION SYSTEM

Consultant:




Corporate Headquarter
10 Philpot Lane, 1st Floor,
London EC3M 8AA,
United Kingdom

Drawing Title:

6 STANCES WATERBORNE PUBLIC TOILET
Ground Floor Plan

Scale:	Designed:	O.R Daniel
	Drawn:	P.S Eyamu
Date:	Checked:	O.R Daniel
Dec-2022	Approved:	O.R Daniel
ENGINEERING DESIGN DRAWING		

Drg No: MWE/GWE/7.3.1 | Cad file No WSS<22_11>

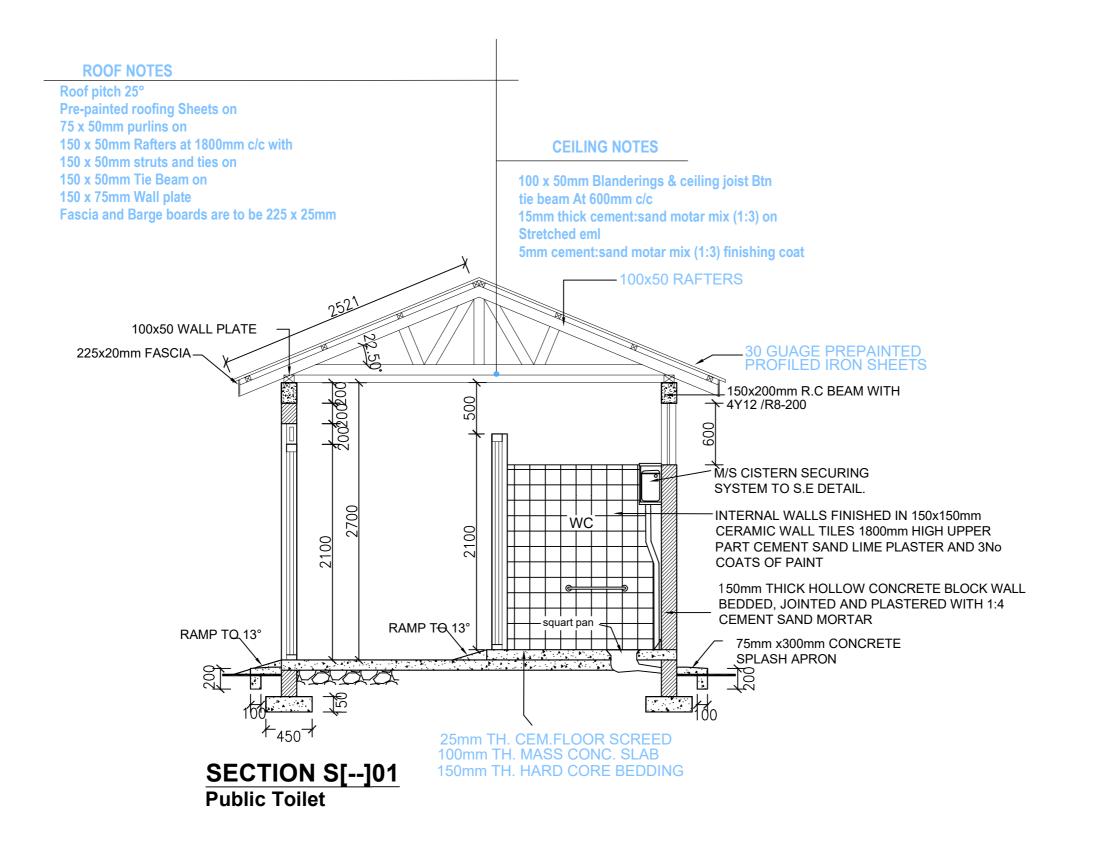

AMENDMENTS No Date Revision 1 7.8.2023 Draft Design

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MINISTRY OF WATER AND ENVIRONMENT
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RURAL WATER SUPPLY AND SANITATION DEPARTMENT
Plot 3 - 7 Kabalega Crescent Road, Luzira, Box 20026 Kampala
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- LOT 1 - MADI OKOLLO, TEREGO AND MOYO DISTRICTS -

CONSTRUCTION OF GWERE RGC WATER SUPPLY AND SANITATION SYSTEM

Consultant:




Corporate Headquarte 10 Philpot Lane, 1st Floor, London EC3M 8AA, United Kingdom


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6 STANCES WATERBORNE PUBLIC TOILET
Section L[S-01]


Scale:	Designed:	O.R Daniel
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Dec-2022	Approved:	O.R Daniel
ENGINEERING DESIGN DRAWING		

Drg No: MWE/GWE/7.3.2 | Cad file No WSS<22_11>




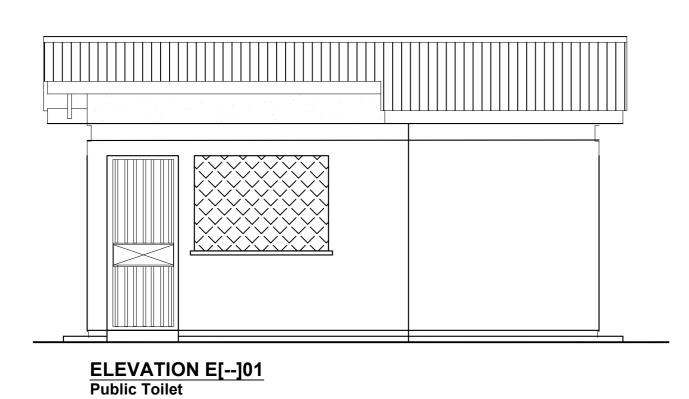

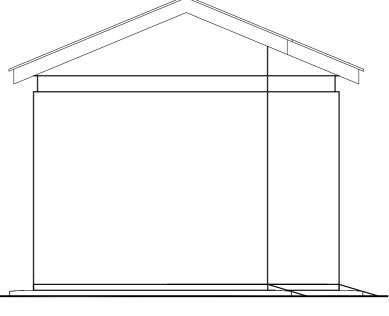

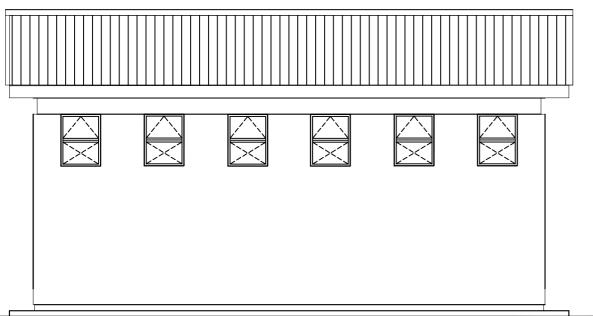



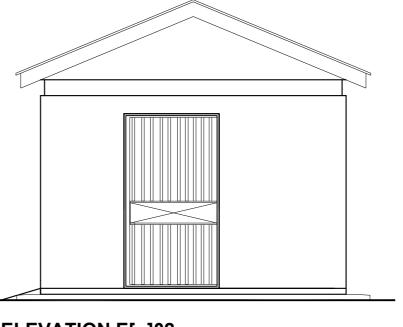

ELEVATION E[--]02
Public Toilet

ı	AM	AMENDMENTS		
ı	No	Date	Revision	
ı	1	7.8.2023	Draft Design	
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MINISTRY OF WATER AND ENVIRONMENT DIRECTORATE OF WATER DEVELOPMENT (DWD) RURAL WATER SUPPLY AND SANITATION DEPARTMENT Plot 3 - 7 Kabalega Crescent Road, Luzira, Box 20026 Kampala Tel: +256 417 889 400, Emai: mwe@mwe.go.ug

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CONSTRUCTION OF GWERE RGC WATER SUPPLY AND SANITATION SYSTEM

Consultant:



Corporate Headquarter 10 Philpot Lane, 1st Floor, London EC3M 8AA, United Kingdom


Drawing Title:

6 STANCES WATERBORNE PUBLIC TOILET Elevations

Scale:	Designed:	O.R Daniel
	Drawn:	P.S Eyamu
Date:	Checked:	O.R Daniel
Dec-2022	Approved:	O.R Daniel
ENCINEEDING DECICAL DRAWING		

ENGINEERING DESIGN DRAWING

Drg No: MWE/GWE/7.3.3 | Cad file No WSS<22_11>

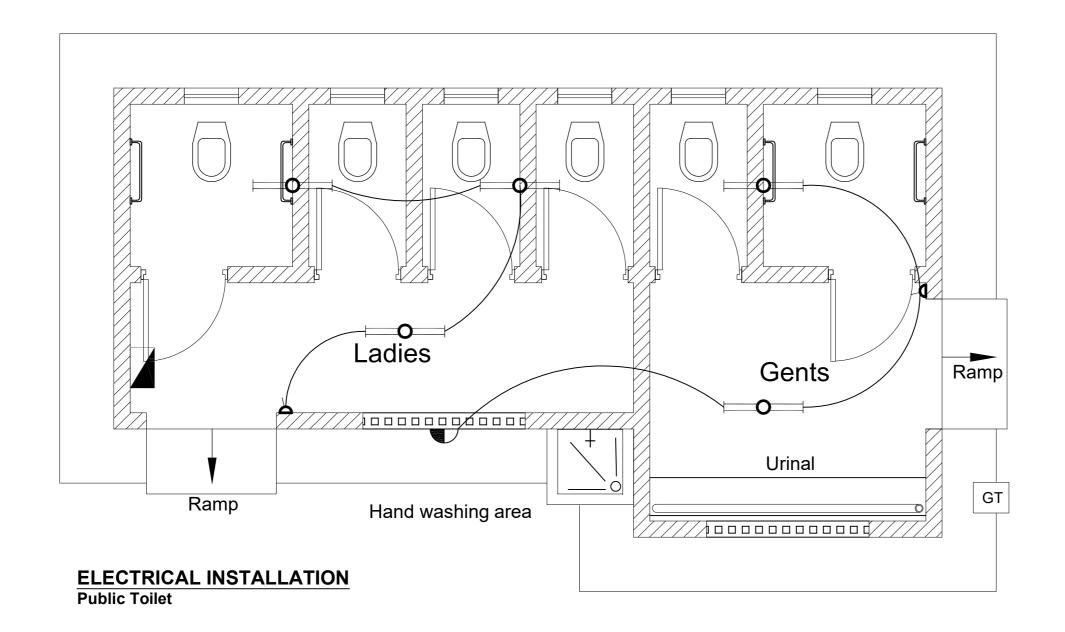

AMENDMENTS		
No	Date	Revision
1	7.8.2023	Draft Design

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MINISTRY OF WATER AND ENVIRONMENT DIRECTORATE OF WATER DEVELOPMENT (DWD) RURAL WATER SUPPLY AND SANITATION DEPARTMENT Plot 3 - 7 Kabalega Crescent Road, Luzira, a Dec 20026 Kampala Tel: +256 417 889 400, Emai: mwe@mwe.go.ug

Consultancy Services for the Feability Study, Detailed Engineering Design and Construction Supervision of Solar Powered Piped Water Supply Systems and Sanitation Facilities
In Refugee Settlements and Host Districts In
West Nile and Northern Uganda
- LOT 1 - MADI OKOLLO, TEREGO AND MOYO DISTRICTS -

CONSTRUCTION OF GWERE RGC WATER **SUPPLY AND SANITATION SYSTEM**

Consultant:




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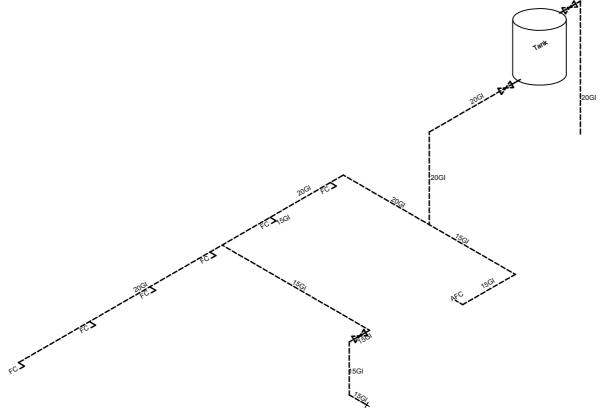
6 STANCES WATERBORNE PUBLIC TOILET Electrical Installation

Scale:	Designed:	O.R Daniel
	Drawn:	P.S Eyamu
Date:	Checked:	O.R Daniel
Dec-2022	Approved:	O.R Daniel
ENGINEEDING DESIGN DRAWING		

ENGINEERING DESIGN DRAWING

Drg No: MWE/GWE/7.3.4 | Cad file No WSS<22_11>



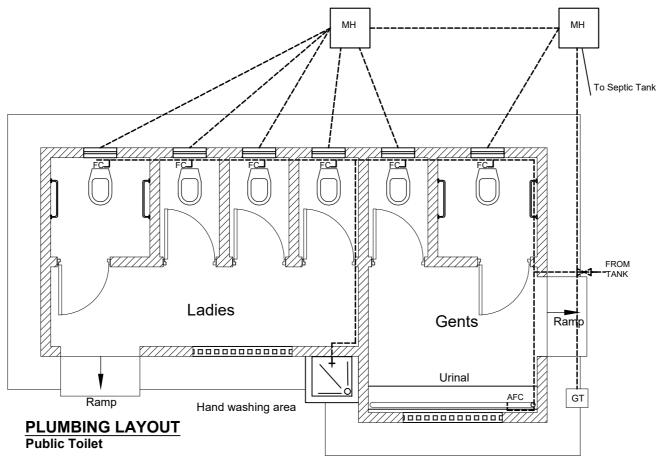

ISOMETRIC VIEW-WATER PIPE LAYOUT

	AMENDMENTS		
l	No	Date	Revision
l	1	7.8.2023	Draft Design
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l			

NOTES

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- 4. For Node details, see Dwg. MWE/GWE/5.0.0 5. All valves, hydrants and washout locations are identified by marker post in positions.

LEGEND





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MINISTRY OF WATER AND ENVIRONMENT DIRECTORATE OF WATER DEVELOPMENT (DWD) RURAL WATER SUPPLY AND SANITATION DEPARTMENT Plot 3 - 7 Kabalega Crescent Road, Luzira, Box 20026 Kampala Tel: +256 417 889 400, Emai: mwe@mwe.go.ug

Consultancy Services for the Feability Study, Detailed Engineering Design and Construction Supervision of Solar Powered Piped Water Supply Systems and Sanitation Facilities In Refugee Settlements and Host Districts In
West Nile and Northern Uganda
- LOT 1 - MADI OKOLLO, TEREGO AND MOYO DISTRICTS -

CONSTRUCTION OF GWERE RGC WATER SUPPLY AND SANITATION SYSTEM

Consultant:




Drawing Title:

6 STANCES WATERBORNE PUBLIC TOILET Plumbing Layout


Scale:	Designed:	O.R Daniel		
	Drawn:	P.S Eyamu		
Date:	Checked:	O.R Daniel		
Dec-2022	Approved:	O.R Daniel		
ENGINEERING DESIGN DRAWING				

ENGINEERING DESIGN DRAWING

Drg No: MWE/GWE/7.3.5 | Cad file No WSS<22_11>

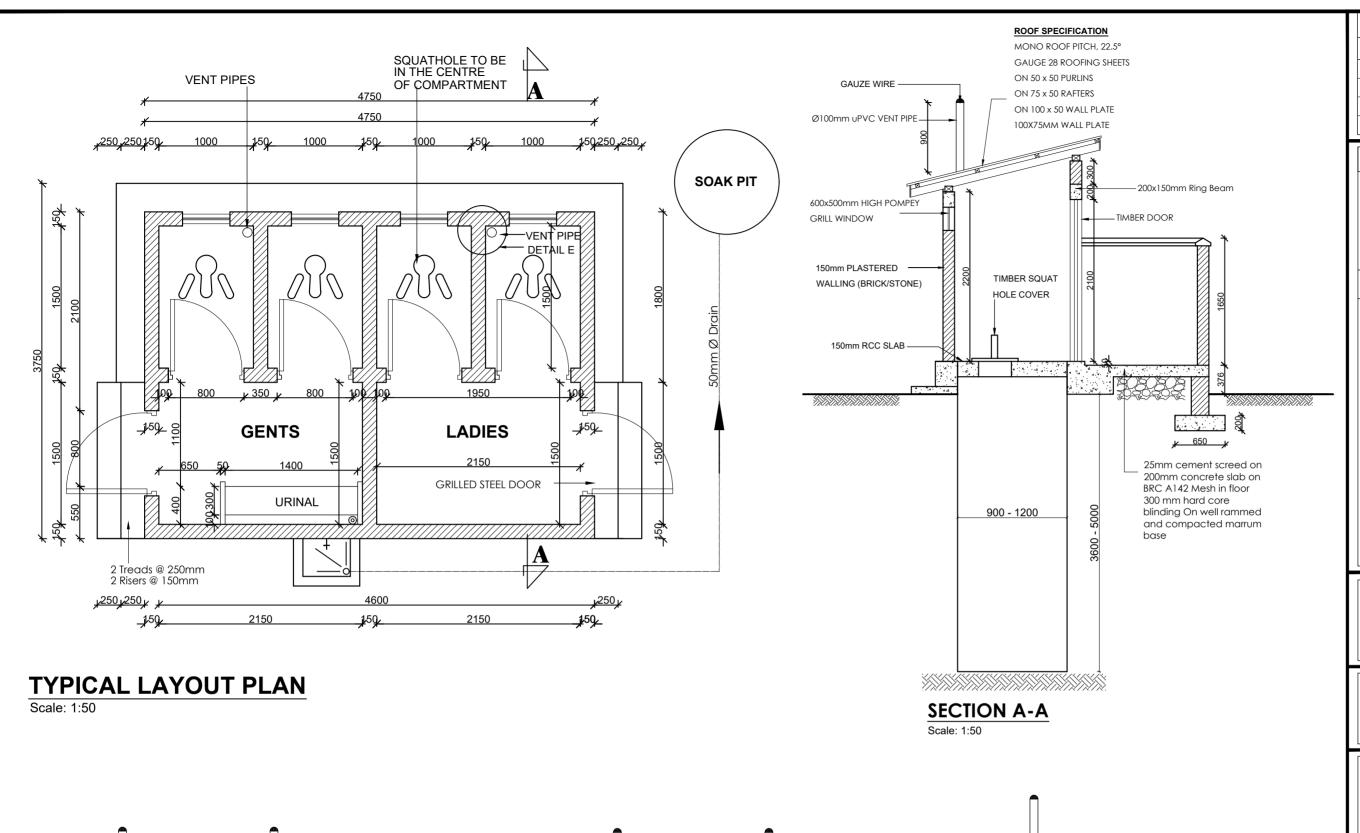

FRONT VIEW

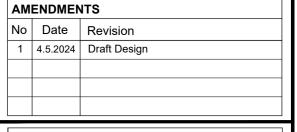

NOTES

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LEGEND







MINISTRY OF WATER AND ENVIRONMENT DIRECTORATE OF WATER DEVELOPMENT (DWD)
RURAL WATER SUPPLY AND SANITATION DEPARTMENT
Plot 3 - 7 Kabalega Crescent Road, Luzira, Box 2020 & Kampala
15 : +256 417 889 400, Email: mwe@mwe.go.ug

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Consultant:




Drawing Title:

4-STANCE STAFF TOILET PLAN, ELEVATION AND SECTION

Scale:	Designed:	O.R Daniel	
	Drawn:	P.S Eyamu	
Date:	Checked:	O.R Daniel	
Dec-2022	Approved:	O.R Daniel	
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ENGINEERING DESIGN DRAWING Drg No: MWE/GWE/7.4.1 | Cad file No WSS<22_11>

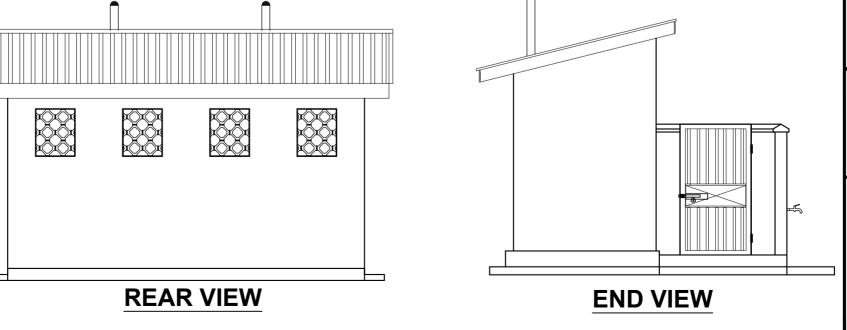

STANDARD DRAWINGS

GENERAL NOTES FOR STANDARD DETAIL DRAWINGS

- Unless flexibility is otherwise provided, where pipes enter or leave concrete structures, or anchor blocks, flexible joints are to be provided as shown in standard Detail Nr SD 137.
- Anchor block designs are based on the following ground conditions. 2)

1800 kg/m ³ Dry soil density:

Submerged soil density: 1090 kg/m ³

Angle of internal friction:

30°

Passive resistance factor:

3

Where considerably better ground conditions, such as rock, are encountered, the dimensions of anchor blocks may be reduced. Supporting calculations for any reduced size anchor blocks must be submitted to the Project Manager 48 hours before construction of the particular anchor block commences and may be concreted only after his approval.

- Bases and thrust faces of anchor blocks are to be cast against undisturbed ground, or against blinding cast against undisturbed ground.
- Pipework joints as shown for the water supply details are diagrammatic only.
- The following notes apply to reinforced concrete chambers. 5)
 - Concrete in walls and base and cover slab

Characteristic strength (N/mm)²: 30

Maximum aggregate size (mm): 20

Cement type:

330 Minimum cement content (kg/m):

Maximum cement content (kg/m): 400

Maximum free water/cement ratio: 0.47

Concrete in blinding

Characteristic strength (N/mm)²: 1030

Maximum aggregate size (mm): 40

Cement type:

Minimum cement content (kg/m): 230

Cover to reinforcement 40mm unless positioned centrally

- Minimum reinforcement lap 300 mm d)
- For details of step irons see Standard Detail Nr SD 136
- Corners of rectangular openings to have T8 bars 500 mm long set diagonally
- All dimensions are in millimetres unless shown otherwise.
- Do not scale dimensions from standard Detail drawings. 7)

AM	AMENDMENTS				
No	Date	Revision			
1	7.8.2023	Draft Design			

NOTES

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LEGEND





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MINISTRY OF WATER AND ENVIRONMENT DIRECTORATE OF WATER DEVELOPMENT (DWD)

RURAL WATER SUPPLY AND SANITATION DEPARTMENT

Plot 3 - 7 Kabalega Crescent Road, Luzira, Box 20026 Kampala

Tel : +256 417 889 400, Email: mwe@mwe.go.ug

Website: www.mwe.go.ug

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- LOT 1 - MADI OKOLLO, TEREGO AND MOYO DISTRICTS -

CONSTRUCTION OF GWERE RGC WATER **SUPPLY AND SANITATION SYSTEM**

Consultant:




10 Philpot Lane, 1st Floor, London EC3M 8AA,


Drawing Title:

STANDARD DRAWINGS General Notes

Scale:	Designed:	O.R Daniel P.S Eyamu	
	Drawn:		
Date:	Checked:	O.R Daniel	
Dec-2022	Approved:	O.R Daniel	
ENGINEEDING DESIGN DRAWING			

Drg No: MWE/GWE/SD100 Cad file No WSS<22_11>

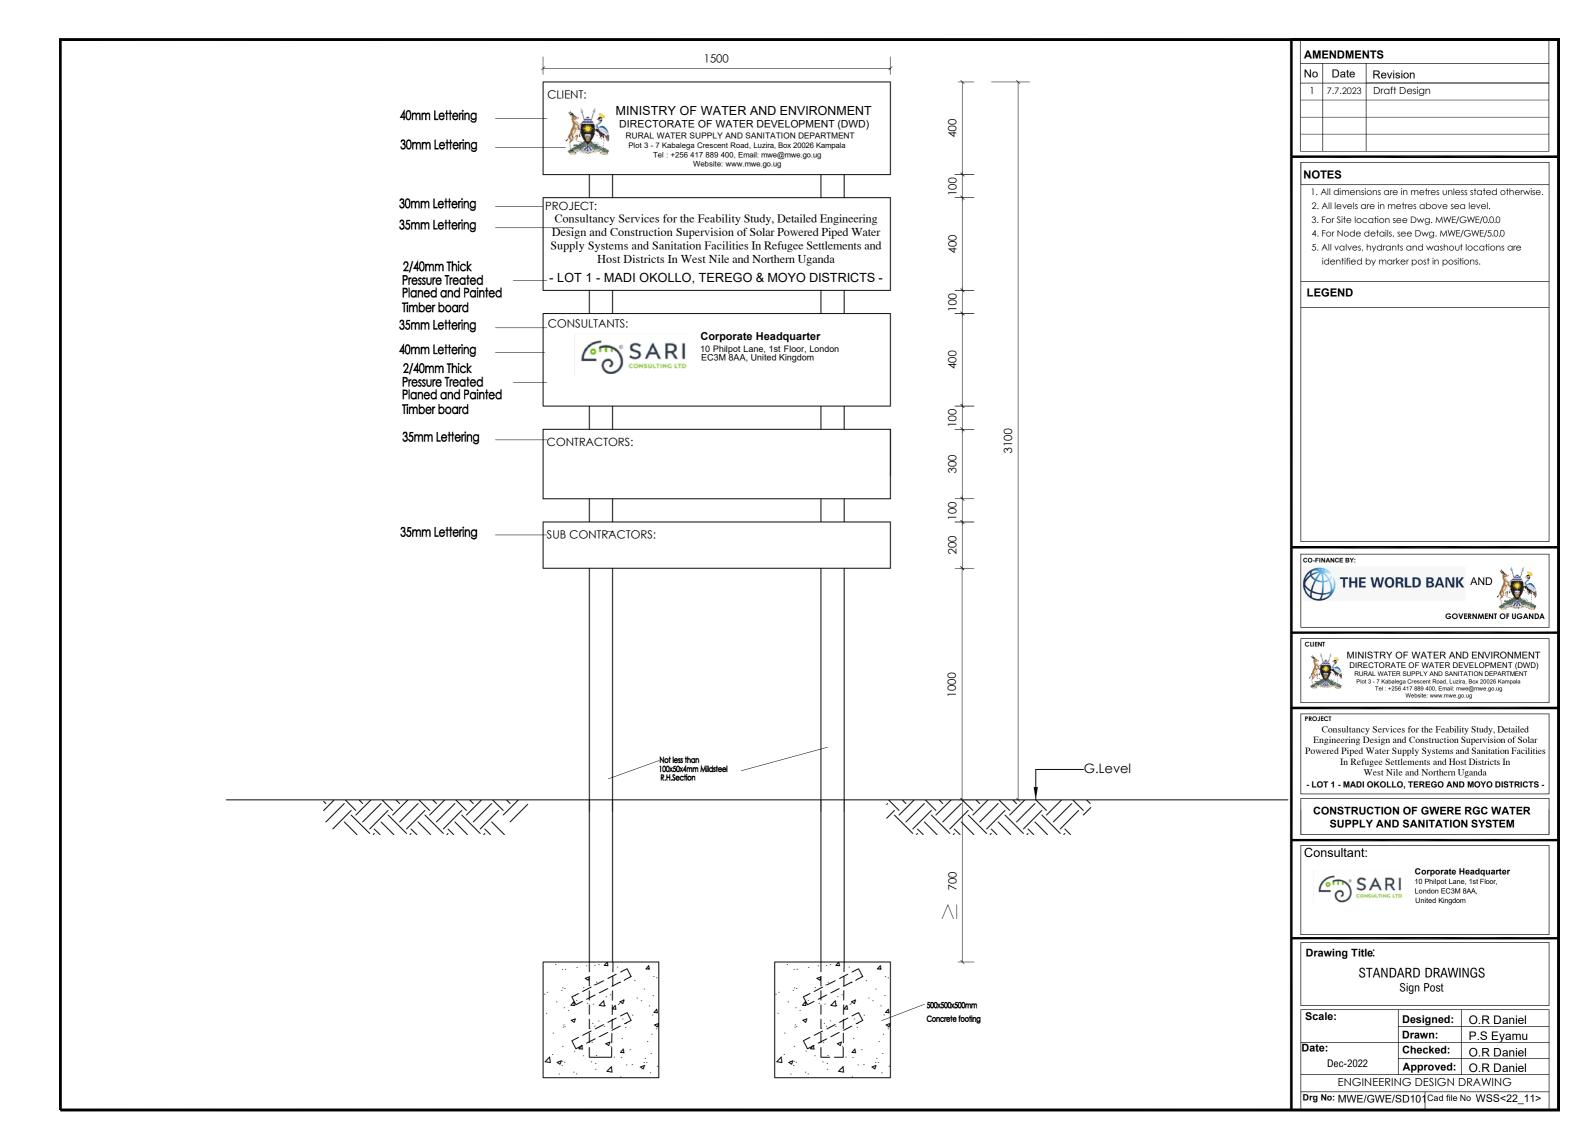

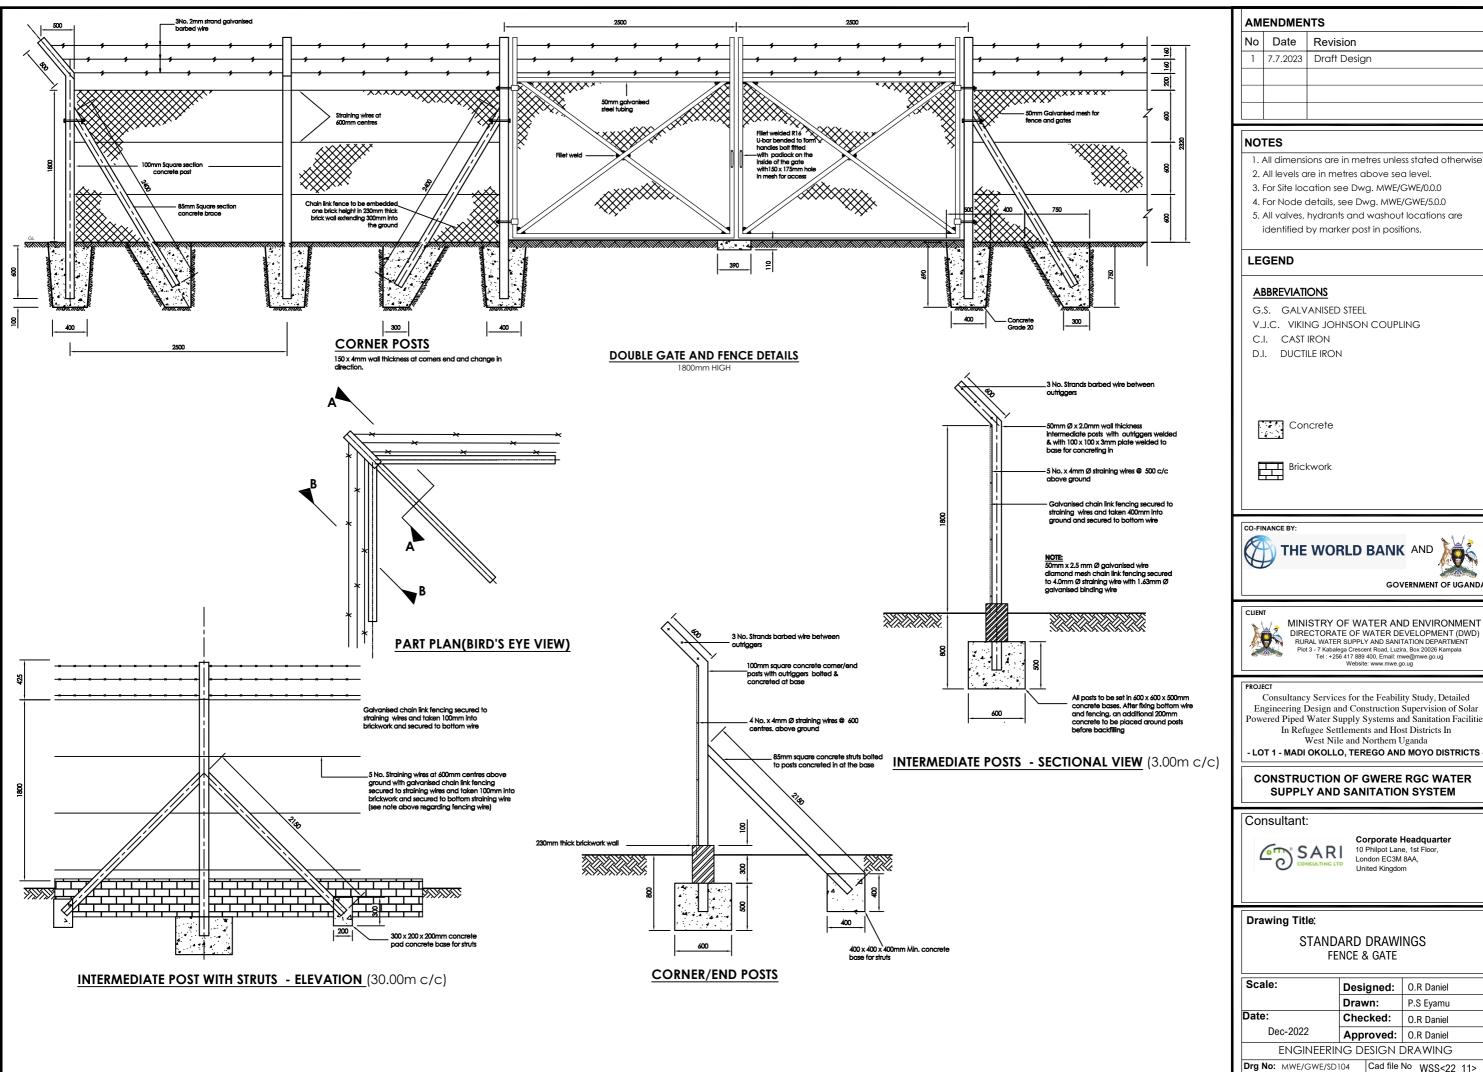

AMENDMENTS		
No	Date	Revision
1	7.7.2023	Draft Design

- 1. All dimensions are in metres unless stated otherwise.
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- 5. All valves, hydrants and washout locations are



MINISTRY OF WATER AND ENVIRONMENT

Consultancy Services for the Feability Study, Detailed Engineering Design and Construction Supervision of Solar Powered Piped Water Supply Systems and Sanitation Facilities In Refugee Settlements and Host Districts In


LOT 1 - MADI OKOLLO, TEREGO AND MOYO DISTRICTS -

SUPPLY AND SANITATION SYSTEM

Corporate Headquarter 10 Philpot Lane, 1st Floor, London EC3M 8AA,

STANDARD DRAWINGS

Scale:	Designed:	O.R Daniel
	Drawn:	P.S Eyamu
Date:	Checked:	O.R Daniel
Dec-2022	Approved:	O.R Daniel
ENGINEERI	DRAWING	

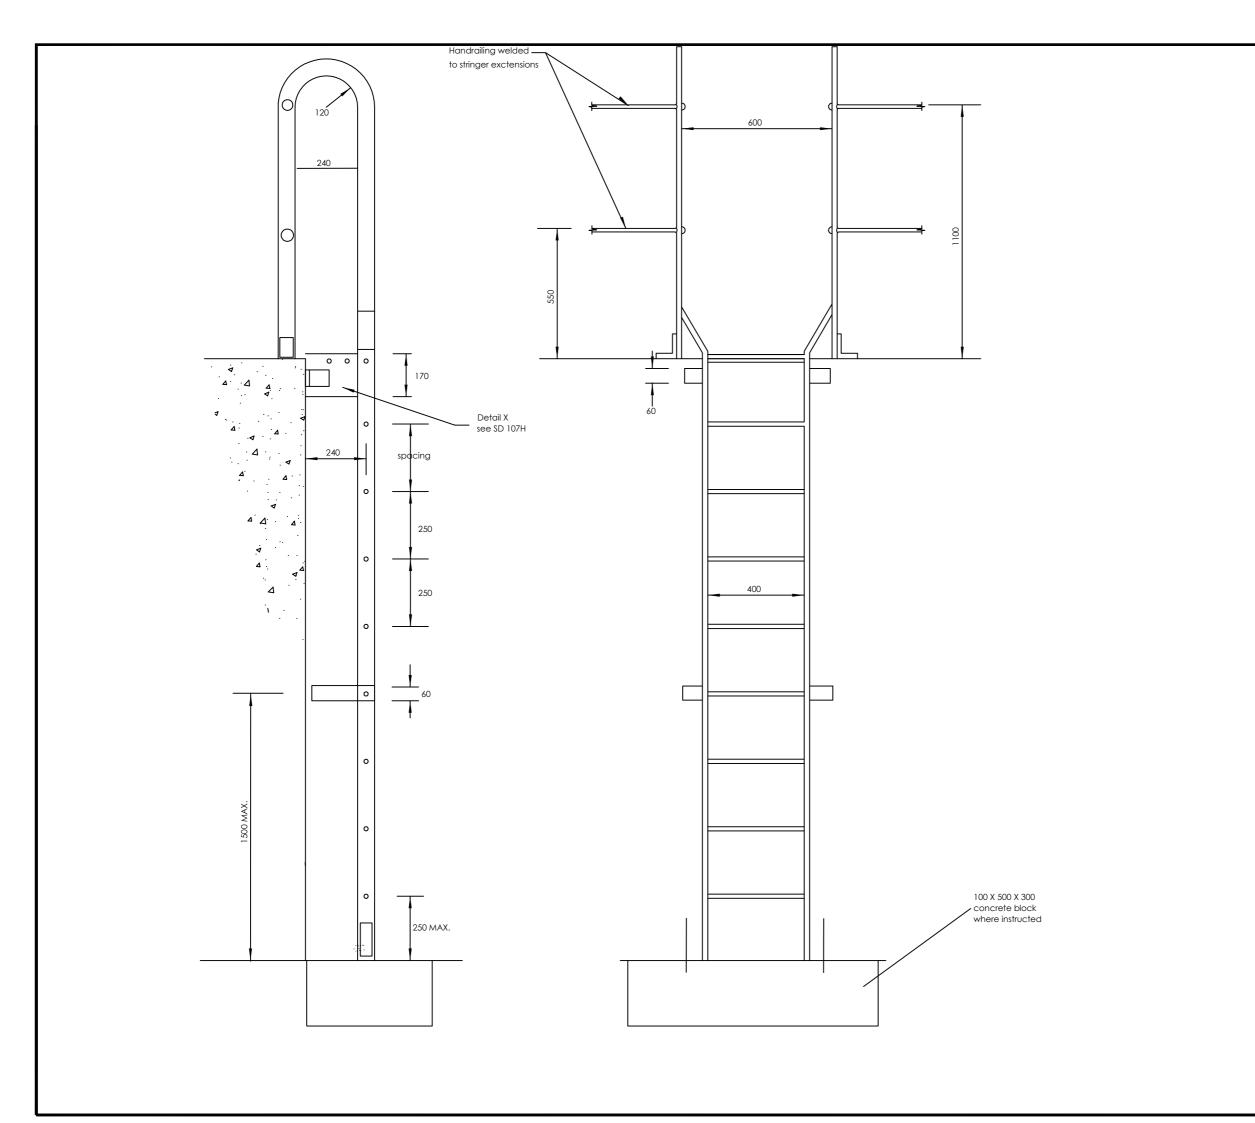

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LEGEND

- 1. Stringers 65 x 10 flat
- 2. Rungs 20 dia. solid bar
- 3. Cleats 90 x 90 x 10 angle
- 4. All welds to be 8 mm fillet welds
- 5. holding down bolts 20 dia.
- 6. Surface finish in accordance with
- the specification 7. For details see SD 107H





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Plot 3 - 7 Kabalega Crescent Road, Luzira, Box 20026 Kampala
Tel: *256 417 889 400, Email: mwe@mwe.go.ug
Website: www.mwe.go.ug

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- LOT 1 - MADI OKOLLO, TEREGO AND MOYO DISTRICTS -

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Consultant:




Corporate Headquarter 10 Philpot Lane, 1st Floor, London EC3M 8AA,

Drawing Title:

STANDARD DRAWINGS LADDER TYPE A

Scale:	Designed:	O.R Daniel		
	Drawn:	P.S Eyamu		
Date:	Checked:	O.R Daniel		
Dec-2022	Approved:	O.R Daniel		
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Drg No: MWE/GWE/SD107E Cad file No WSS<22_11>

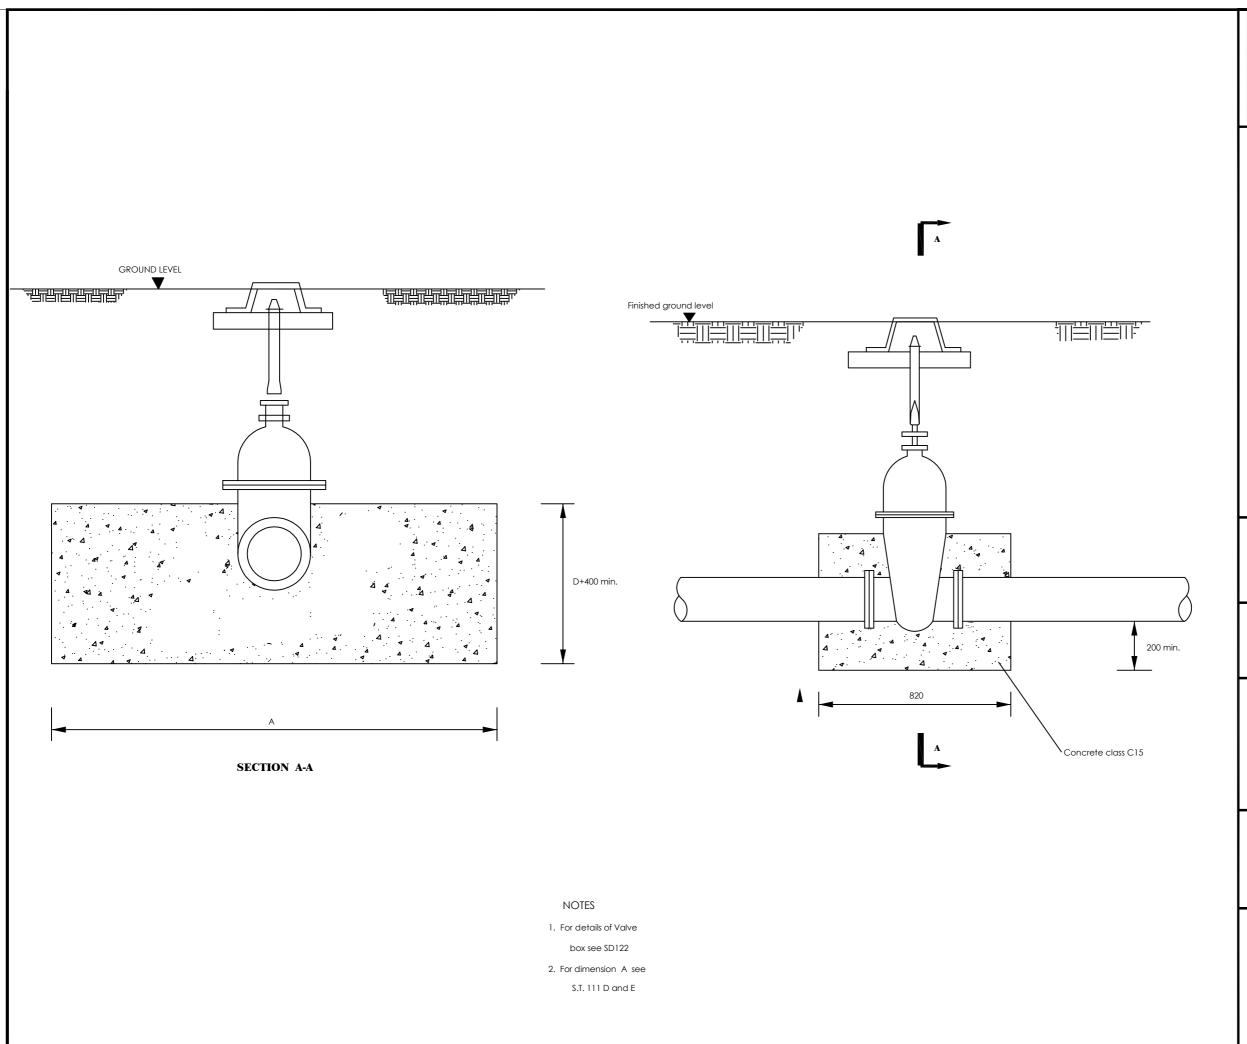

AM	AMENDMENTS		
No	Date	Revision	
1	7.7.2023	Draft Design	

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- 2. All levels are in metres above sea level.
- 3. For Site location see Dwg. MWE/GWE/0.0.0
- 4. For Node details, see Dwg. MWE/GWE/5.0.0
- 5. All valves, hydrants and washout locations are identified by marker post in positions.

LEGEND



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MINISTRY OF WATER AND ENVIRONMENT DIRECTORATE OF WATER DEVELOPMENT (DWD) RURAL WATER SUPPLY AND SANITATION DEPARTMENT Plot 3 - 7 Kabalega Crescent Road, Luzira, Box 20026 Kampala Tel : + 226 417 889 400, Iranili mwe@mwe.go.ug Website: www.mwe.go.ug

PROJEC

Consultancy Services for the Feability Study, Detailed
Engineering Design and Construction Supervision of Solar
Powered Piped Water Supply Systems and Sanitation Facilities
In Refugee Settlements and Host Districts In
West Nile and Northern Uganda

West Nile and Northern Uganda
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CONSTRUCTION OF GWERE RGC WATER SUPPLY AND SANITATION SYSTEM

Consultant:




Corporate Headquarter 10 Philpot Lane, 1st Floor, London EC3M 8AA, United Kingdom

Drawing Title:

STANDARD DRAWINGS GATE VALVE I

Scale:	Designed:		O.R Daniel
	Drav	/n:	P.S Eyamu
Date:	Checked:		O.R Daniel
Dec-2022	Approved:		O.R Daniel
ENGINEERING DESIGN DRAWING			DRAWING
Drg No: MWE/GWE/SD1	11A	Cad file I	No WSS<22_11>

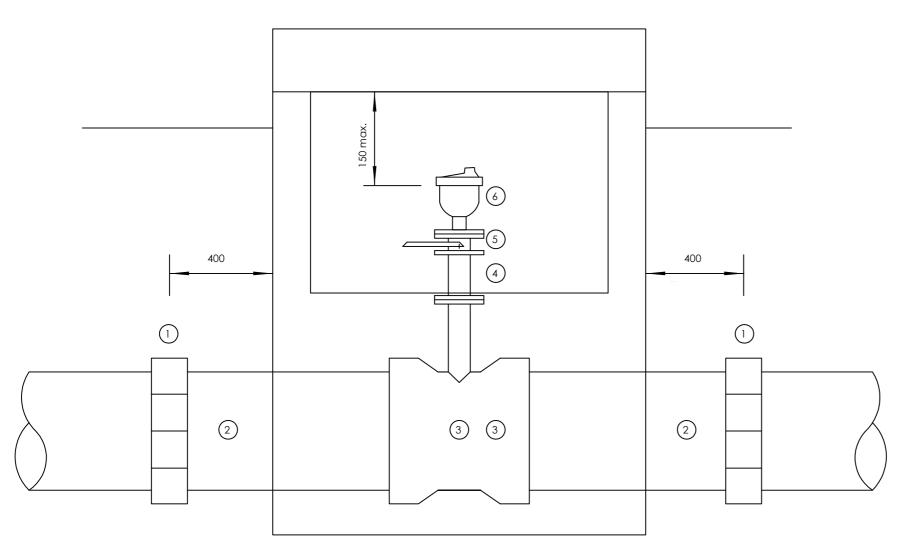

- 1 All dimensions are in millimetres
- 2 Flanged pipework to be ductile iron
- 3 Make up pipes to be ductile iron
- 4 Chamber to be 1200x900 internal dimensions For details see standard drawing SD 112D
- 5 See General Notes

SCHEDULE

ITEM DESCRIPTION

- 1 Flexible adaptor if required
- 2 Make-up pipe
- 3 Socket tee flanged branch 80/50 dia as required
- 4 Flanged pipe 80/50 dia as required
- 5 Isolating valve main 100-300dia valve 50 dia
- J L main 350-600dia valve 80dia 6 Air valve

AM	AMENDMENTS				
No	Date	Revision			
1	7.7.2023	Draft Design			

NOTES

127

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- 3. For Site location see Dwg. MWE/GWE/0.0.0
- 4. For Node details, see Dwg. MWE/GWE/5.0.0
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LEGEND





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MINISTRY OF WATER AND ENVIRONMENT MINIS I RY OF WALER AND ENVIRONIWEN DIRECTORATE OF WATER DEVELOPMENT (DWD) RURAL WATER SUPPLY AND SANITATION DEPARTMENT Plot 3 - 7 Kabalega Crescent Road, Luzira, Box 20026 Kampala Tel: +256 417 889 400, Email: mew@nwe.go.ug

Website: www.mwe.go.ug

Consultancy Services for the Feability Study, Detailed Engineering Design and Construction Supervision of Solar Powered Piped Water Supply Systems and Sanitation Facilities In Refugee Settlements and Host Districts In West Nile and Northern Uganda

- LOT 1 - MADI OKOLLO, TEREGO AND MOYO DISTRICTS -

CONSTRUCTION OF GWERE RGC WATER SUPPLY AND SANITATION SYSTEM

Consultant:




Corporate Headquarter 10 Philpot Lane, 1st Floor, London EC3M 8AA,

Drawing Title:

STANDARD DRAWINGS AIR VALVE PIPEWORK

Scale:	Designed:		O.R Daniel	
	Drav	vn:	P.S Eyamu	
Date:	Checked:		O.R Daniel	
Dec-2022	Approved:		O.R Daniel	
ENGINEERING DESIGN DRAWING				
Drg No: MWE/GWE/SD1	12A	Cad file I	No WSS<22_11>	

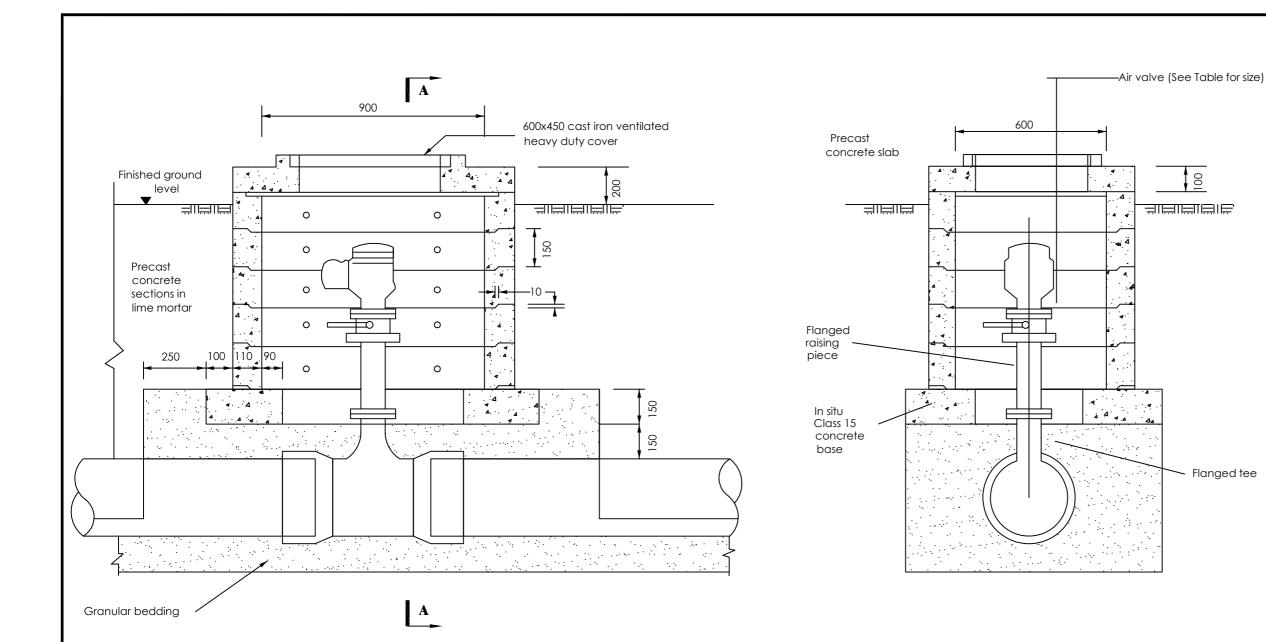

Air valve

inlet dia.

50

80

Main dia.

100-300

350-500

АМ	AMENDMENTS		
No	Date	Revision	
1	7.7.2023	Draft Design	

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LEGEND



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MINISTRY OF WATER AND ENVIRONMENT MINIS I RY OF WALER AND ENVIRONIWEN DIRECTORATE OF WATER DEVELOPMENT (DWD) RURAL WATER SUPPLY AND SANITATION DEPARTMENT Plot 3 - 7 Kabalega Crescent Road, Luzira, Box 20026 Kampala Tel: +256 417 889 400, Email: mew@nwe.go.ug

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Consultant:



Corporate Headquarter 10 Philpot Lane, 1st Floor, London EC3M 8AA,


Drawing Title:

STANDARD DRAWINGS AIR VALVE CHAMBER

Scale:	Designed:	O.R Daniel			
	Drawn:	P.S Eyamu			
Date:	Checked: O.R Daniel				
Dec-2022	Approved:	O.R Daniel			
ENGINEERING DESIGN DRAWING					
Barrier No. 1 (Contract Contract Contra					


Drg No: MWE/GWE/SD112B Cad file No WSS<22 11>

WO TYPE 1(uPVC, Steel and DI Mains)

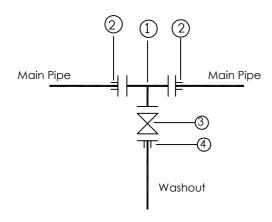

- (1) 1No CI Flanged Tee DN A/B
- 2) 2No DI Flange Adaptor, Maxi type or similar type DN A
- (3) 1 No CI Flanged Gate Valve DN A
- (4) 1 No DI Flange Adaptor, Maxi type or similar DN B

WO TYPE 2

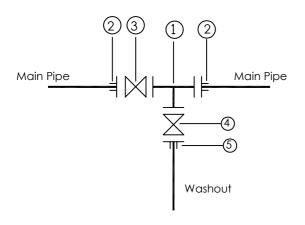

- (1) 1No CI Flanged Tee DN A/B
- 2 2No DI Flange Adaptor, Maxi type or similar type DN A3 1No CI Flanged Gate Valve DN A4 1No DI Flanged Gate Valve DN B


- (5) 1No DI Flange Adaptor, Maxi type or similar DN B

Pipe Diameter		Fittings Diameter	
Main Pipe	Washout	Α	В
OD 50	OD 50	DN 40	DN 40
OD 63	OD 63	DN 50	OD 50
OD 90	OD 63	DN 80	OD 50
OD 110	OD 63	DN 100	OD 50
OD 160	OD 63	DN 150	OD 50
OD 218	OD 110	DN 200	OD 100
OD 250	OD 110	DN 250	OD 100
OD 300	OD 110	DN 300	OD 100
OD 350	OD 110	DN 350	OD 100
OD 400	OD 110	DN 400	OD 100
OD 500	OD 110	DN 450	OD 100

NOTE: Pressure ratings of Washouts and Fittings shall be similar to those of

the main pipe on which the washout is to be installed

WO TYPE 1(HDPE Mains)

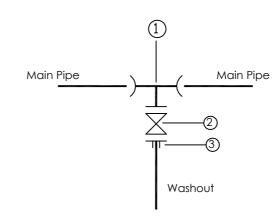

- $\textcircled{1} \ \ \text{1No Compression HDPE Tee with flanged branch DN A/B}$
- (2) 1No CI Flanged Gate Valve DN A
- (3)1 No Compression Flange Adaptor for HDPE Spigots DN B

AMENDMENTS		
No	Date	Revision
1	7.7.2023	Draft Design

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- LOT 1 - MADI OKOLLO, TEREGO AND MOYO DISTRICTS -

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Consultant:




Corporate Headquarter 10 Philpot Lane, 1st Floor, London EC3M 8AA,

STANDARD DRAWINGS WASHOUT PIPE DETAILS

Scale:	Designed:	O.R Daniel		
	Drawn:	P.S Eyamu		
Date: Dec-2022	Checked:	O.R Daniel		
	Approved:	O.R DANIEL		
ENGINEERING DESIGN DRAWING				

Drg No: MWE/GWE/SD114A | Cad file No | WSS<22_11>

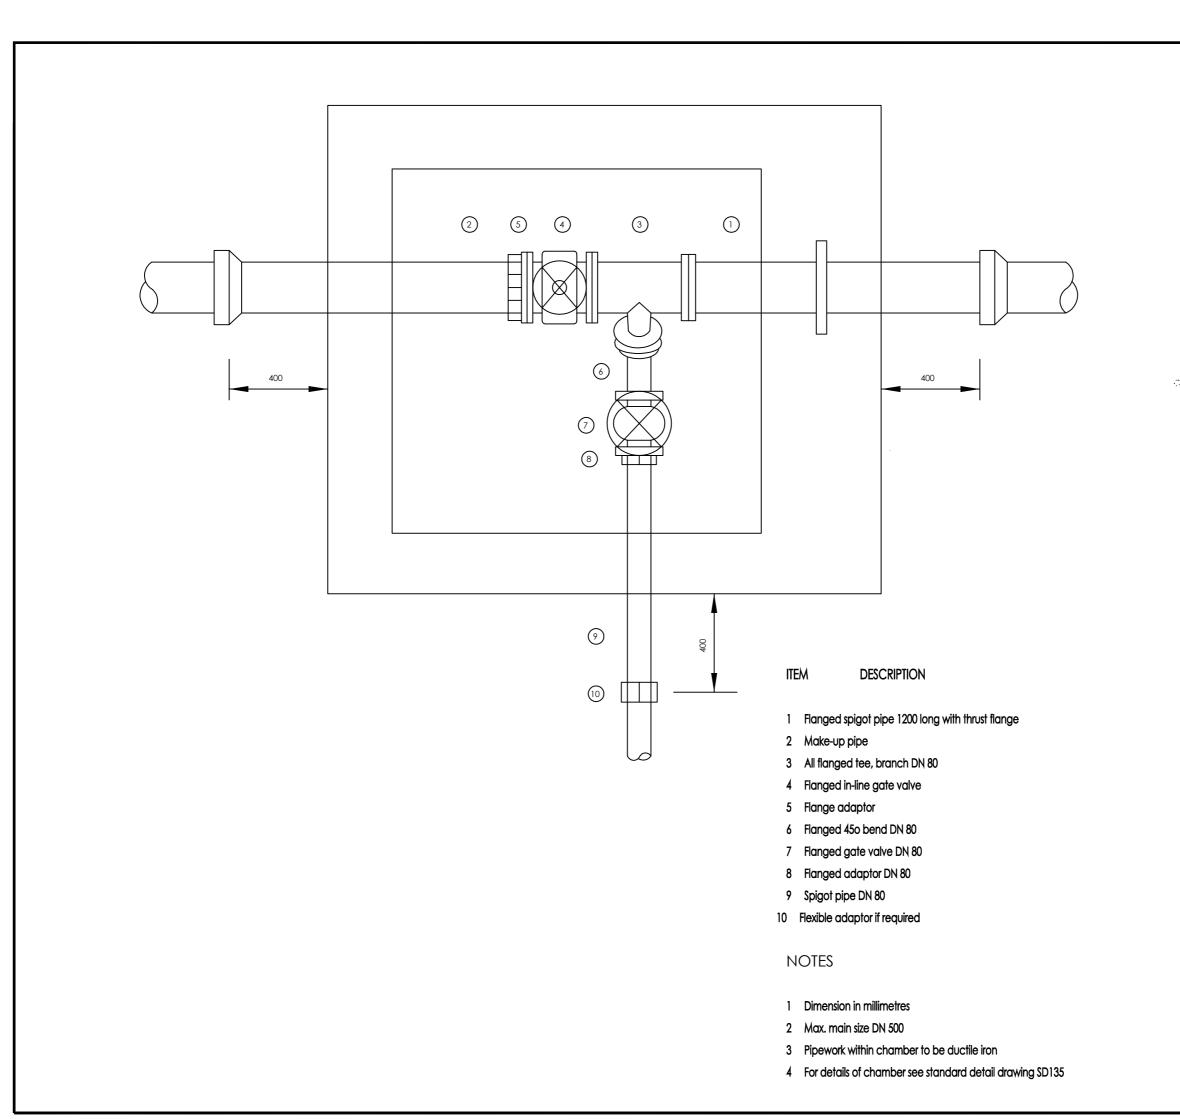

- 1	Date	Revision
1 7	7.7.2023	Draft Design

- 1. All dimensions are in metres unless stated otherwise.
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- 3. For Site location see Dwg. MWE/GWE/0.0.0
- 4. For Node details, see Dwg. MWE/GWE/5.0.0 5. All valves, hydrants and washout locations are identified by marker post in positions.

LEGEND





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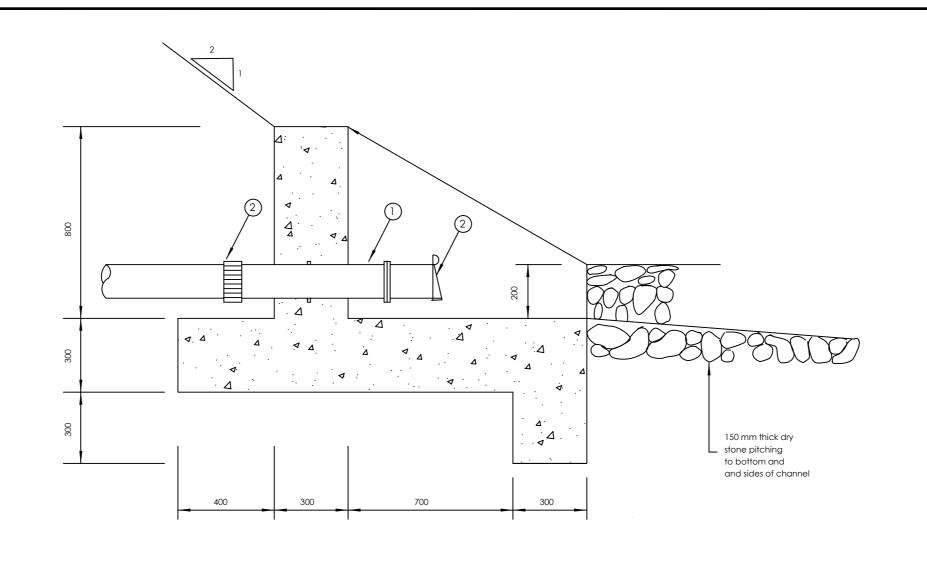



Corporate Headquarter 10 Philpot Lane, 1st Floor, London EC3M 8AA,

Drawing Title:

STANDARD DRAWINGS WASHOUT CHAMBER

Scale:	Designe	d: O.R Daniel
	Drawn:	P.S Eyamu
Date:	Checked	l: 0.R Daniel
Dec-2022	Approve	d: 0.R Daniel
ENGINEERIN	IG DESIG	N DRAWING
Drg No: MWE/GWE/SD	14B Cad	file No WSS<22_11>



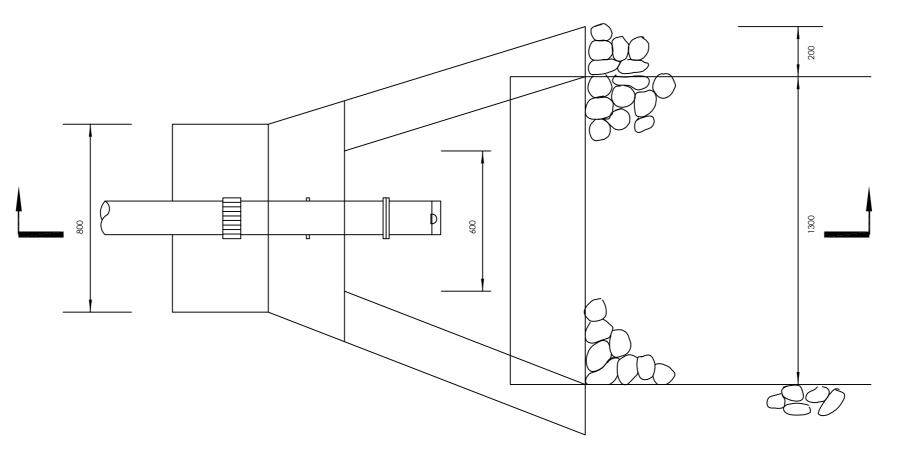

No	Date	Revision
1	7.7.2023	Draft Design

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LEGEND

Reinforcement to be one layer A252 mesh throughout

For Pipe fittings diameter and pressure ratings, see drawing No. SD 114

1 No. Flanged socket piece with paddle flange 350mm from flange, length not exceeding 750mm

1No. Flange flap valve

31 No. Viking Johnson flexible coupling



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MINISTRY OF WATER AND ENVIRONMENT MINIS I RY OF WALER AND ENVIRONMENT DIRECTORATE OF WATER DEVELOPMENT (DWD) RURAL WATER SUPPLY AND SANITATION DEPARTMENT Plot 3 - 7 Kabalega Crescent Road, Luzira, Box 20026 Kampala Tel: +256 417 889 400, Email: mev@mve go.ug Website: www.mwe.go.ug

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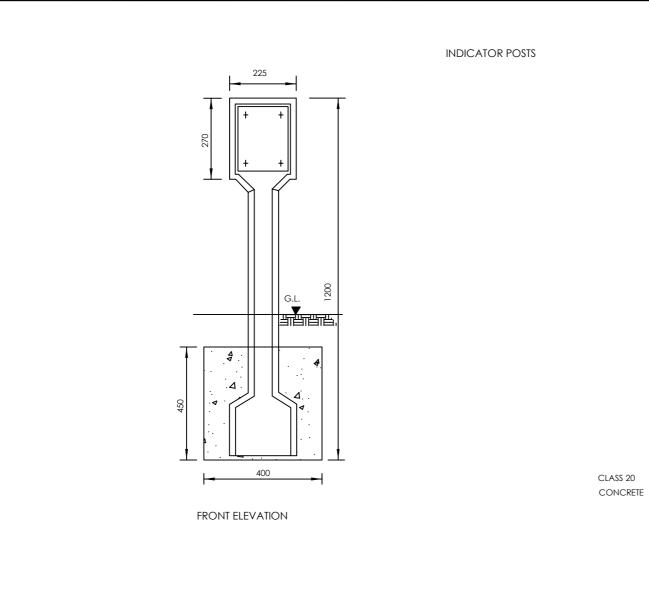
Corporate Headquarter 10 Philpot Lane, 1st Floor, London EC3M 8AA,


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STANDARD DRAWINGS OUTFALL


Scale:	Designed:	O.R Daniel			
	Drawn:	P.S Eyamu			
Date:	Checked:	O.R Daniel			
Dec-2022	Approved:	O.R Daniel			
ENGINEERING DESIGN DRAWING					

Drg No: MWE/GWE/SD116 Cad file No WSS<22_11>



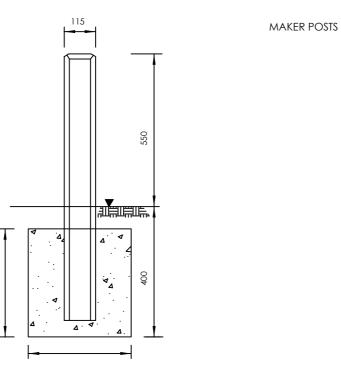

FRONT ELEVATION

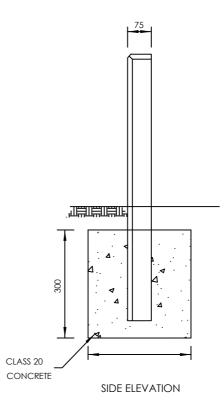

SIDE ELEVATION

No	Date	Revision
1	7.7.2023	Draft Design

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CONSTRUCTION OF GWERE RGC WATER SUPPLY AND SANITATION SYSTEM

Consultant:




Corporate Headquarter 10 Philpot Lane, 1st Floor, London EC3M 8AA,

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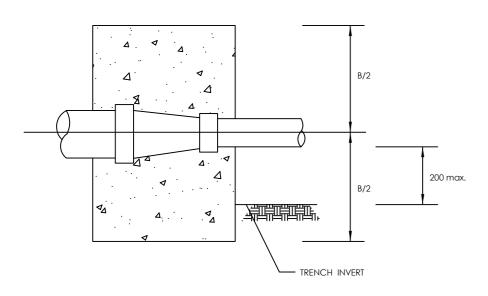
STANDARD DRAWINGS MARKER POST

Scale:	Designed	d: O.R Daniel		
	Drawn:	P.S Eyamu		
Date:	Checked	: O.R Daniel		
Dec-2022	Approve	d: O.R Daniel		
ENGINEERING DESIGN DRAWING				
Drg No: MWE/GWE/SD1	17 Cad 1	file No WSS<22_11>		

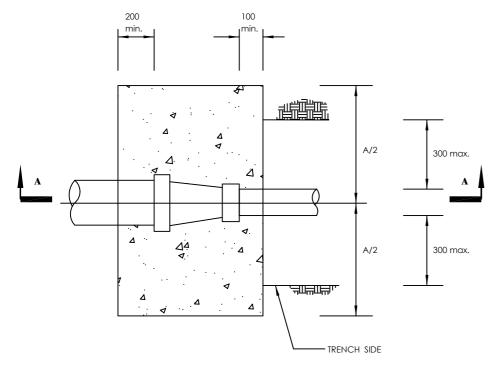

PLAN





SECTION A-A

GROUND CONDITION		DRY	SUBMERGED
TEST PRESSURE (BAR)		15	15
80 - 50	A	850	850
	В	650	650
100 - 50	A	1020	1020
100 - 80	В	680	680
150 - 100	A	1300	1300
	В	700	1000
200 - 100	A	1700	1900
	В	700	1000
200 - 150	A	1350	1350
	В	750	950
250 -100	A	2150	2250
	В	750 🚓	1250
250 - 150	A	1950	1950
	В	750	1250
250 - 200	A	1400	1400
	В	800	1200
300 - 200	A	2050	2050
	В	1000	1600
300 - 250	A	1450	1450
	В	850	1350
350 - 300	A	1250	1650
	В	1000	1200
500 - 400	A	2000	2300
	В	1400	1800

No	Date	Revision
1	7.7.2023	Draft Design

NOTES

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- 4. For Node details, see Dwg. MWE/GWE/5.0.0
- 5. All valves, hydrants and washout locations are identified by marker post in positions.

LEGEND





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MINISTRY OF WATER AND ENVIRONMENT MINISTRY OF WATER AND ENVIRONMENT DIRECTORATE OF WATER DEVELOPMENT (DWD)
RURAL WATER SUPPLY AND SANITATION DEPARTMENT
Plot 3 - 7 Kabalega Crescent Road, Luzira, Box 20026 Kampala
Tel: *256 417 889 400, Email: mwe@mwe.go.ug
Website: www.mwe.go.ug

Consultancy Services for the Feability Study, Detailed Engineering Design and Construction Supervision of Solar Powered Piped Water Supply Systems and Sanitation Facilities In Refugee Settlements and Host Districts In West Nile and Northern Uganda

- LOT 1 - MADI OKOLLO, TEREGO AND MOYO DISTRICTS -

CONSTRUCTION OF GWERE RGC WATER SUPPLY AND SANITATION SYSTEM

Consultant:




Corporate Headquarter 10 Philpot Lane, 1st Floor, London EC3M 8AA,


Drawing Title:

STANDARD DRAWINGS ANCHOR BLOCKS FOR TAPERS

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	Drawn:	P.S Eyamu			
Date:	Checked:	O.R Daniel			
Dec-2022	Approved:	O.R Daniel			
ENGINEERING DESIGN DRAWING					
B 11					

Drg No: MWE/GWE/SD118A Cad file No WSS<22_11>

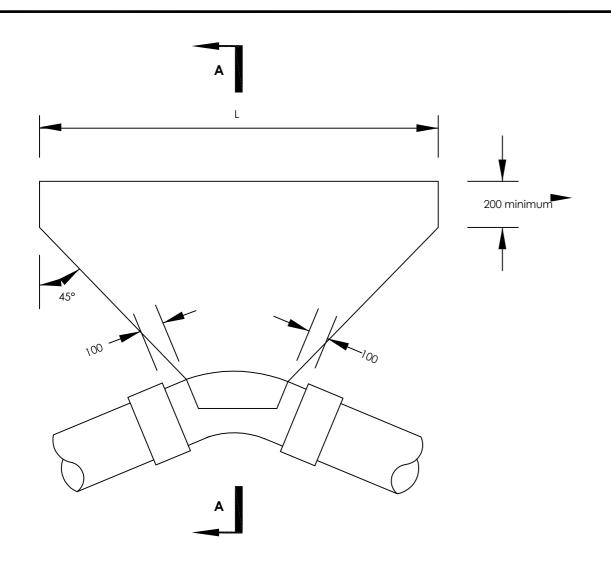

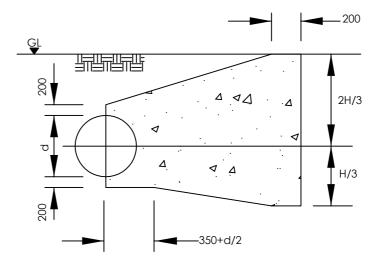

SECTION A-A

PLAN

Ground Condition			DRY			
Test Pressure (Bar)				1	5	
Ber	nd Angle		111/2°	22½°	45°	90°
		H				
	80	L				
		H	1	SEE SD 118C		
	80 < d < 15Q	L				
		H	1			
Ē	150 < d < 300	l L				
<u>L</u>		H	1		1600	1600
	300 < d < 400	L			2450	4530
DA DA		H	1		1650	1650
PIPE DIAMETER (mm)	450	L			2900	5330
		H	1000	1350	1800	1800
	500	L	1250	1950	3050	5650

AM	AMENDMENTS		
No	Date	Revision	
1	7.7.2023	Draft Design	

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CONSTRUCTION OF GWERE RGC WATER SUPPLY AND SANITATION SYSTEM

Consultant:




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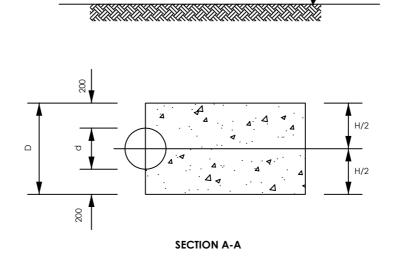
Drawing Title:

STANDARD DRAWINGS ANCHOR BLOCKS FOR BENDS 1

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	Drawn:	P.S Eyamu		
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Dec-2022	Approved:	O.R Daniel		
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Drg No: MWE/GWE/SD118B Cad file No WSS<22_11>



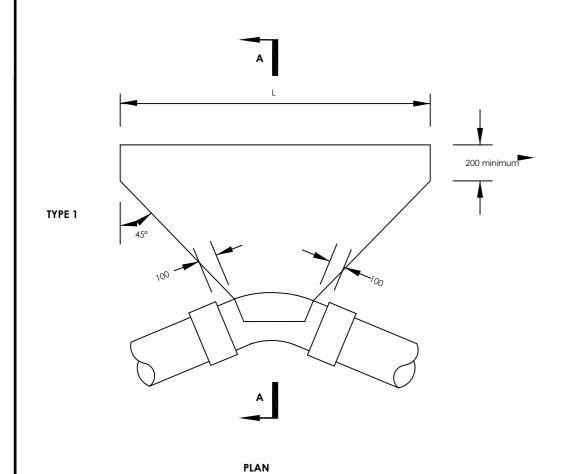

GROUND LEVEL

DRY GROUND CONDITION 15 TEST PRESSURE (Bar) 111/40 22½° 90° BEND ANGLE 480 480 350 700 200 300 550 550 80 < d < 150 🔍 300 750 1700 900 700 700 700 150 < d < 300 🔍 650 1250 2500 800 800 300 < d < 400 🔍 900 1800 DIAMETER 900 900 450 5000 温 2500 SEE SD 118Å 500

ΑN	AMENDMENTS			
No	Date	Revision		
1	7.7.2023	Draft Design		

NOTES

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LEGEND

Two layers of water proof paper to be placed between concrete fitting

NOTE:

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Consultant:




Corporate Headquarter 10 Philpot Lane, 1st Floor, London EC3M 8AA,

Drawing Title:

STANDARD DRAWINGS ANCHOR BLOCKS FOR BENDS 2

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Dec-2022	App	roved:	0.1	R DANIEL
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Drg No: MWE/GWE/SD	118C	Cad file	No	WSS<22_11>

TYPICAL GATE VALVE, EXTENSION SPINDLE, PROTECTION TUBE AND SURFACE BOX

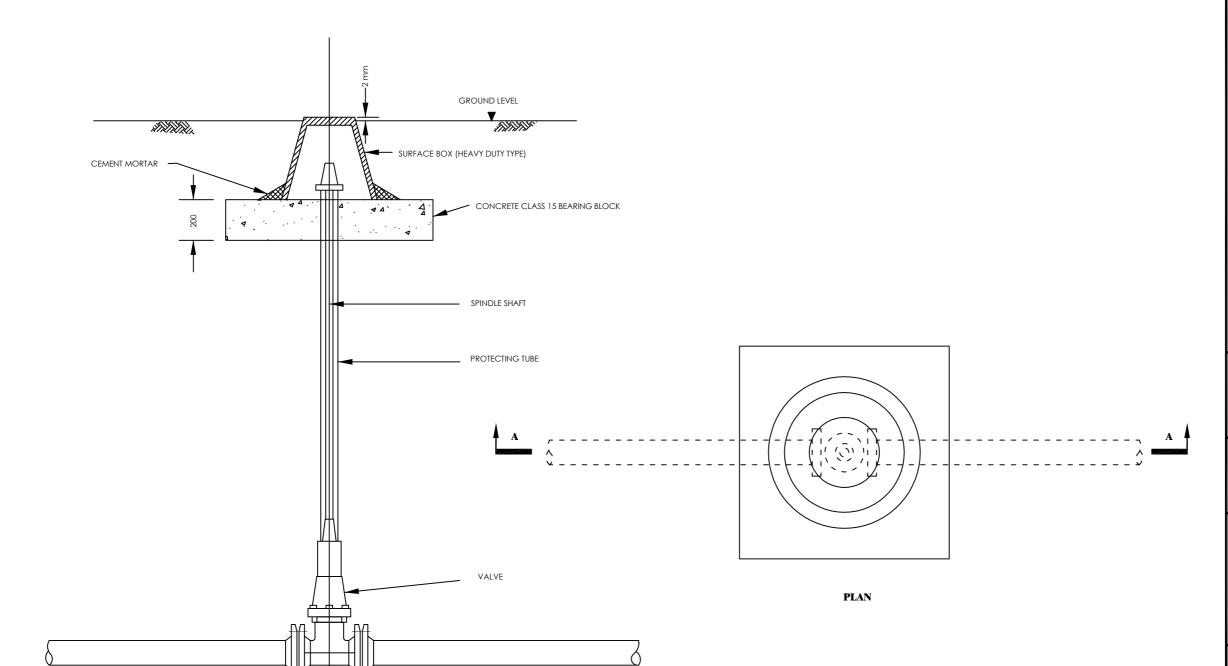

SECTION A-A

AM	AMENDMENTS			
No	Date	Revision		
1	7.7.2023	Draft Design		

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LEGEND





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- LOT 1 - MADI OKOLLO, TEREGO AND MOYO DISTRICTS -

CONSTRUCTION OF GWERE RGC WATER SUPPLY AND SANITATION SYSTEM

Consultant:




Corporate Headquarter 10 Philpot Lane, 1st Floor, London EC3M 8AA,

Drawing Title:

STANDARD DRAWINGS SURFACE BOX

Scale:	Desi	gned:	O.R Daniel	
	Drav	vn:	P.S Eyamu	
Date:	Checked: Approved:		O.R Daniel	
Dec-2022			O.R Daniel	
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SECTION B-B

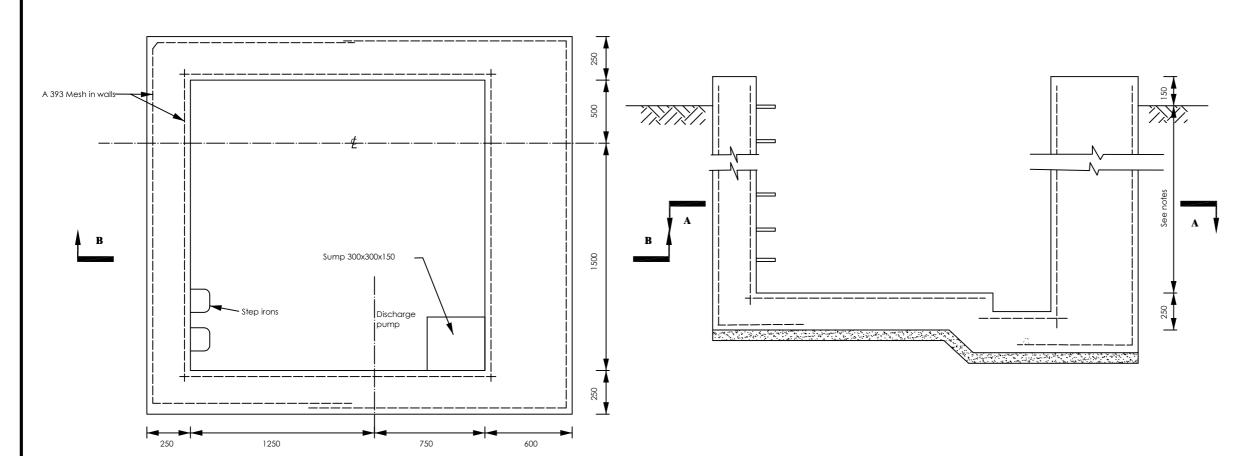NOTES

SECTION A-A

- 1. Floor of chamber to be 250 below pipe IL min depth 1700 below ground level.
- 2. Fore details of cover slab see Drawing SD 135C
- 3. See General notes.
- 4. Use SD 135b if additional thrust block is required

AM	AMENDMENTS			
No	Date	Revision		
1	7.7.2023	Draft Design		

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West Nile and Northern Uganda
- LOT 1 - MADI OKOLLO, TEREGO AND MOYO DISTRICTS -

CONSTRUCTION OF GWERE RGC WATER SUPPLY AND SANITATION SYSTEM

Consultant:




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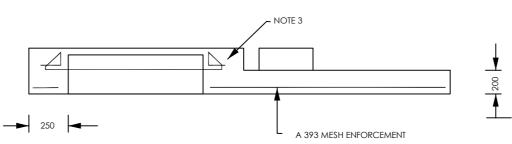
Drawing Title:

STANDARD DRAWINGS WASHOUT GV CHAMBER

Scale:	Designed:	O.R Daniel		
	Drawn:	P.S Eyamu		
Date:	Checked:	O.R Daniel		
Dec-2022	Approved:	O.R DANIEL		
ENGINEERING DESIGN DRAWING				

Drg No: MWE/GWE/SD135A Cad file No WSS<22_11>



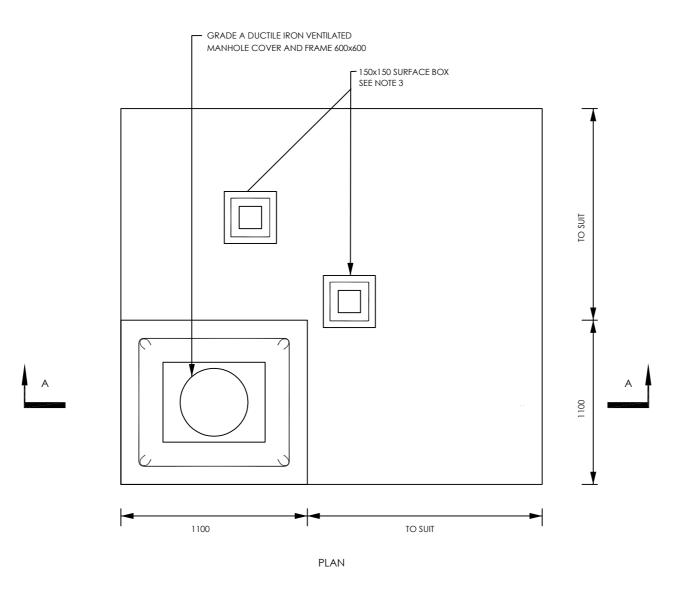

SECTION A-A

1 7.7.20	3 Draft Design

- 1. All dimensions are in metres unless stated otherwise.
- 2. All levels are in metres above sea level.
- 3. For Site location see Dwg. MWE/GWE/0.0.0
- 4. For Node details, see Dwg. MWE/GWE/5.0.0
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- LOT 1 - MADI OKOLLO, TEREGO AND MOYO DISTRICTS -

CONSTRUCTION OF GWERE RGC WATER SUPPLY AND SANITATION SYSTEM

Consultant:




Corporate Headquarter 10 Philpot Lane, 1st Floor, London EC3M 8AA,

Drawing Title:

STANDARD DRAWINGS WASHOUT GV ROOF SLAB

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Dec-2022	Approved:		O.R DANIEL	
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No	Date	Revision			
1	7.7.2023	Draft Design			

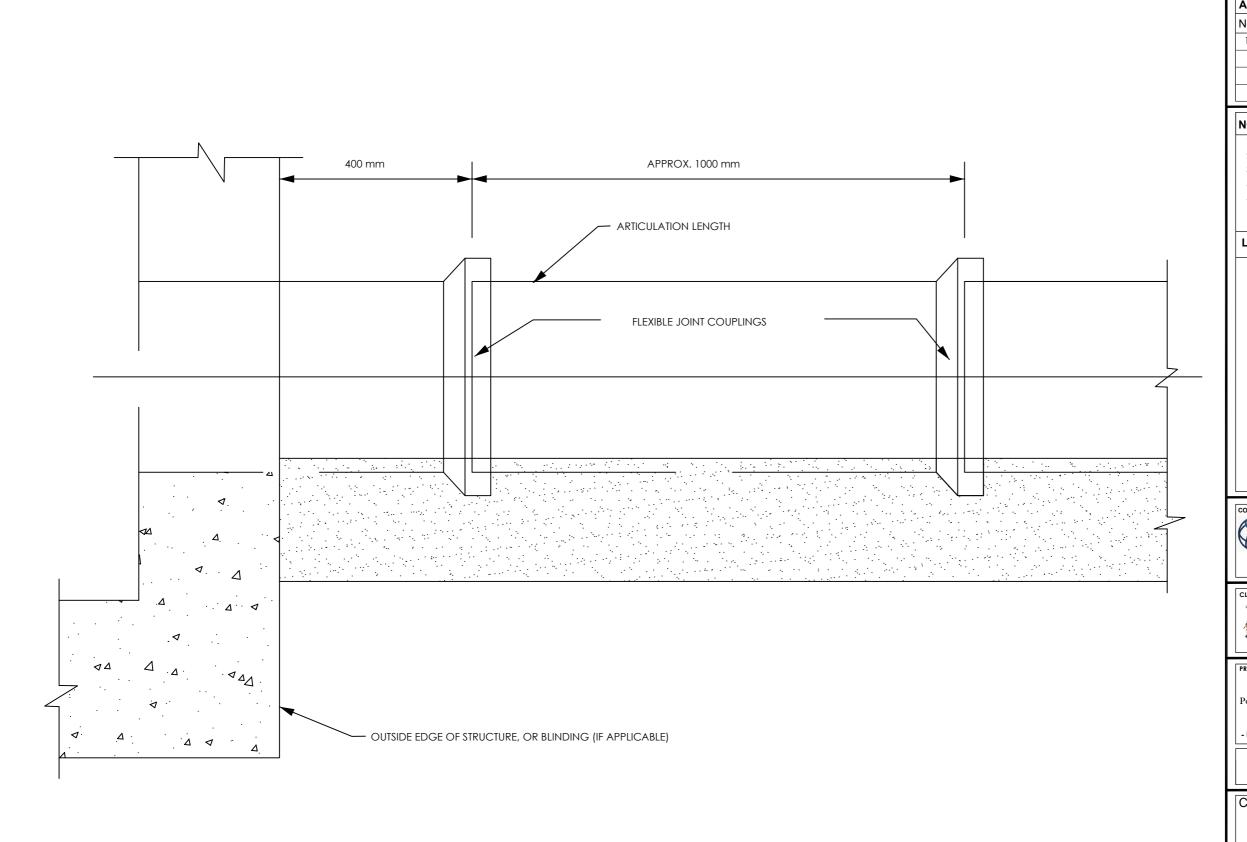- 1. All dimensions are in metres unless stated otherwise.
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- 3. For Site location see Dwg. MWE/GWE/0.0.0
- 4. For Node details, see Dwg. MWE/GWE/5.0.0
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LEGEND







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RURAL WATER SUPPLY AND SANITATION DEPARTMENT
Plot 3 - 7 Kabalega Crescent Road, Luzira, Box 20026 Kampala
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Website: www.mwe.go.ug

Consultancy Services for the Feability Study, Detailed Engineering Design and Construction Supervision of Solar Powered Piped Water Supply Systems and Sanitation Facilities In Refugee Settlements and Host Districts In West Nile and Northern Uganda

- LOT 1 - MADI OKOLLO, TEREGO AND MOYO DISTRICTS -

CONSTRUCTION OF GWERE RGC WATER SUPPLY AND SANITATION SYSTEM

Consultant:



Corporate Headquarter 10 Philpot Lane, 1st Floor, London EC3M 8AA,


Drawing Title:

STANDARD DRAWINGS FLEXIBLE PIPE JOINT DETAILS

Scale:	Desi	gned:	O.R Daniel	
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Date:	Checked:		O.R Daniel	
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GRAVITY LINES AND LATERALS

LAID IN ROAD LAID IN FIELD/VERGE

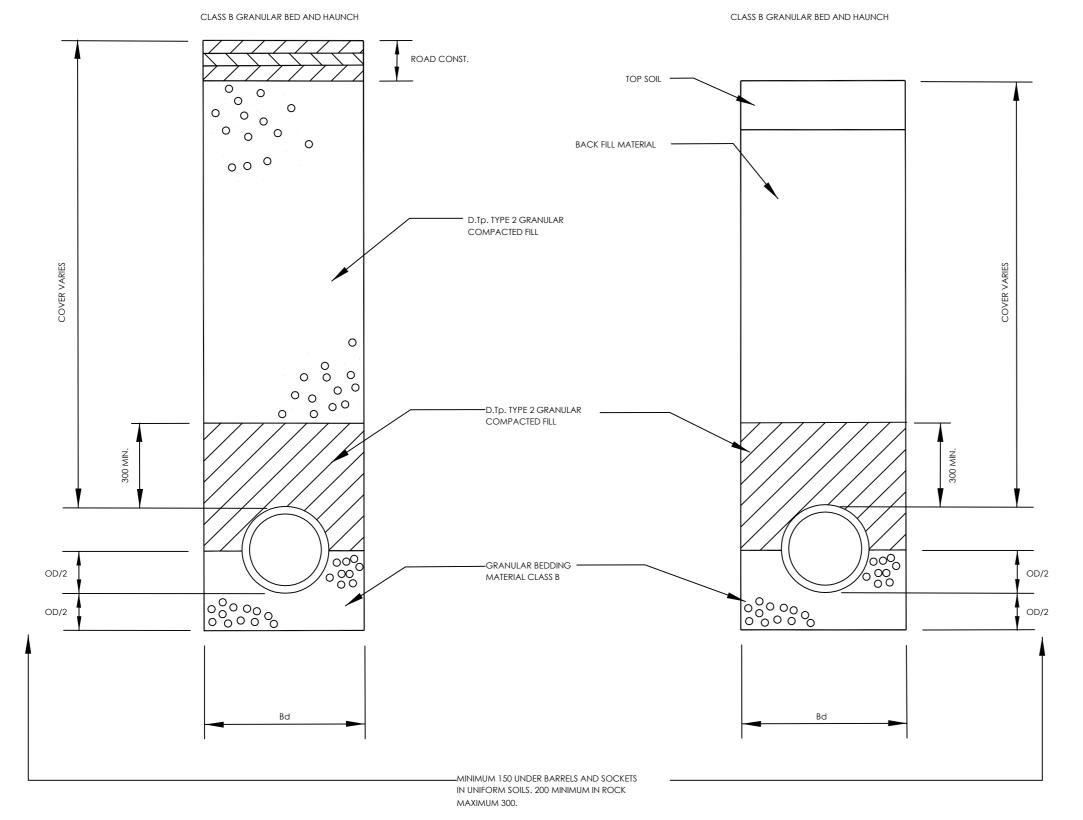

l	AM	AMENDMENTS		
ı	No	Date	Revision	
ı	1	7.7.2023	Draft Design	
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NOTES

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LEGEND

PIPE DIÅ.	MAX Bd
100	550
150	600
225	700
300	850
400	1000
450	1100
525	1130
600	1200

TRENCH WIDTH TABLE





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- LOT 1 - MADI OKOLLO, TEREGO AND MOYO DISTRICTS -

CONSTRUCTION OF GWERE RGC WATER SUPPLY AND SANITATION SYSTEM

Consultant:




Corporate Headquarter 10 Philpot Lane, 1st Floor, London EC3M 8AA,

Drawing Title:

STANDARD DRAWINGS PIPE BEDDING

Scale:	Designed:		O.R Daniel				
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Date:	Checked:		O.R Daniel				
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No	ENDMEN Date	Revision
1	7 7 0000	Draft Design
- 1	7.7.2023	Drait Design

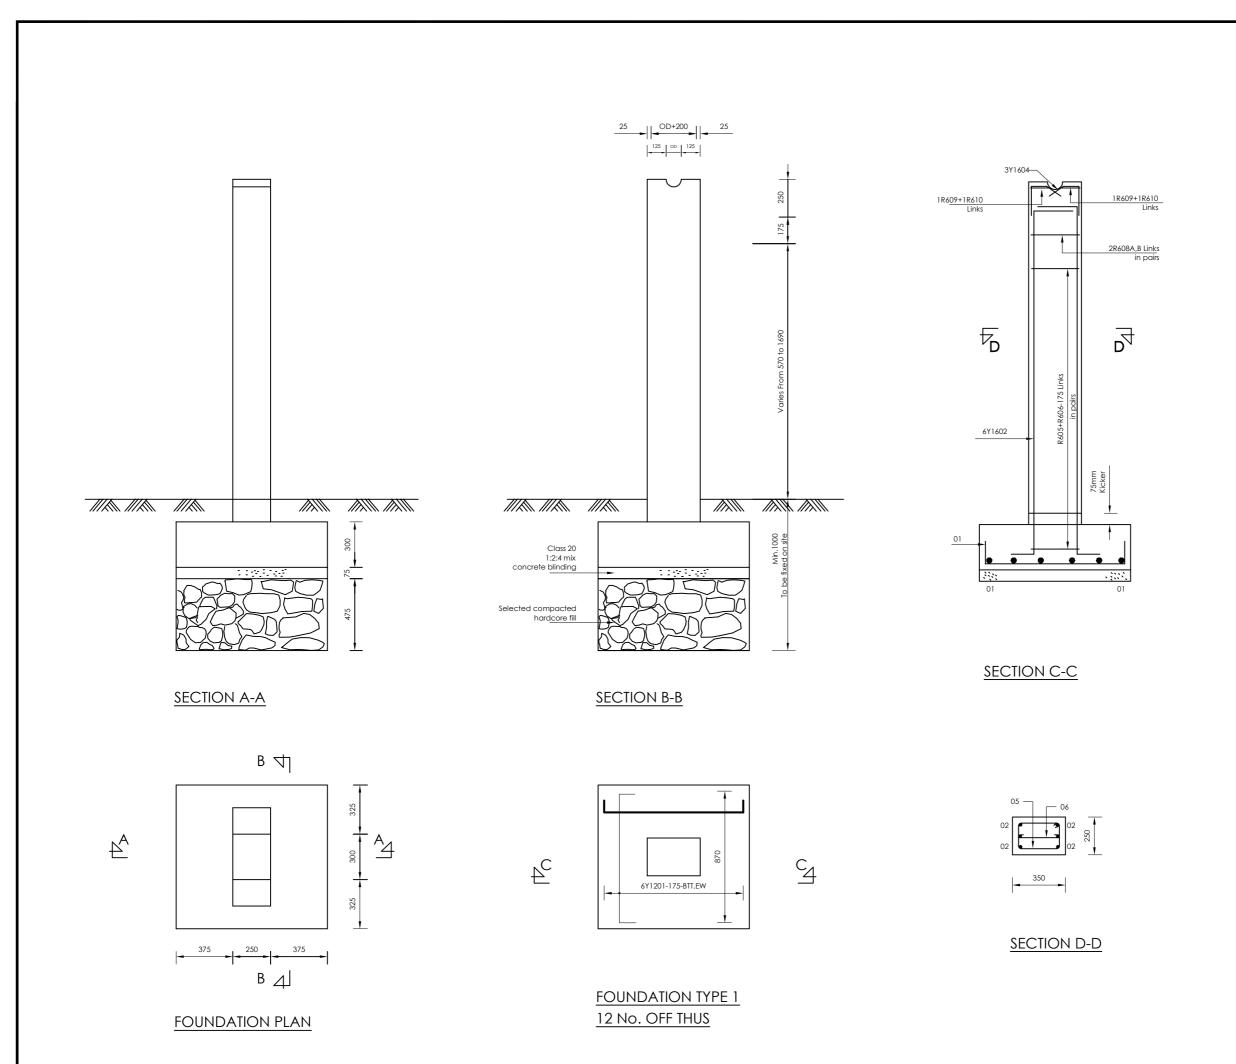- 1. All dimensions are in metres unless stated otherwise.
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- 4. For Node details, see Dwg. MWE/LEF/5.0.0
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LEGEND



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Website: www.mwe.go.ug

PROJECT

Consultancy Services for the Feability Study, Detailed Engineering Design and Construction Supervision of Solar Powered Piped Water Supply Systems and Sanitation Facilities In Refugee Settlements and Host Districts In West Nile and Northern Loanda

West Nile and Northern Uganda
- LOT 1 - MADI OKOLLO, TEREGO AND MOYO DISTRICTS

CONSTRUCTION OF GWERE RGC WATER SUPPLY AND SANITATION SYSTEM

Consultant:



Corporate Headquarter 10 Philpot Lane, 1st Floor, London EC3M 8AA, United Kingdom

Drawing Title:

STANDARD DRAWINGS PIPE SUPPORTS (R.C DETAILS)

Scale:	Desi	gned:	O.R Daniel			
	Drav	vn:	P.S Eyamu			
Date:	Checked:		O.R Daniel			
Dec-2022	Approved:		O.R Daniel			
ENGINEERING DESIGN DRAWING						
Drg No: MWE/GWE/SD220		Cad file	No WSS<22_11>			