

THE REPUBLIC OF UGANDA

MINISTRY OF WATER AND ENVIRONMENT

INTEGRATED WATER MANAGEMENT AND DEVELOPMENT PROJECT (PROJECT ID NO: P163782)

FINANCED BY THE WORLD BANK & GOVERNMENT OF UGANDA

CO-FINANCED BY



AND



CONSTRUCTION OF MUTUNDA RGC SOLAR POWERED PIPED WATER SUPPLY AND SANITATION SYSTEM

REFERENCE NO.: MWE/WRKS/22-23/00005

BIDDING DOCUMENT

VOLUME IV

DRAWINGS

OCTOBER 2022

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		DRAWING No	DRAWING TITLE
DRAWING No	DRAWING TITLE	MUT/WS/2.2.3	TRANSMISSION LINE 02 (1+200.00 – 1+800.00)
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MUT/WS/0.0.2	GENERAL LAYOUT (SHEET 02 0F 02)	MUT/WS/2.2.6	TRANSMISSION LINE 02 (3+000.00 – 3+600.00)
		MUT/WS/2.2.7	TRANSMISSION LINE 02 (3+600.00 – 4+200.00)
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		MUT/WS/3.1.2	250M3 POPARA RESERVOIR – SECTION A-A & SECTION B-B
MUT/WS/1.2.1	BOREHOLE PUMP ATTENDANT, GUARD HOUSE & ECOSAN (PLAN & SECTION)	MUT/WS/3.1.3	250M3 POPARA RESERVOIR – FOUNDATION LAYOUT AND DETAILS
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MUT/WS/2.0.0	GENERAL LAYOUT TRANSMISSION NETWORK	MUT/WS/3.2.1	100M3 TEYEGO RESERVOIR – PLAN LAYOUT
MUT/WS/2.0.1	GENERAL LAYOUT TRANSMISSION NETWORK (SHEET 01 OF 02)	MUT/WS/3.2.2	100M3 TEYEGO RESERVOIR — SECTION A-A & SECTION B-B
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MUT/WS/2.1.10	TRANSMISSION LINE 01 (5+400.00 - 6+000.00)	MUT/WS/5.1.1	DISTRIBUTION LINE 01 (0+000.00 - 0+600.00)
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MUT/WS/2.1.13	TRANSMISSION LINE 01 (7+200.00 – 7+800.00)	MUT/WS/5.2.1	DISTRIBUTION LINE 02 (0+000.00 – 0+600.00)
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MUT/WS/2.2.2	TRANSMISSION LINE 02 (0+600.00 – 1+200.00)	MUT/WS/5.3.2	DISTRIBUTION LINE 03 (0+600.00 – 1+200.00)

DRAWING No	DRAWING TITLE	DRAWING No	DRAWING TITLE
MUT/WS/5.3.3	DISTRIBUTION LINE 03 (1+200.00 – 1+800.00)	MUT/WS/5.13.1	DISTRIBUTION LINE 13 (0+000.00 - 0+600.00)
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MUT/WS/5.4.1	DISTRIBUTION LINE 04 (0+000.00 – 0+571.00)	MUT/WS/5.13.9	DISTRIBUTION LINE 13 (4+800.00 – 5+400.00)
		MUT/WS/5.13.10	DISTRIBUTION LINE 13 (5+400.00 – 6+000.00)
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MUT/WS/5.5.4	DISTRIBUTION LINE 05 (1+800.00 – 2+400.00)	MUT/WS/5.13.14	DISTRIBUTION LINE 13 (7+800.00 – 8+400.00)
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		MUT/WS/5.13.16	DISTRIBUTION LINE 13 (9+000.00 – 9+600.00)
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MUT/WS/5.7.2	DISTRIBUTION LINE 07 (0+600.00 - 1+200.00)	MUT/WS/8.1.1	PUBLIC STAND POST- CONNECTION AND SOAK PIT DETAILS
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		MUT/S/1.1.2	INSTITUTIONAL TOILET - BOYS
MUT/WS/5.9.1	DISTRIBUTION LINE 09 (0+000.00 – 0+585.00)	MUT/S/1.1.3	INSTITUTIONAL TOILET - GIRLS
MUT/WS/5.10.1	DISTRIBUTION LINE 10 (0+000.00 – 0+563.80)	MUT/S/1.2.1	WATER BORNE TOILET – FLOOR PLAN
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MUT/WS/5.11.1	DISTRIBUTION LINE 11 (0+000.00 - 0+641.10)	MUT/S/1.2.3	WATER BORNE TOILET – ELEVATIONS, DOOR & WINDOW SCHEDULE
		MUT/S/1.2.4	WATER BORNE TOILET – ELEVATIONS
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MUT/WS/5.12.3	DISTRIBUTION LINE 12 (1+200.00 – 1+800.00)		
MUT/WS/5.12.4	DISTRIBUTION LINE 12 (1+800.00 – 2+400.00)	SD 100	CENIEDAL NICTES ECO STANDADO DO AMUNIOS
MUT/WS/5.12.5	DISTRIBUTION LINE 12 (2+400.00 – 3+000.00)	SD 100	GENERAL NOTES FOR STANDARD DRAWINGS SIGN BOARD
MUT/WS/5.12.6	DISTRIBUTION LINE 12 (3+000.00 – 3+203.85)		
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DRAWING No	DRAWING TITLE	DRAWING No	DRAWING TITLE
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SD106B	FORCED STEEL STANCHIONS FOR PLATFORMS AND WALKWAYS-1	SD132	TRENCH CUTOFF
SD106C	FORCED STEEL STANCHIONS FOR PLATFORMS AND WALKWAYS-2	SD135A	WASHOUT/GATE VALVE CHAMBER – R.C DETAILS
SD106D	ARRANGEMENT OF HANDRAILING ON WALKWAYS AND TOP OF LADDERS	SD135C	WASHOUT/GATE VALVE CHAMBER ROOF SLAB – R.C DETAILS
SD107A	ARRANGEMENT OF HANDRAILING ON WALKWAYS AND TOP OF LADDERS	SD137	FLEXIBLE PIPE JOINT DETAILES FOR PIPES IN CONCRETE STRUCTURES
SD107B	MILD STEEL SHIP TYPE LADDER - DETAIL	SD202	BEDDING DETAILS FOR GRAVITY LINE AND LATERALS
SD107C	mild Steel Stairway Side Elevation	SD206	INSPECTION CHAMBERS- TYPES 1 AND 2
SD107D	mild Steel Stairway front elevation	SD211	PRECAST CONCRETE COVER SLAB OPEN AREAS
SD107E`	MILD STEEL ACCESS LADDER – TYPE A (NOT EXCEEDING 2.3m RISE)	SD212	PRECAST CONCRETE COVER SLAB UNDER ROADS AND PAVINGS
SD107G	MILD STEEL ACCESS LADDERS - TYPE C	SD213	PRECAST CHAMBER COVER SLAB INSTALLATIONS
SD107H	MILD STEEL ACCESS LADDER DETAILS	SD214	PRECAST CONCRETE CHAMBER SECTIONS
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SD110	FLOW METER - PIPEWORK	SD216	THRUST BLOCK
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SD118C	ANCHOR BLOCKS FOR BENDS-2		
SD118D	ANCHOR BLOCKS FOR BENDS-3		
SD118E	ANCHOR BLOCKS FOR BENDS -4		
SD118F	ANCHOR BLOCKS FOR BENDS -5		
SD118G	ANCHOR BLOCKS FOR BENDS -6		
SD118H	ANCHOR BLOCKS FOR BENDS -7		
SD118I	ANCHOR BLOCKS FOR BENDS -8		
SD118J	ANCHOR BLOCKS FOR TEES AND DEAD ENDS — 1		
SD118K	ANCHOR BLOCKS FOR TEES AND DEAD ENDS - 2		
SD118L	ANCHOR BLOCKS FOR TEES AND DEAD ENDS - 3		
SD121	PIPE BEDDING		

SD122


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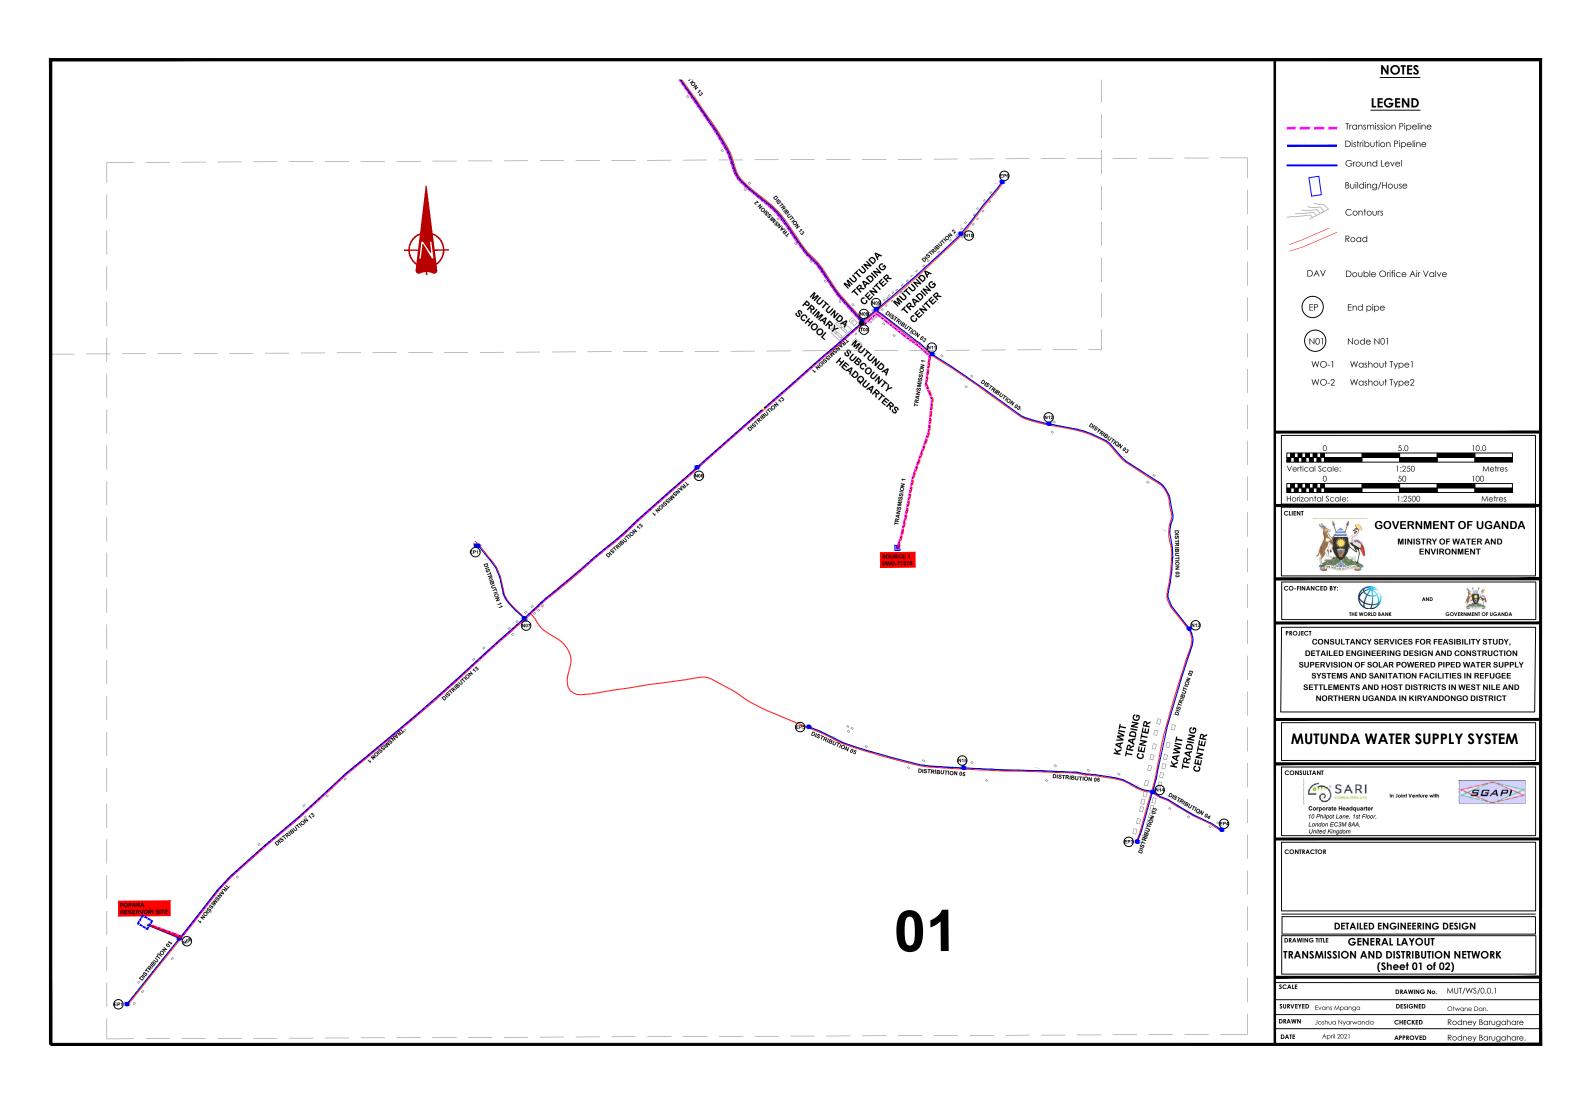
SD126


SURFACE BOX AND FIELD DRAIN


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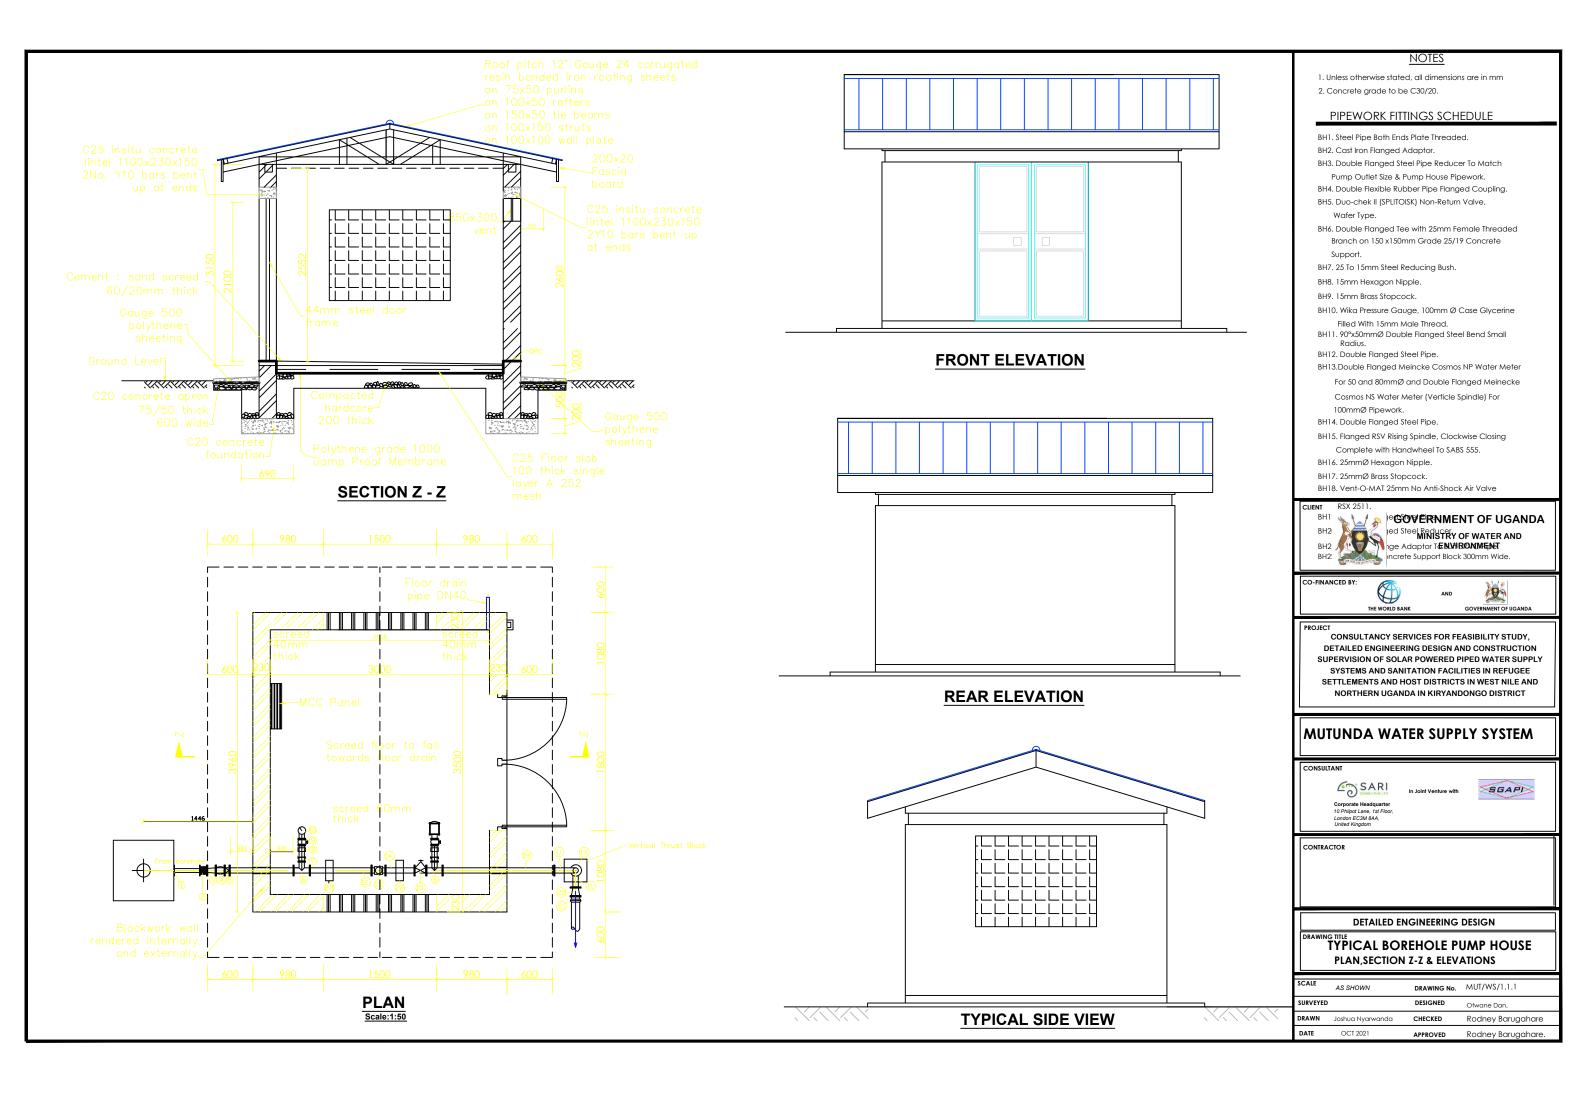
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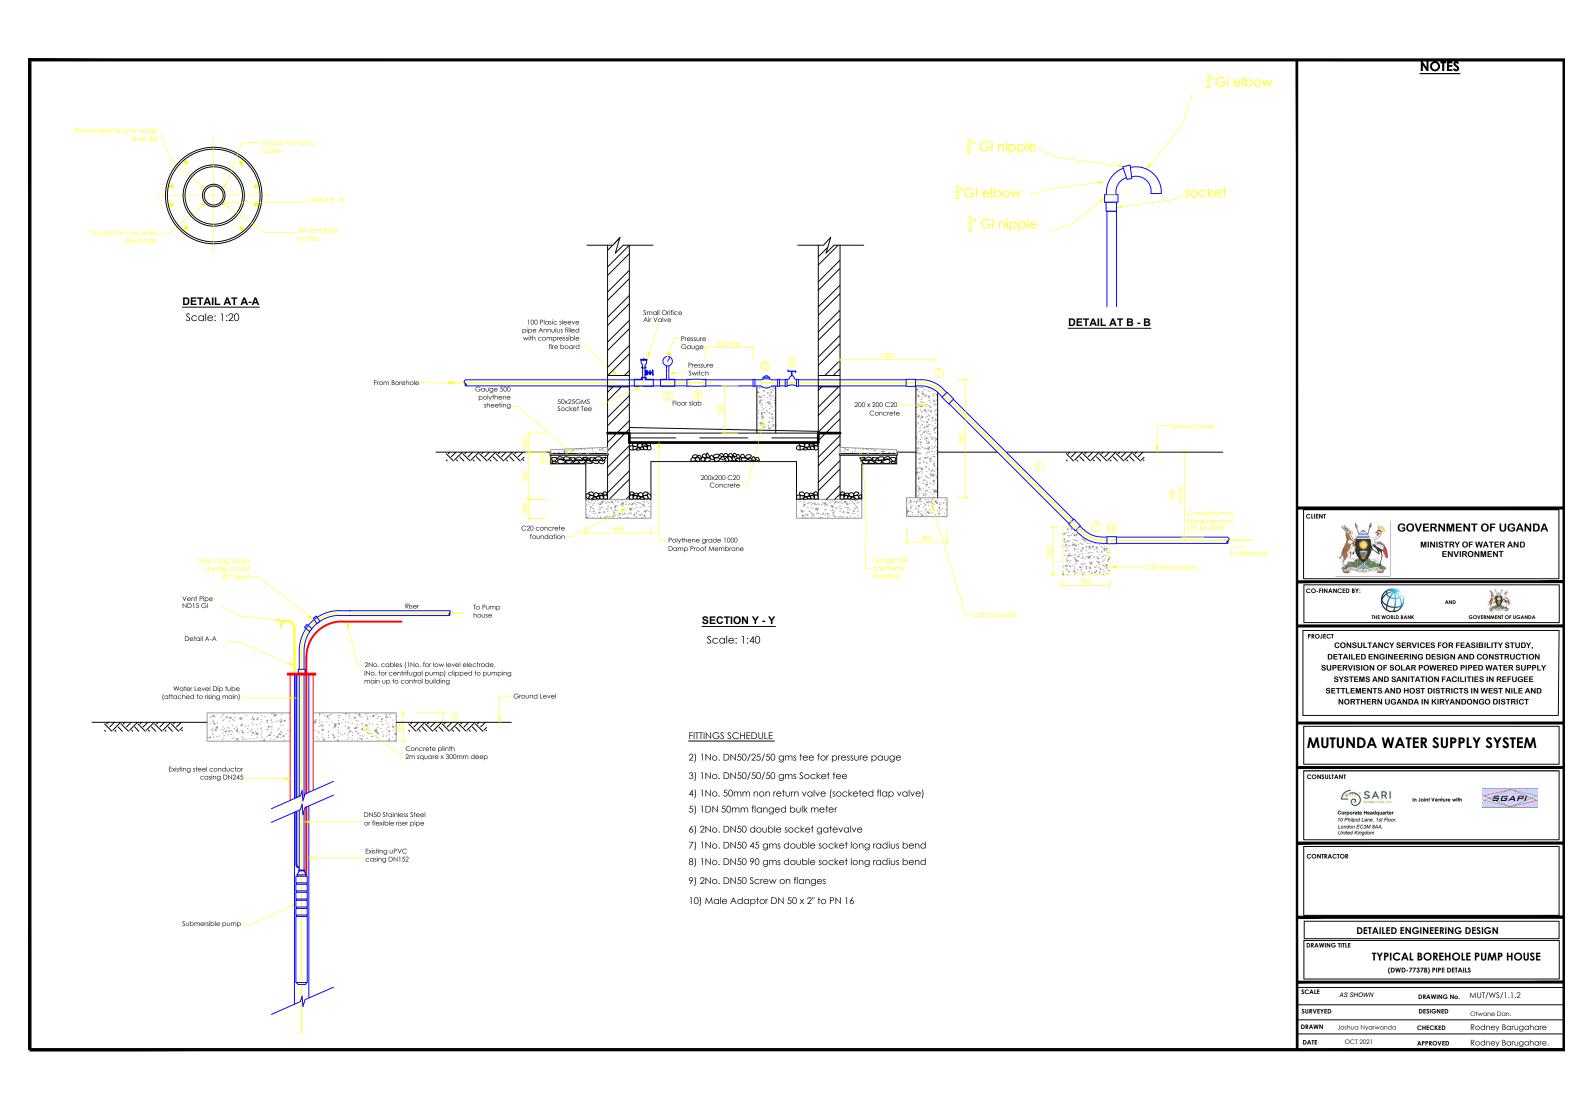







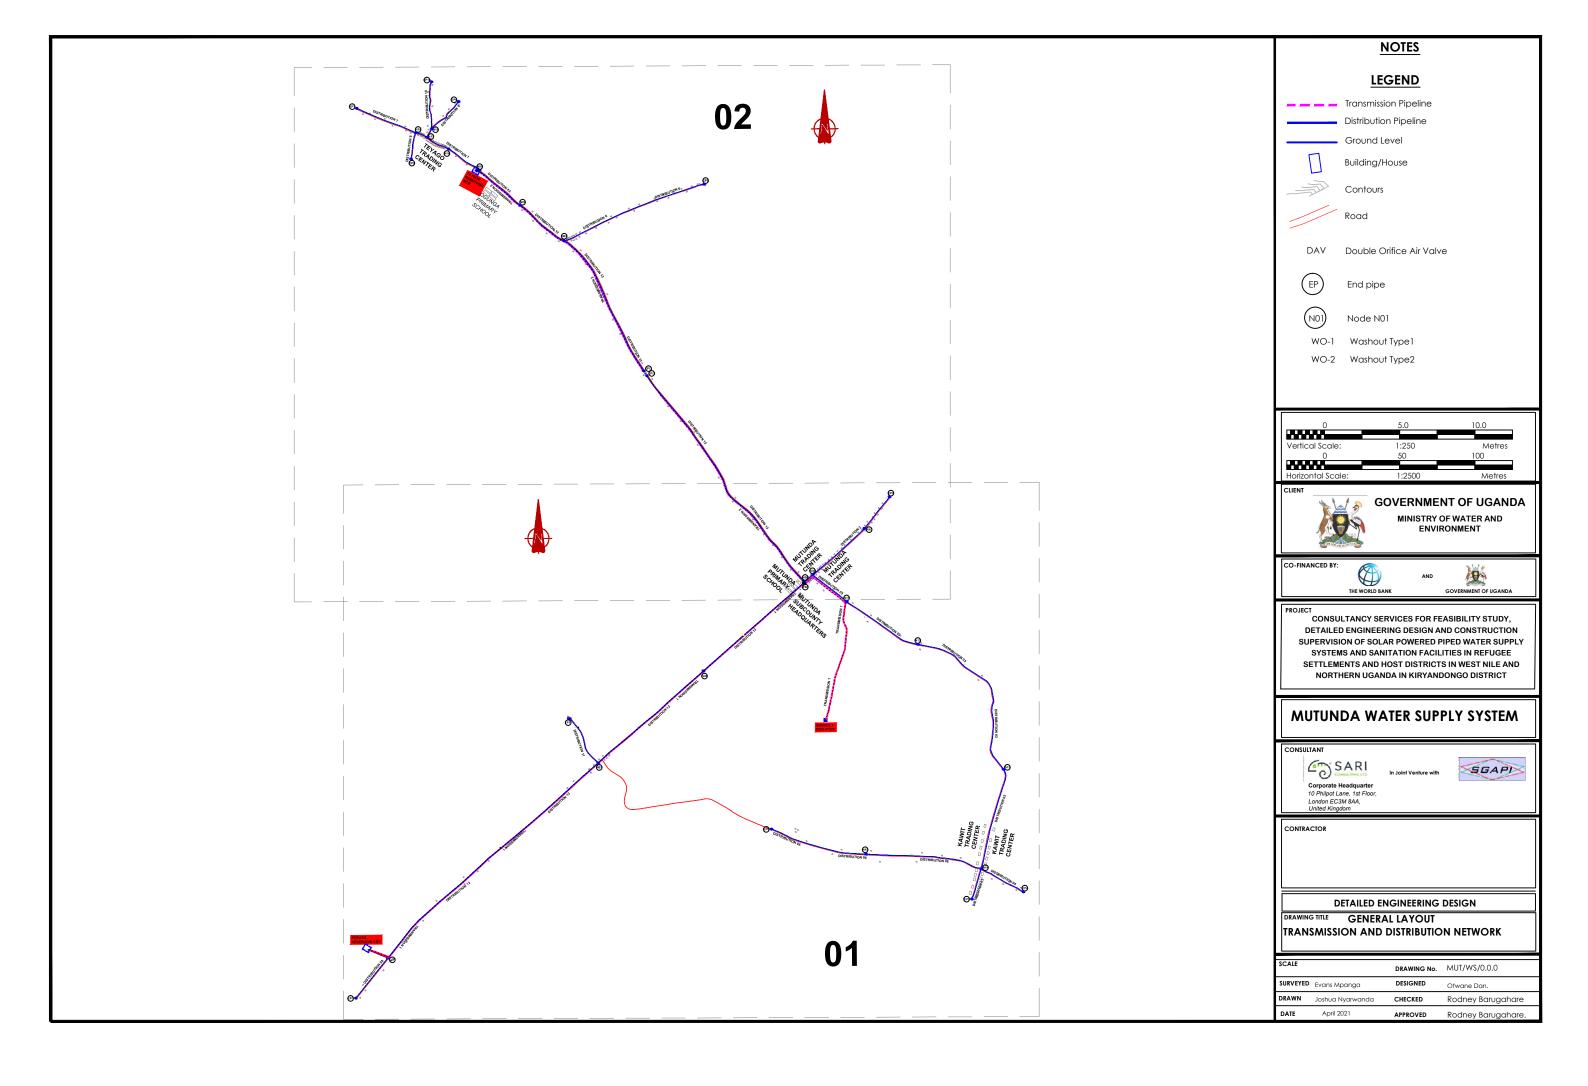

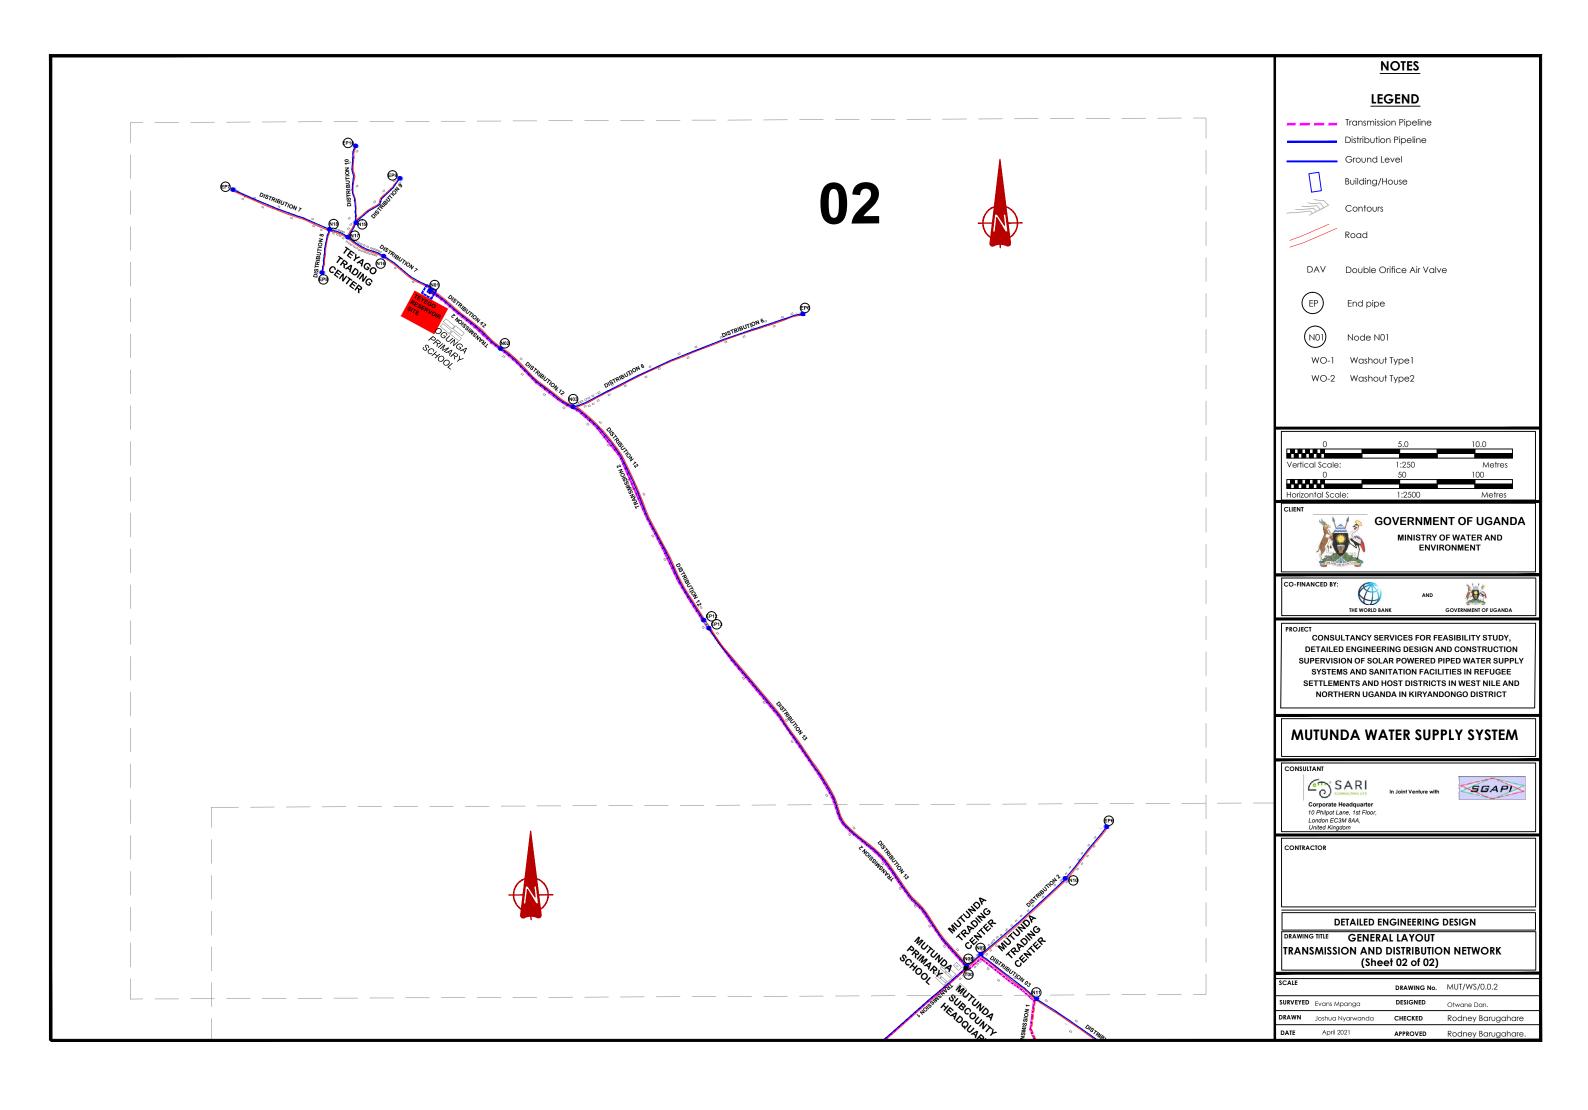


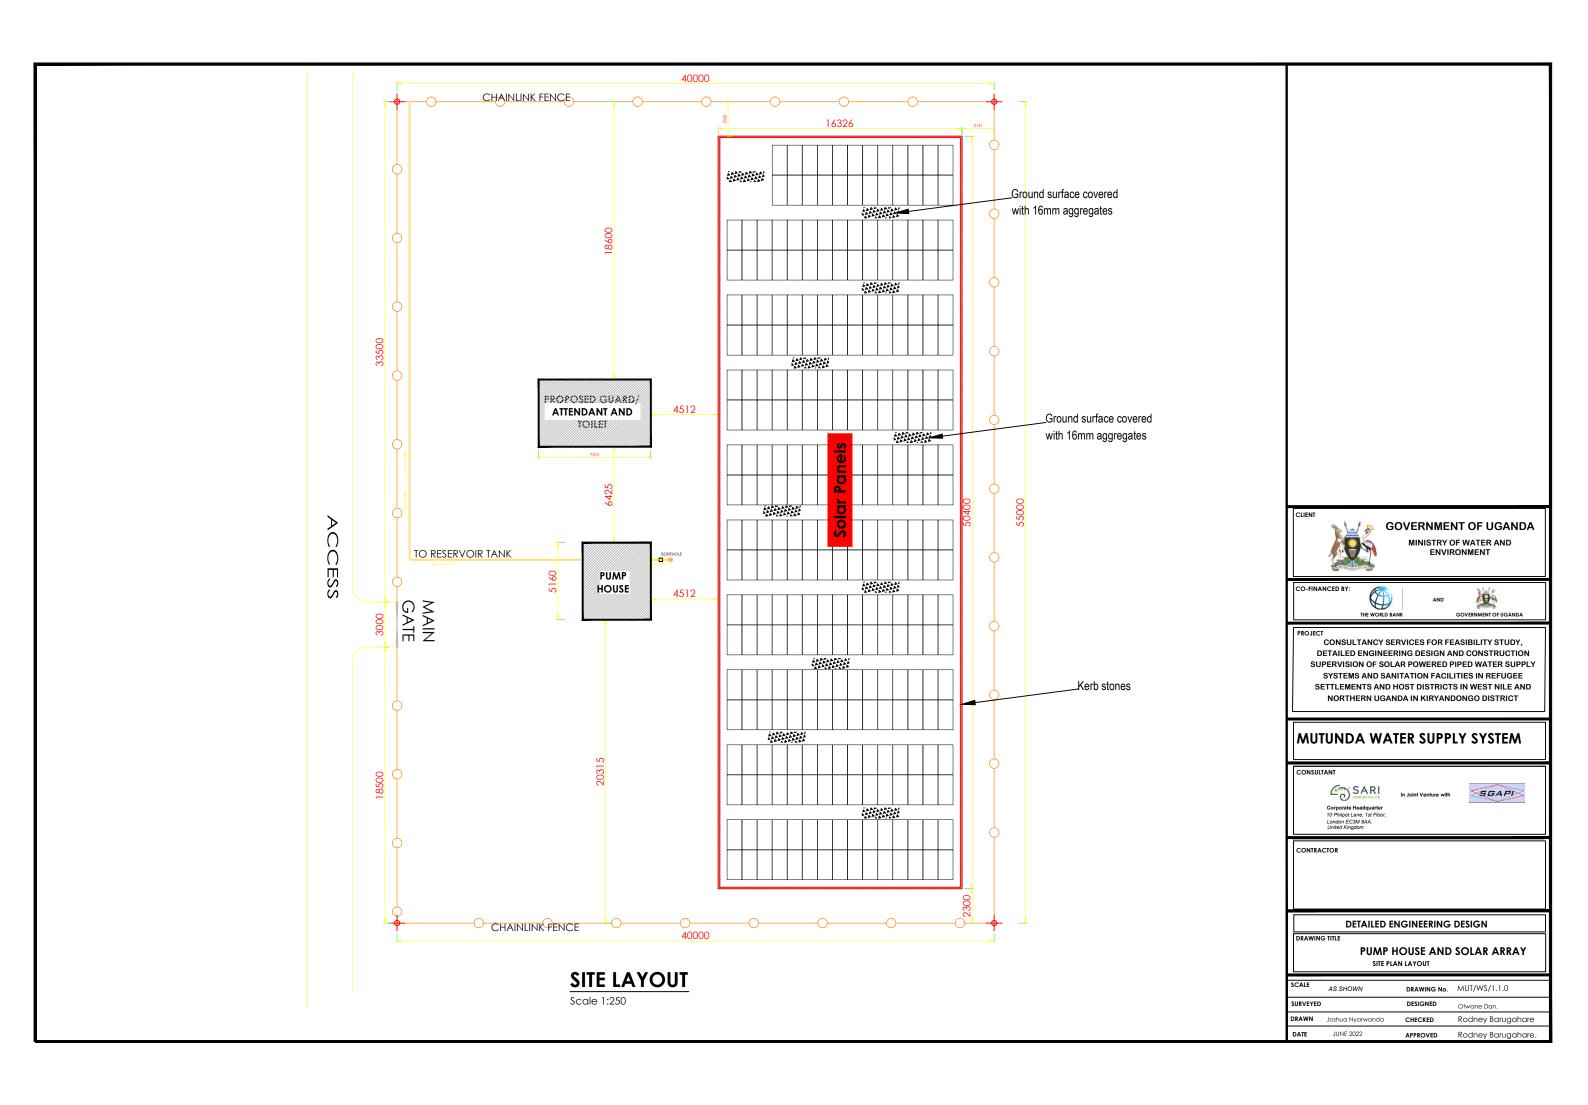

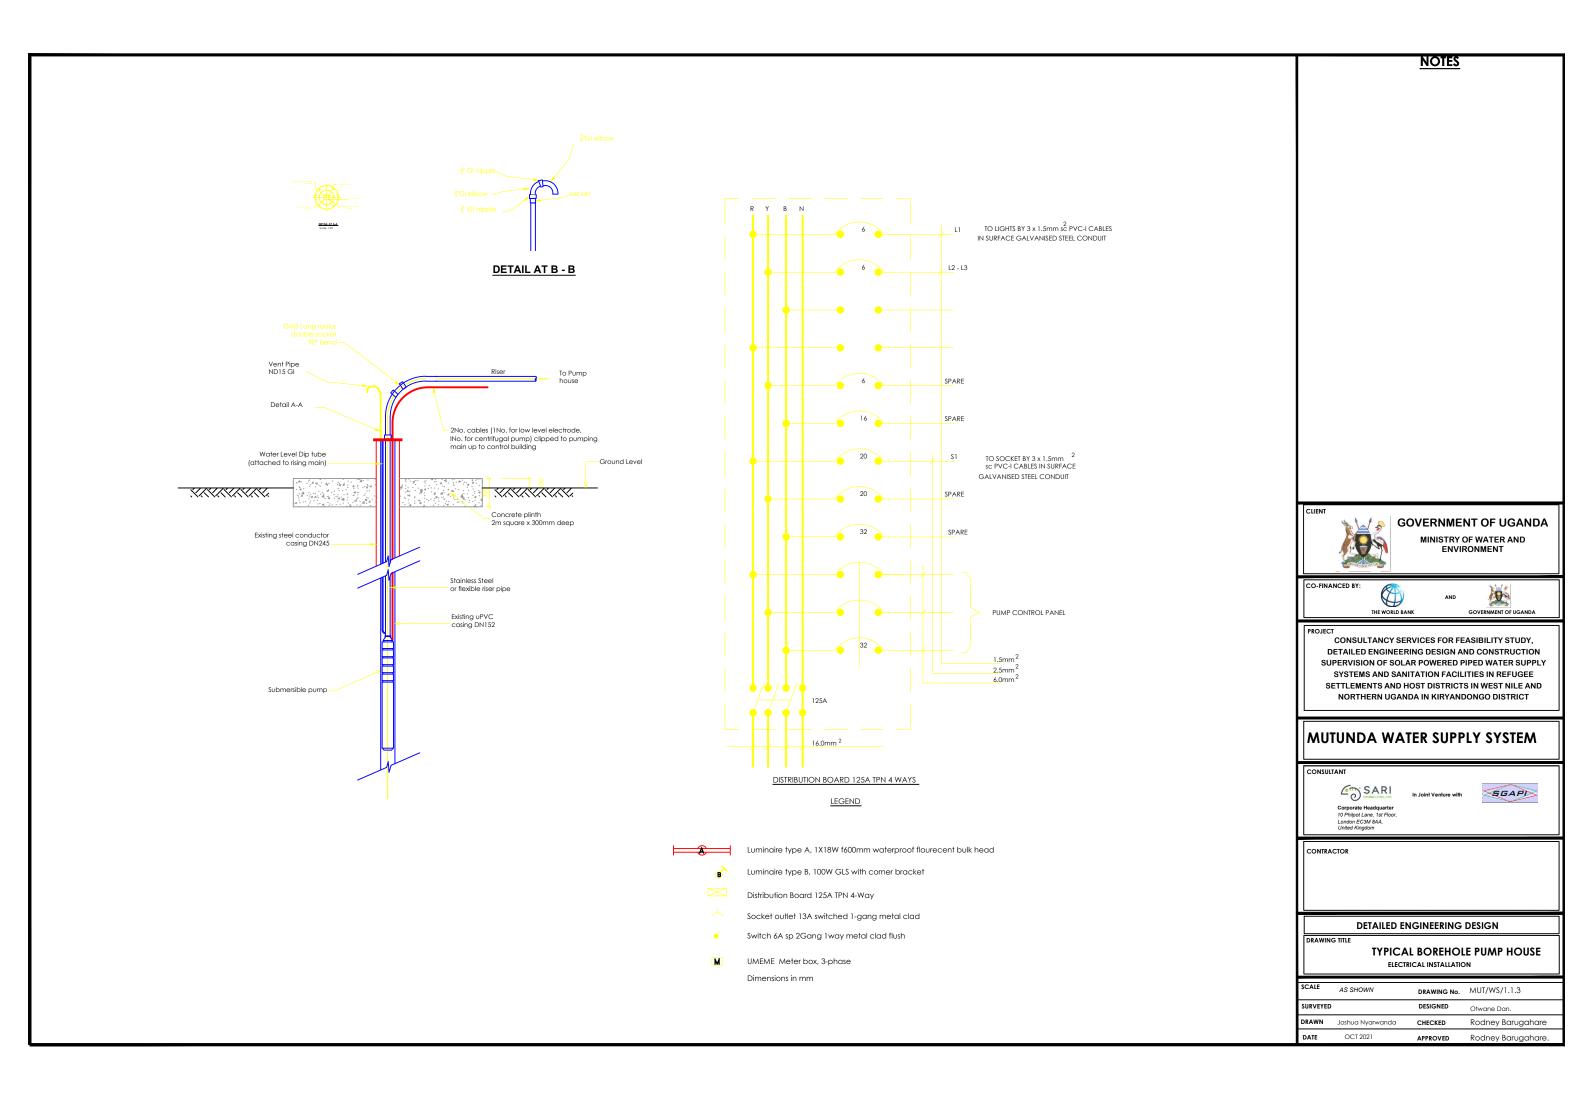

Controller

1 set 1-phase cable Well Probe V2, 2x PV Disconnect 1000-40-5, PV Combiner 1000-125-4,PV Protect 1000-125, SmartPSUk2-40,SmartStart, Surge Protector2

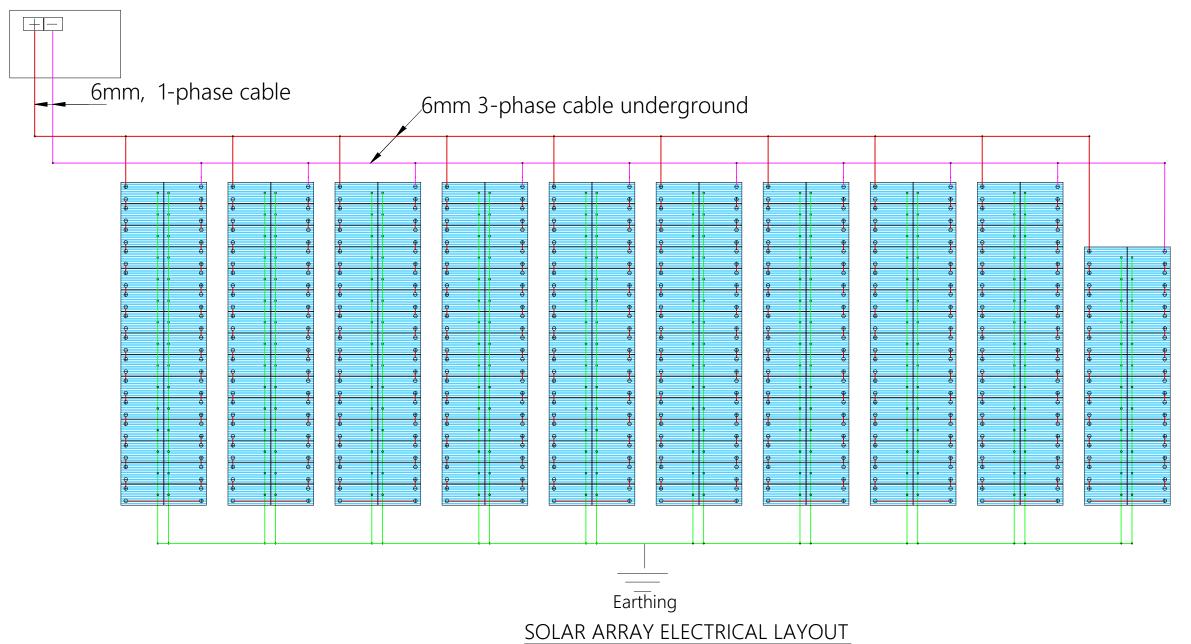

GOVERNMENT OF UGANDA

MINISTRY OF WATER AND
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CONSULTANCY SERVICES FOR FEASIBILITY STUDY,
DETAILED ENGINEERING DESIGN AND CONSTRUCTION
SUPERVISION OF SOLAR POWERED PIPED WATER SUPPLY
SYSTEMS AND SANITATION FACILITIES IN REFUGEE
SETTLEMENTS AND HOST DISTRICTS IN WEST NILE AND
NORTHERN UGANDA IN KIRYANDONGO DISTRICT

MUTUNDA WATER SUPPLY SYSTEM

CONSULTANT

SARI SARI


SGAPI


CONTRACTOR


DETAILED ENGINEERING DESIGN


SOLAR ARRAY
Electrical Layout


SCALE	AS SHOWN	DRAWING No.	MUT/WS/1.1.4
SURVEYED)	DESIGNED	Otwane Dan.
DRAWN	Joshua Nyarwanda	CHECKED	Rodney Barugahare
DATE	JUNE 2022	APPROVED	Rodney Barugahare.

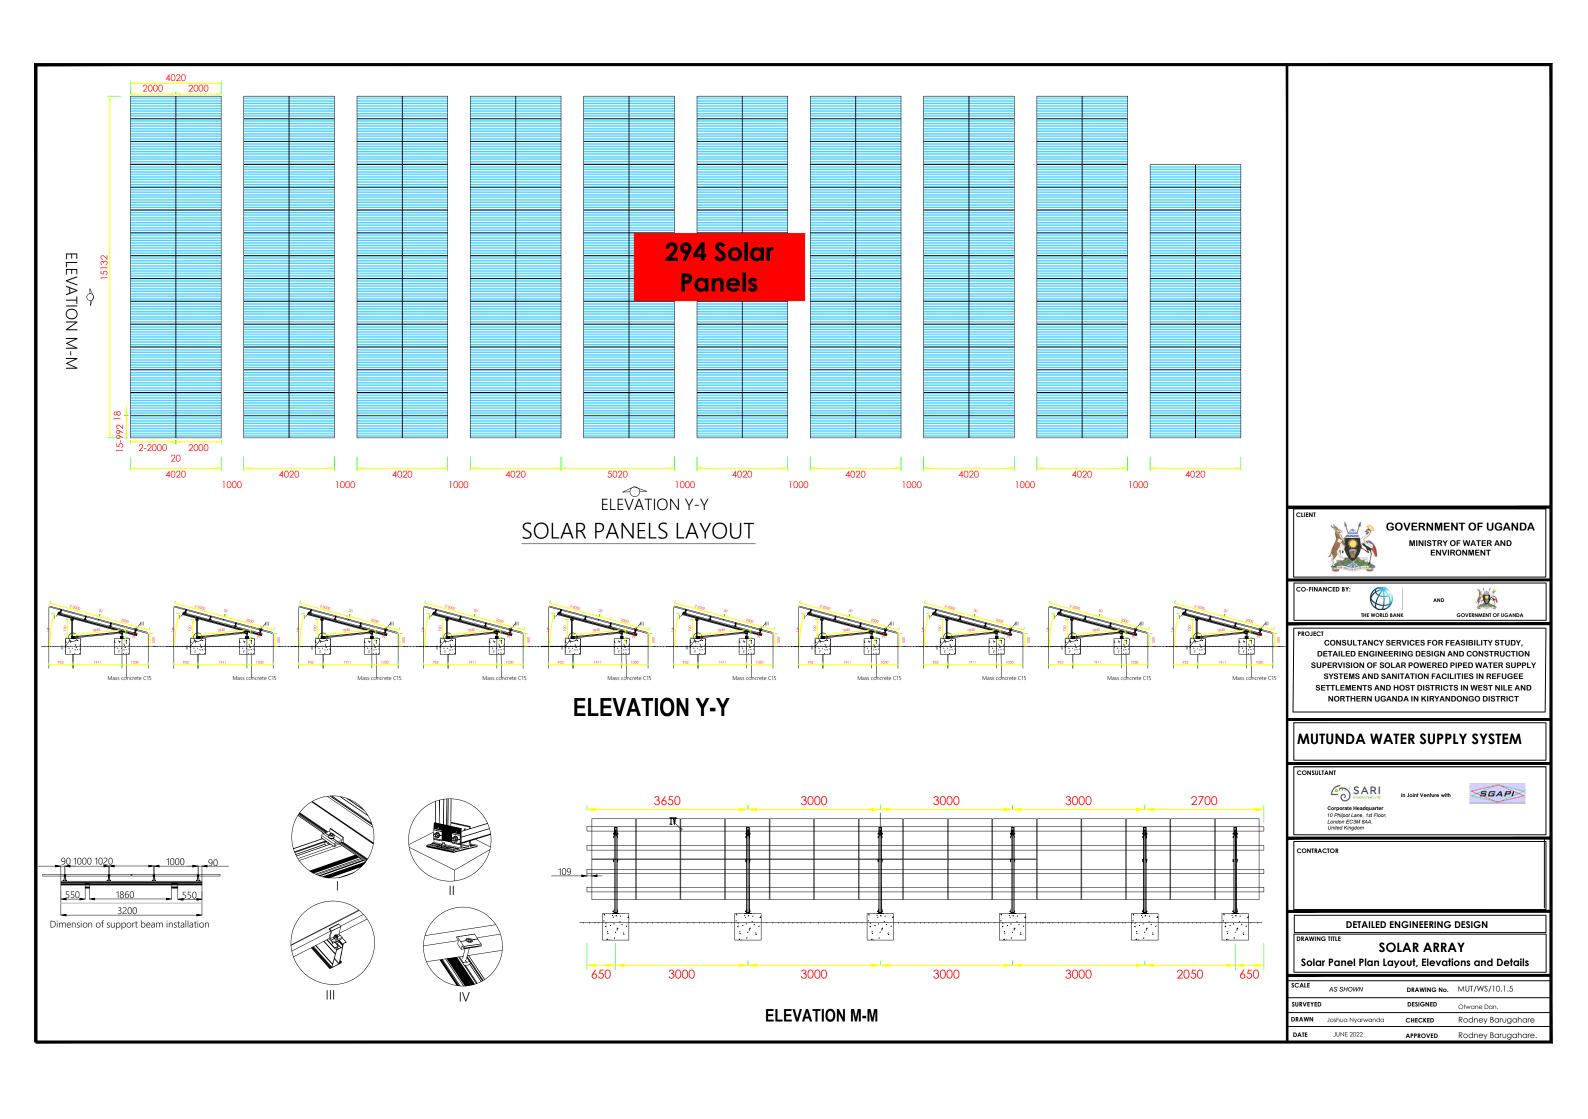


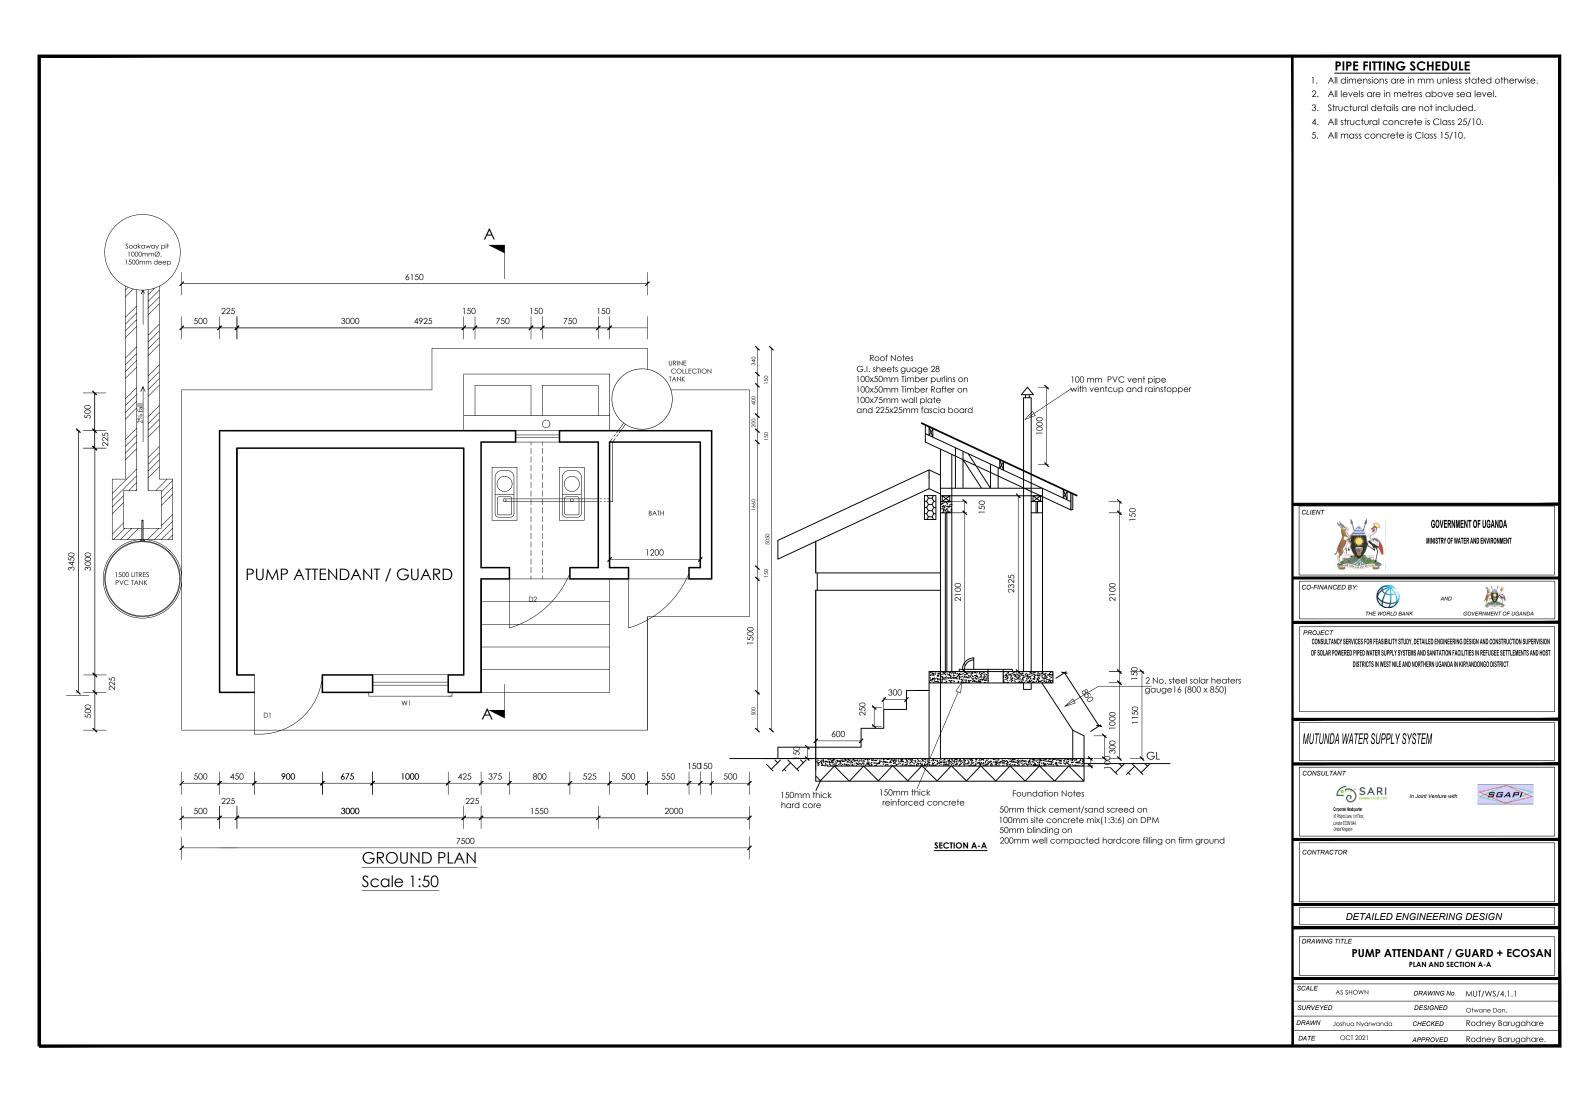


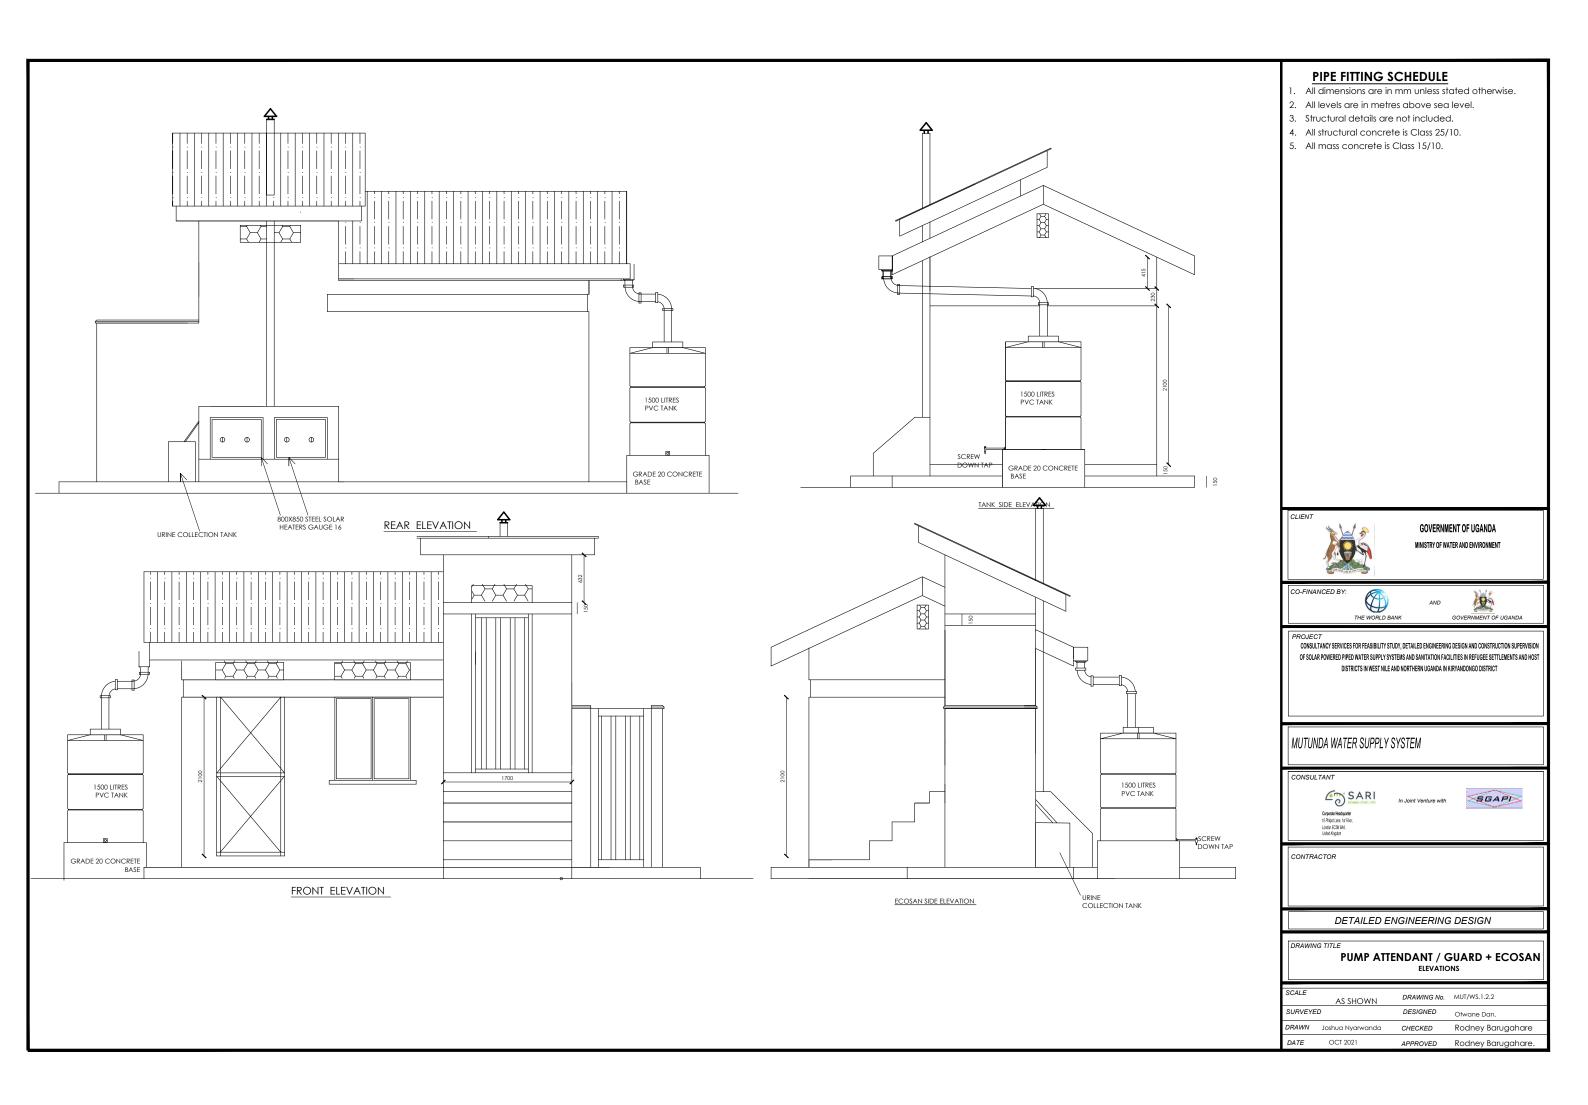


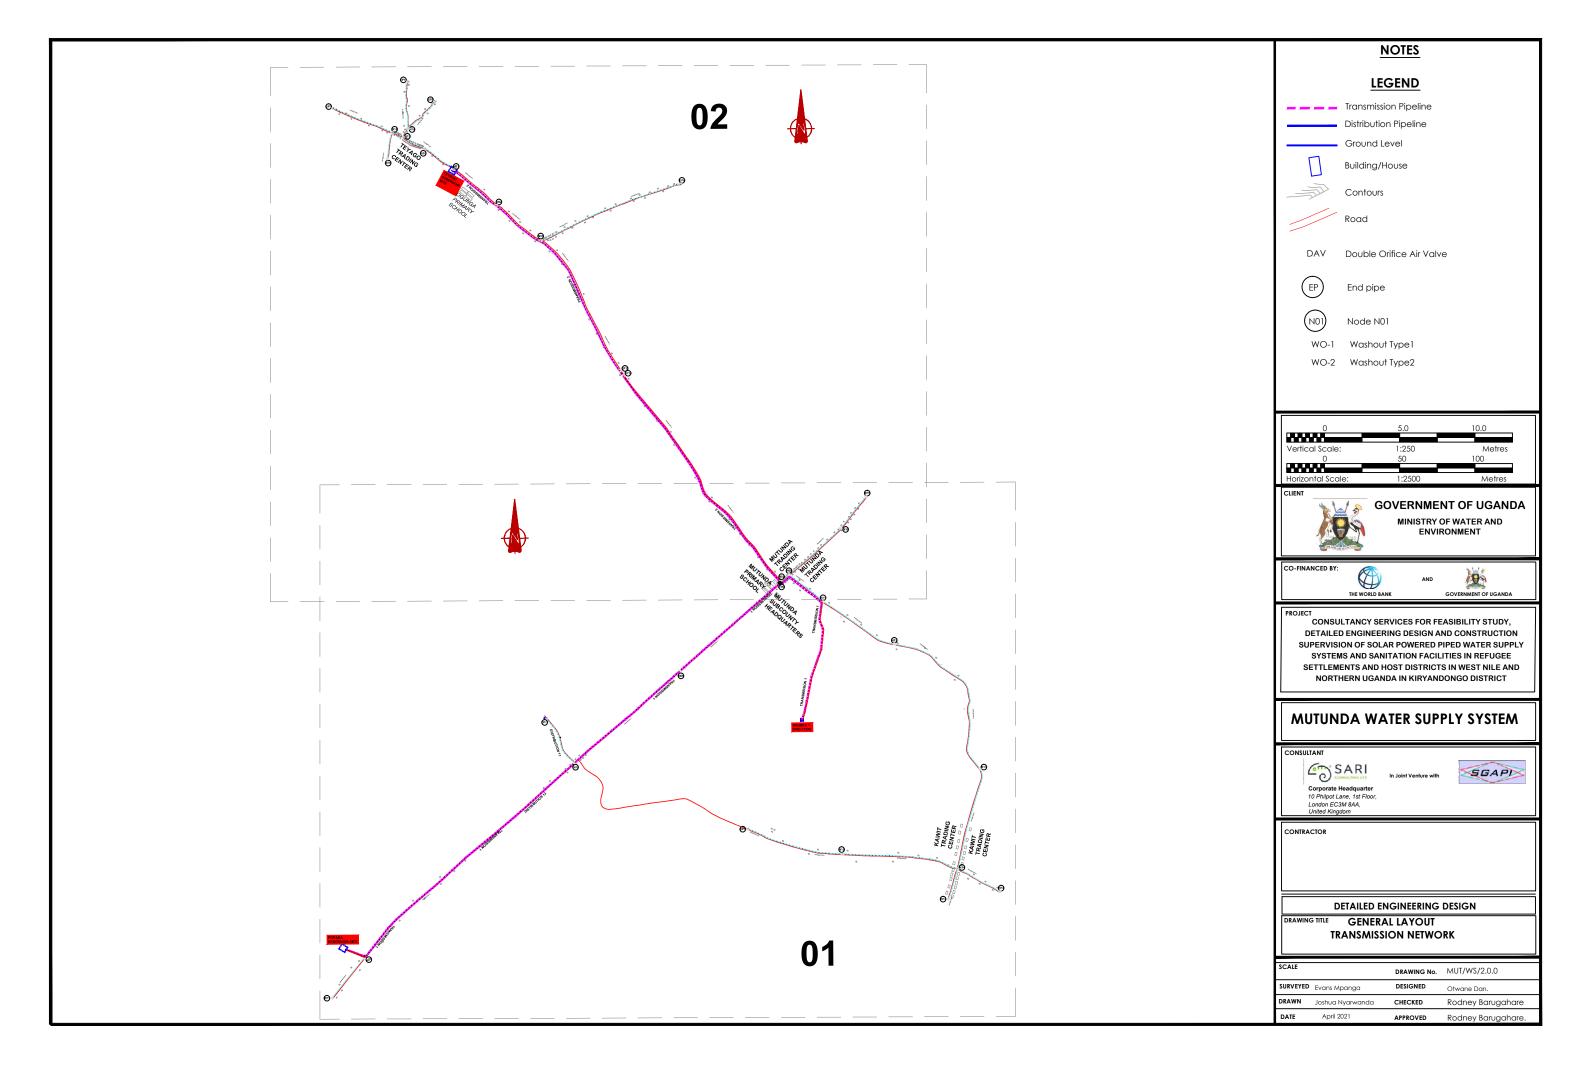

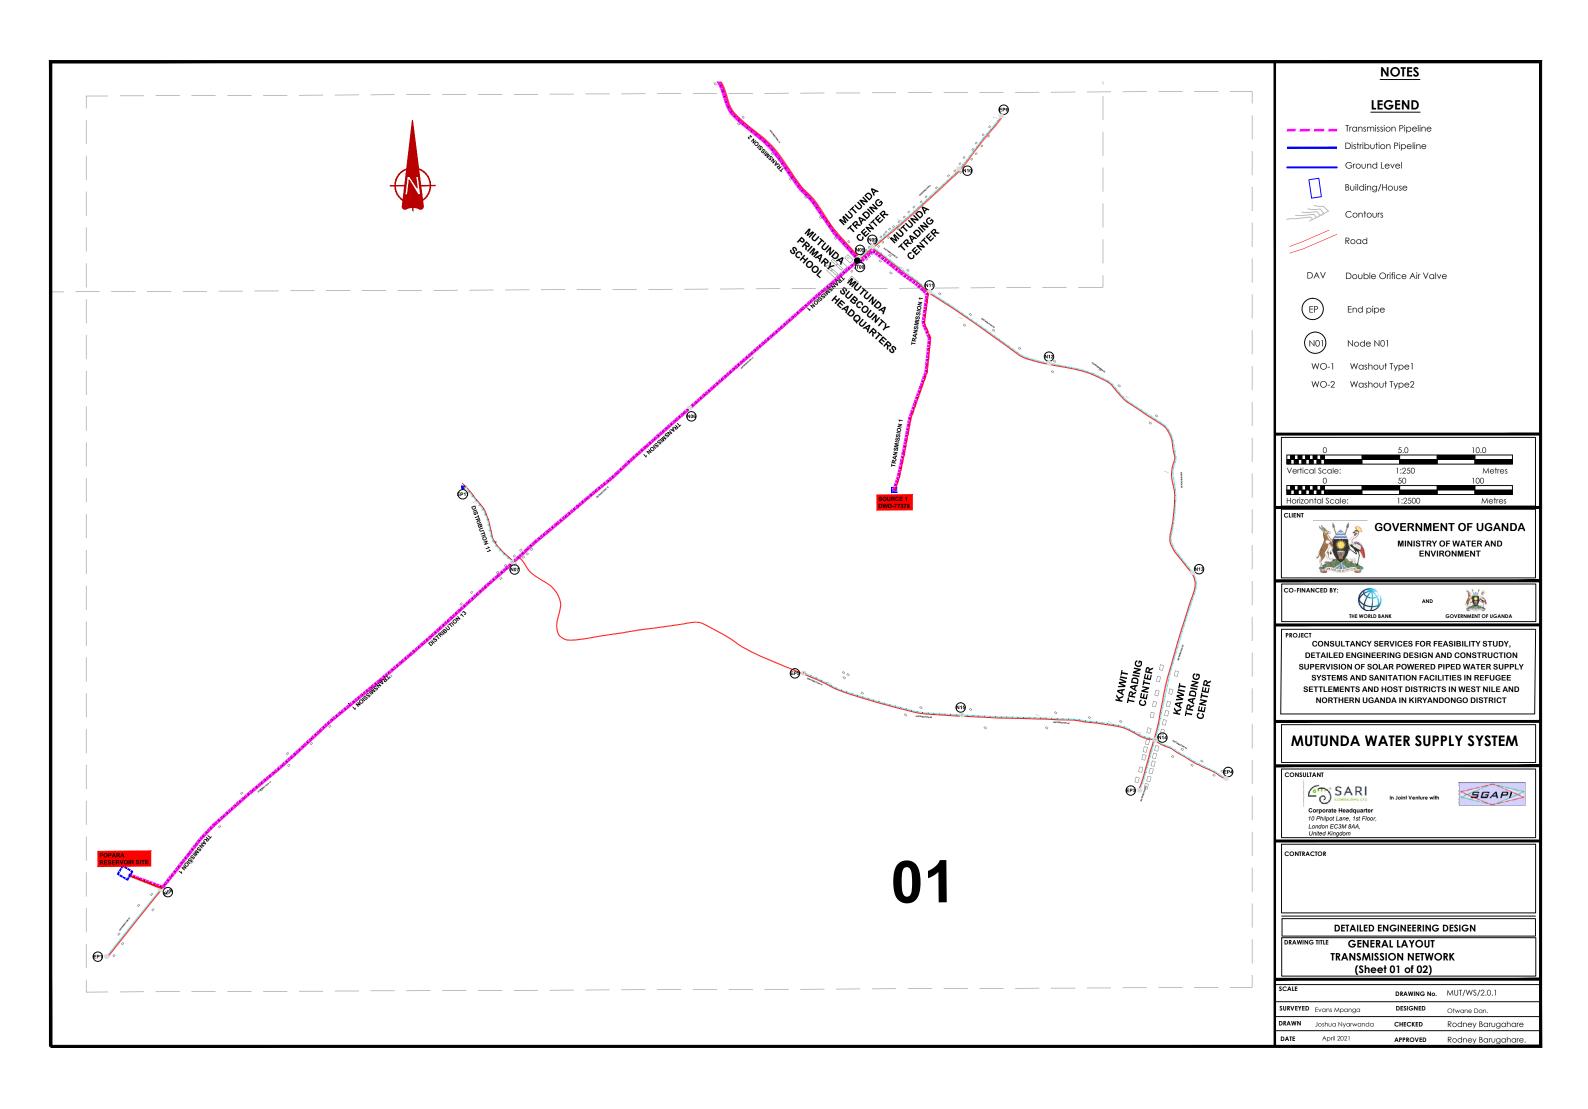

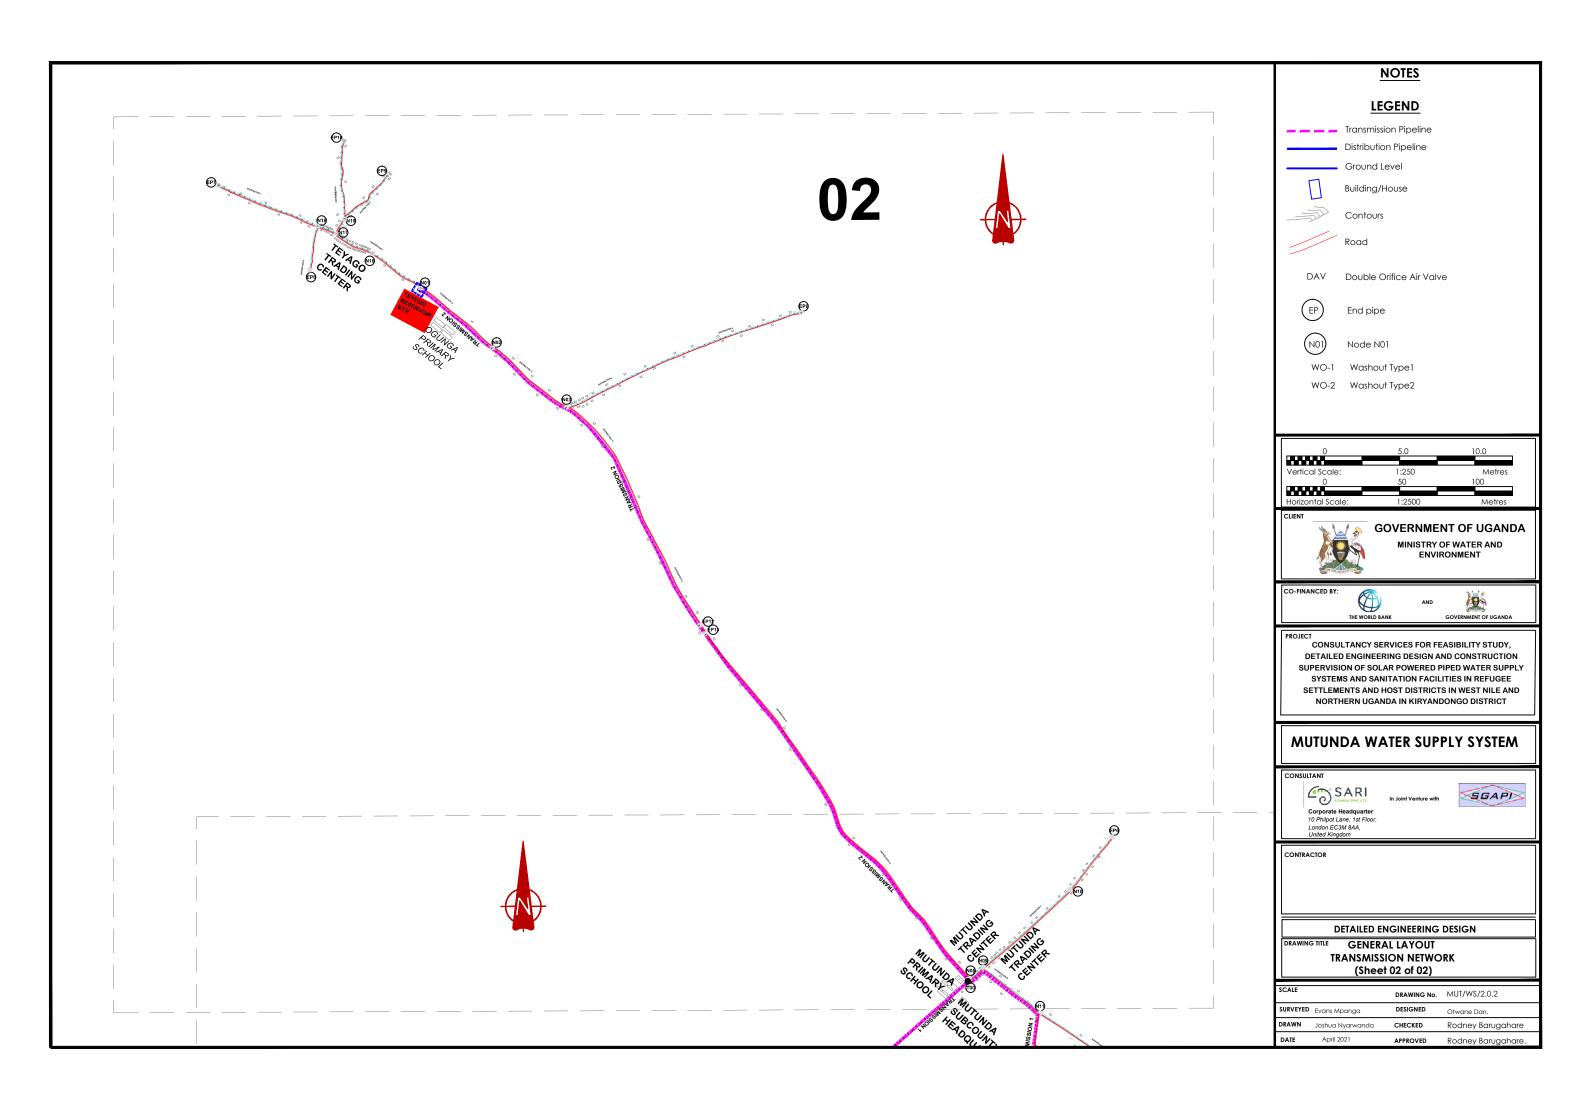

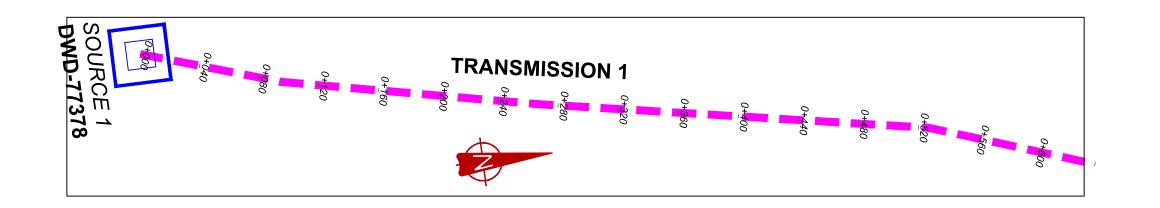

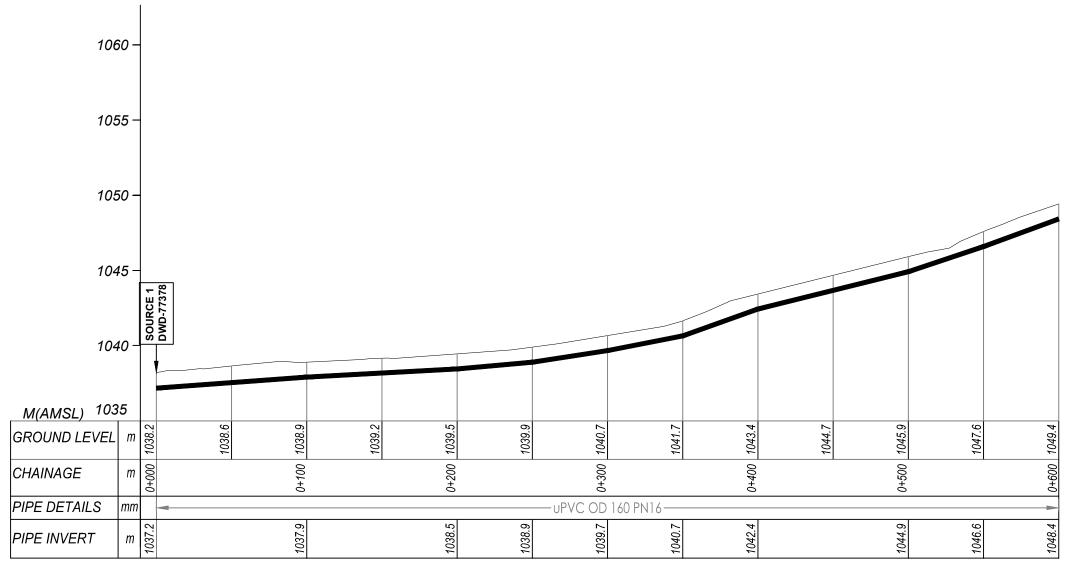

TRANSMISSION 1 (0+000.00 - 0+600.00)

NOTES

LEGEND

Transmission Pipeline
Distribution Pipeline
Ground Level



Building/House



Contours



DAV Double Orifice Air Valve




End pipe



Node N01

WO-2 Washout Type2

WO-1 Washout Type 1

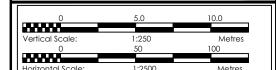



GOVERNMENT OF UGANDA MINISTRY OF WATER AND ENVIRONMENT

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PROJECT

CONSULTANCY SERVICES FOR FEASIBILITY STUDY,
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SUPERVISION OF SOLAR POWERED PIPED WATER SUPPLY
SYSTEMS AND SANITATION FACILITIES IN REFUGEE
SETTLEMENTS AND HOST DISTRICTS IN WEST NILE AND
NORTHERN UGANDA IN KIRYANDONGO DISTRICT

MUTUNDA WATER SUPPLY SYSTEM

Corporate Headquarter 10 Philipot Lane, 1st Floor, London EC3M 8AA, United Kingdom

In Joint Venture with





CONTRACTO


DETAILED ENGINEERING DESIGN


TRANSMISSION LINE 01 (0+000.00 - 0+600.00)


SCALE	VERT; 1:250 HOR; 1:2500	DRAWING No.	MUT/WS/2.1.1
SURVEYED	Evans Mpanga	DESIGNED	Otwane Dan.
DRAWN	Joshua Nyarwanda	CHECKED	Rodney Barugahare
DATE	April 2021	APPROVED	Rodney Barugahare.

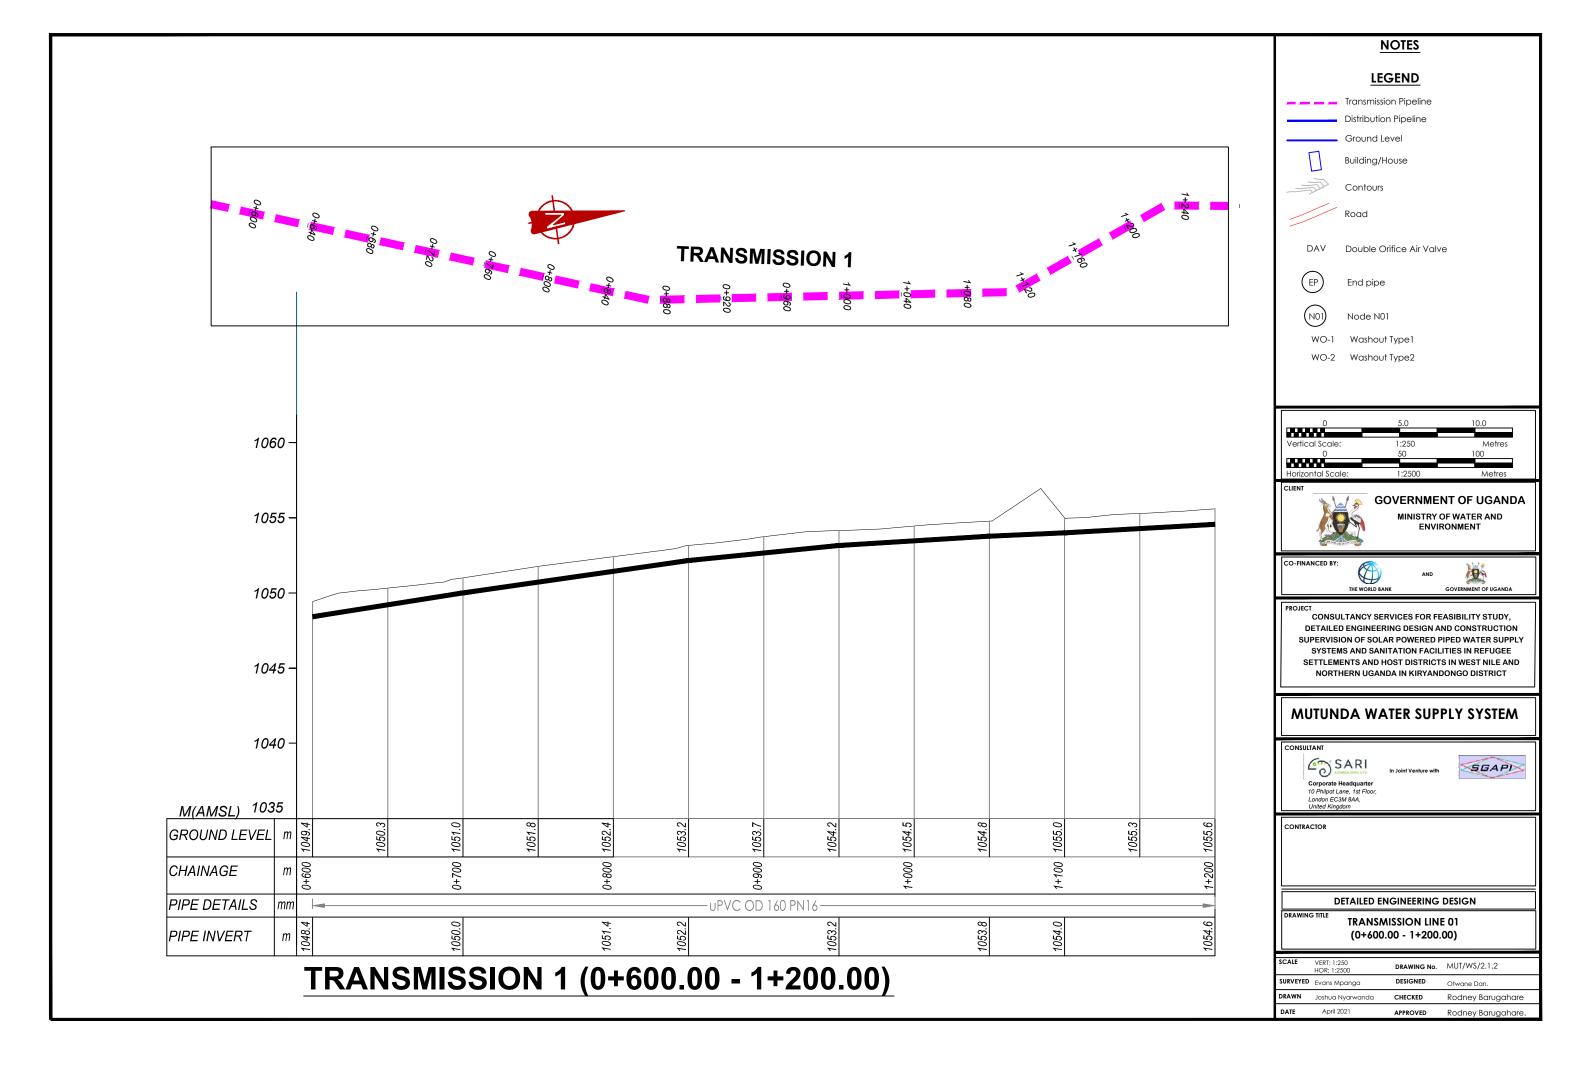

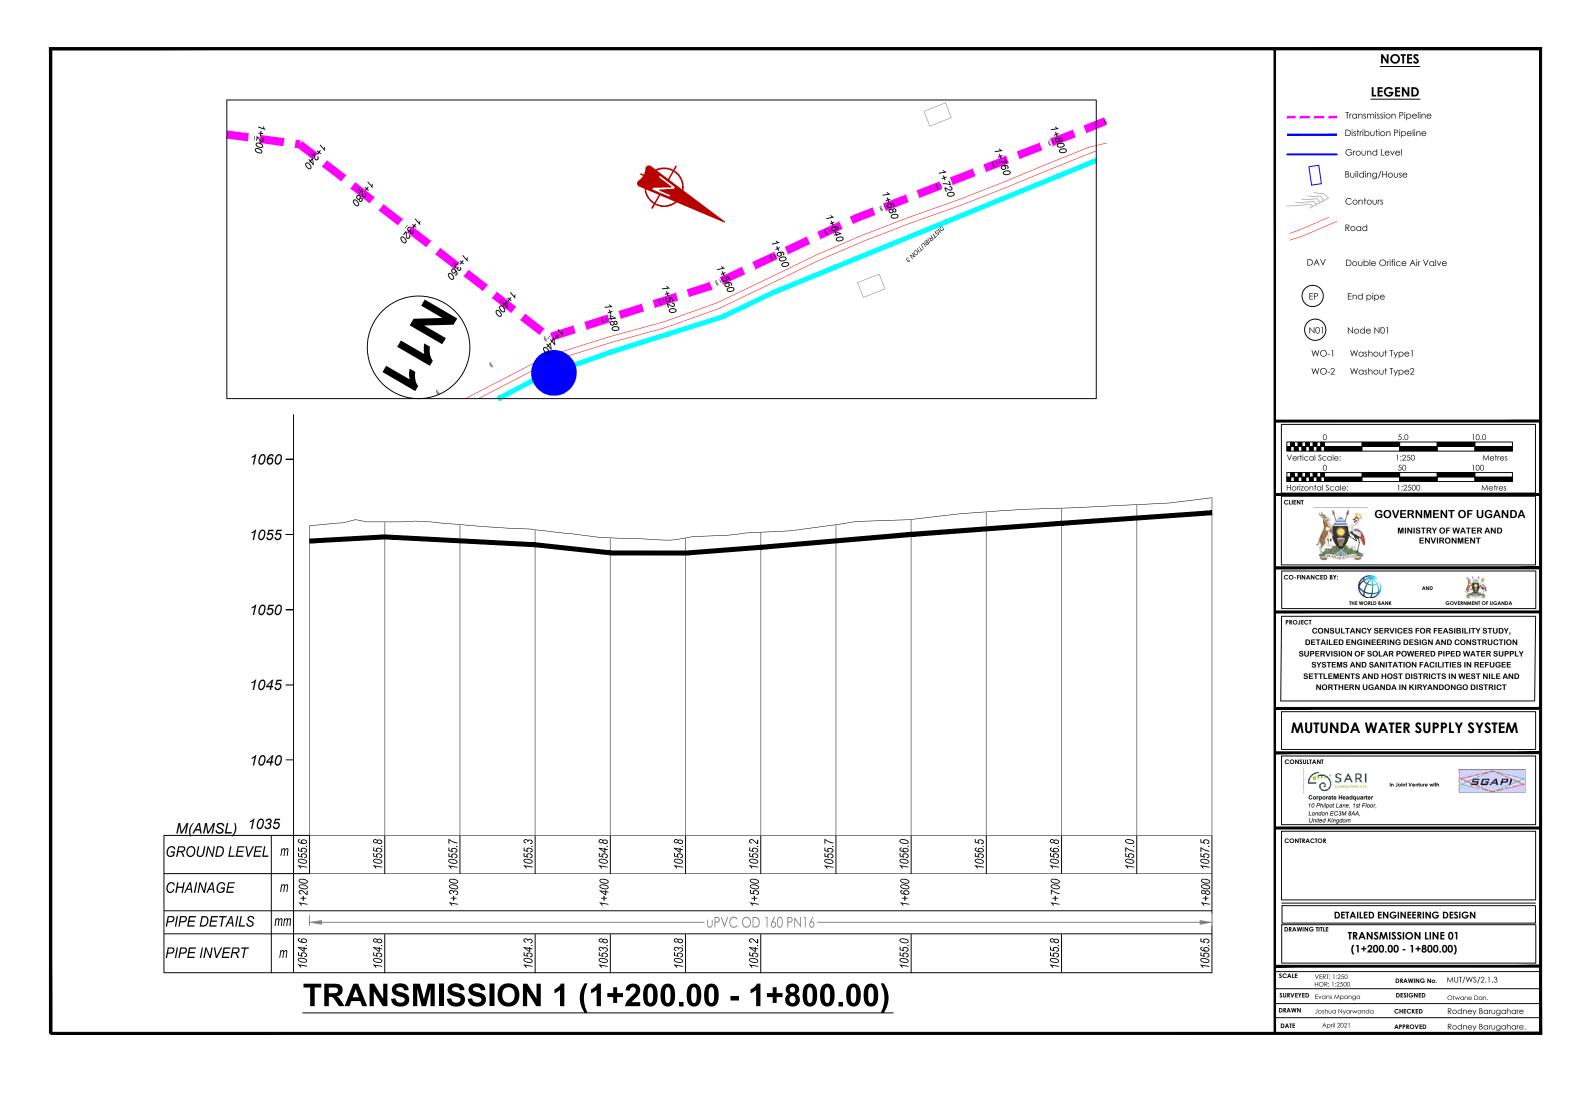

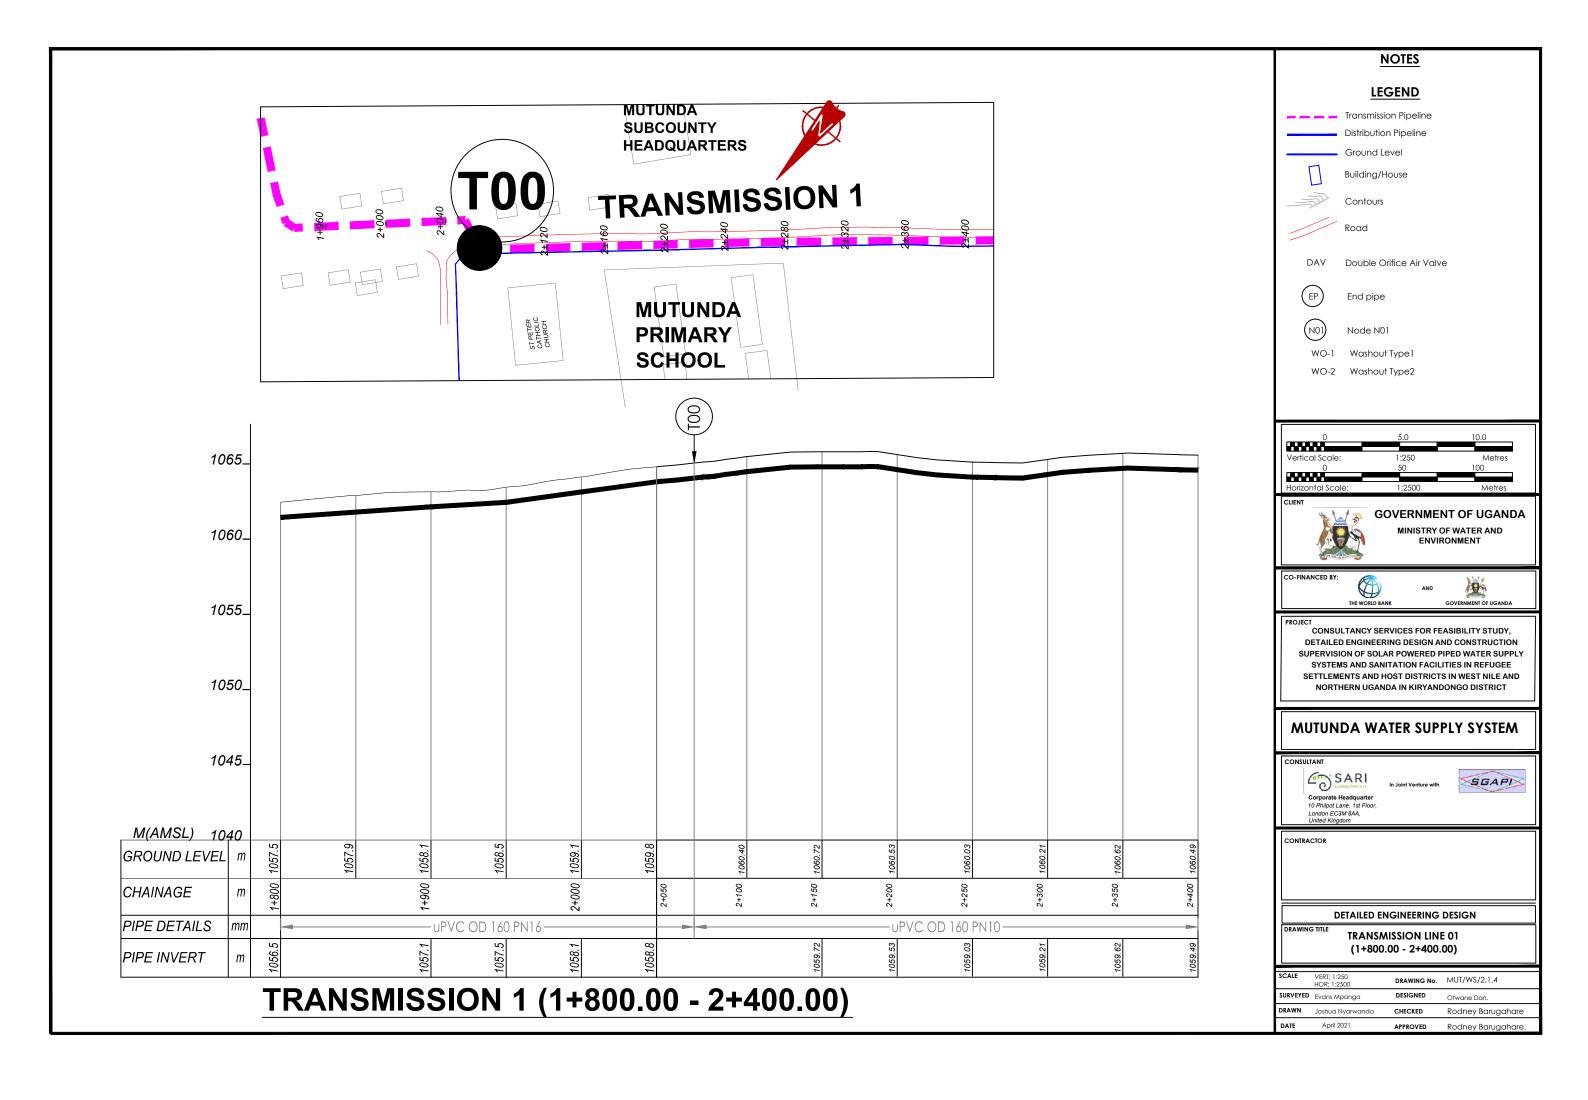

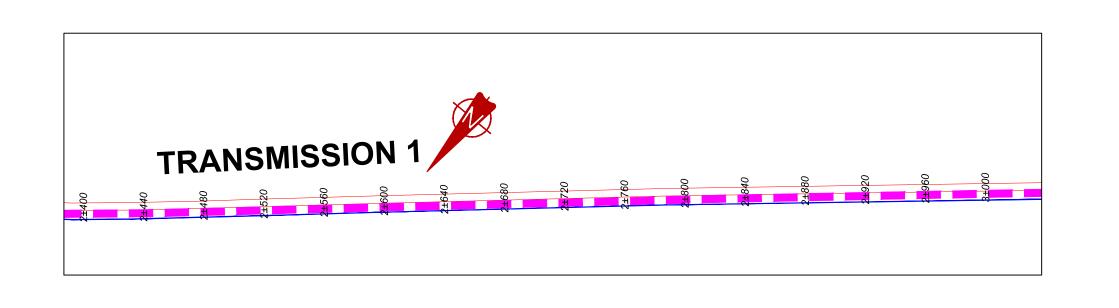

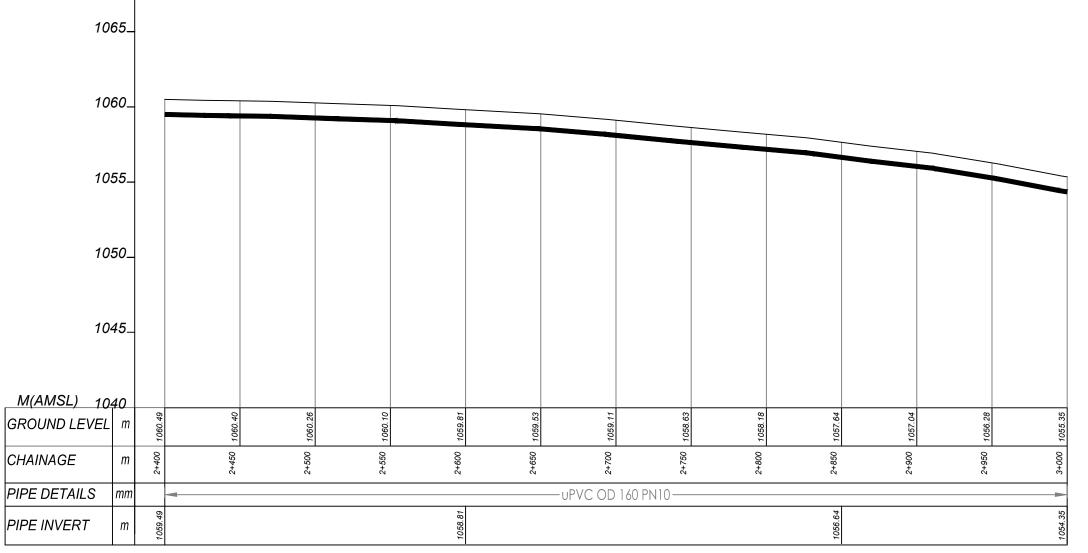

TRANSMISSION 1 (2+400.00 - 3+000.00)

NOTES

LEGEND

Transmission Pipeline
Distribution Pipeline
Ground Level



Building/House



Contours



DAV Double Orifice Air Valve



End pipe


Road



Node N01

WO-1 Washout Type1

WO-2 Washout Type2

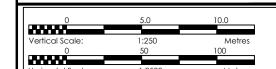



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AND



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MUTUNDA WATER SUPPLY SYSTEM

Corporate Headquarter
10 Philipot Lane, 1st Floor,
London EC3M 8AA,
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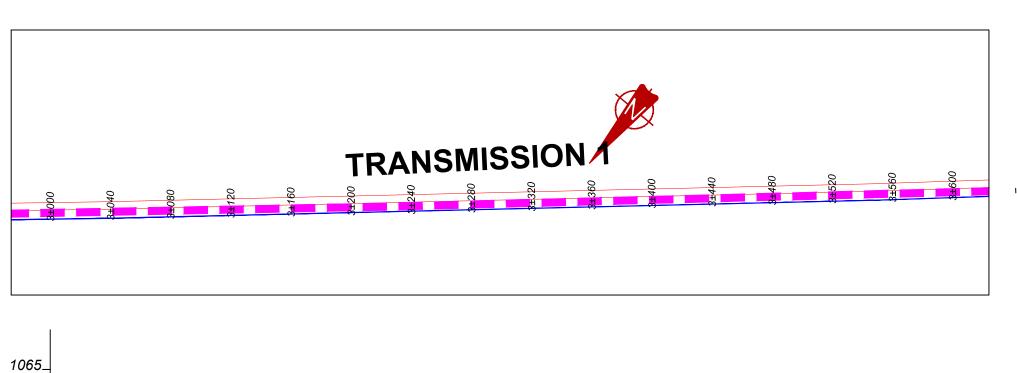



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DETAILED ENGINEERING DESIGN

TRANSMISSION LINE 01 (2+400.00 - 3+000.00)

SCALE	VERT; 1:250 HOR; 1:2500	DRAWING No.	MUT/WS/2.1.5
SURVEYED	Evans Mpanga	DESIGNED	Otwane Dan.
DRAWN	Joshua Nyarwanda	CHECKED	Rodney Barugahare
DATE	April 2021	APPROVED	Rodney Barugahare.



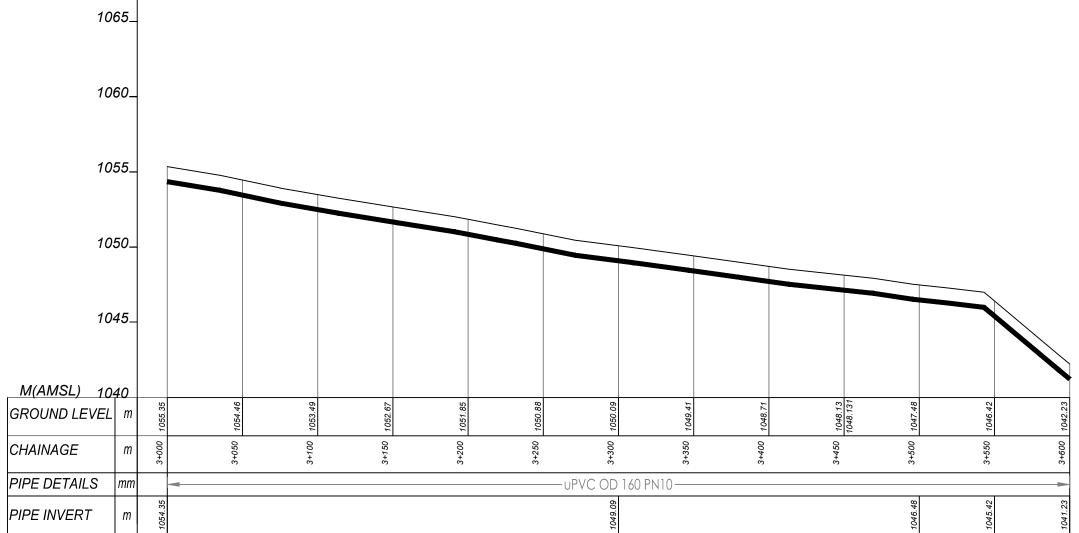

TRANSMISSION 1 (3+000.00 - 3+600.00)

NOTES

LEGEND

Transmission Pipeline Distribution Pipeline Ground Level



Building/House



Contours



DAV Double Orifice Air Valve



End pipe


Road



Node N01

WO-2 Washout Type2

WO-1 Washout Type 1

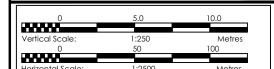



GOVERNMENT OF UGANDA MINISTRY OF WATER AND ENVIRONMENT





CONSULTANCY SERVICES FOR FEASIBILITY STUDY, DETAILED ENGINEERING DESIGN AND CONSTRUCTION SUPERVISION OF SOLAR POWERED PIPED WATER SUPPLY SYSTEMS AND SANITATION FACILITIES IN REFUGEE SETTLEMENTS AND HOST DISTRICTS IN WEST NILE AND NORTHERN UGANDA IN KIRYANDONGO DISTRICT

MUTUNDA WATER SUPPLY SYSTEM


SARI Corporate Headquarter 10 Philpot Lane, 1st Floor, London EC3M 8AA, United Kingdom





DETAILED ENGINEERING DESIGN


TRANSMISSION LINE 01 (3+000.00 - 3+600.00)

SCALE	VERT; 1:250 HOR; 1:2500	DRAWING No.	MUT/WS/2.1.6
SURVEYED	Evans Mpanga	DESIGNED	Otwane Dan.
DRAWN	Joshua Nyarwanda	CHECKED	Rodney Barugahare
DATE	April 2021	APPROVED	Rodney Barugahare.

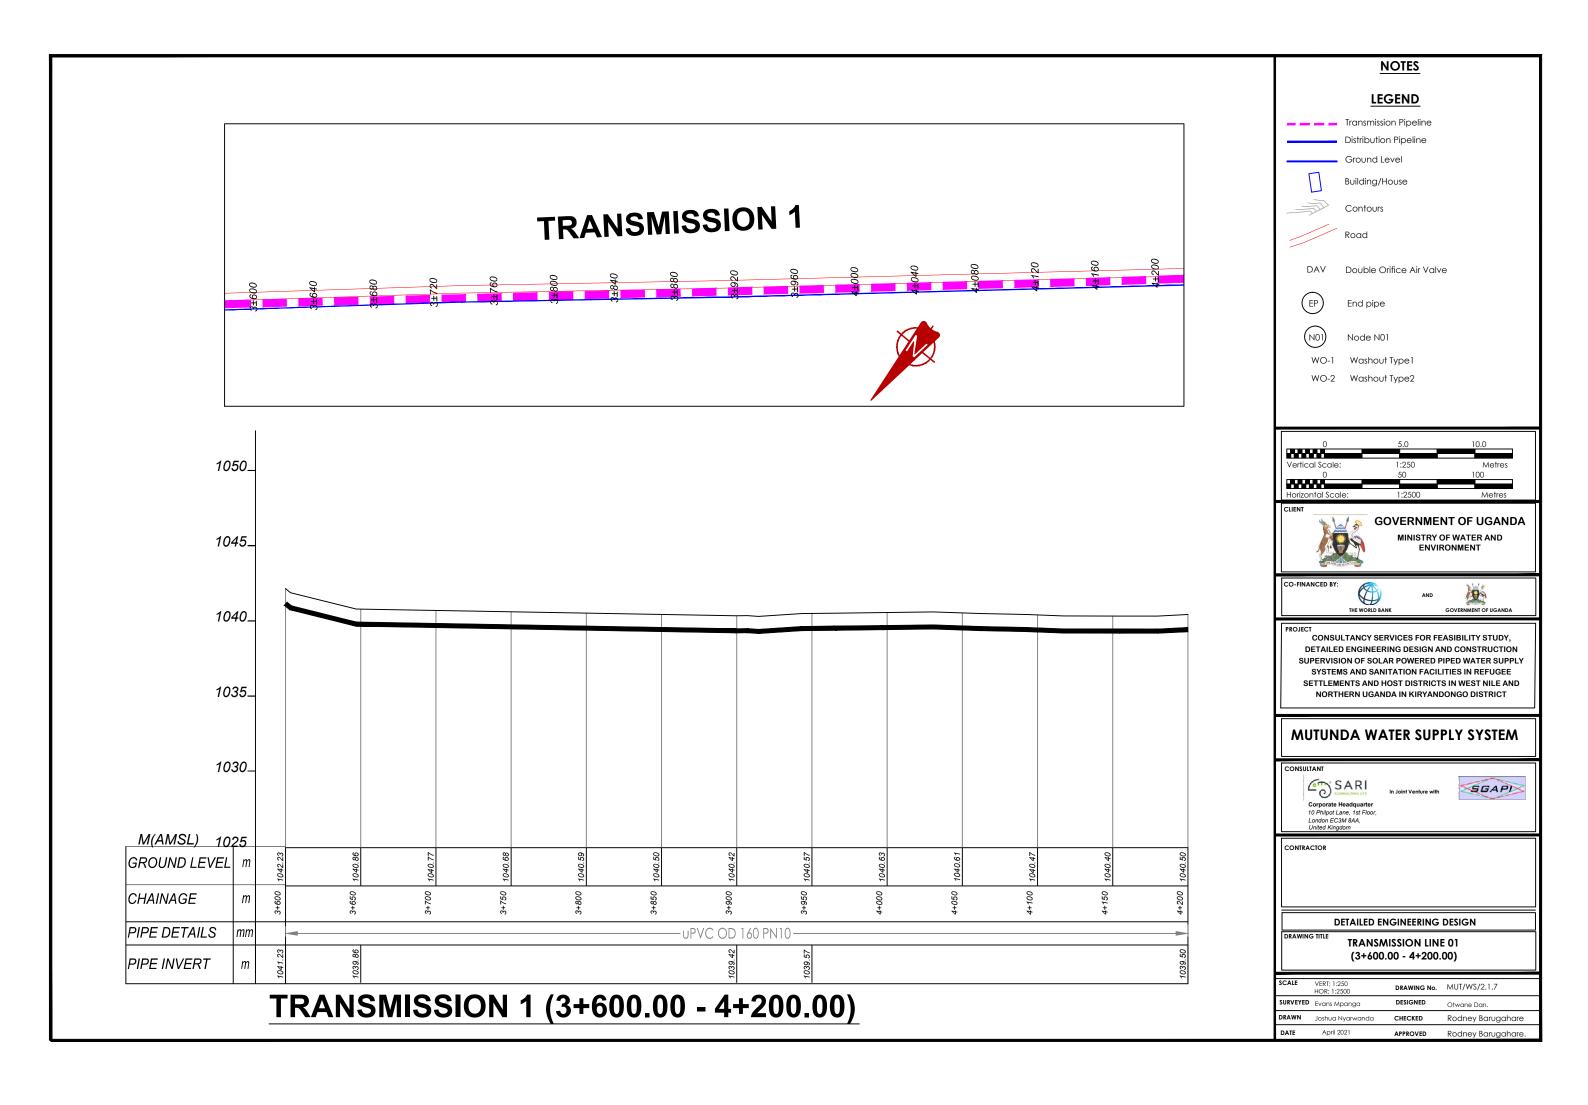

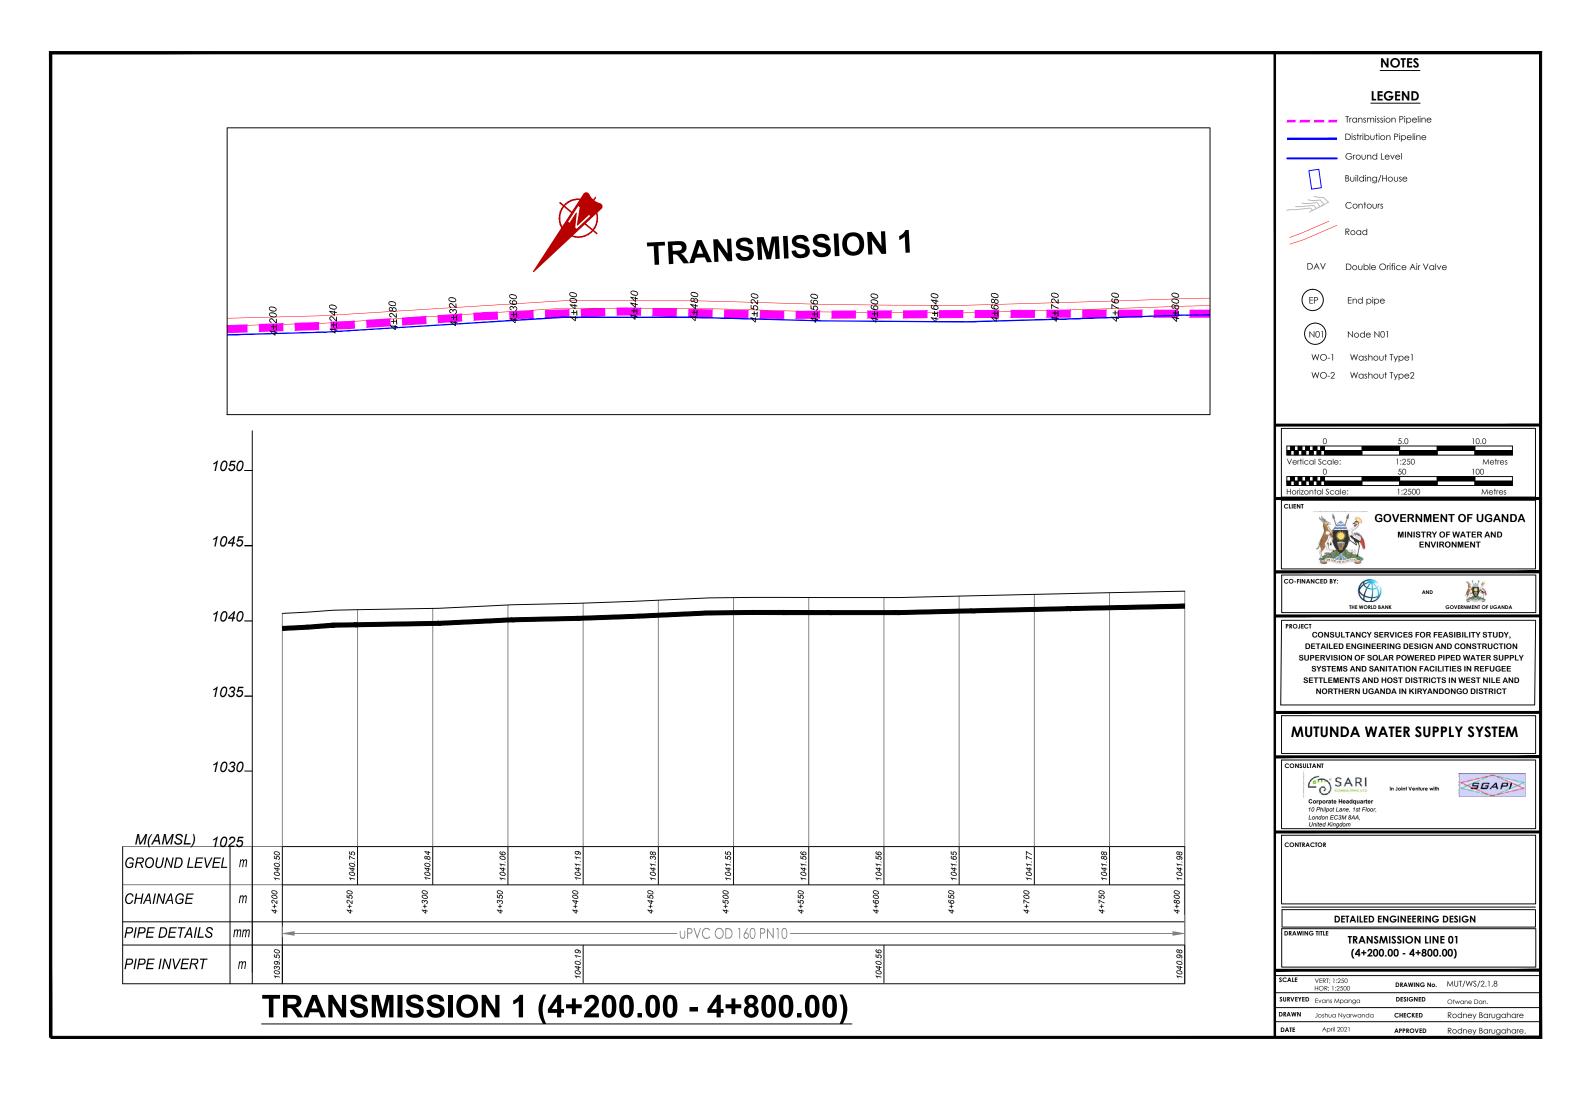

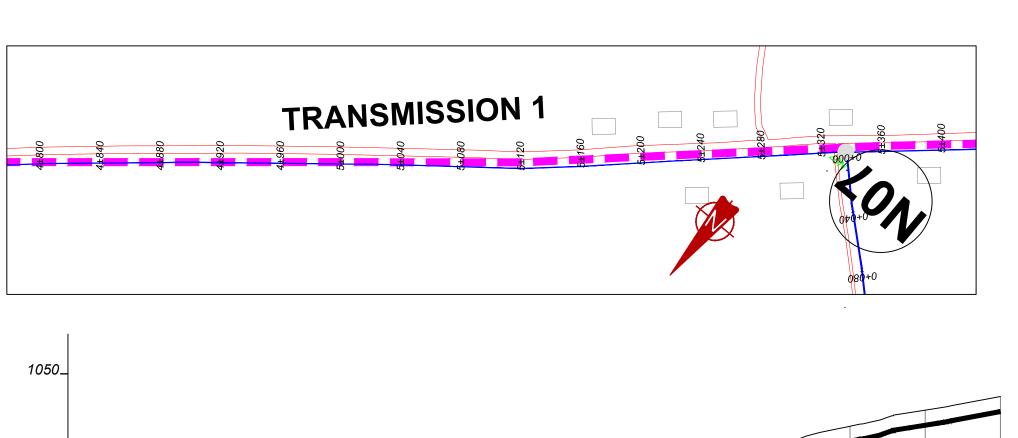

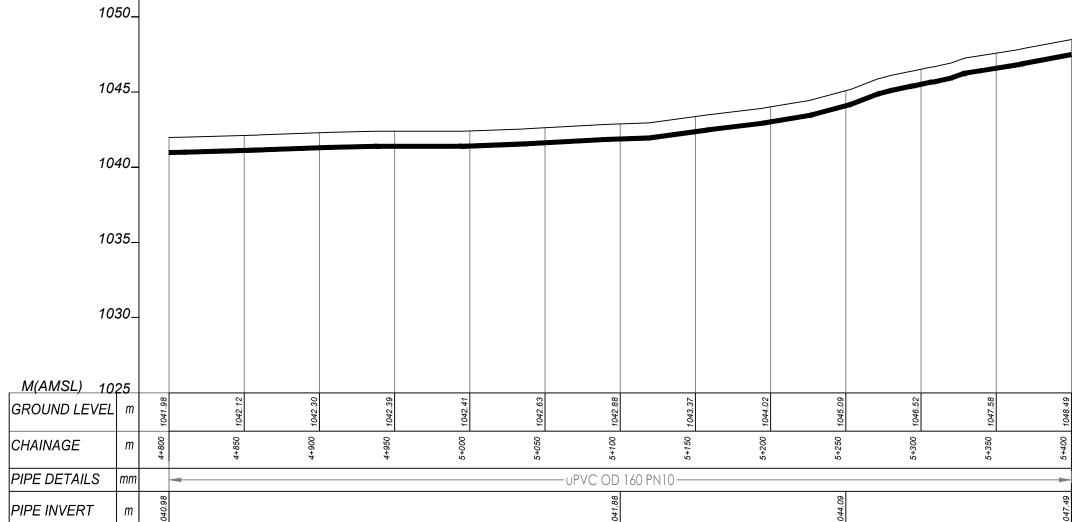

TRANSMISSION 1 (4+800.00 - 5+400.00)

NOTES LEGEND Transmission Pipeline Distribution Pipeline Ground Level Building/House Contours Road DAV Double Orifice Air Valve End pipe Node N01 WO-1 Washout Type 1 WO-2 Washout Type2 **GOVERNMENT OF UGANDA** MINISTRY OF WATER AND CONSULTANCY SERVICES FOR FEASIBILITY STUDY, DETAILED ENGINEERING DESIGN AND CONSTRUCTION SUPERVISION OF SOLAR POWERED PIPED WATER SUPPLY SYSTEMS AND SANITATION FACILITIES IN REFUGEE SETTLEMENTS AND HOST DISTRICTS IN WEST NILE AND NORTHERN UGANDA IN KIRYANDONGO DISTRICT

MUTUNDA WATER SUPPLY SYSTEM

Corporate Headquarter
10 Philipot Lane, 1st Floor,
London EC3M 8AA,
United Kingdom


In Joint Venture with




DETAILED ENGINEERING DESIGN

TRANSMISSION LINE 01 (4+800.00 - 5+400.00)

SCALE	VERT; 1:250 HOR; 1:2500	DRAWING No.	MUT/WS/2.1.9
SURVEYED	Evans Mpanga	DESIGNED	Otwane Dan.
DRAWN	Joshua Nyarwanda	CHECKED	Rodney Barugahare
DATE	April 2021	APPROVED	Rodney Barugahare.

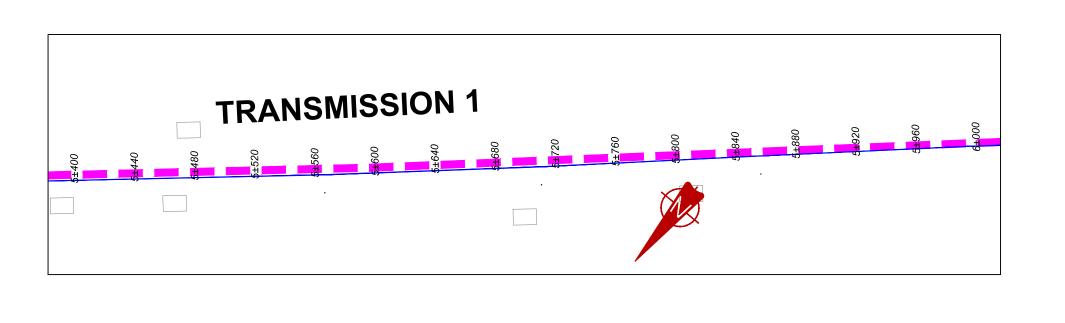

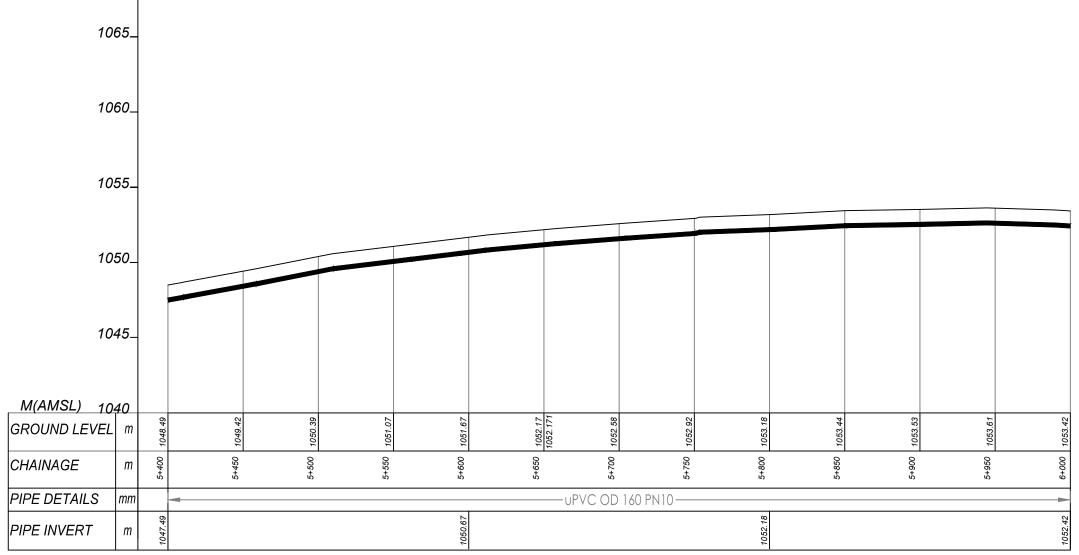

TRANSMISSION 1 (5+400.00 - 6+000.00)

NOTES

LEGEND

Transmission Pipeline
Distribution Pipeline
Ground Level



Building/House



Contours



DAV Double Orifice Air Valve



End pipe


Road



Node N01

WO-1 Washout Type 1

WO-2 Washout Type2

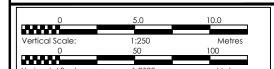



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CONSULTANCY SERVICES FOR FEASIBILITY STUDY,
DETAILED ENGINEERING DESIGN AND CONSTRUCTION
SUPERVISION OF SOLAR POWERED PIPED WATER SUPPLY
SYSTEMS AND SANITATION FACILITIES IN REFUGEE
SETTLEMENTS AND HOST DISTRICTS IN WEST NILE AND
NORTHERN UGANDA IN KIRYANDONGO DISTRICT

MUTUNDA WATER SUPPLY SYSTEM

CONSULTANT

Corporate Headquarter

10 Philpot Lane, 1st Floor,
London EC3M 8AA,
United Kingdom

In Joint Venture with





CONTRACTO

DETAILED ENGINEERING DESIGN

TRANSMISSION LINE 01 (5+400.00 - 6+000.00)

SCALE	VERT; 1:250 HOR: 1:2500	DRAWING No.	MUT/WS/2.1.10
SURVEYED	Evans Mpanga	DESIGNED	Otwane Dan.
DRAWN	Joshua Nyarwanda	CHECKED	Rodney Barugahare
DATE	April 2021	APPROVED	Rodney Barugahare.

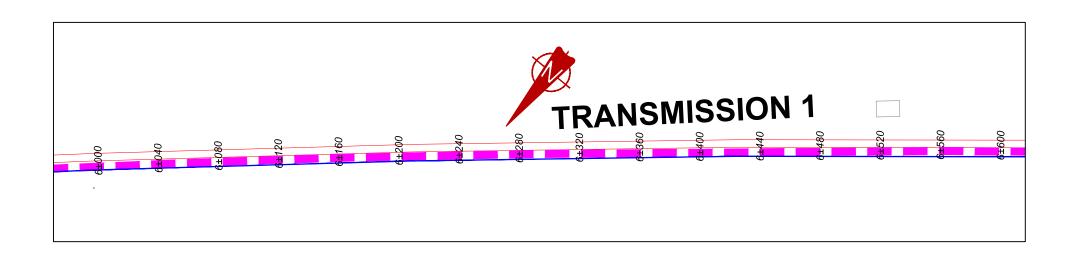

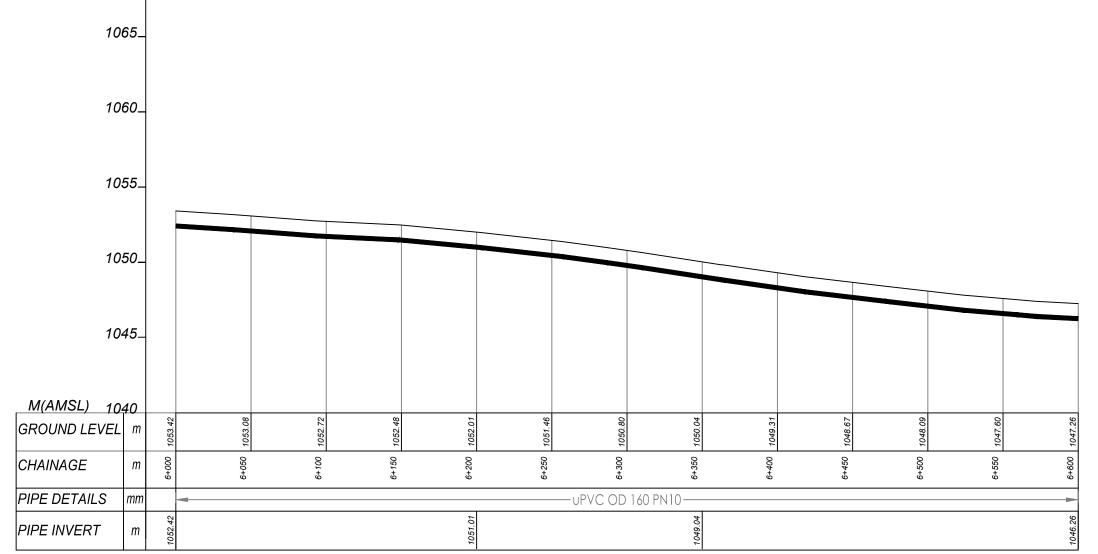

TRANSMISSION 1 (6+000.00 - 6+600.00)

NOTES LEGEND Transmission Pipeline Distribution Pipeline Ground Level Building/House Contours Road


DAV Double Orifice Air Valve

(EP) End pipe

Node N01

WO-2 Washout Type2

WO-1 Washout Type 1

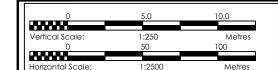

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CONSULTANCY SERVICES FOR FEASIBILITY STUDY,
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SYSTEMS AND SANITATION FACILITIES IN REFUGEE
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MUTUNDA WATER SUPPLY SYSTEM

Corporate Headquarter
10 Philipot Lane, 1st Floor,
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United Kingdom

In Joint Venture with





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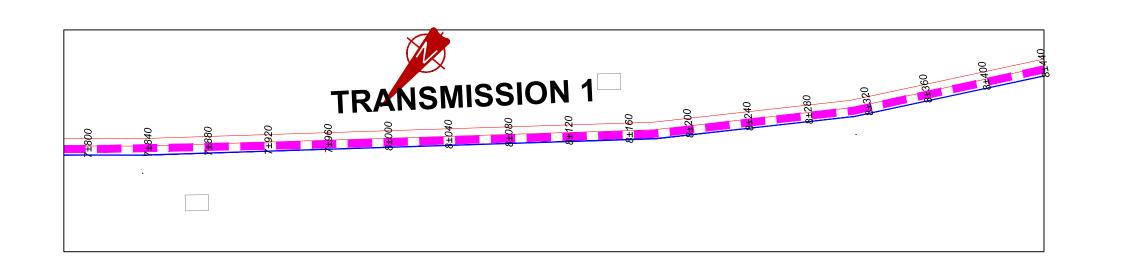
DETAILED ENGINEERING DESIGN


TRANSMISSION LINE 01 (6+000.00 - 6+600.00)

SCALE	VERT; 1:250 HOR; 1:2500	DRAWING No.	MUT/WS/2.1.11
SURVEYED	Evans Mpanga	DESIGNED	Otwane Dan.
DRAWN	Joshua Nyarwanda	CHECKED	Rodney Barugahare
DATE	April 2021	APPROVED	Rodney Barugahare.



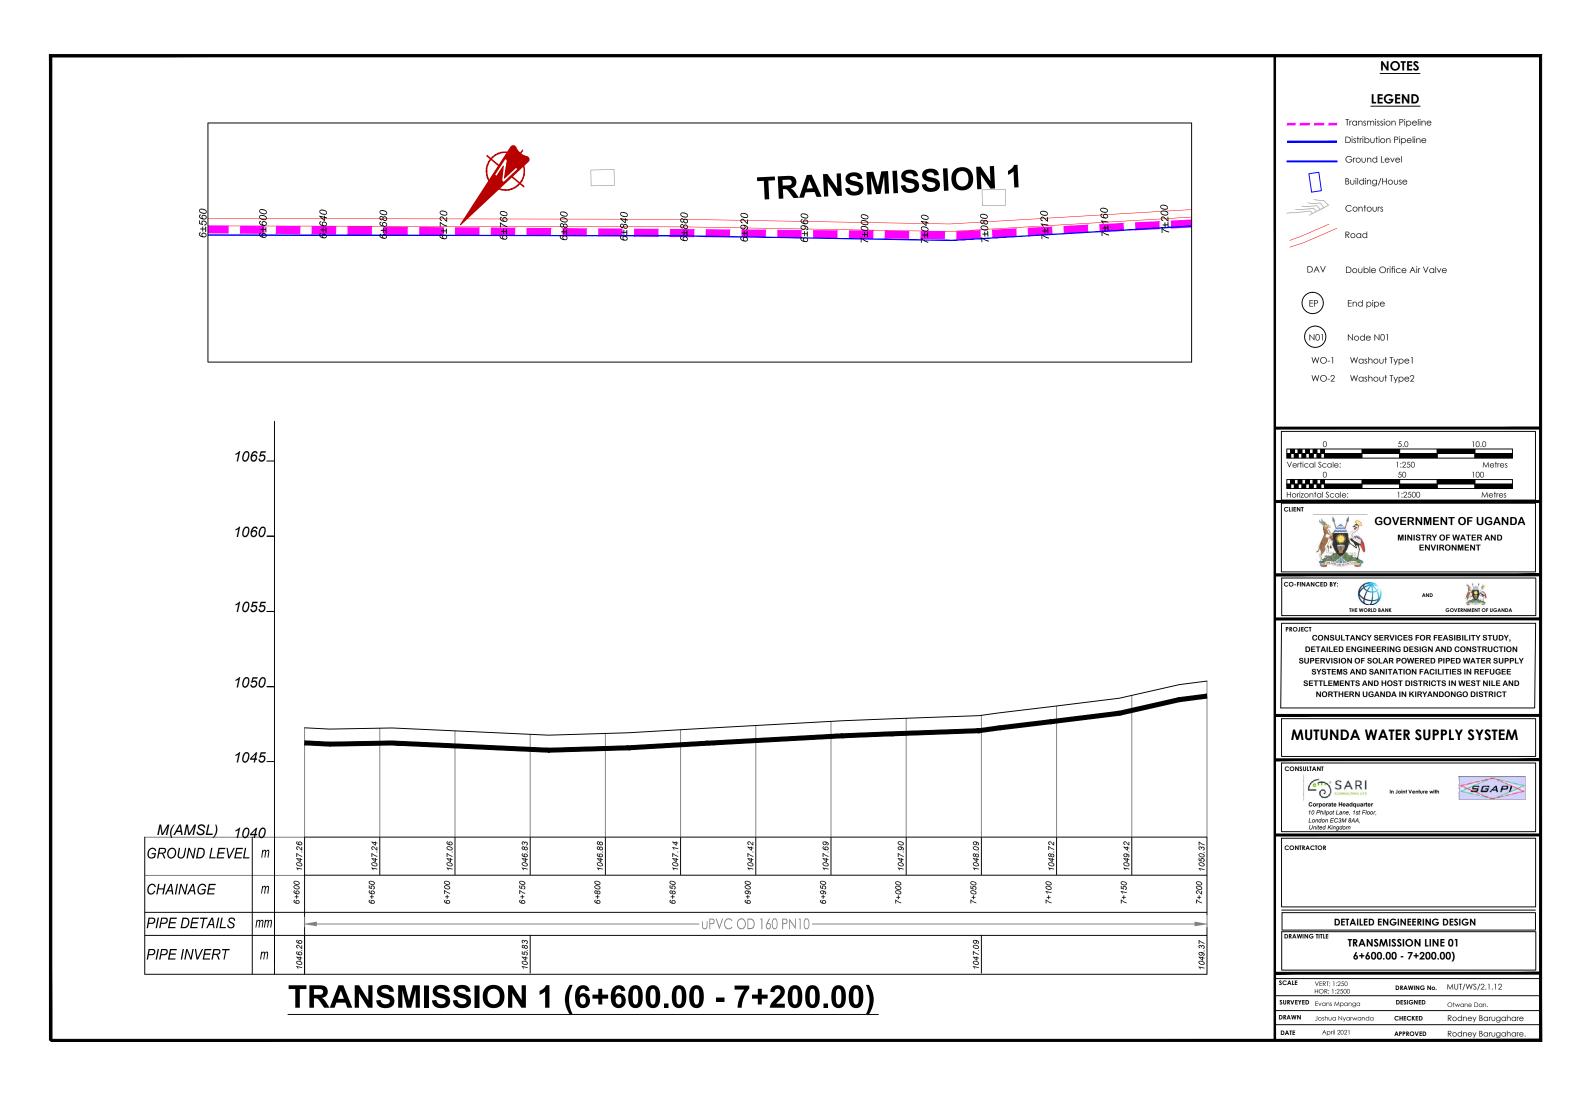


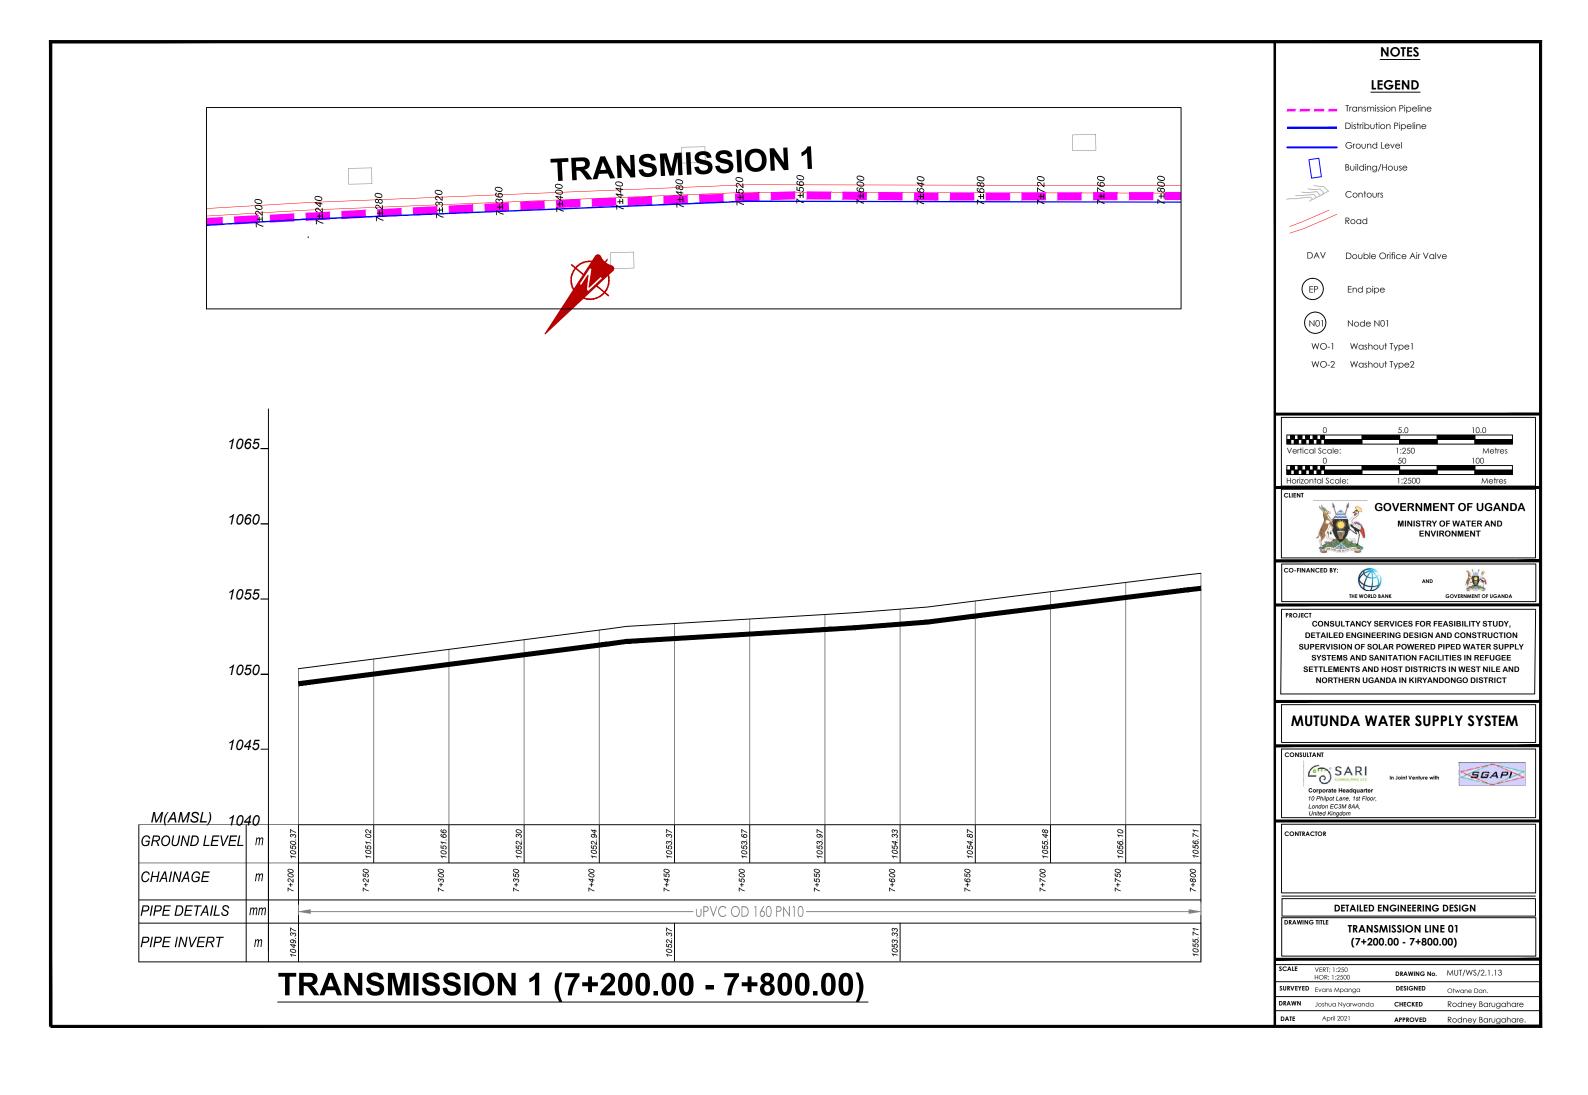

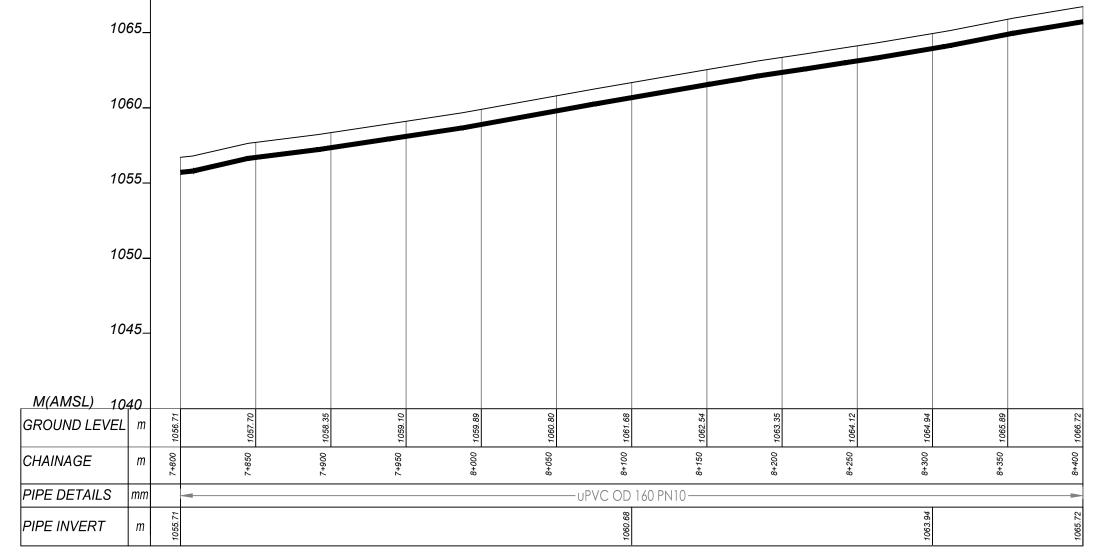

TRANSMISSION 1 (7+800.00 - 8+400.00)

LEGEND Transmission Pipeline Distribution Pipeline Ground Level Building/House Contours Road DAV Double Orifice Air Valve EP End pipe NOI Node NOI WO-1 Washout Type 1 WO-2 Washout Type 2

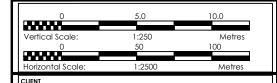

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CONSULTANCY SERVICES FOR FEASIBILITY STUDY,

DETAILED ENGINEERING DESIGN AND CONSTRUCTION

SUPERVISION OF SOLAR POWERED PIPED WATER SUPPLY

SYSTEMS AND SANITATION FACILITIES IN REFUGEE

SETTLEMENTS AND HOST DISTRICTS IN WEST NILE AND

NORTHERN UGANDA IN KIRYANDONGO DISTRICT

MUTUNDA WATER SUPPLY SYSTEM

Corporate Headquarter
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United Kingdom

In Joint Venture with





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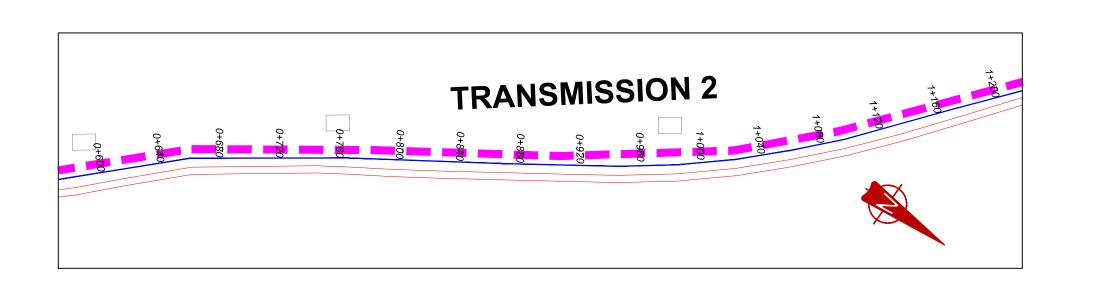
DETAILED ENGINEERING DESIGN


TRANSMISSION LINE 01 (7+800.00 - 8+400.00)

SCALE	VERT; 1:250 HOR; 1:2500	DRAWING No.	MUT/WS/2.1.14
SURVEYED	Evans Mpanga	DESIGNED	Otwane Dan.
DRAWN	Joshua Nyarwanda	CHECKED	Rodney Barugahare
DATE	April 2021	APPROVED	Rodney Barugahare.



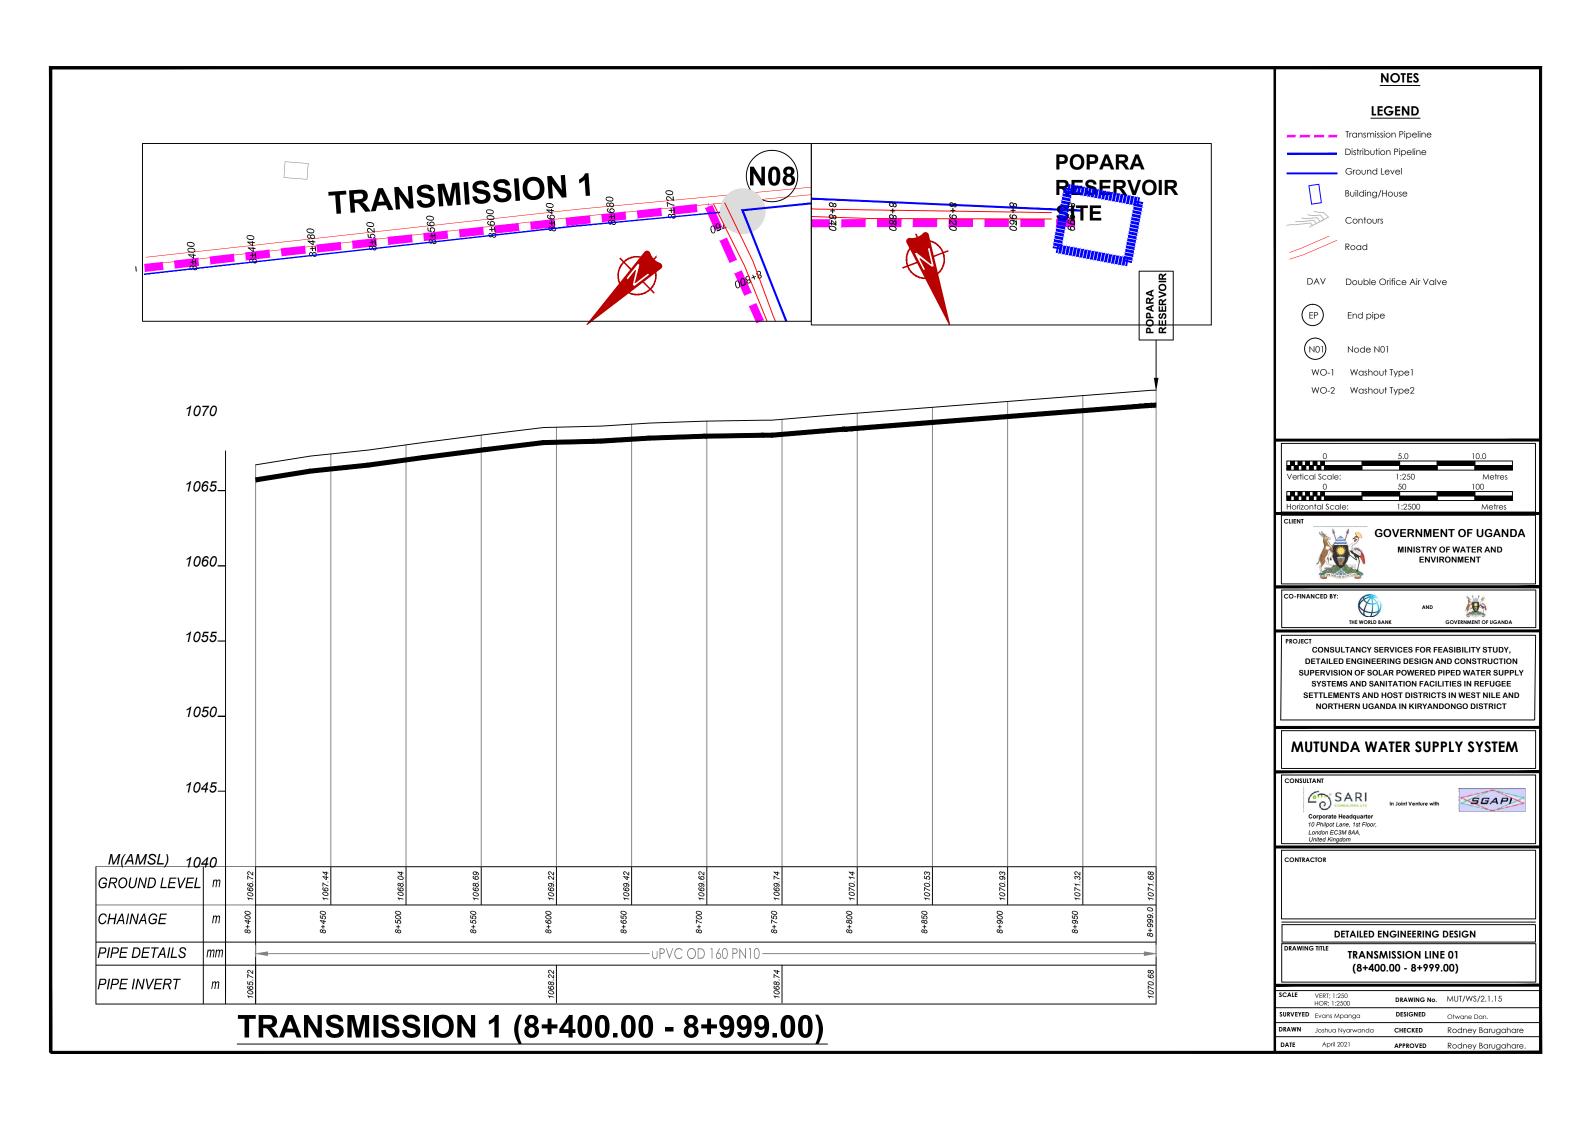

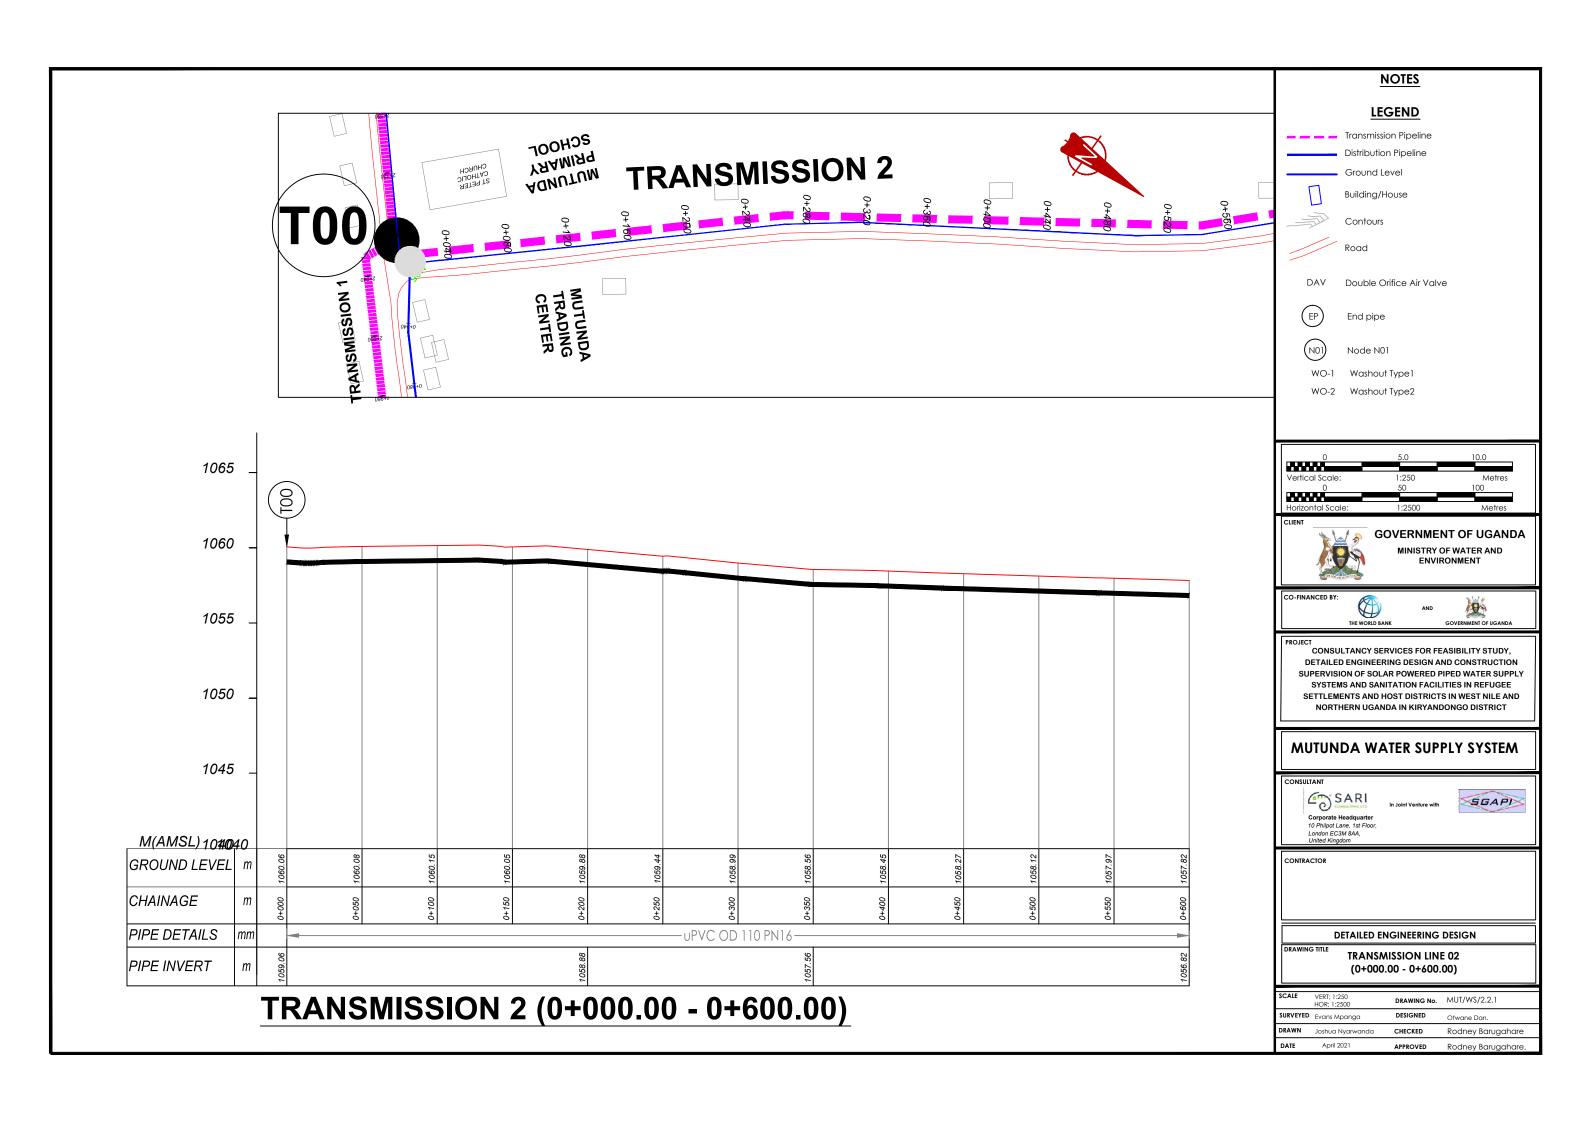

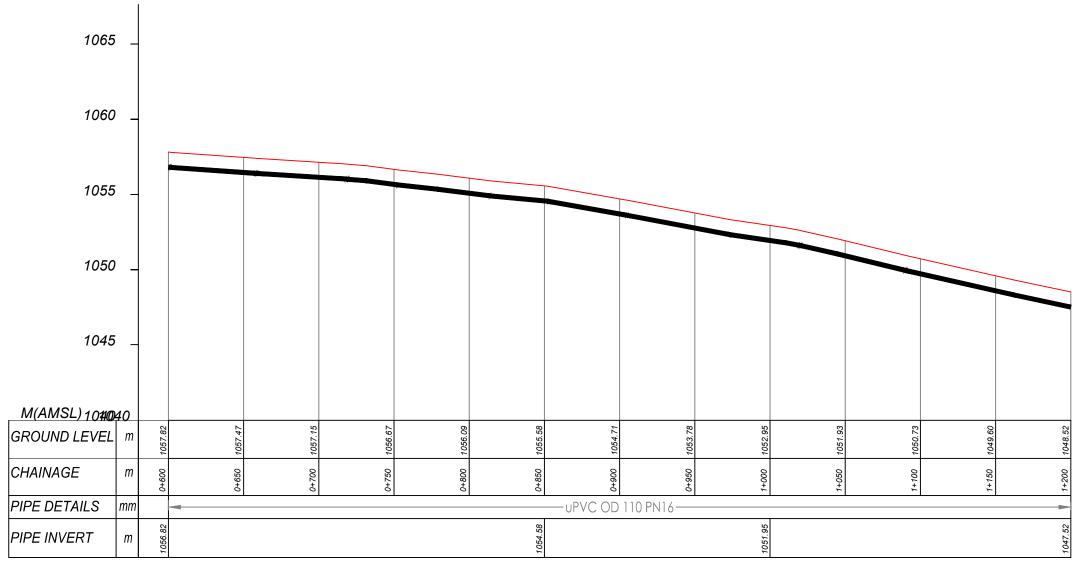



TRANSMISSION 2 (0+600.00 - 1+200.00)


NOTES LEGEND Transmission Pipeline Distribution Pipeline Ground Level Building/House Contours Road DAV Double Orifice Air Valve End pipe Node N01 WO-1 Washout Type 1 WO-2 Washout Type2 **GOVERNMENT OF UGANDA** MINISTRY OF WATER AND CONSULTANCY SERVICES FOR FEASIBILITY STUDY, DETAILED ENGINEERING DESIGN AND CONSTRUCTION SUPERVISION OF SOLAR POWERED PIPED WATER SUPPLY SYSTEMS AND SANITATION FACILITIES IN REFUGEE SETTLEMENTS AND HOST DISTRICTS IN WEST NILE AND NORTHERN UGANDA IN KIRYANDONGO DISTRICT **MUTUNDA WATER SUPPLY SYSTEM** SARI SGAPI Corporate Headquarter 10 Philpot Lane, 1st Floor, London EC3M 8AA, United Kingdom DETAILED ENGINEERING DESIGN **TRANSMISSION LINE 02** (0+600.00 - 1+200.00)


CHECKED

Rodney Barugahare

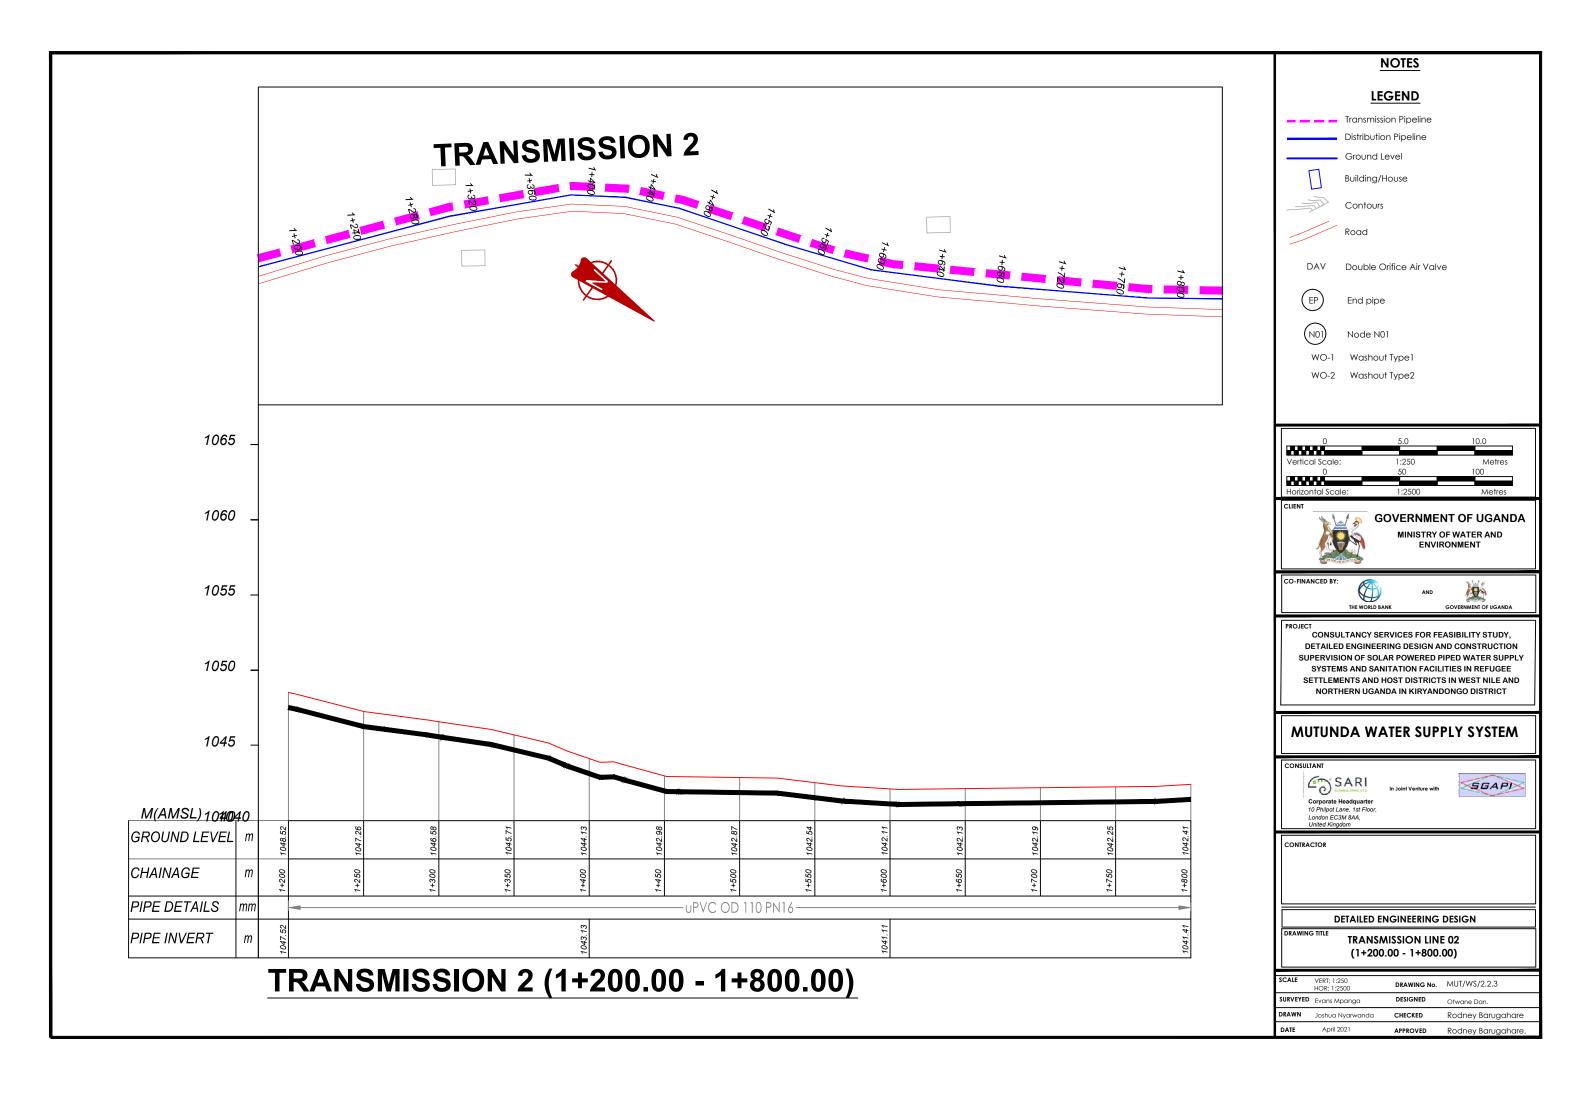

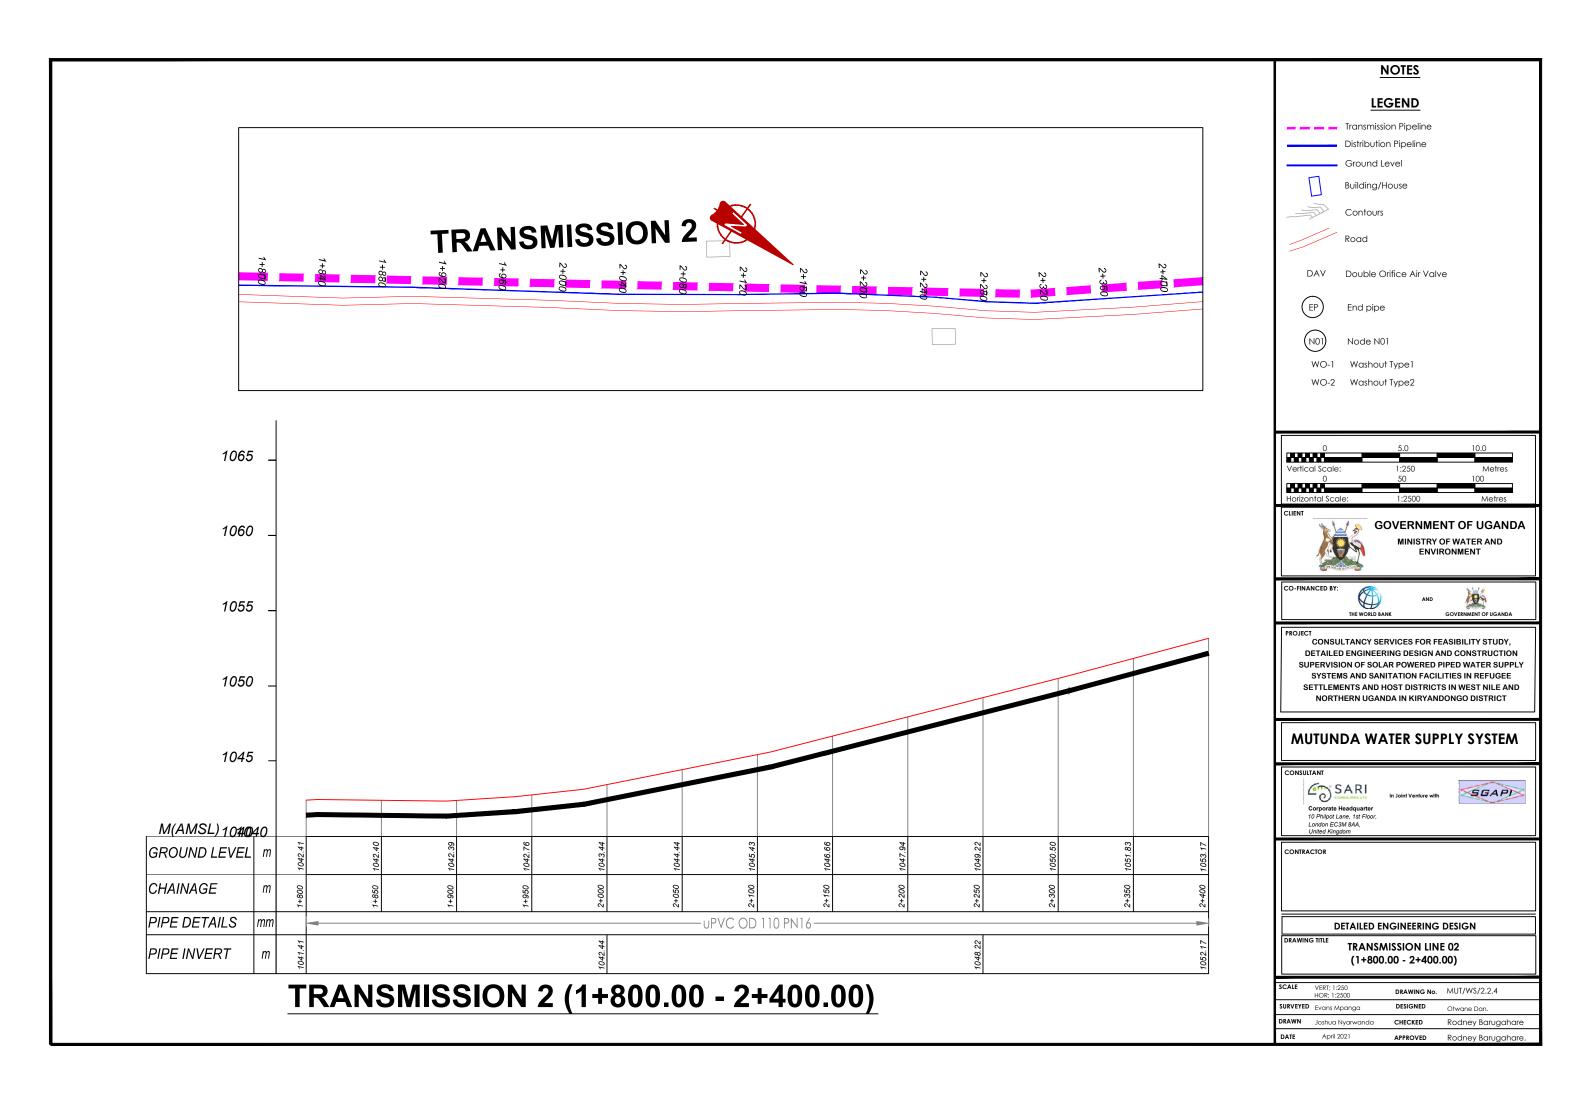

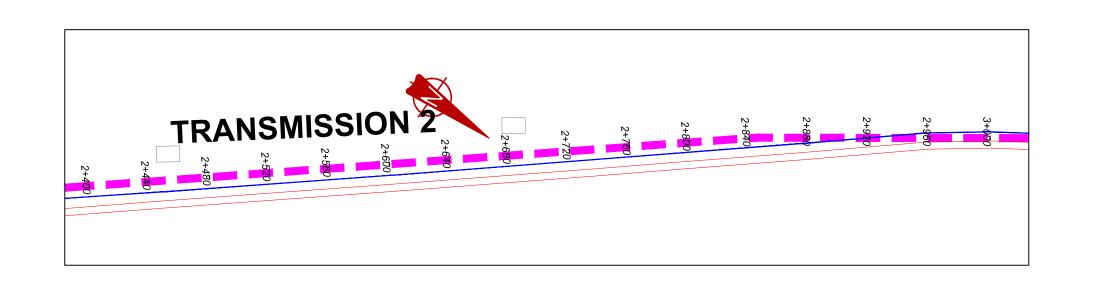

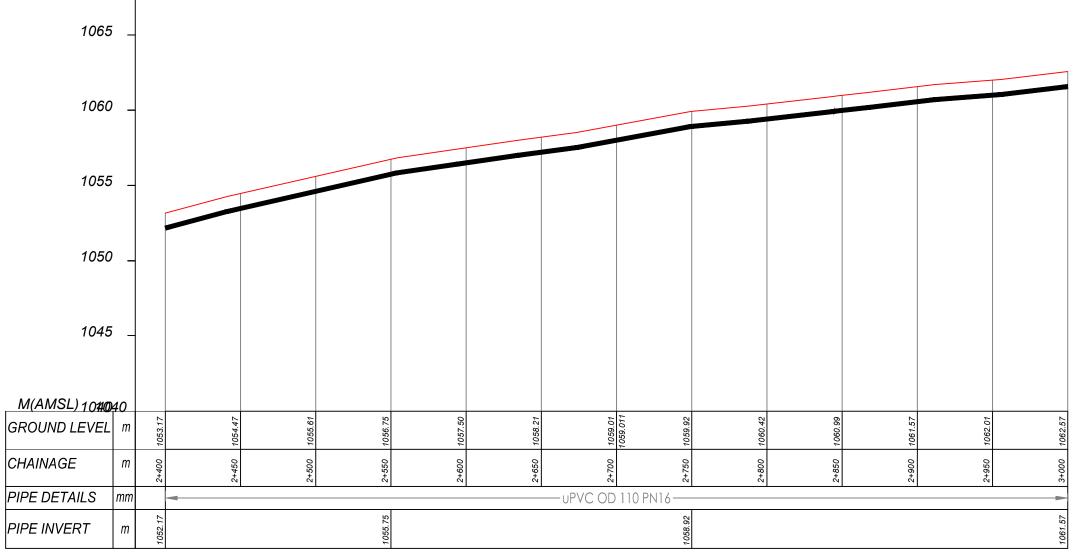

TRANSMISSION 2 (2+400.00 - 3+000.00)

NOTES

LEGEND

Transmission Pipeline
Distribution Pipeline



Ground LevelBuilding/House



Contours

Road



DAV Double Orifice Air Valve




End pipe



Node N01

WO-1 Washout Type1
WO-2 Washout Type2

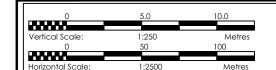



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CONSULTANCY SERVICES FOR FEASIBILITY STUDY,
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SYSTEMS AND SANITATION FACILITIES IN REFUGEE
SETTLEMENTS AND HOST DISTRICTS IN WEST NILE AND
NORTHERN UGANDA IN KIRYANDONGO DISTRICT

MUTUNDA WATER SUPPLY SYSTEM

Corporate Headquarter
10 Philipot Lane, 1st Floor,
London EC3M 8AA,
United Kingdom

n Joint Venture with





CONTRACTO

DETAILED ENGINEERING DESIGN


TRANSMISSION LINE 02 (2+400.00 - 3+000.00)

SCALE	VERT; 1:250 HOR; 1:2500	DRAWING No.	MUT/WS/2.2.5
SURVEYED	Evans Mpanga	DESIGNED	Otwane Dan.
DRAWN	Joshua Nyarwanda	CHECKED	Rodney Barugahare
DATE	April 2021	APPROVED	Rodney Barugahare.

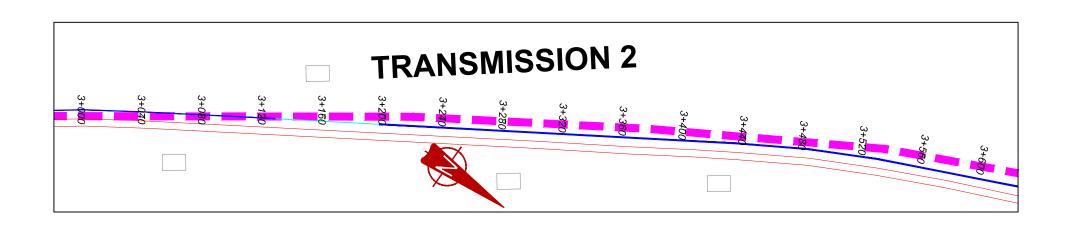

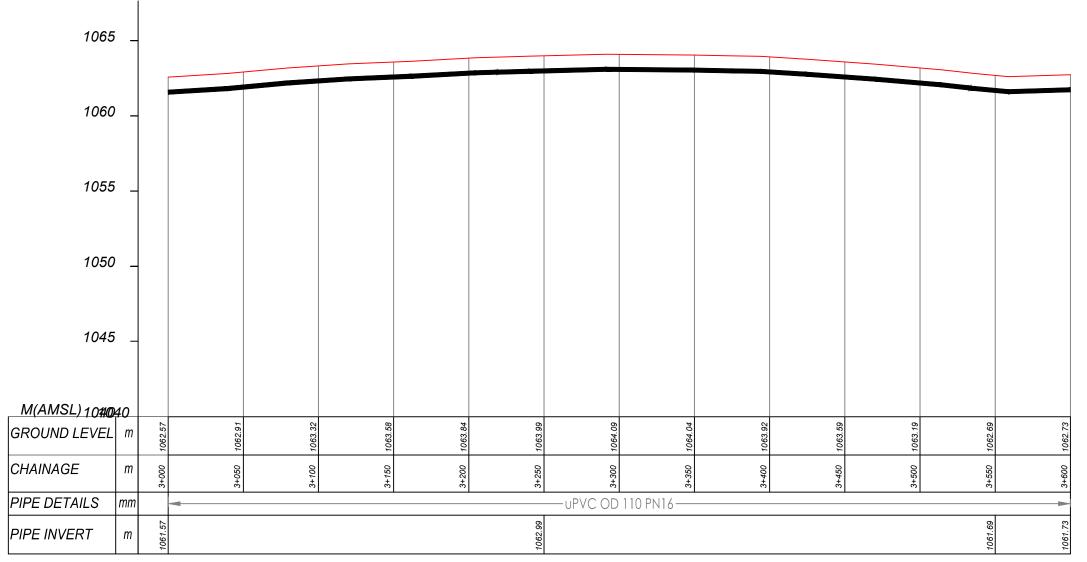

TRANSMISSION 2 (3+000.00 - 3+600.00)

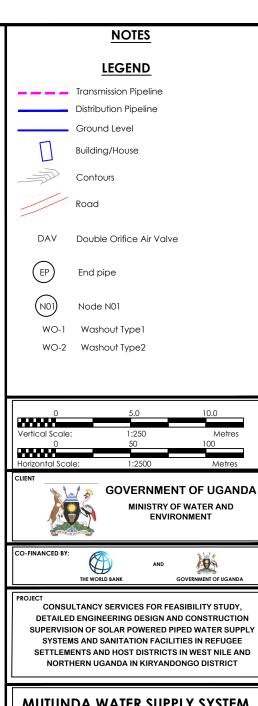

MUTUNDA WATER SUPPLY SYSTEM


SARI Corporate Headquarter 10 Philpot Lane, 1st Floor, London EC3M 8AA, United Kingdom




DETAILED ENGINEERING DESIGN

TRANSMISSION LINE 02 (3+000.00 - 3+600.00)

SCALE	VERT; 1:250 HOR; 1:2500	DRAWING No.	MUT/WS/2.2.6
SURVEYED	Evans Mpanga	DESIGNED	Otwane Dan.
DRAWN	Joshua Nyarwanda	CHECKED	Rodney Barugahare
DATE	April 2021	APPROVED	Rodney Barugahare.

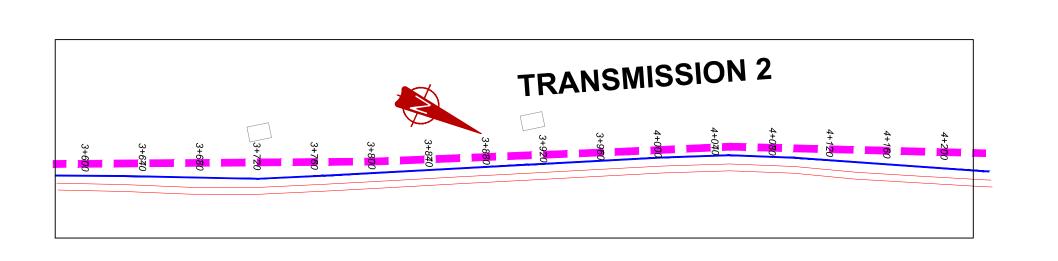

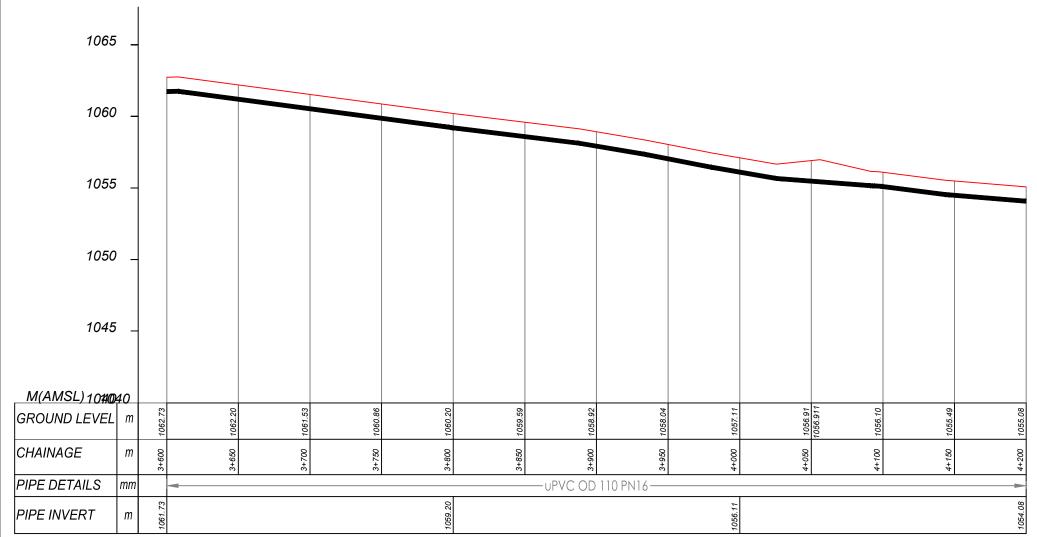

TRANSMISSION 2 (3+600.00 - 4+200.00)

<u>NOTES</u>

LEGEND

Transmission Pipeline
Distribution Pipeline
Ground Level



Building/House



Contours Road



DAV Double Orifice Air Valve



End pipe



Node N01

WO-2 Washout Type2

WO-1 Washout Type 1

0 5.0 10.0

Vertical Scale: 1:250 Metres 0 50 100



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SUPERVISION OF SOLAR POWERED PIPED WATER SUPPLY
SYSTEMS AND SANITATION FACILITIES IN REFUGEE
SETTLEMENTS AND HOST DISTRICTS IN WEST NILE AND
NORTHERN UGANDA IN KIRYANDONGO DISTRICT

MUTUNDA WATER SUPPLY SYSTEM

Corporate Headquarter
10 Philipot Lane, 1st Floor,
London EC3M 8AA,
United Kingdom

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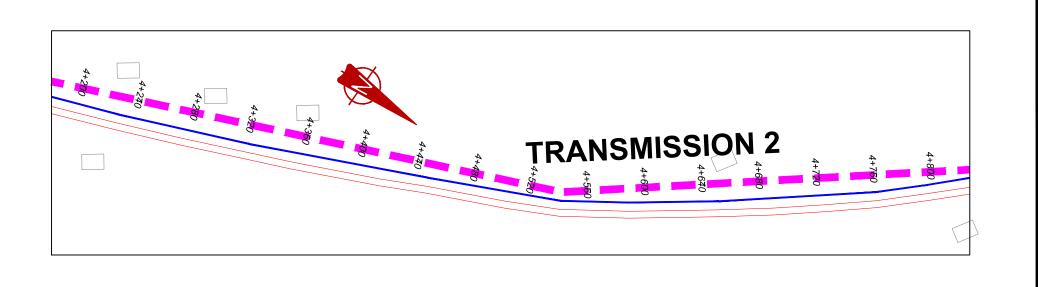
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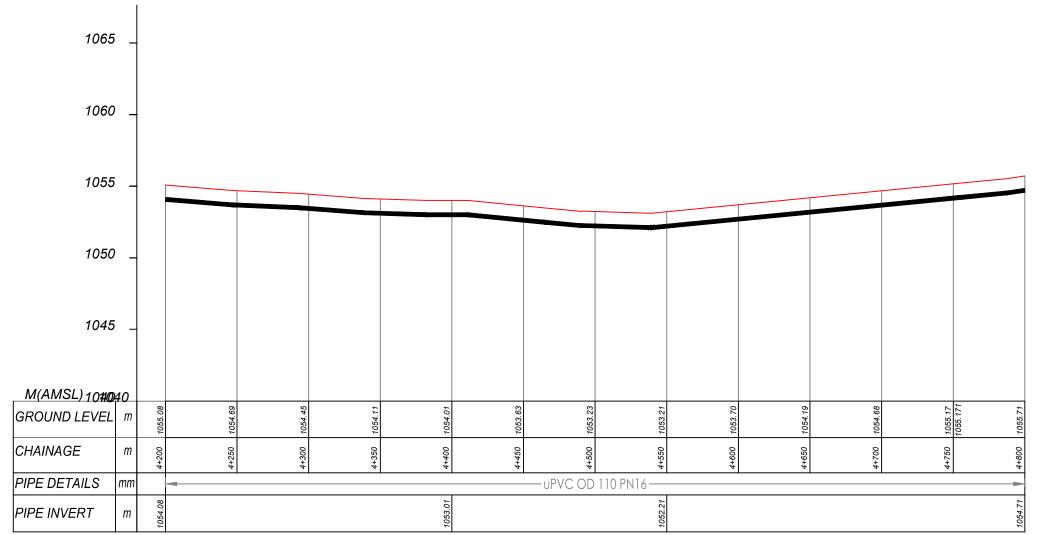
DETAILED ENGINEERING DESIGN

DRAWING TITL

TRANSMISSION LINE 02 (3+600.00 - 4+200.00)


SCALE	VERT; 1:250 HOR; 1:2500	DRAWING No.	MUT/WS/2.2.7
SURVEYED	Evans Mpanga	DESIGNED	Otwane Dan.
DRAWN	Joshua Nyarwanda	CHECKED	Rodney Barugahare
DATE	April 2021	APPROVED	Rodney Barugahare.





TRANSMISSION 2 (4+200.00 - 4+800.00)

LEGEND Transmission Pipeline Distribution Pipeline Ground Level Building/House Contours Road DAV Double Orifice Air Valve EP End pipe NO1 Node N01 WO-1 Washout Type1 WO-2 Washout Type2

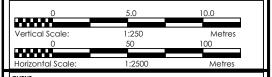

G

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CONSULTANCY SERVICES FOR FEASIBILITY STUDY,
DETAILED ENGINEERING DESIGN AND CONSTRUCTION
SUPERVISION OF SOLAR POWERED PIPED WATER SUPPLY
SYSTEMS AND SANITATION FACILITIES IN REFUGEE
SETTLEMENTS AND HOST DISTRICTS IN WEST NILE AND
NORTHERN UGANDA IN KIRYANDONGO DISTRICT

MUTUNDA WATER SUPPLY SYSTEM

Corporate Headquarter
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London EC3M 8AA,
United Kingdom

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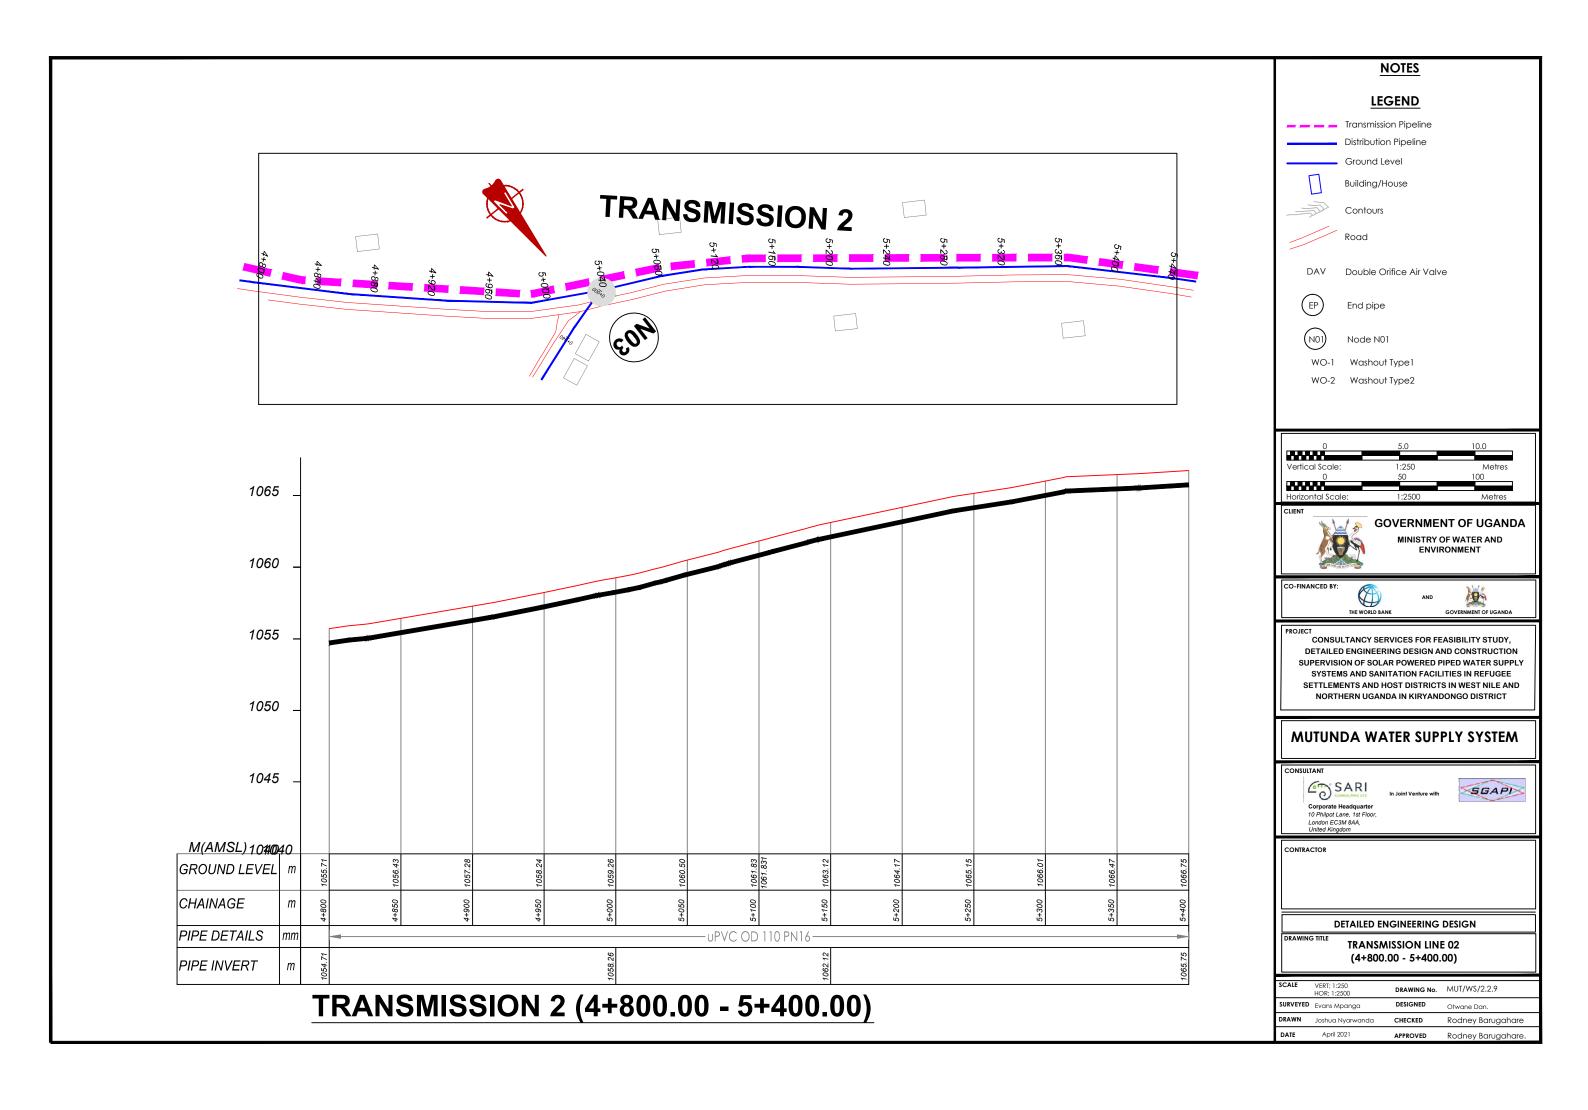



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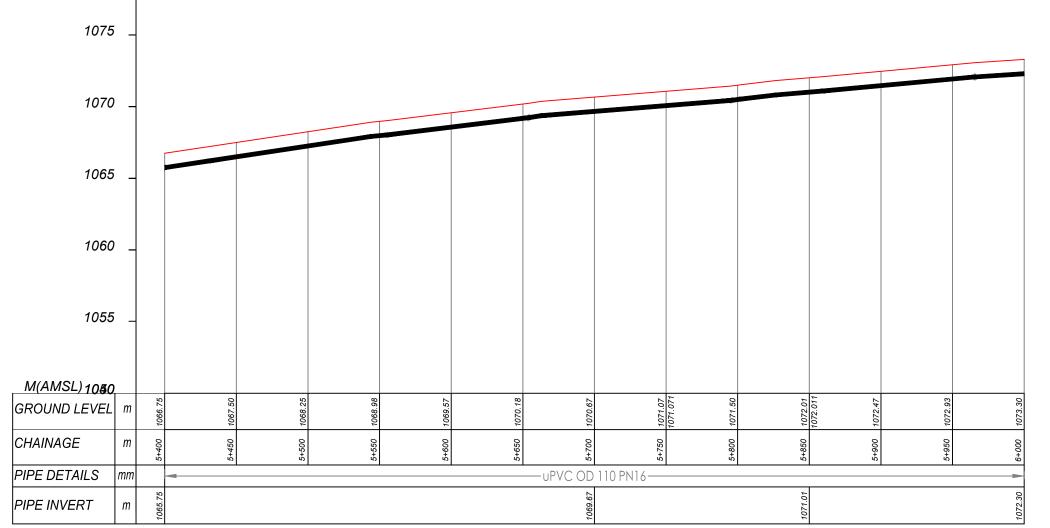
DETAILED ENGINEERING DESIGN

TRANSMISSION LINE 02 (4+200.00 - 4+800.00)

_			
SCALE	VERT; 1:250 HOR; 1:2500	DRAWING No.	MUT/WS/2.2.8
SURVEYED	Evans Mpanga	DESIGNED	Otwane Dan.
DRAWN	Joshua Nyarwanda	CHECKED	Rodney Barugahare
DATE	April 2021	APPROVED	Rodney Barugahare.






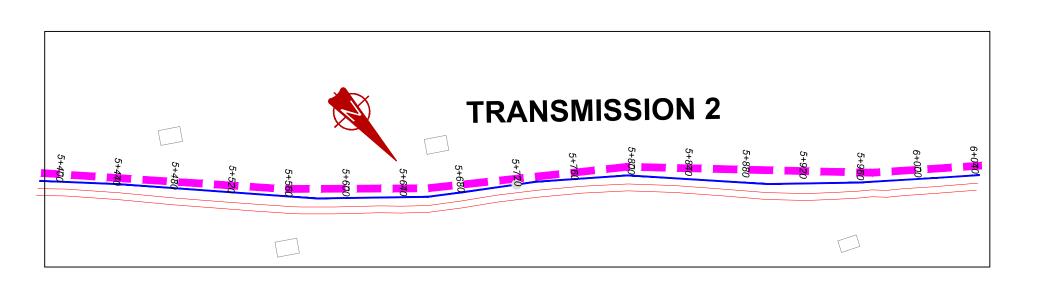

TRANSMISSION 2 (5+400.00 - 6+000.00)

LEGEND Transmission Pipeline Distribution Pipeline Ground Level Building/House Contours Road DAV Double Orifice Air Valve EP End pipe NOI) Node NOI WO-1 Washout Type 1 WO-2 Washout Type 2 Vertical Scale: 1:250 Metres 0 50 100

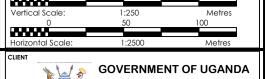

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SYSTEMS AND SANITATION FACILITIES IN REFUGEE
SETTLEMENTS AND HOST DISTRICTS IN WEST NILE AND
NORTHERN UGANDA IN KIRYANDONGO DISTRICT

MUTUNDA WATER SUPPLY SYSTEM

Corporate Headquarter
10 Philipot Lane, 1st Floor,
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United Kingdom

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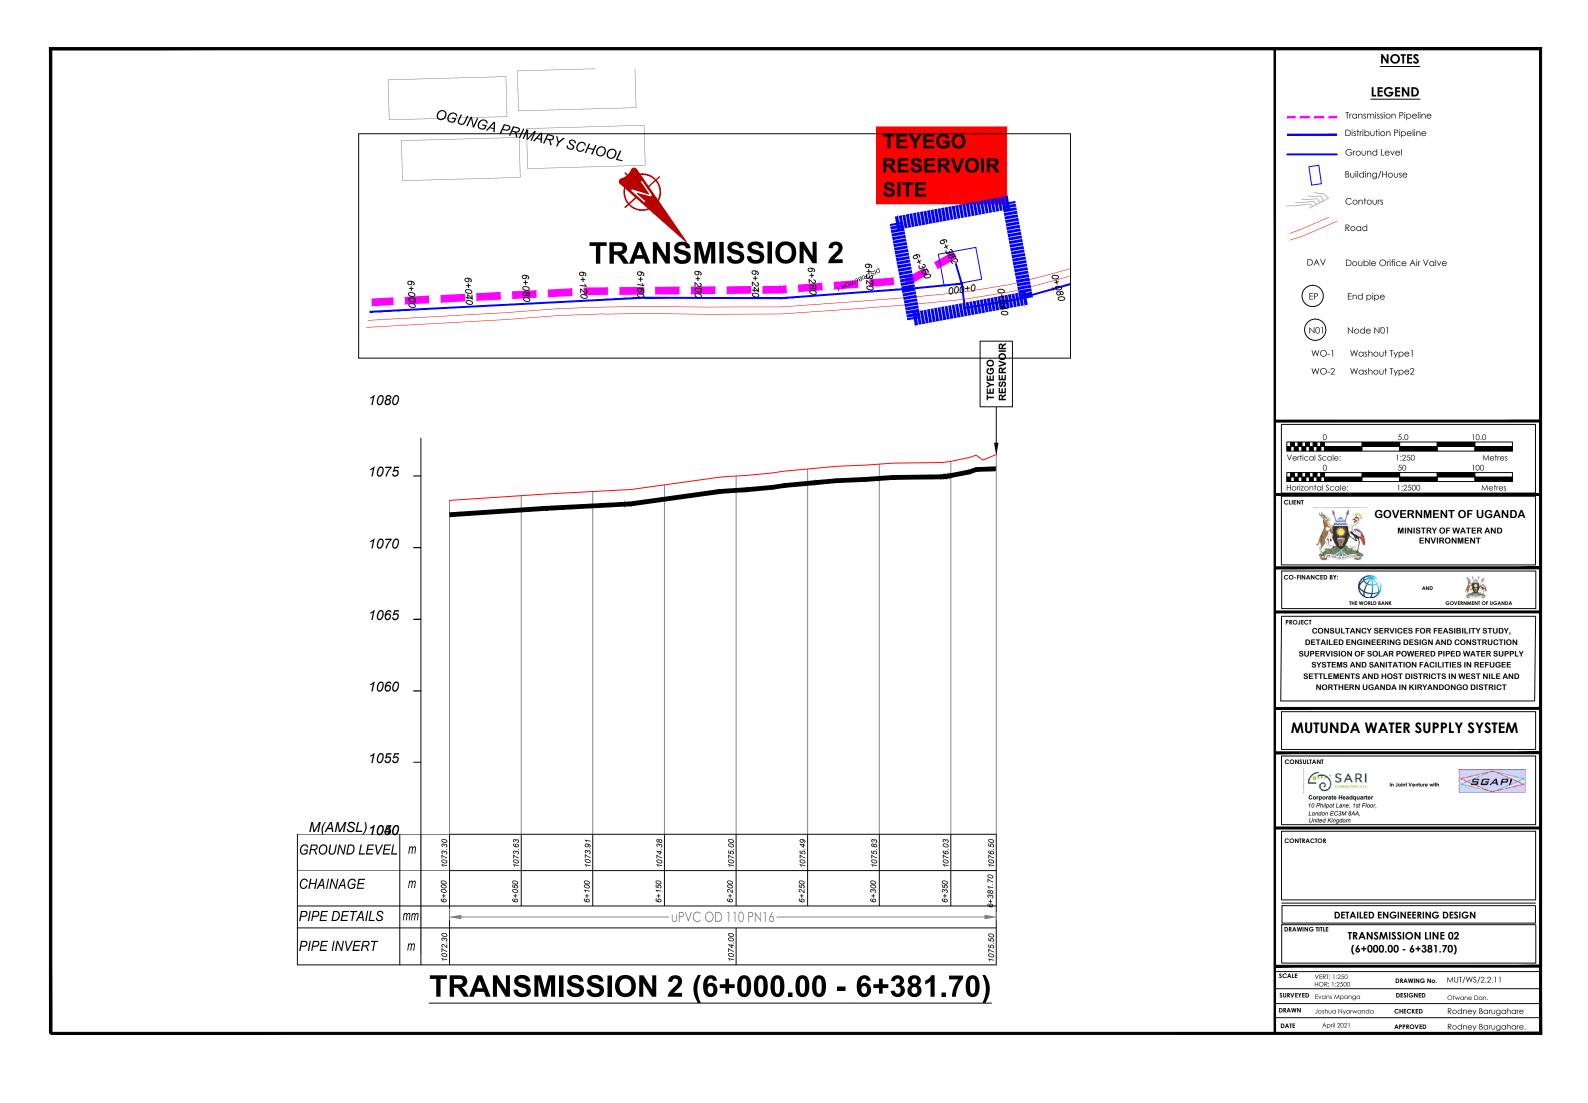



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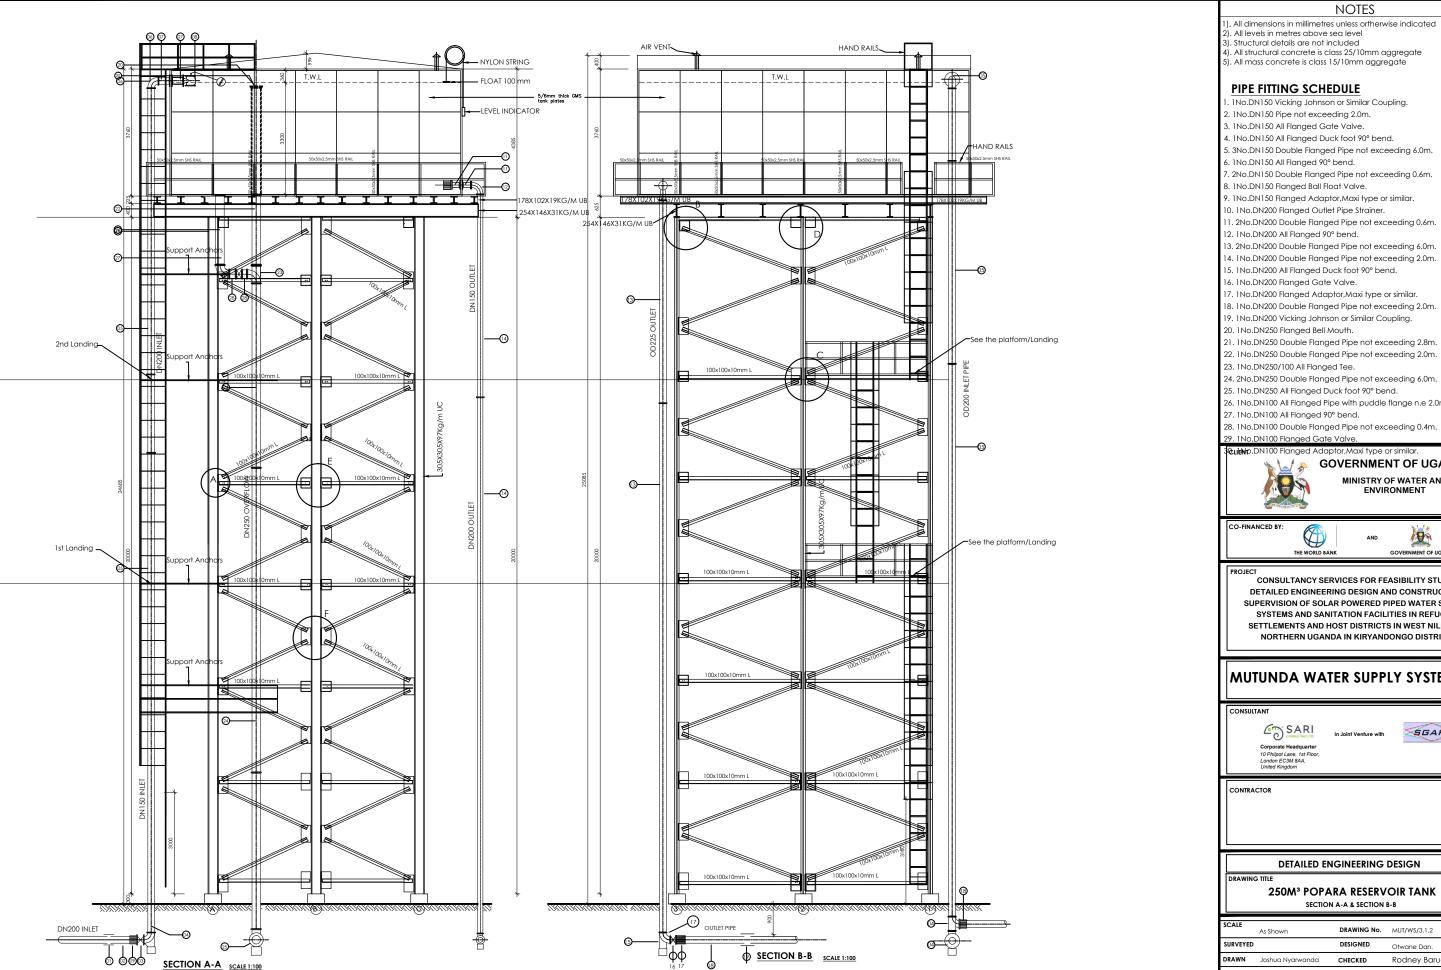
DETAILED ENGINEERING DESIGN

TRANSMISSION LINE 02 (5+400.00 - 6+000.00)

SCALE	VERT; 1:250 HOR; 1:2500	DRAWING No.	MUT/WS/2.2.10
SURVEYED	Evans Mpanga	DESIGNED	Otwane Dan.
DRAWN	Joshua Nyarwanda	CHECKED	Rodney Barugahare
DATE	April 2021	APPROVED	Rodney Barugahare.





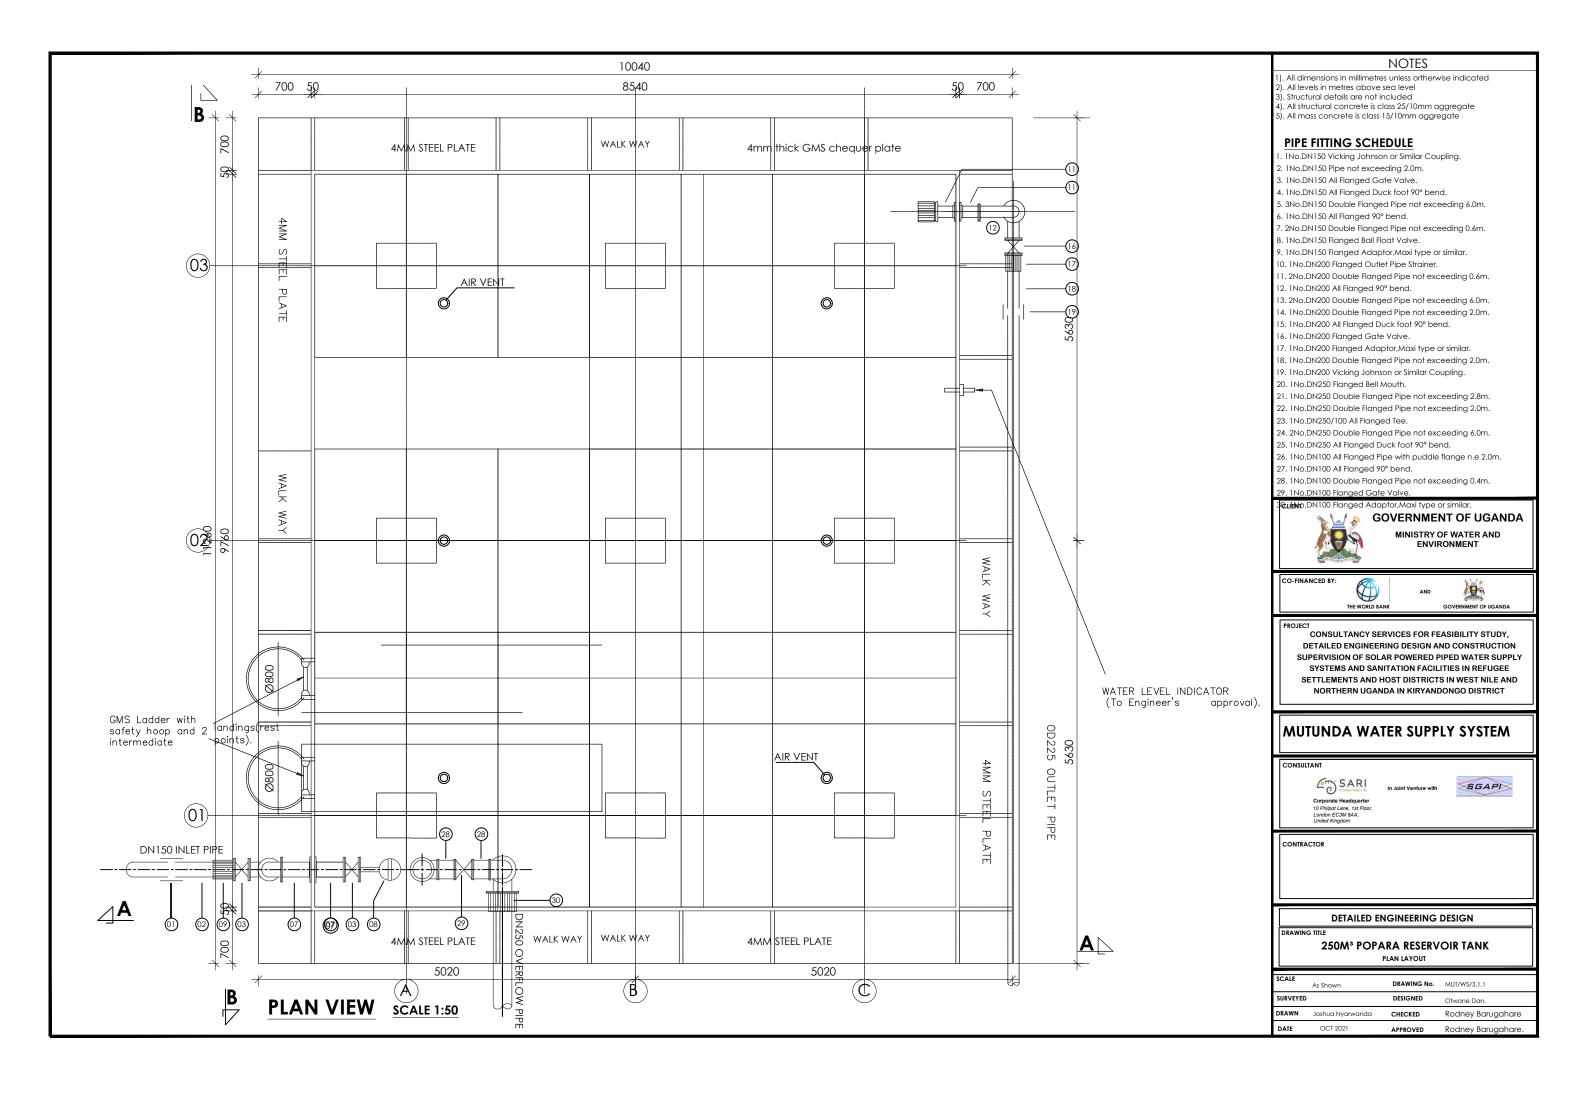

-). All dimensions in millimetres unless ortherwise indicated

- 5. 3No.DN150 Double Flanged Pipe not exceeding 6.0m.

- ${\tt 11.\,2No.DN200\,Double\,Flanged\,Pipe\,not\,exceeding\,0.6m.}$
- 13. 2No.DN200 Double Flanged Pipe not exceeding 6.0m.
- 14. 1No.DN200 Double Flanged Pipe not exceeding 2.0m.

- 18. 1No.DN200 Double Flanged Pipe not exceeding 2.0m.
- 19. 1No.DN200 Vicking Johnson or Similar Coupling.
- 21. 1No.DN250 Double Flanged Pipe not exceeding 2.8m.
- 22. 1No.DN250 Double Flanged Pipe not exceeding 2.0m.
- 24. 2No.DN250 Double Flanged Pipe not exceeding 6.0m.
- 26. 1No.DN100 All Flanged Pipe with puddle flange n.e 2.0m.

GOVERNMENT OF UGANDA

MINISTRY OF WATER AND ENVIRONMENT



CONSULTANCY SERVICES FOR FEASIBILITY STUDY, DETAILED ENGINEERING DESIGN AND CONSTRUCTION SUPERVISION OF SOLAR POWERED PIPED WATER SUPPLY SYSTEMS AND SANITATION FACILITIES IN REFUGEE SETTLEMENTS AND HOST DISTRICTS IN WEST NILE AND NORTHERN UGANDA IN KIRYANDONGO DISTRICT


MUTUNDA WATER SUPPLY SYSTEM





DETAILED ENGINEERING DESIGN

250M³ POPARA RESERVOIR TANK

SCALE	As Shown	DRAWING No.	MUT/WS/3.1.2
SURVEYED		DESIGNED	Otwane Dan.
DRAWN	Joshua Nyarwanda	CHECKED	Rodney Barugahare
DATE	OCT 2021	APPROVED	Rodney Barugahare.

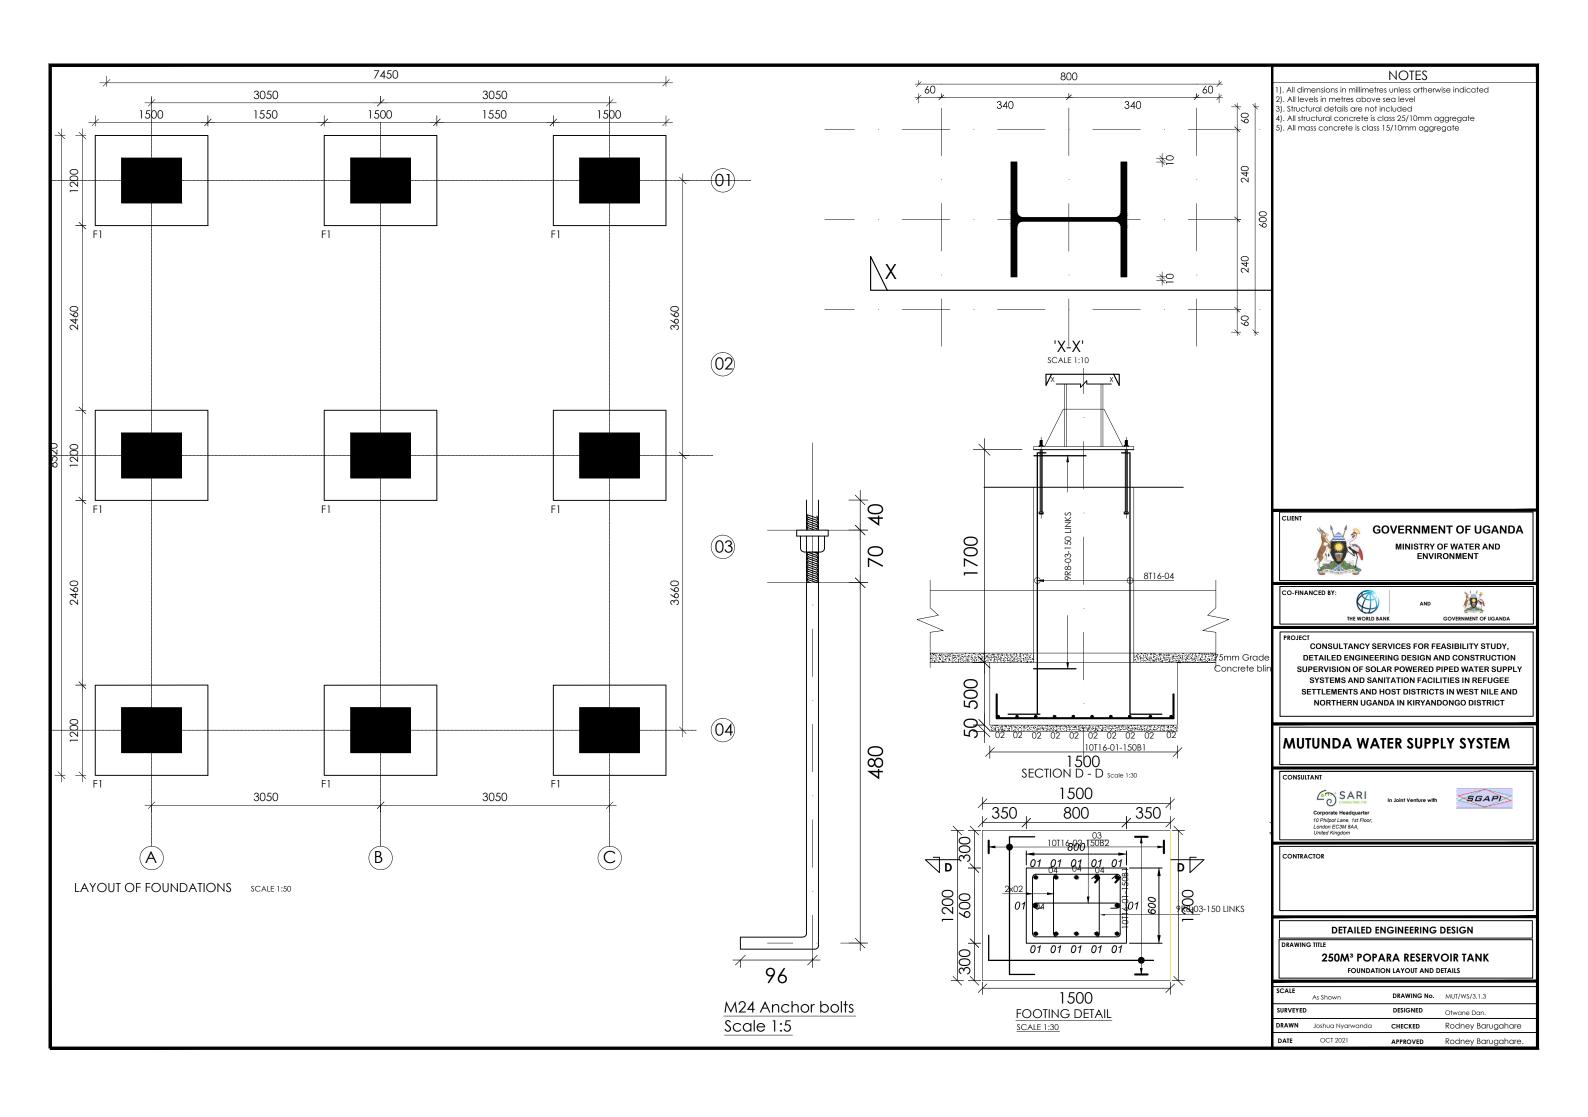

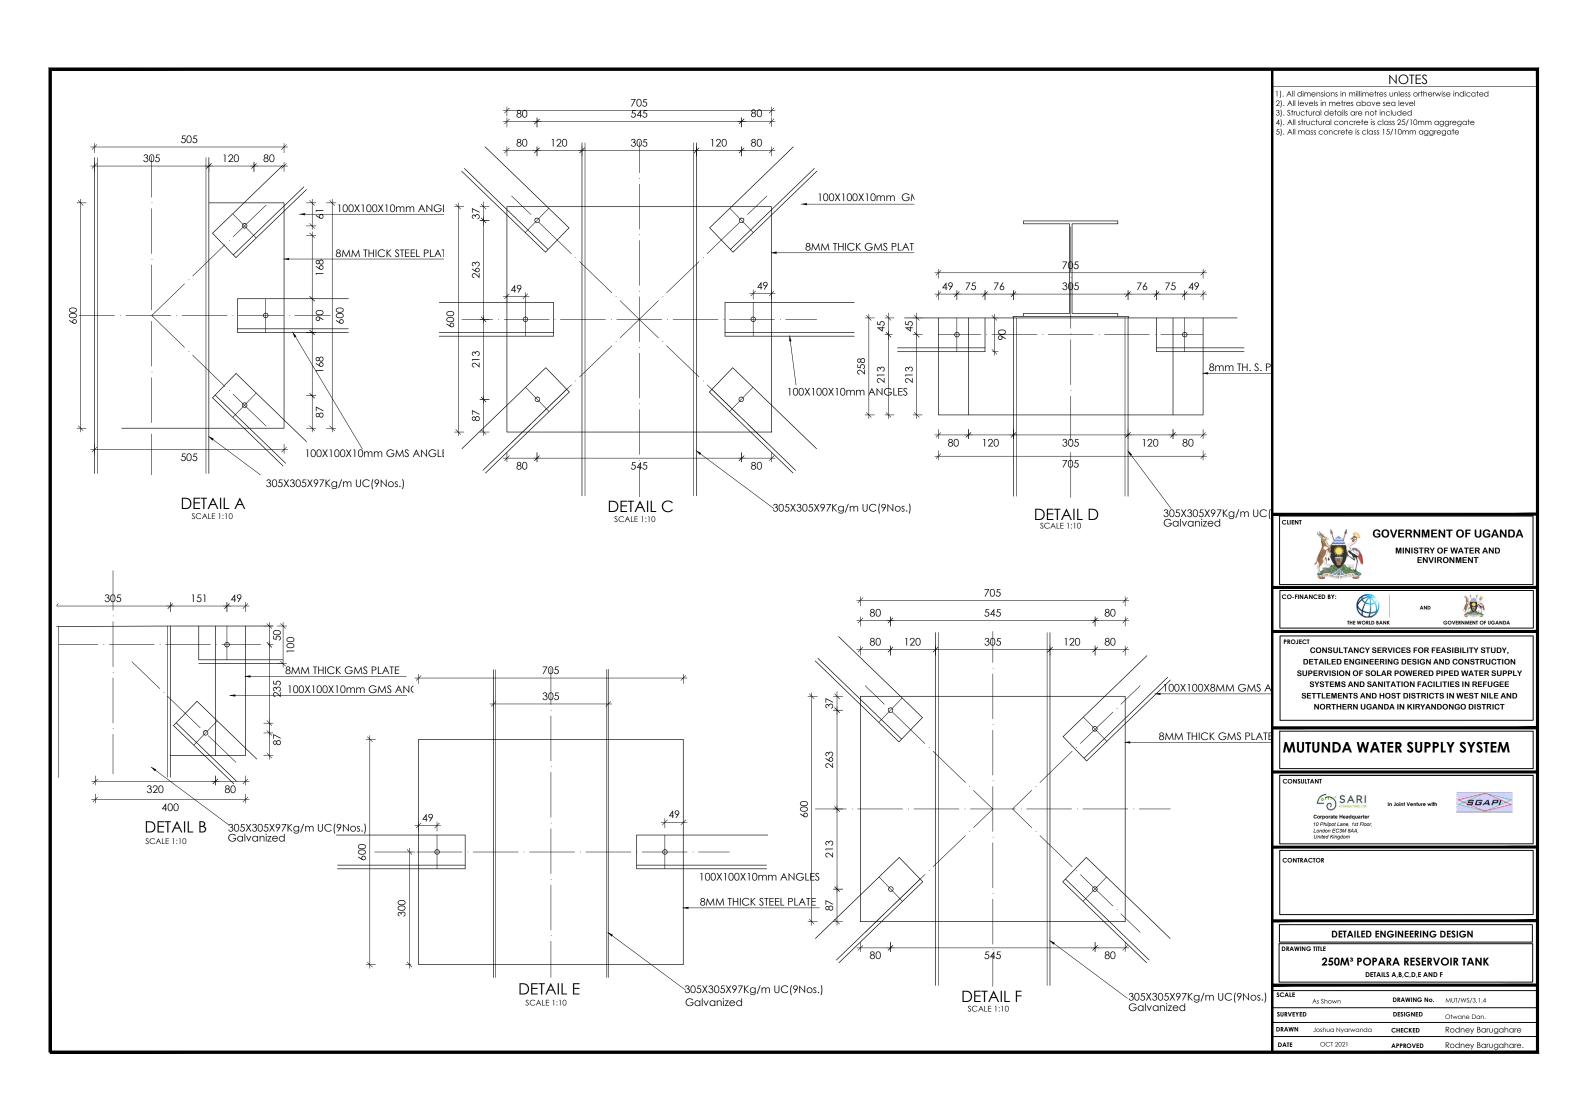

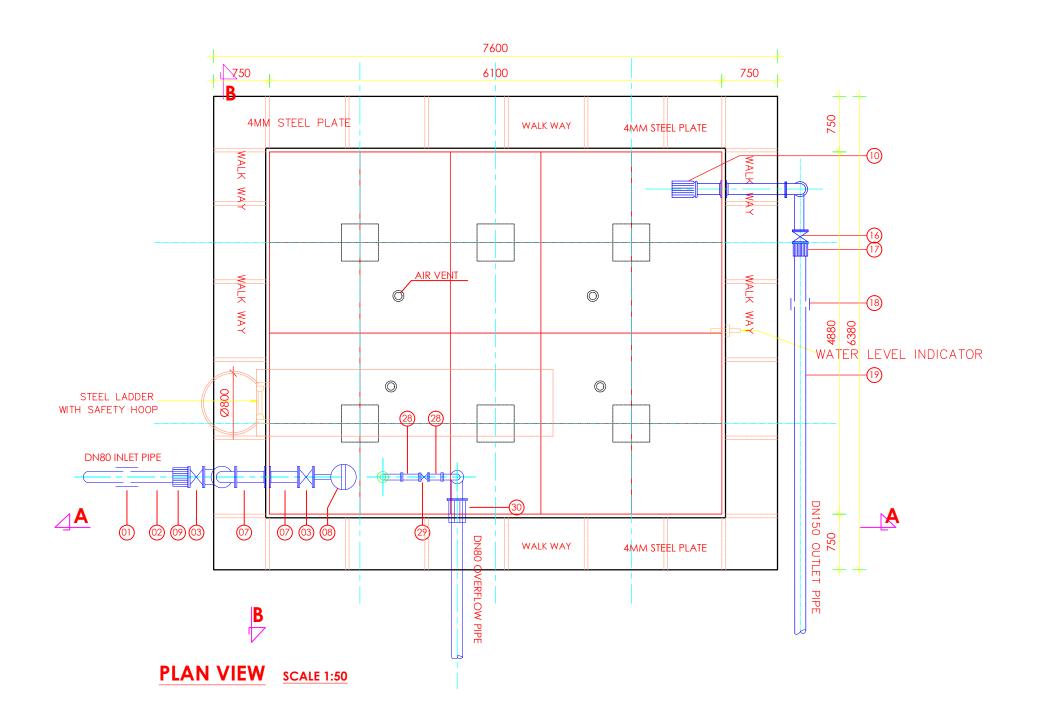

PIPE FITTING SCHEDULE

- 1. 1No.DN80 Vicking Johnson or Similar Coupling.
- 2. 1No.DN80 Pipe not exceeding 2.0m.
- 3. 1No.DN80 All Flanged Gate Valve.
- 4. 1No.DN80 All Flanged Duck foot 90° bend.
- 5. 3No.DN80 Double Flanged Pipe not exceeding 6.0m.
- 6. 1No.DN80 All Flanged 90° bend.
- 7. 2No.DN80 Double Flanged Pipe not exceeding 0.6m.
- 8. 1No.DN80 Flanged Ball Float Valve.
- 9. 1No.DN80 Flanged Adaptor, Maxi type or similar.
- 10. 1No.DN150 Flanged Outlet Pipe Strainer.
- $11.\,2 No. DN150\,Double\,Flanged\,Pipe\,not\,exceeding\,0.6 m.$
- 12. 1No.DN150 All Flanged 90° bend.
- 13. 2No.DN150 Double Flanged Pipe not exceeding 6.0m.
- 14. 1No.DN150 Double Flanged Pipe not exceeding 2.0m.
- 15. 1No.DN150 All Flanged Duck foot 90° bend.
- 16. 1No.DN150 Flanged Gate Valve.
- 17. 1No.DN150 Flanged Adaptor, Maxi type or similar.
- 18. 1No.DN150 Double Flanged Pipe not exceeding 2.0m.
- 19. 1No.DN150 Vicking Johnson or Similar Coupling.
- 20. 1No.DN80 Flanged Bell Mouth.
- 21. 1No.DN80 Double Flanged Pipe not exceeding 3.0m.
- 22. 2No.DN80 Double Flanged Pipe not exceeding 6.0m.
- 23. 1No.DN80/50 All Flanged Tee.
- 24. 1No.DN80 Double Flanged Pipe not exceeding 3.0m.
- 25. 1No.DN80 All Flanged Duck foot 90° bend.
- 26. 1No.DN80 All Flanged Pipe with puddle flange n.e 6.0m.
- 27. 1No.DN50 All Flanged 90° bend.
- 28. 1No.DN50 Double Flanged Pipe not exceeding 0.4m.
- 29. 1No.DN50 Flanged Gate Valve.
- 30. 1No.DN50 Flanged Adaptor, Maxi type or similar.



GOVERNMENT OF UGANDA

MINISTRY OF WATER AND ENVIRONMENT

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SUPERVISION OF SOLAR POWERED PIPED WATER SUPPLY
SYSTEMS AND SANITATION FACILITIES IN REFUGEE
SETTLEMENTS AND HOST DISTRICTS IN WEST NILE AND
NORTHERN UGANDA IN KIRYANDONGO DISTRICT

MUTUNDA WATER SUPPLY SYSTEM

CONSULTAN



In Joint Ventur



CONTRACTOR


DETAILED ENGINEERING DESIGN


DRAWING TITLE

100M³ TEYEGO RESERVOIR TANK

PLAN LAYOUT

SCALE	As Shown	DRAWING No.	MUT/WS/3.2.1
SURVEYED		DESIGNED	Otwane Dan.
DRAWN	Joshua Nyarwanda	CHECKED	Rodney Barugahare
DATE	OCT 2021	APPROVED	Rodney Barugahare.

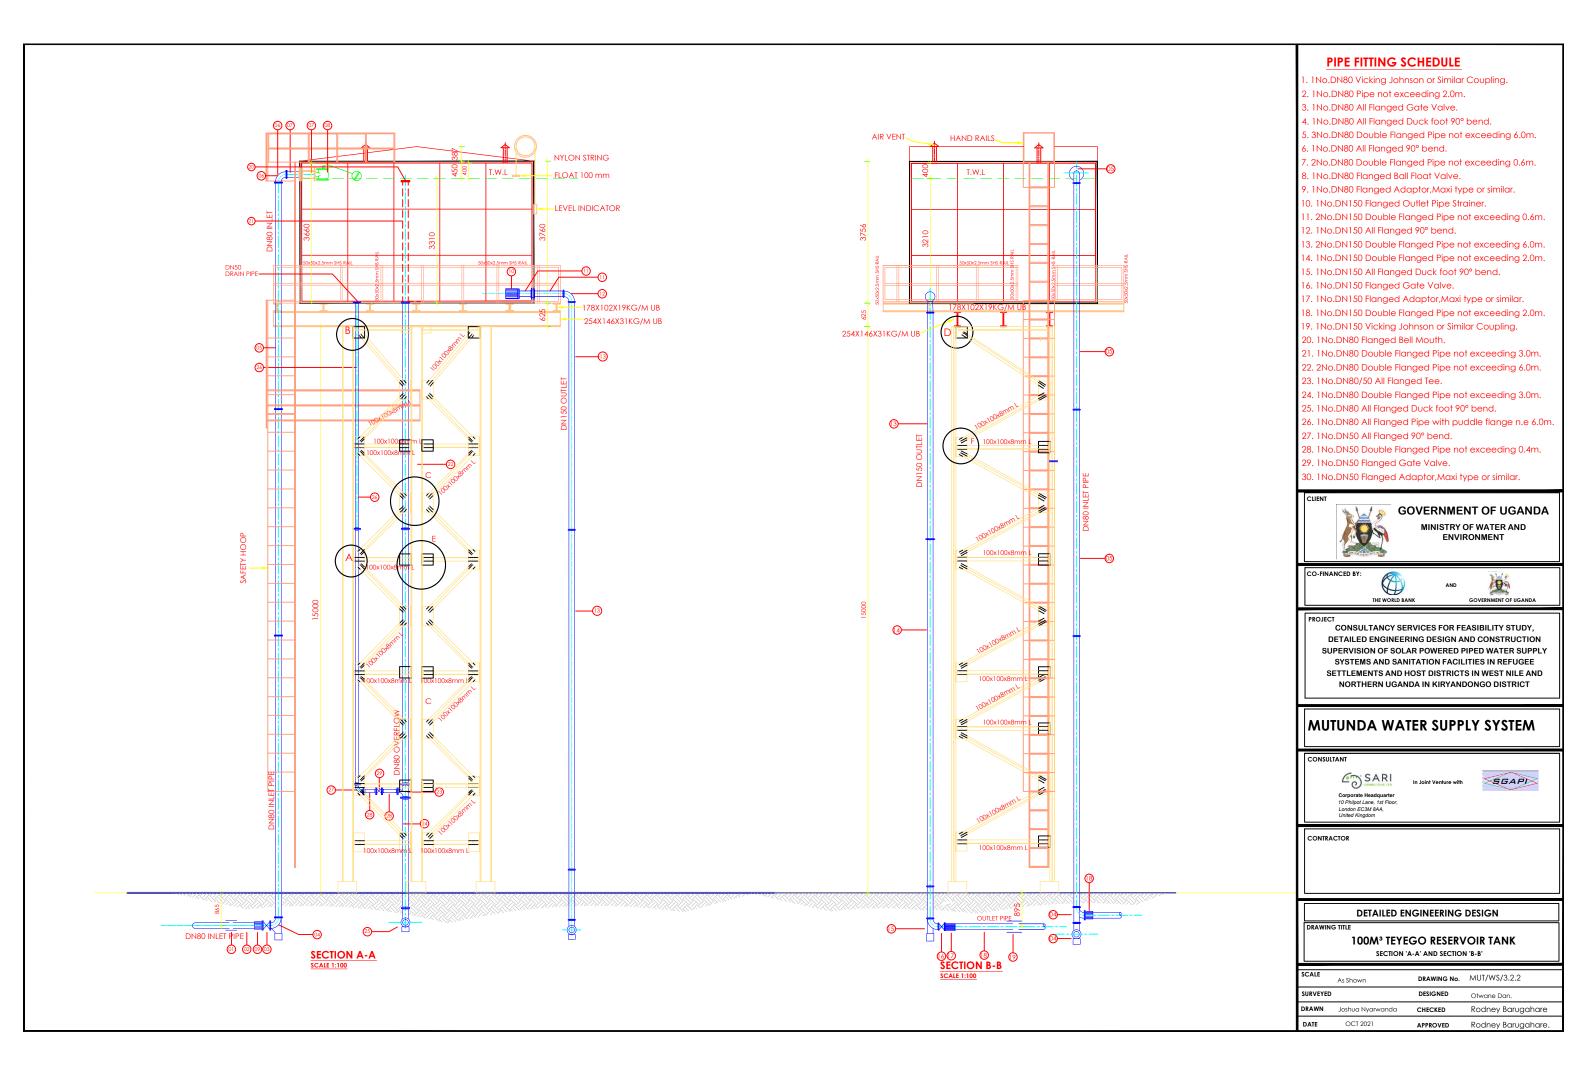

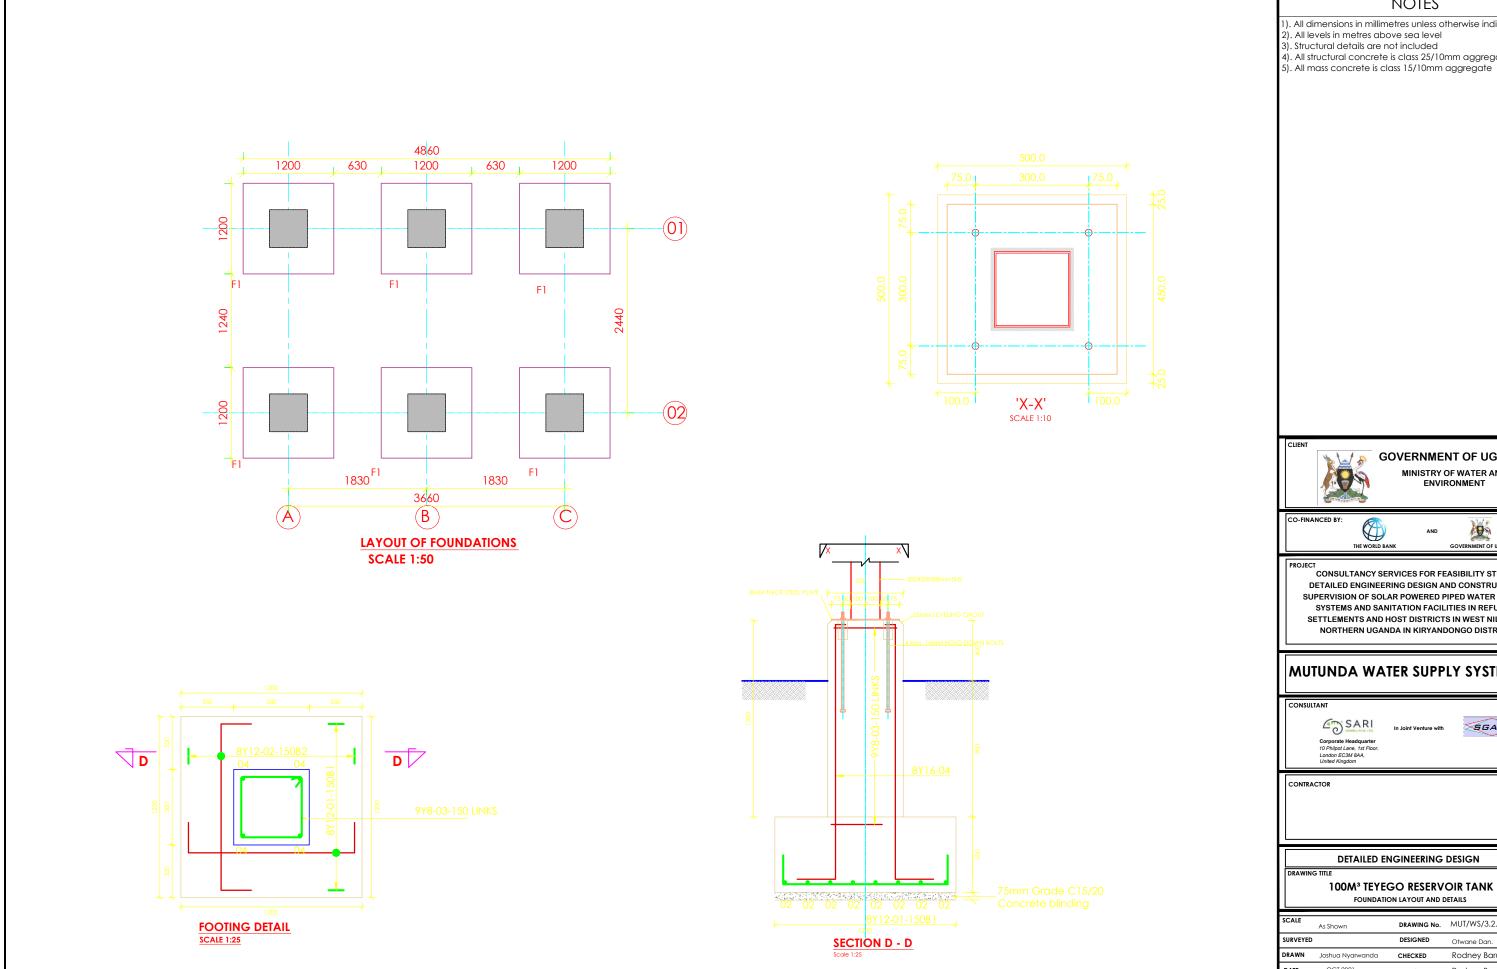

- 1). All dimensions in millimetres unless otherwise indicated

- 4). All structural concrete is class 25/10mm aggregate

GOVERNMENT OF UGANDA

MINISTRY OF WATER AND ENVIRONMENT


CONSULTANCY SERVICES FOR FEASIBILITY STUDY, DETAILED ENGINEERING DESIGN AND CONSTRUCTION SUPERVISION OF SOLAR POWERED PIPED WATER SUPPLY SYSTEMS AND SANITATION FACILITIES IN REFUGEE SETTLEMENTS AND HOST DISTRICTS IN WEST NILE AND NORTHERN UGANDA IN KIRYANDONGO DISTRICT


MUTUNDA WATER SUPPLY SYSTEM




DETAILED ENGINEERING DESIGN

SCALE	As Shown	DRAWING No.	MUT/WS/3.2.3
SURVEYED)	DESIGNED	Otwane Dan.
DRAWN	Joshua Nyarwanda	CHECKED	Rodney Barugahare
DATE	OCT 2021	A DDDOVED	Podpov Baruaabaro

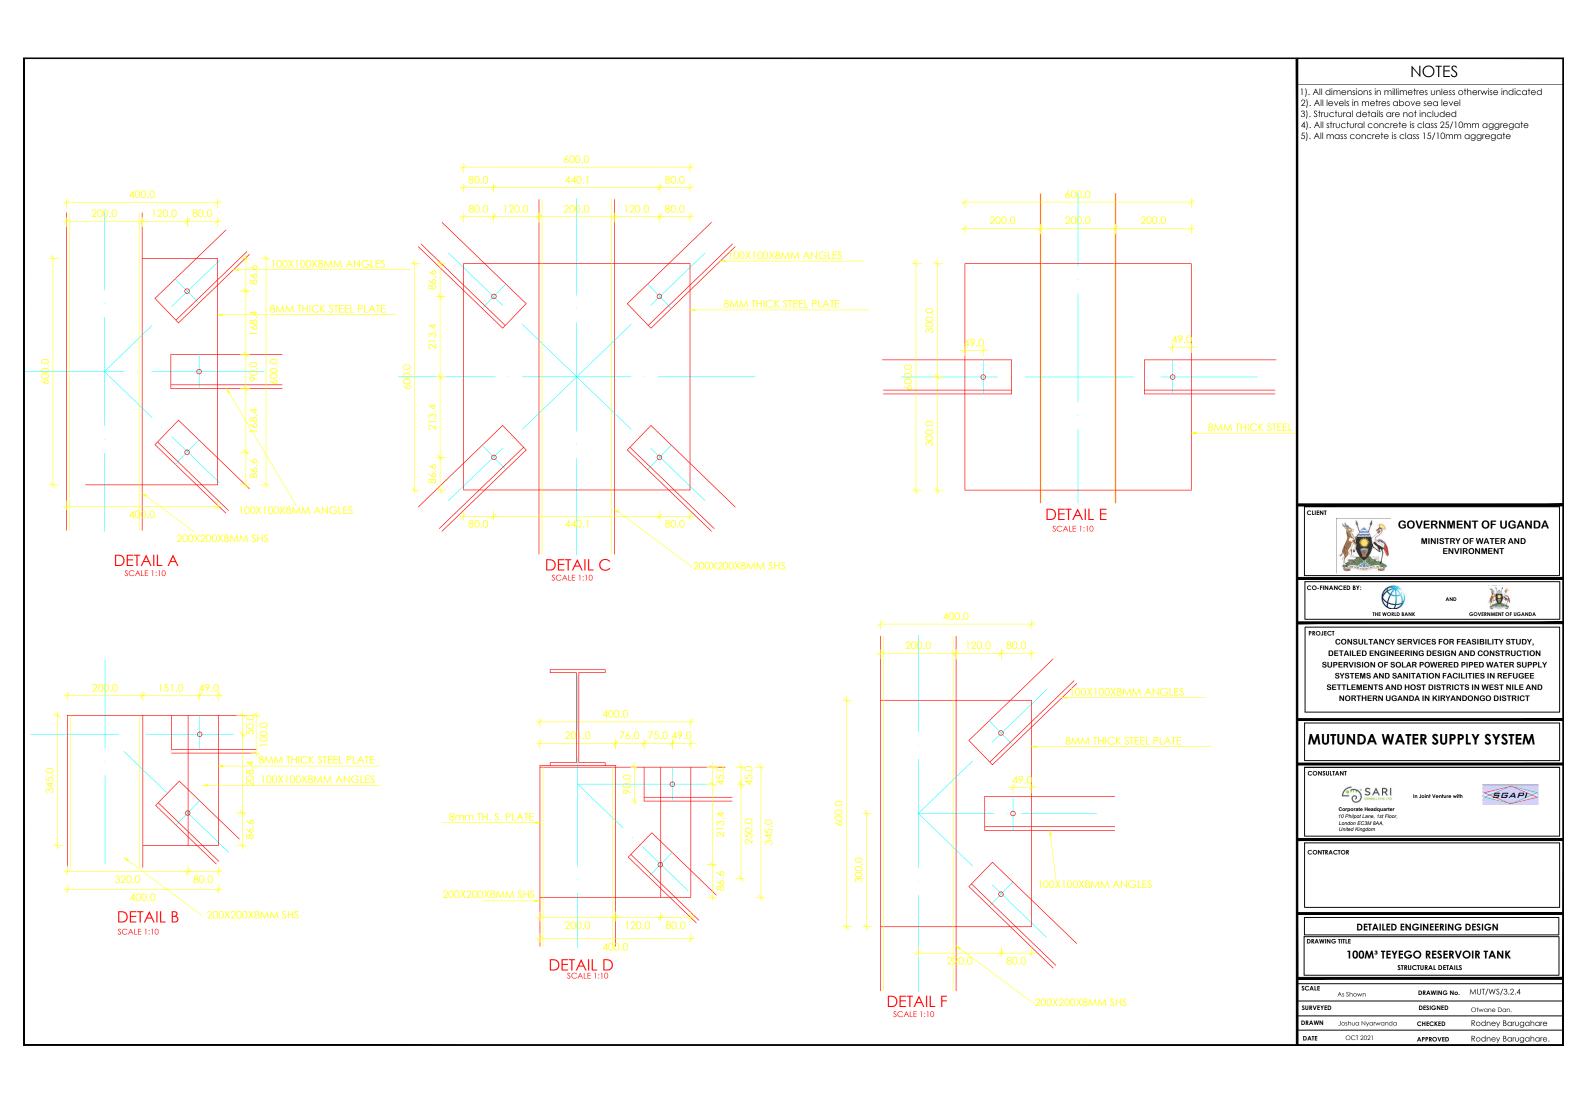

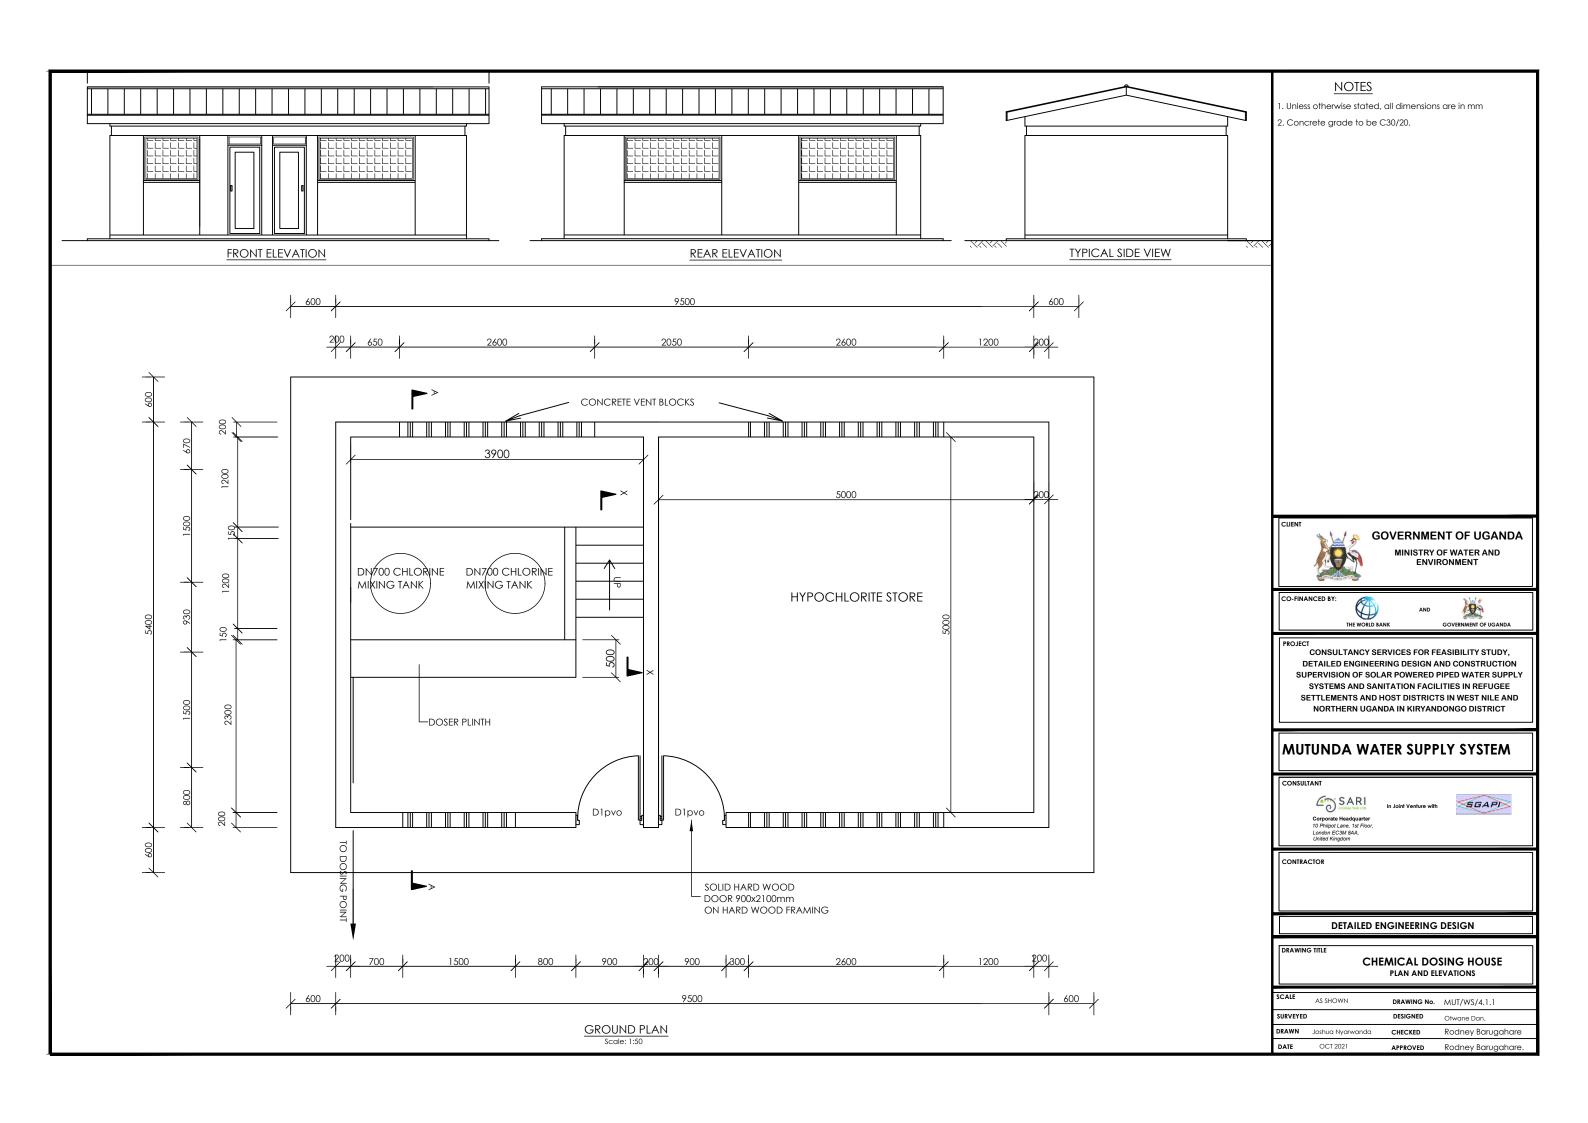

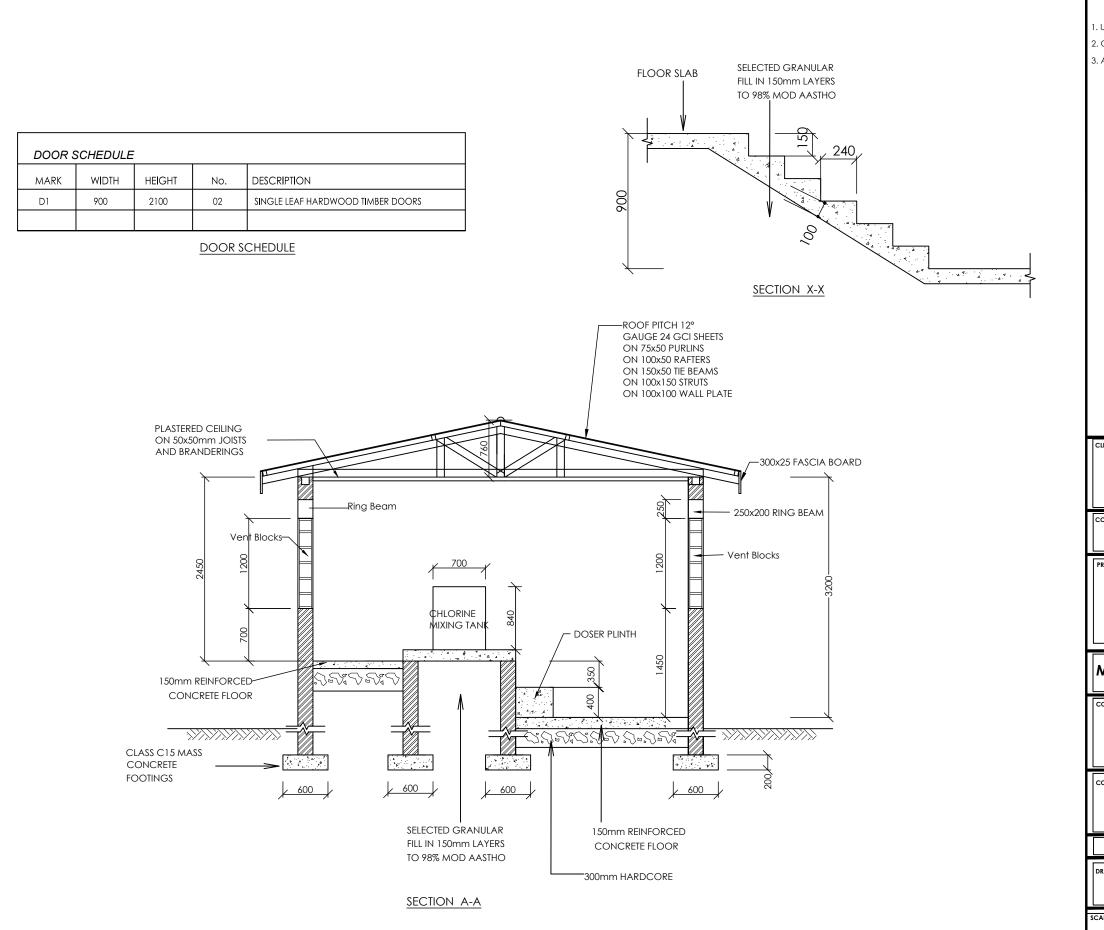

- 1. Unless otherwise stated, all dimensions are in mm
- 2. Concrete grade to be C30/20.
- 3. All levels in metres above mean sea level.



GOVERNMENT OF UGANDA

MINISTRY OF WATER AND ENVIRONMENT





CONSULTANCY SERVICES FOR FEASIBILITY STUDY, DETAILED ENGINEERING DESIGN AND CONSTRUCTION SUPERVISION OF SOLAR POWERED PIPED WATER SUPPLY SYSTEMS AND SANITATION FACILITIES IN REFUGEE SETTLEMENTS AND HOST DISTRICTS IN WEST NILE AND NORTHERN UGANDA IN KIRYANDONGO DISTRICT

MUTUNDA WATER SUPPLY SYSTEM






CONTRACTOR

DETAILED ENGINEERING DESIGN

DRAWING TITLE

CHEMICAL DOSING HOUSE

SCALE	AS SHOWN	DRAWING No.	MUT/WS/4.1.2
SURVEYED		DESIGNED	Otwane Dan.
DRAWN	Joshua Nyarwanda	CHECKED	Rodney Barugahare
DATE	OCT 2021	APPROVED	Rodney Barugahare.

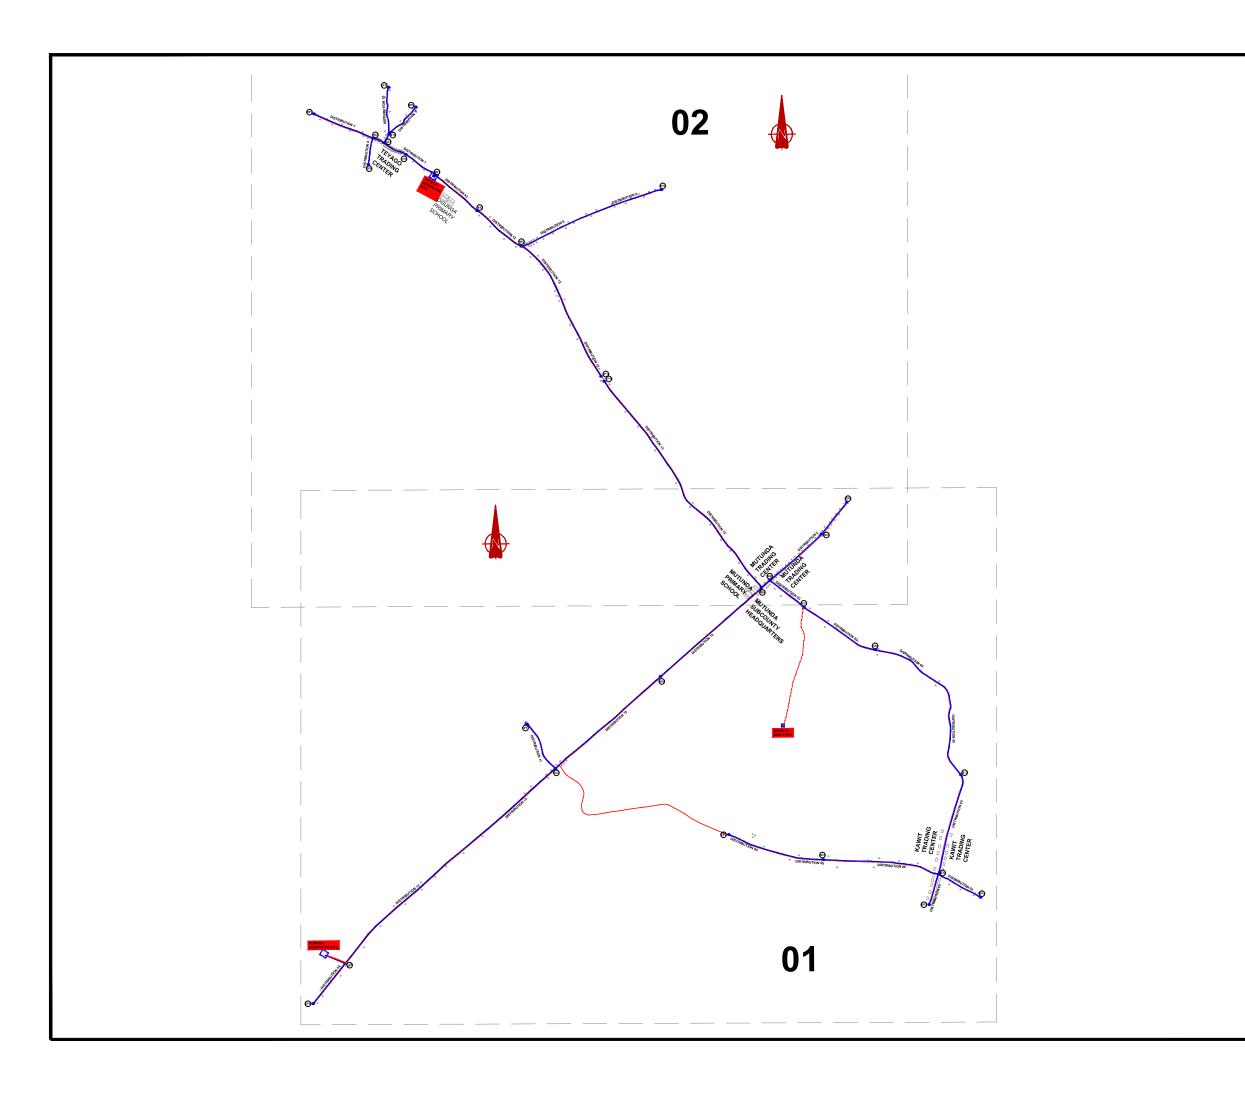

LEGEND

Transmission Pipeline Distribution Pipeline

Ground Level

Building/House

Contours

Road


DAV Double Orifice Air Valve

End pipe



Node N01

WO-1 Washout Type 1 WO-2 Washout Type2

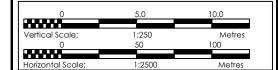



GOVERNMENT OF UGANDA

MINISTRY OF WATER AND ENVIRONMENT





CONSULTANCY SERVICES FOR FEASIBILITY STUDY, DETAILED ENGINEERING DESIGN AND CONSTRUCTION SUPERVISION OF SOLAR POWERED PIPED WATER SUPPLY SYSTEMS AND SANITATION FACILITIES IN REFUGEE SETTLEMENTS AND HOST DISTRICTS IN WEST NILE AND NORTHERN UGANDA IN KIRYANDONGO DISTRICT

MUTUNDA WATER SUPPLY SYSTEM








DETAILED ENGINEERING DESIGN DRAWING TITLE GENERAL LAYOUT

DISTRIBUTION NETWORK

DRAWING No. MUT/WS/5.0.0 SURVEYED Evans Mpanga DESIGNED **DRAWN** Joshua Nyarwanda Rodney Barugahare CHECKED April 2021

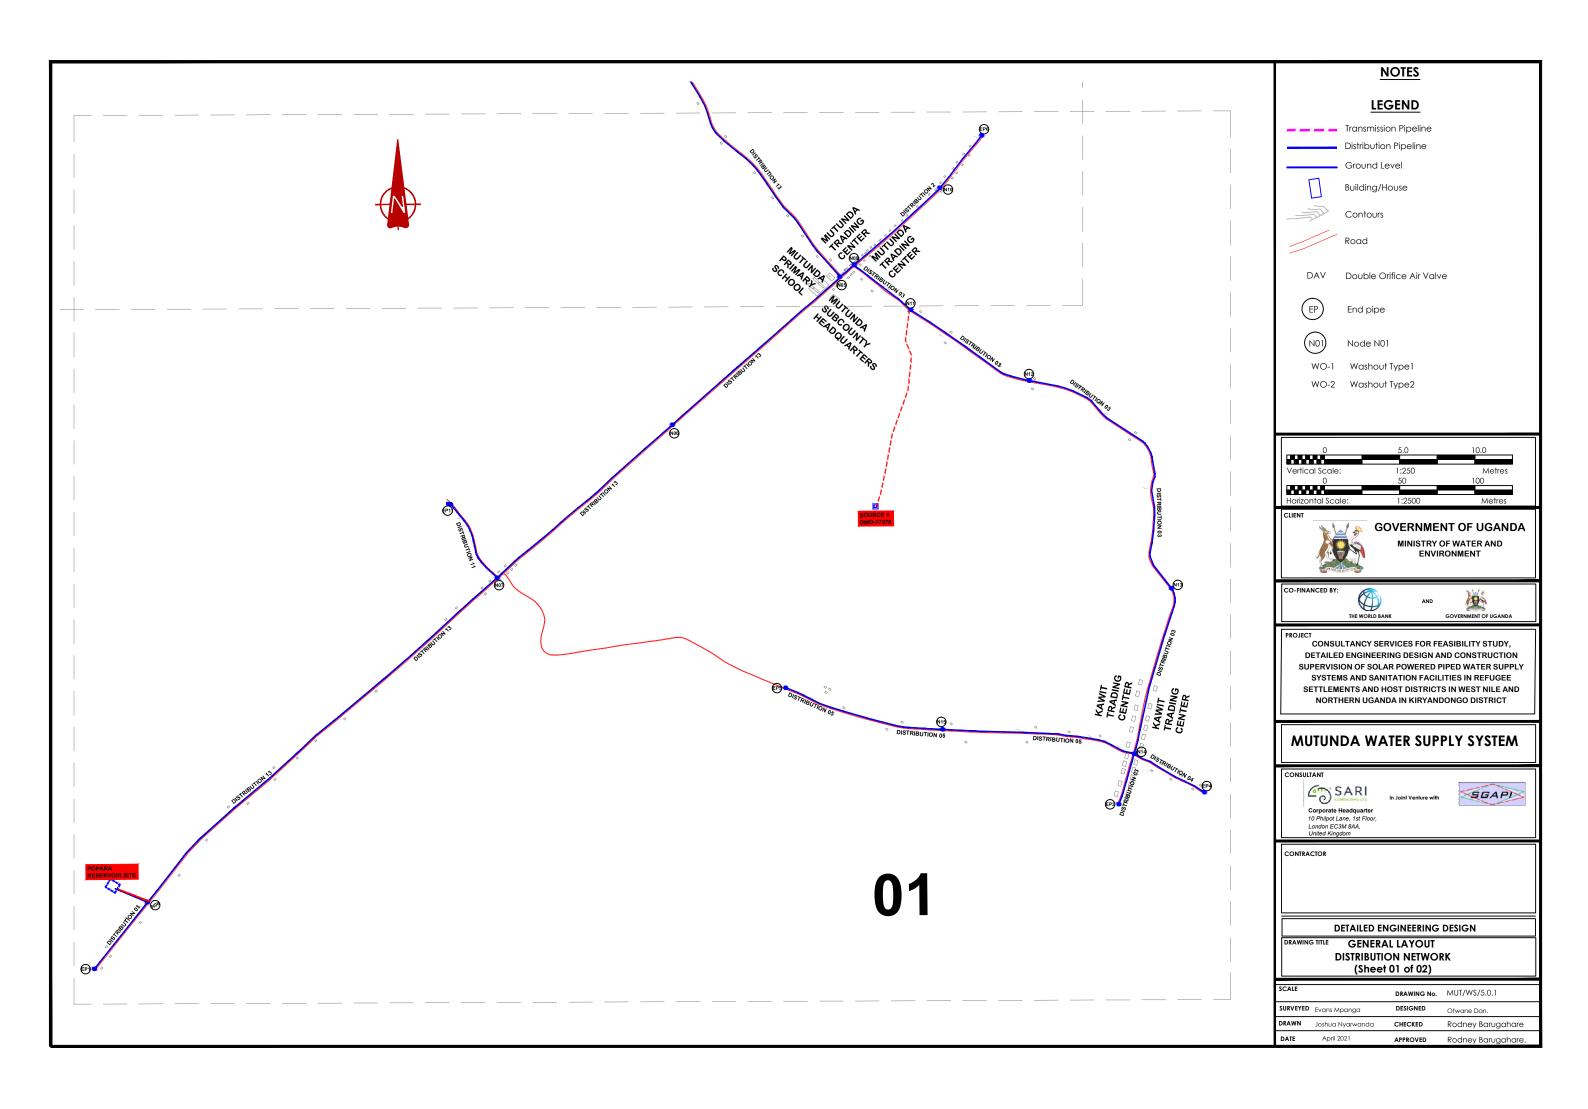

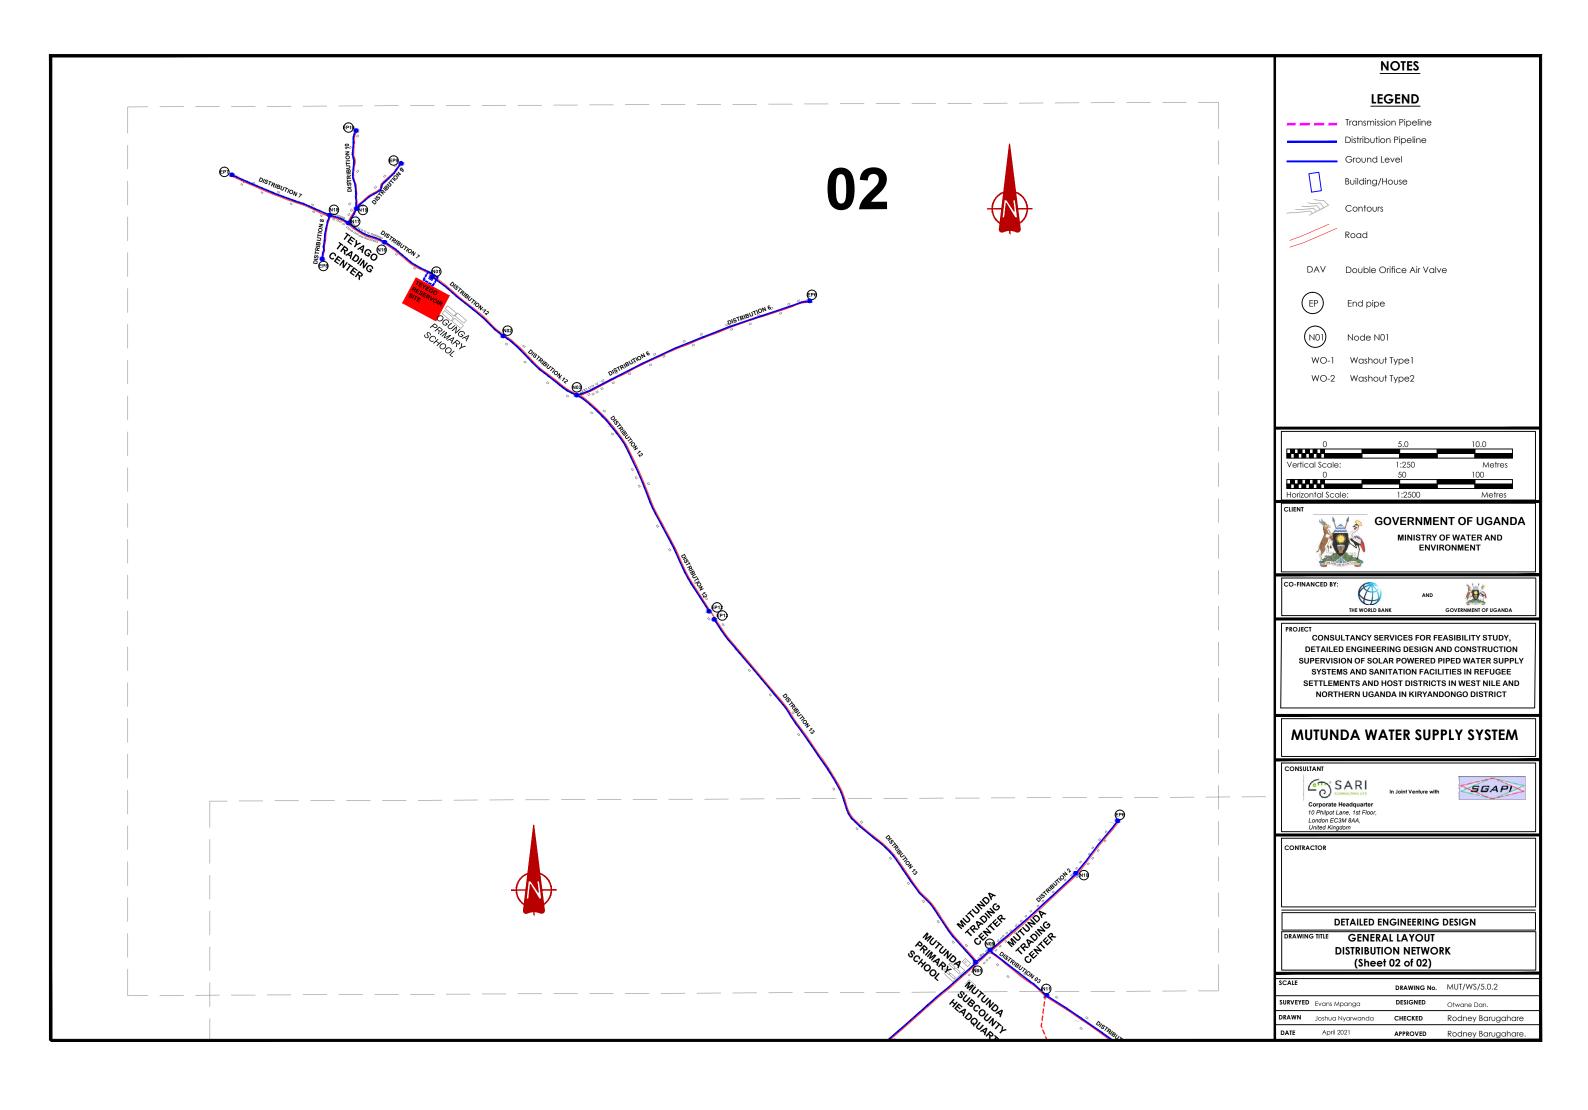

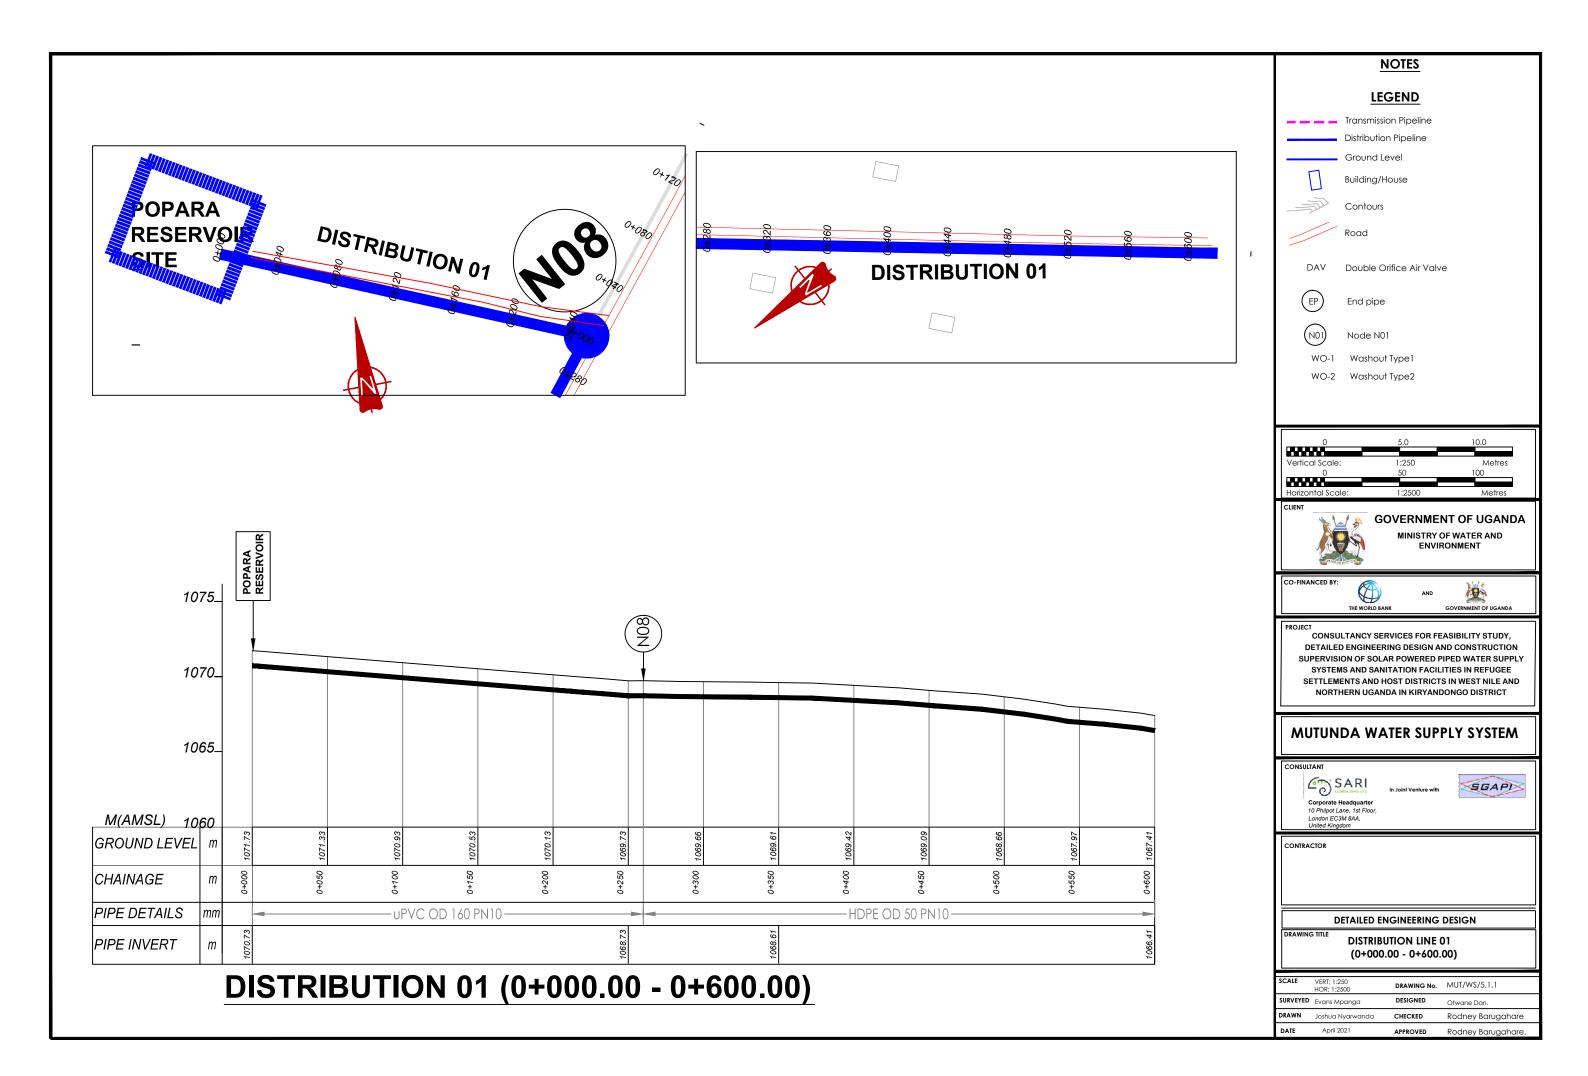

DISTRIBUTION 01 1075_ 1070_ 1065_ M(AMSL) 1060 GROUND LEVEL | m | CHAINAGE PIPE DETAILS -HDPE OD 50 PN10-PIPE INVERT **DISTRIBUTION 01 (0+600.00 - 0+860.46)**

NOTES LEGEND Transmission Pipeline Distribution Pipeline Ground Level Building/House Contours Road DAV Double Orifice Air Valve End pipe Node N01 WO-1 Washout Type 1 WO-2 Washout Type2 **GOVERNMENT OF UGANDA** MINISTRY OF WATER AND ENVIRONMENT CONSULTANCY SERVICES FOR FEASIBILITY STUDY, DETAILED ENGINEERING DESIGN AND CONSTRUCTION SUPERVISION OF SOLAR POWERED PIPED WATER SUPPLY SYSTEMS AND SANITATION FACILITIES IN REFUGEE SETTLEMENTS AND HOST DISTRICTS IN WEST NILE AND NORTHERN UGANDA IN KIRYANDONGO DISTRICT **MUTUNDA WATER SUPPLY SYSTEM**

Corporate Headquarter
10 Philipot Lane, 1st Floor,
London ECSM BAA,
United Kingdom


In Joint Venture with




DETAILED ENGINEERING DESIGN

DISTRIBUTION LINE 01 (0+600.00 - 1+200.00)


SCALE	VERT; 1:250 HOR; 1:2500	DRAWING No.	MUT/WS/5.1.2
SURVEY	FED Evans Mpanga	DESIGNED	Otwane Dan.
DRAWN	Joshua Nyarwanda	CHECKED	Rodney Barugahare
DATE	April 2021	APPROVED	Rodney Barugahare.

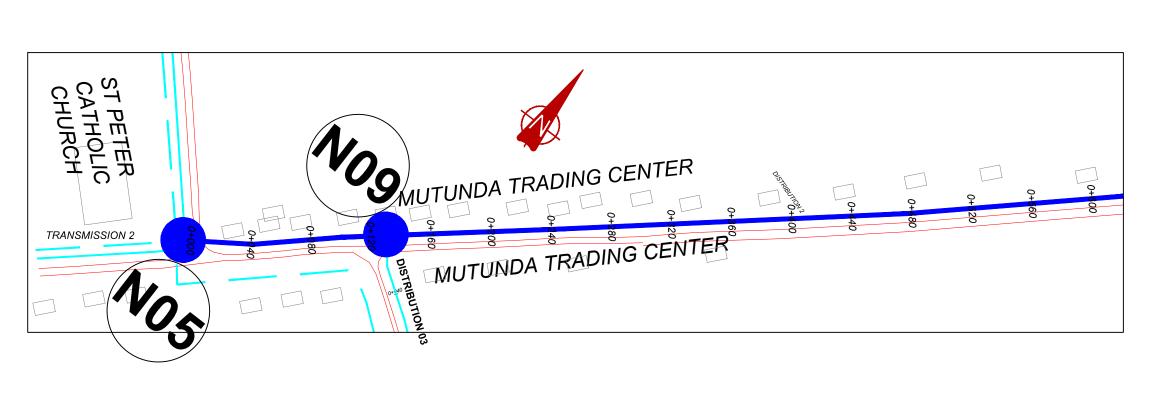

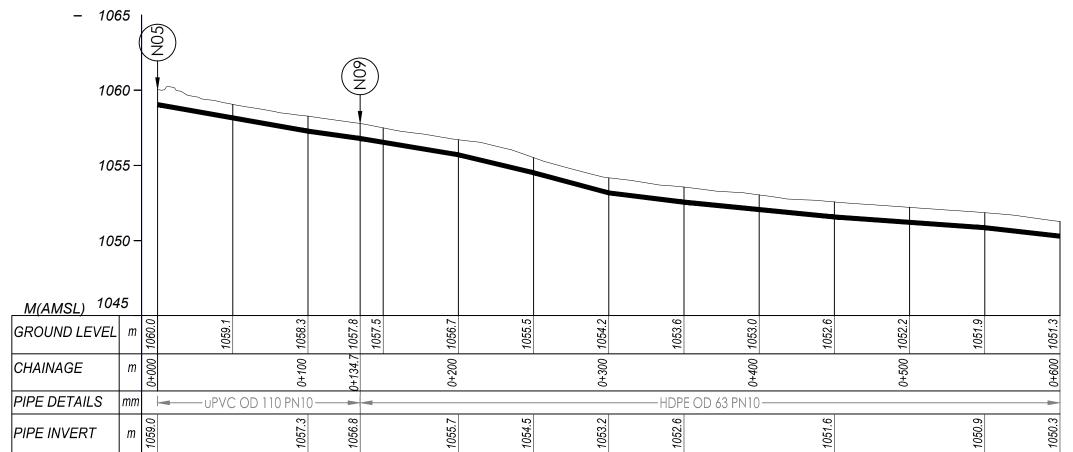

DISTRIBUTION 02 (0+000.00 - 0+600.00)

LEGEND Transmission Pipeline Distribution Pipeline Ground Level Building/House Contours Road DAV Double Orifice Air Valve EP End pipe NOI Node NOI WO-1 Washout Type I WO-2 Washout Type 2

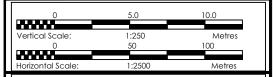

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GOVERNMENT OF UGANDA MINISTRY OF WATER AND ENVIRONMENT

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PROJECT

COJECT

CONSULTANCY SERVICES FOR FEASIBILITY STUDY,

DETAILED ENGINEERING DESIGN AND CONSTRUCTION
SUPERVISION OF SOLAR POWERED PIPED WATER SUPPLY
SYSTEMS AND SANITATION FACILITIES IN REFUGEE
SETTLEMENTS AND HOST DISTRICTS IN WEST NILE AND
NORTHERN UGANDA IN KIRYANDONGO DISTRICT

MUTUNDA WATER SUPPLY SYSTEM

Corporate Headquarter
10 Philipot Lane, 1st Floor,
London EC3M 8AA,
United Kingdom

In Joint Venture with




CONTRACTO

DETAILED ENGINEERING DESIGN

DISTRIBUTION LINE 02 (0+000.00 - 0+600.00)

SCALE	VERT: 1:250		
H	HOR; 1:2500	DRAWING No.	MUT/WS/5.2.1
SURVEYED	Evans Mpanga	DESIGNED	Otwane Dan.
DRAWN	Joshua Nyarwanda	CHECKED	Rodney Barugahare
DATE	April 2021	APPROVED	Rodney Barugahare.

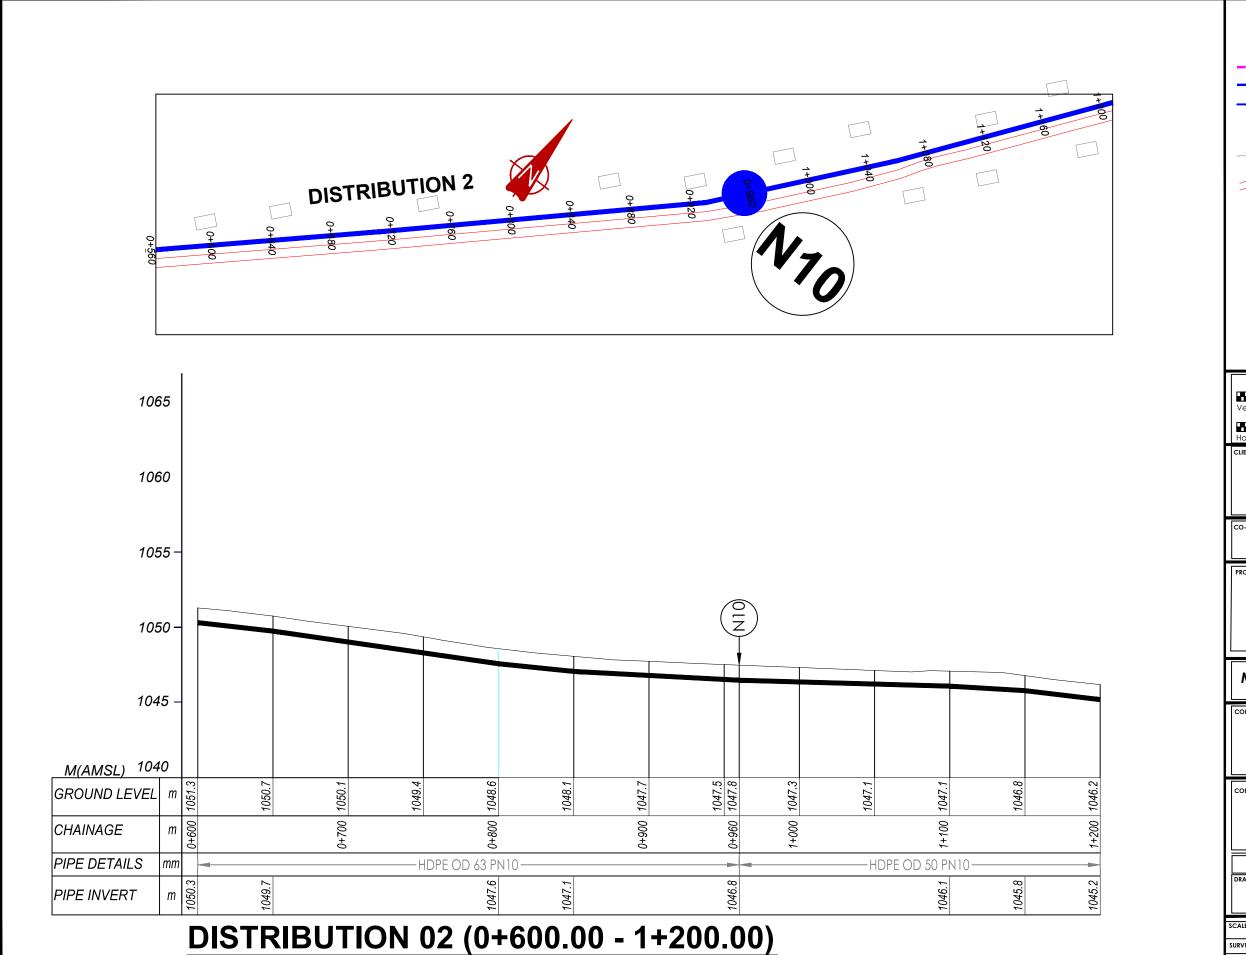

LEGEND

_____ Transmission Pipeline
_____ Distribution Pipeline
_____ Ground Level



Building/House



Contours



Road

DAV Double Orifice Air Valve




End pipe



Node N01

WO-2 Washout Type2

WO-1 Washout Type 1

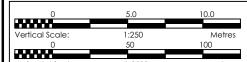

GOVERNMENT OF UGANDA MINISTRY OF WATER AND

MINISTRY OF WATER AND ENVIRONMENT

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CONSULTANCY SERVICES FOR FEASIBILITY STUDY,
DETAILED ENGINEERING DESIGN AND CONSTRUCTION
SUPERVISION OF SOLAR POWERED PIPED WATER SUPPLY
SYSTEMS AND SANITATION FACILITIES IN REFUGEE
SETTLEMENTS AND HOST DISTRICTS IN WEST NILE AND
NORTHERN UGANDA IN KIRYANDONGO DISTRICT

MUTUNDA WATER SUPPLY SYSTEM

Corporate Headquarter
10 Philipot Lane, 1st Floor,
London EC3M 8AA,
United Kingdom

In Joint Venture with





CONTRACTO

DETAILED ENGINEERING DESIGN

DISTRIBUTION LINE 02 (0+600.00 - 1+200.00)


SCALE	VERT; 1:250 HOR; 1:2500	DRAWING No.	MUT/WS/5.2.2
SURVEYED	Evans Mpanga	DESIGNED	Otwane Dan.
DRAWN	Joshua Nyarwanda	CHECKED	Rodney Barugahare
DATE	April 2021	APPROVED	Rodney Barugahare.

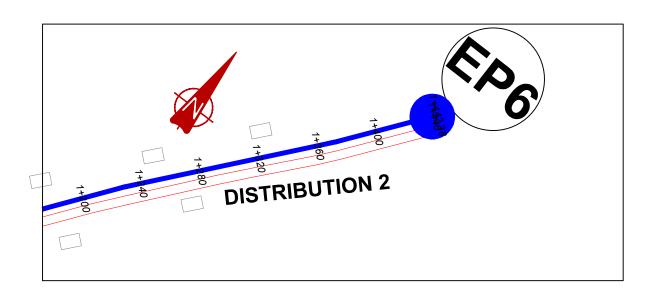

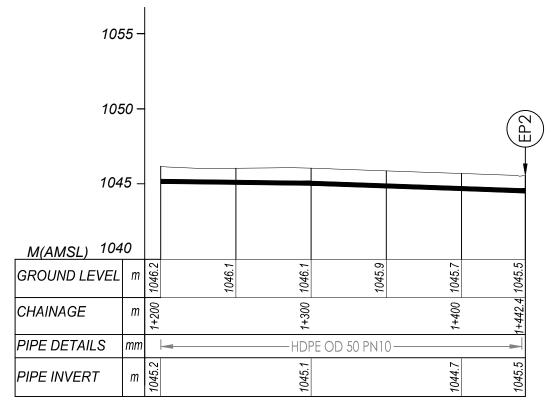

DISTRIBUTION 02 (1+200.00 - 1+442.40)

NOTES LEGEND Transmission Pipeline Distribution Pipeline Ground Level Building/House Contours Road DAV Double Orifice Air Valve End pipe Node N01 WO-1 Washout Type 1 WO-2 Washout Type2

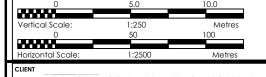









CONSULTANCY SERVICES FOR FEASIBILITY STUDY, DETAILED ENGINEERING DESIGN AND CONSTRUCTION SUPERVISION OF SOLAR POWERED PIPED WATER SUPPLY SYSTEMS AND SANITATION FACILITIES IN REFUGEE SETTLEMENTS AND HOST DISTRICTS IN WEST NILE AND NORTHERN UGANDA IN KIRYANDONGO DISTRICT

MUTUNDA WATER SUPPLY SYSTEM


SARI Corporate Headquarter 10 Philpot Lane, 1st Floor, London EC3M 8AA, United Kingdom





DETAILED ENGINEERING DESIGN


DISTRIBUTION LINE 02 (1+200.00 - 1+442.40)


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SURVEYED	Evans Mpanga	DESIGNED	Otwane Dan.
DRAWN	Joshua Nyarwanda	CHECKED	Rodney Barugahare
DATE	April 2021	APPROVED	Rodney Barugahare.

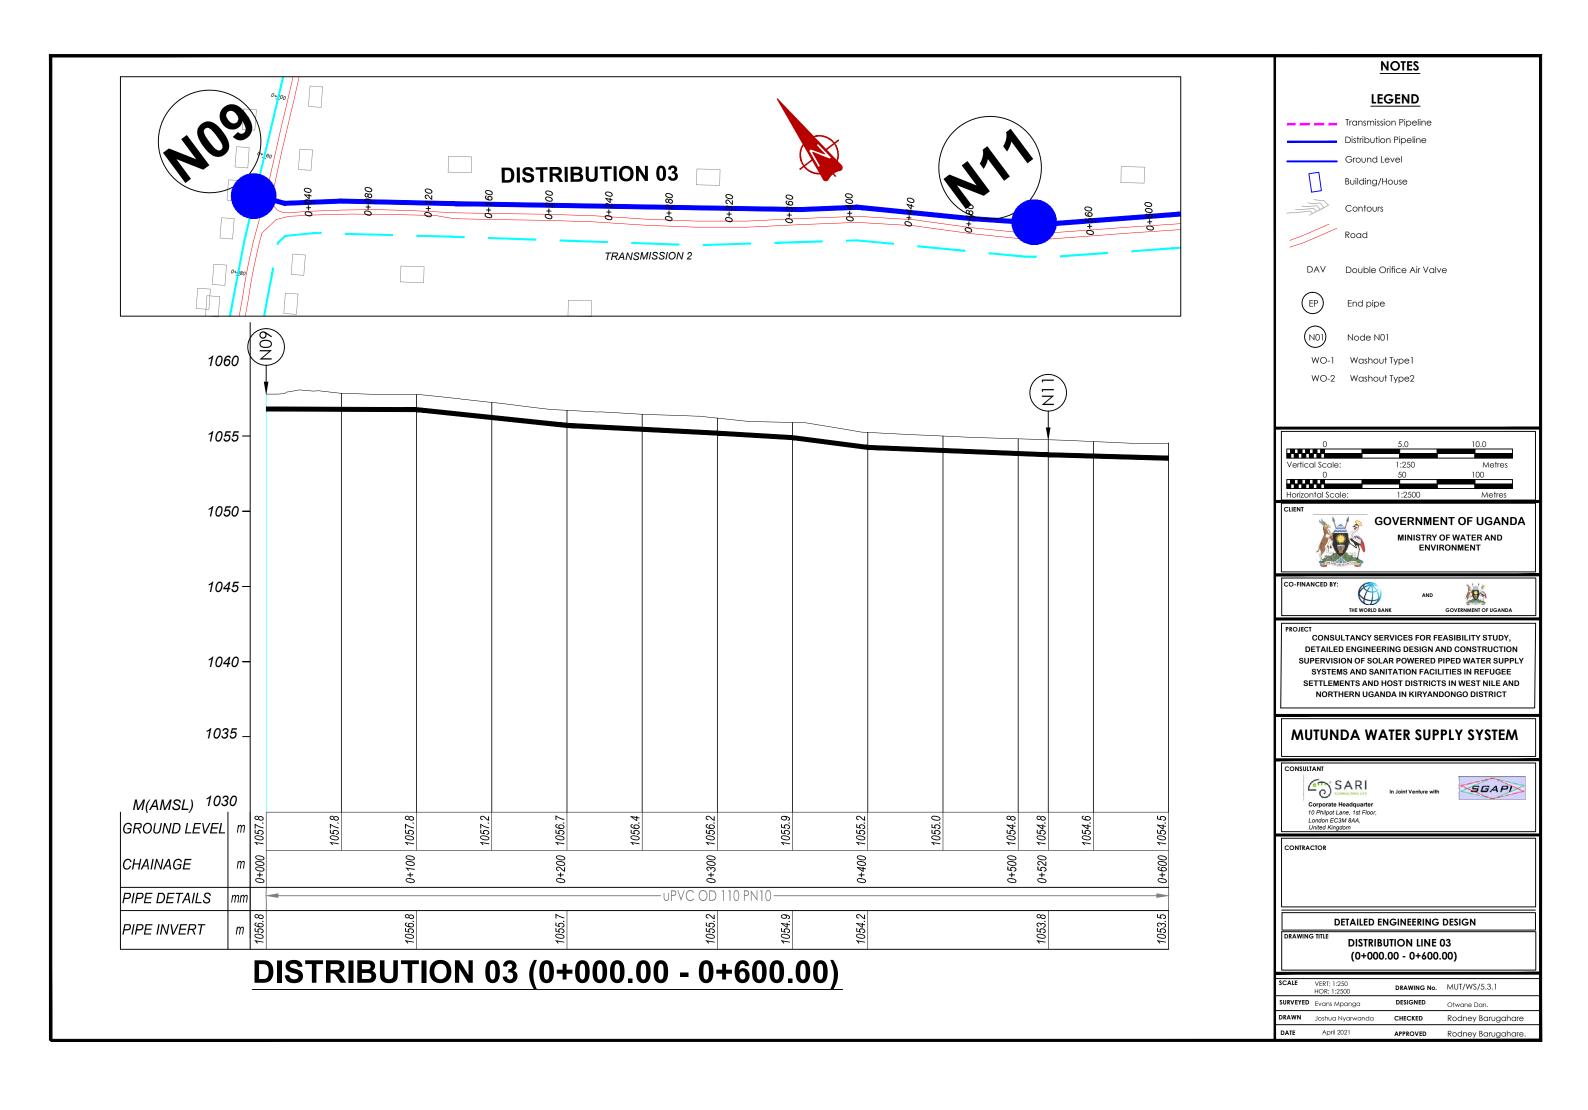

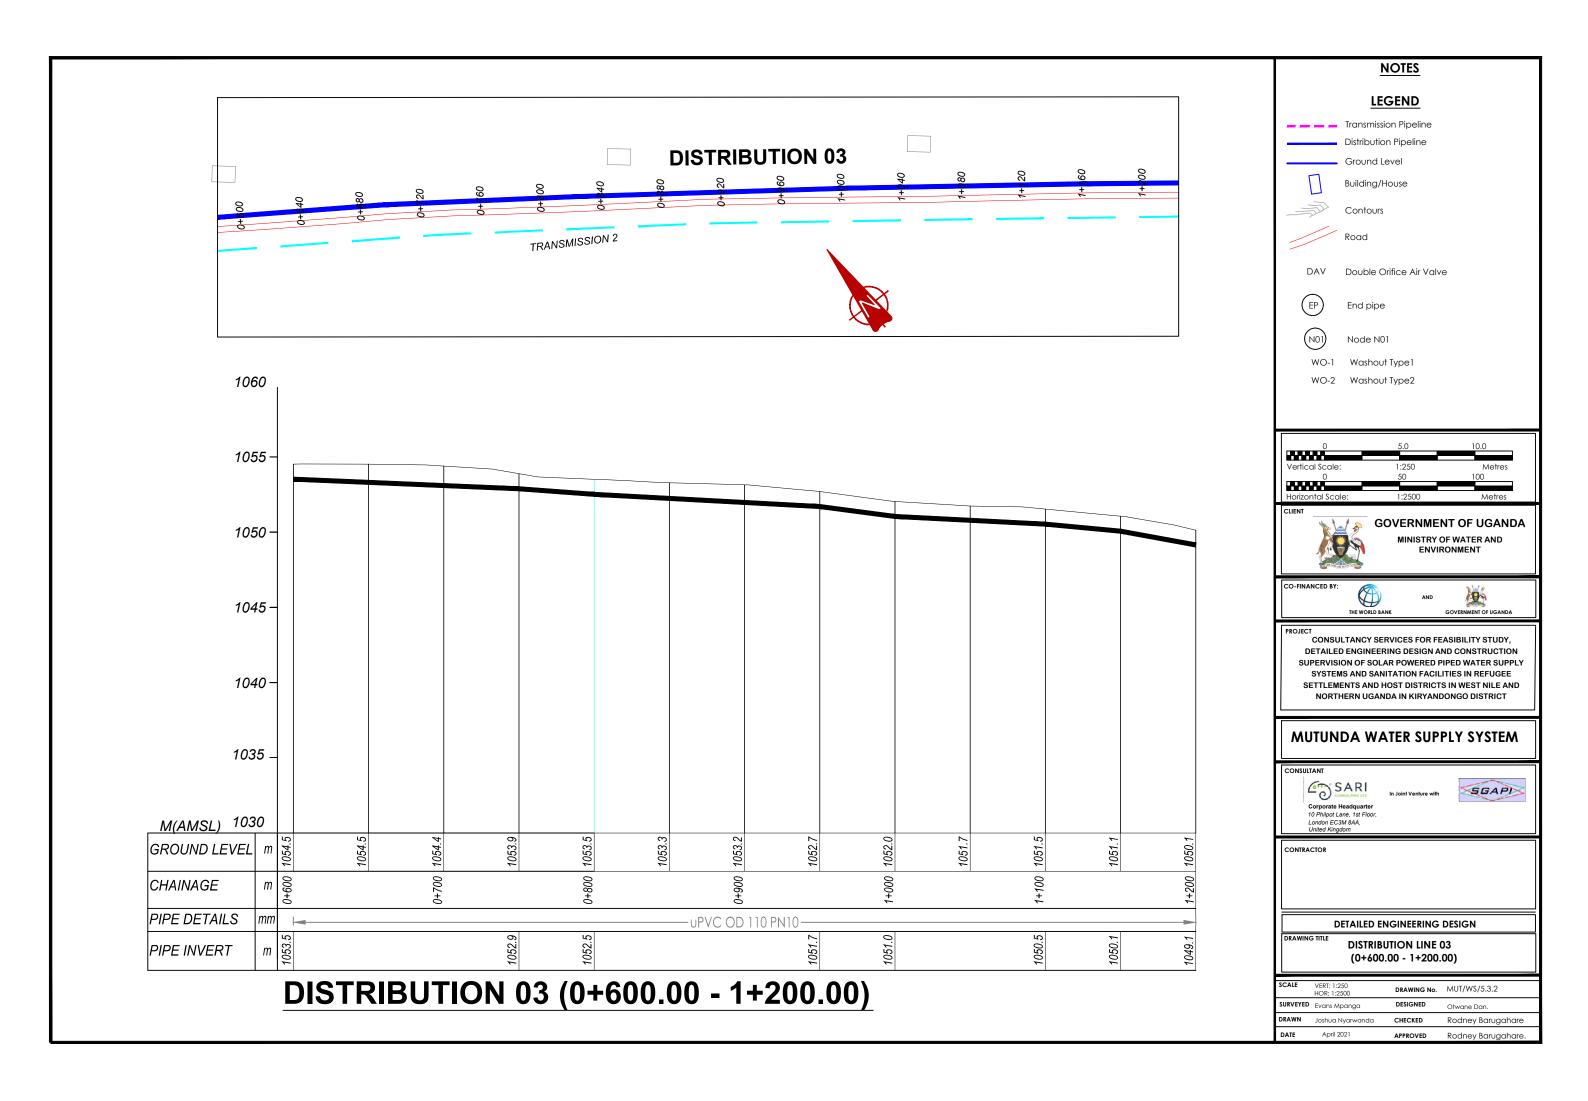

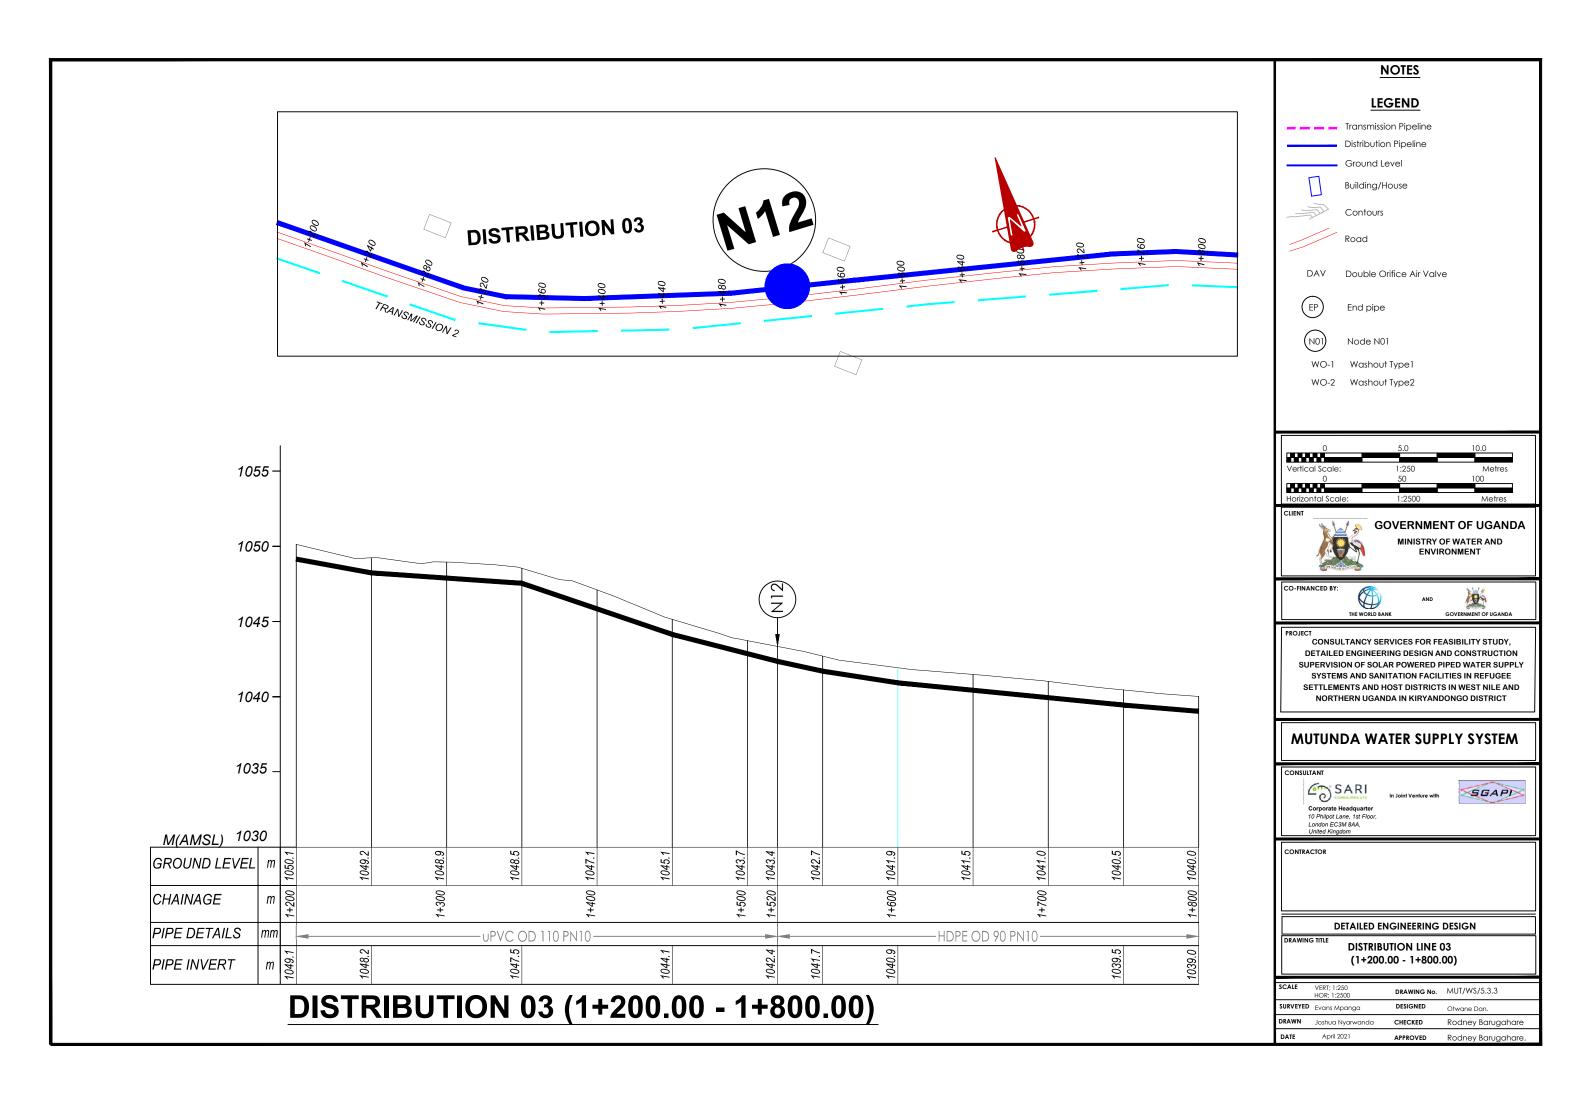

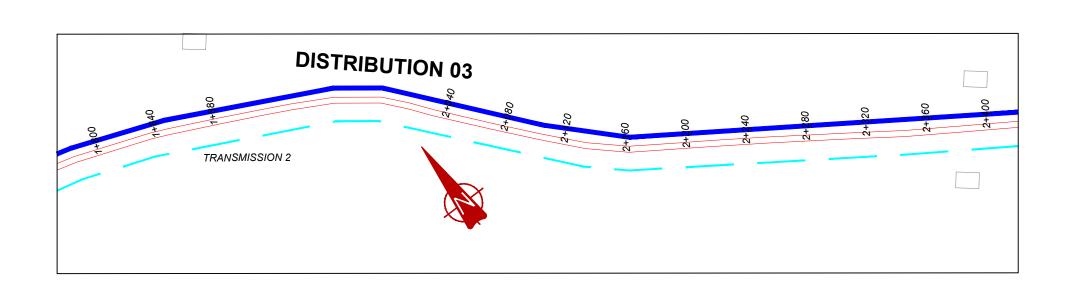

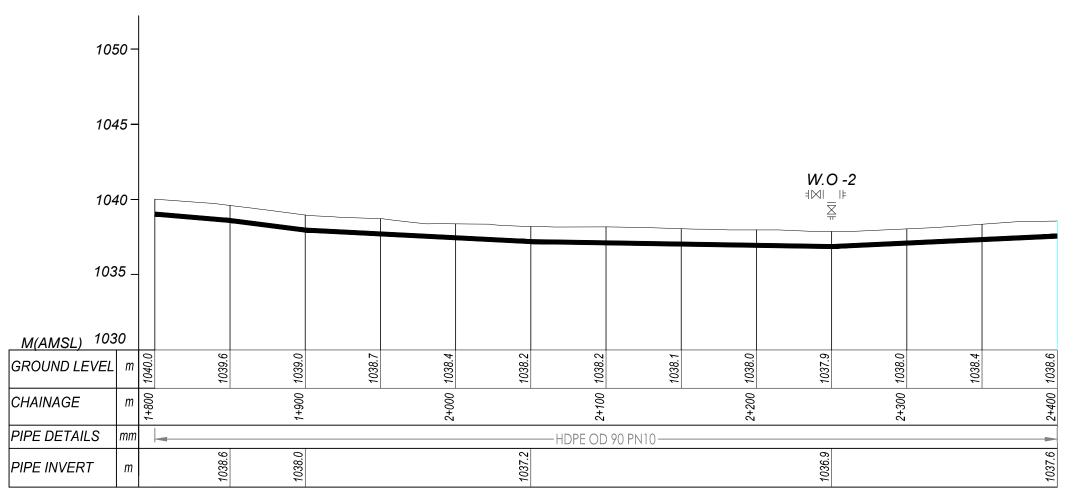

DISTRIBUTION 03 (1+800.00 - 2+400.00)

NOTES LEGEND

Transmission Pipeline
Distribution Pipeline
Ground Level



Building/House



Contours Road



DAV Double Orifice Air Valve




End pipe



Node N01

WO-2 Washout Type2

WO-1 Washout Type 1

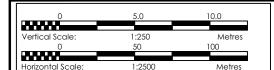



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CONSULTANCY SERVICES FOR FEASIBILITY STUDY,
DETAILED ENGINEERING DESIGN AND CONSTRUCTION
SUPERVISION OF SOLAR POWERED PIPED WATER SUPPLY
SYSTEMS AND SANITATION FACILITIES IN REFUGEE
SETTLEMENTS AND HOST DISTRICTS IN WEST NILE AND
NORTHERN UGANDA IN KIRYANDONGO DISTRICT

MUTUNDA WATER SUPPLY SYSTEM

CONSULTANT

Corporate Headquarter
10 Philipot Lane, 1st Floor,
London EC3M 8AA,
United Kingdom

In Joint Venture with





CONTRACTO


DETAILED ENGINEERING DESIGN

DISTRIBUTION LINE 03 (1+800.00 - 2+400.00)

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SURVEYED		DESIGNED	Otwane Dan.
DRAWN	Joshua Nyarwanda	CHECKED	Rodney Barugahare
DATE	April 2021	APPROVED	Rodney Barugahare.

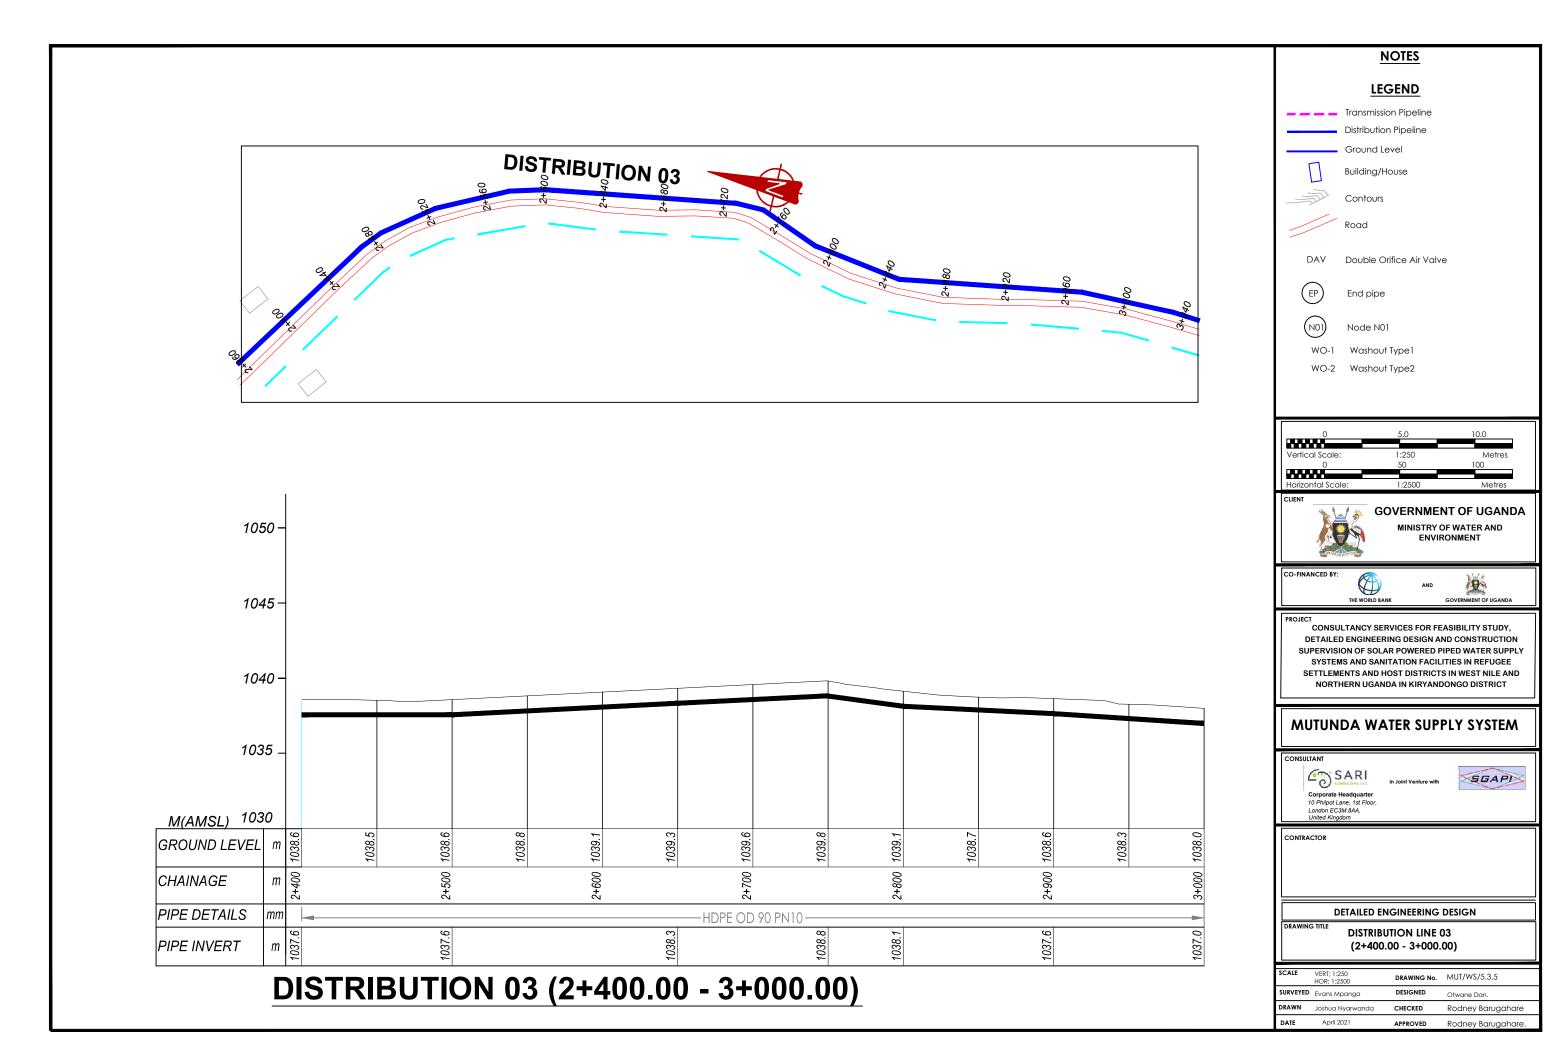

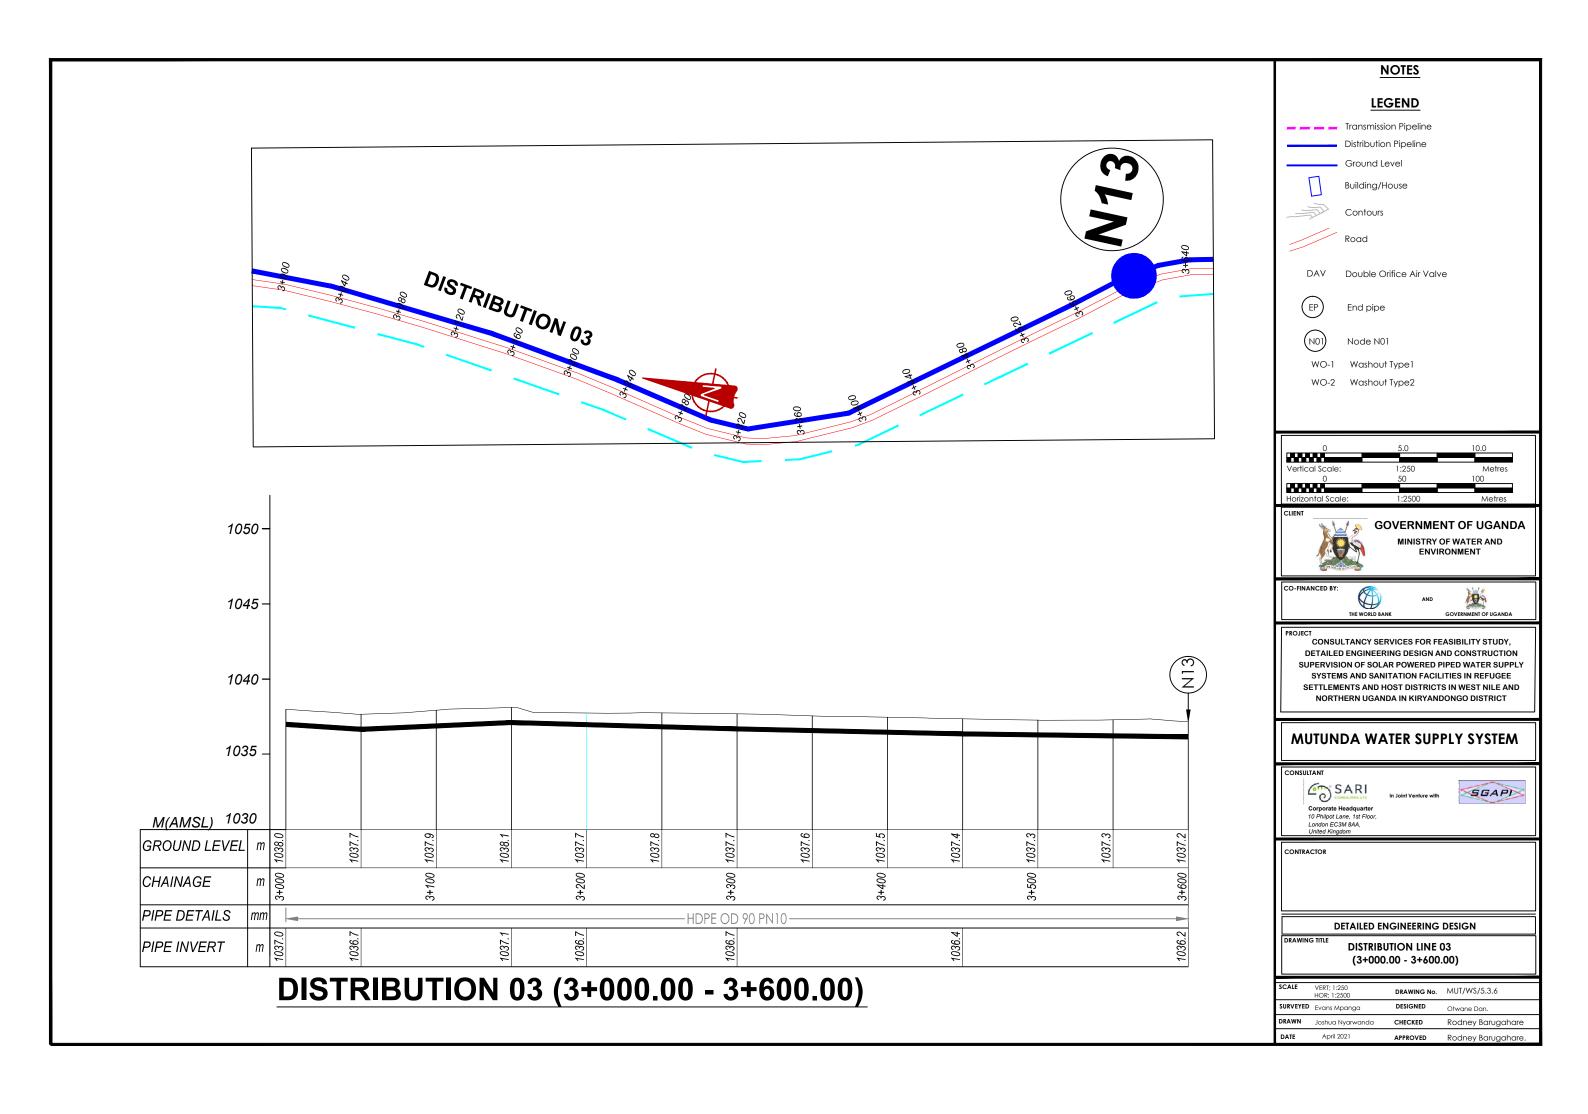


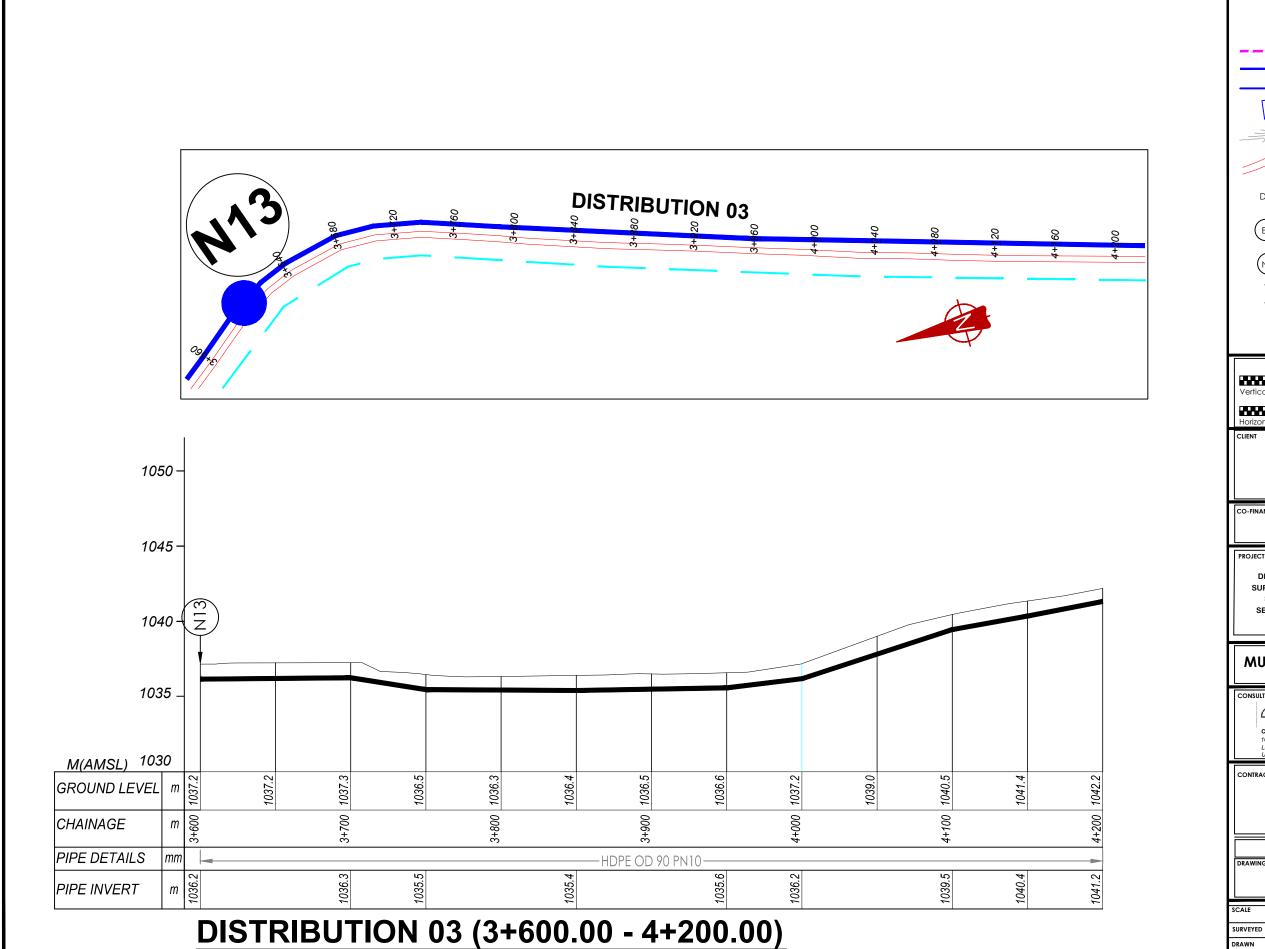

NOTES LEGEND Transmission Pipeline Distribution Pipeline Ground Level Building/House Contours Road DAV Double Orifice Air Valve End pipe Node N01 WO-1 Washout Type 1 WO-2 Washout Type2 **GOVERNMENT OF UGANDA** MINISTRY OF WATER AND ENVIRONMENT CONSULTANCY SERVICES FOR FEASIBILITY STUDY, DETAILED ENGINEERING DESIGN AND CONSTRUCTION SUPERVISION OF SOLAR POWERED PIPED WATER SUPPLY SYSTEMS AND SANITATION FACILITIES IN REFUGEE SETTLEMENTS AND HOST DISTRICTS IN WEST NILE AND NORTHERN UGANDA IN KIRYANDONGO DISTRICT **MUTUNDA WATER SUPPLY SYSTEM** SARI SGAPI Corporate Headquarter 10 Philpot Lane, 1st Floor, London EC3M 8AA, United Kingdom DETAILED ENGINEERING DESIGN **DISTRIBUTION LINE 03** (3+600.00 - 4+200.00)

Rodney Barugahare

CENTER DISTRIBUTION 03 KAWIT TRADING CENTER KAWIT TRADING CENTER

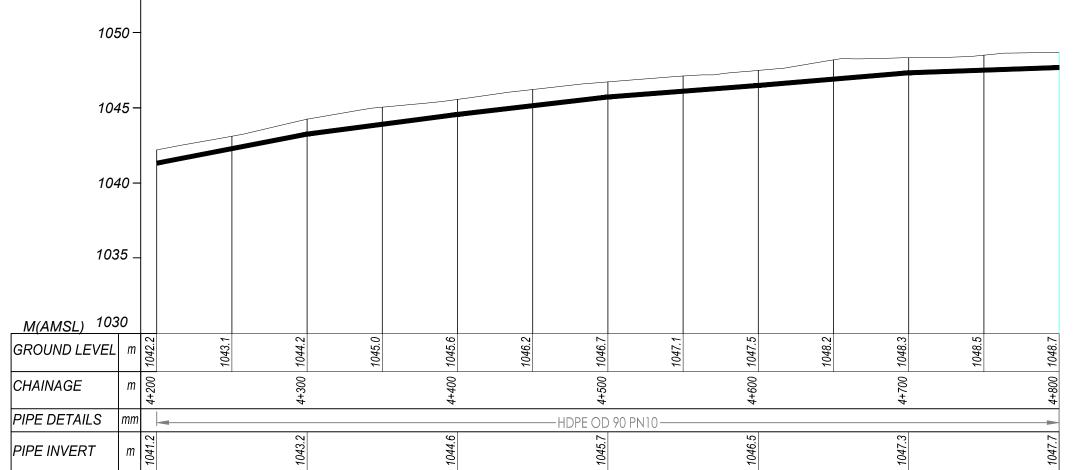

DISTRIBUTION 03 (4+200.00 - 4+800.00)

NOTES LEGEND Transmission Pipeline Distribution Pipeline Ground Level Building/House Contours Road DAV Double Orifice Air Valve End pipe Node N01 WO-1 Washout Type 1 WO-2 Washout Type2 **GOVERNMENT OF UGANDA** MINISTRY OF WATER AND ENVIRONMENT CONSULTANCY SERVICES FOR FEASIBILITY STUDY, DETAILED ENGINEERING DESIGN AND CONSTRUCTION SUPERVISION OF SOLAR POWERED PIPED WATER SUPPLY SYSTEMS AND SANITATION FACILITIES IN REFUGEE SETTLEMENTS AND HOST DISTRICTS IN WEST NILE AND NORTHERN UGANDA IN KIRYANDONGO DISTRICT **MUTUNDA WATER SUPPLY SYSTEM** SARI COMBULTING LTD SGAPI Corporate Headquarter 10 Philpot Lane, 1st Floor, London EC3M 8AA, United Kingdom

DETAILED ENGINEERING DESIGN


DISTRIBUTION LINE 03


Joshua Nyarwanda

(4+200.00 - 4+800.00)

CHECKED

Rodney Barugahare

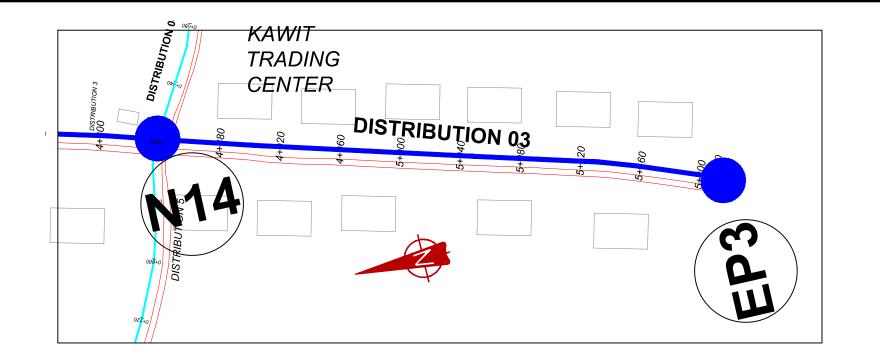

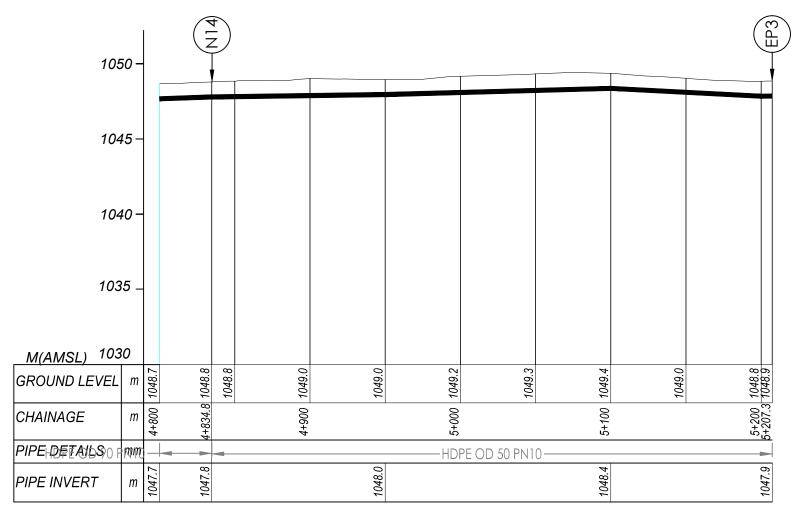

DISTRIBUTION 03 (4+200.00 - 5+207.30)



LEGEND

Transmission Pipeline
Distribution Pipeline



Ground Level
Building/House



Contours



DAV Double Orifice Air Valve



End pipe


Road



Node N01

WO-2 Washout Type2

WO-1 Washout Type 1

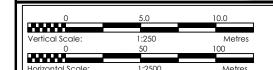



GOVERNMENT OF UGANDA MINISTRY OF WATER AND ENVIRONMENT

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PROJECT

CONSULTANCY SERVICES FOR FEASIBILITY STUDY,
DETAILED ENGINEERING DESIGN AND CONSTRUCTION
SUPERVISION OF SOLAR POWERED PIPED WATER SUPPLY
SYSTEMS AND SANITATION FACILITIES IN REFUGEE
SETTLEMENTS AND HOST DISTRICTS IN WEST NILE AND
NORTHERN UGANDA IN KIRYANDONGO DISTRICT

MUTUNDA WATER SUPPLY SYSTEM

CONSULTANT

SARI

Comporate Headquarter
10 Philipot Lane, 1st Floor,
London EC3M 8AA,
United Kingdom

In Joint Venture with





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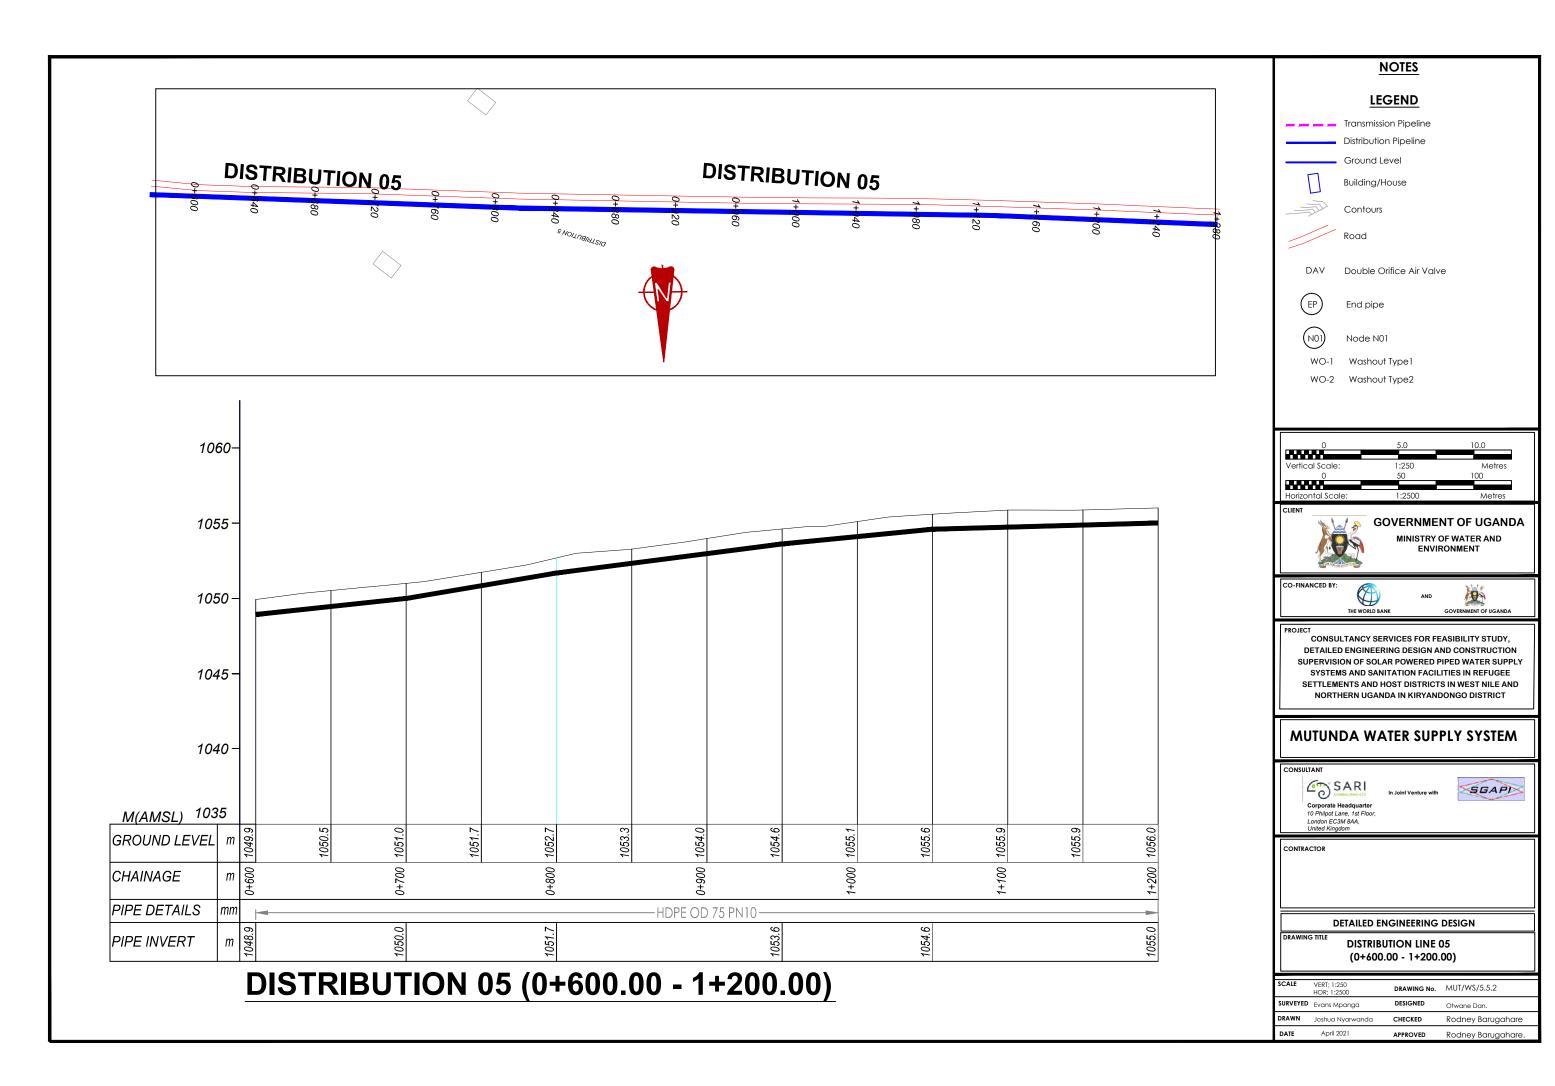
DETAILED ENGINEERING DESIGN


DISTRIBUTION LINE 03 (4+200.00 - 5+207.30)


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SURVEYED	Evans Mpanga	DESIGNED	Otwane Dan.
DRAWN	Joshua Nyarwanda	CHECKED	Rodney Barugahare
DATE	April 2021	APPROVED	Rodney Barugahare.




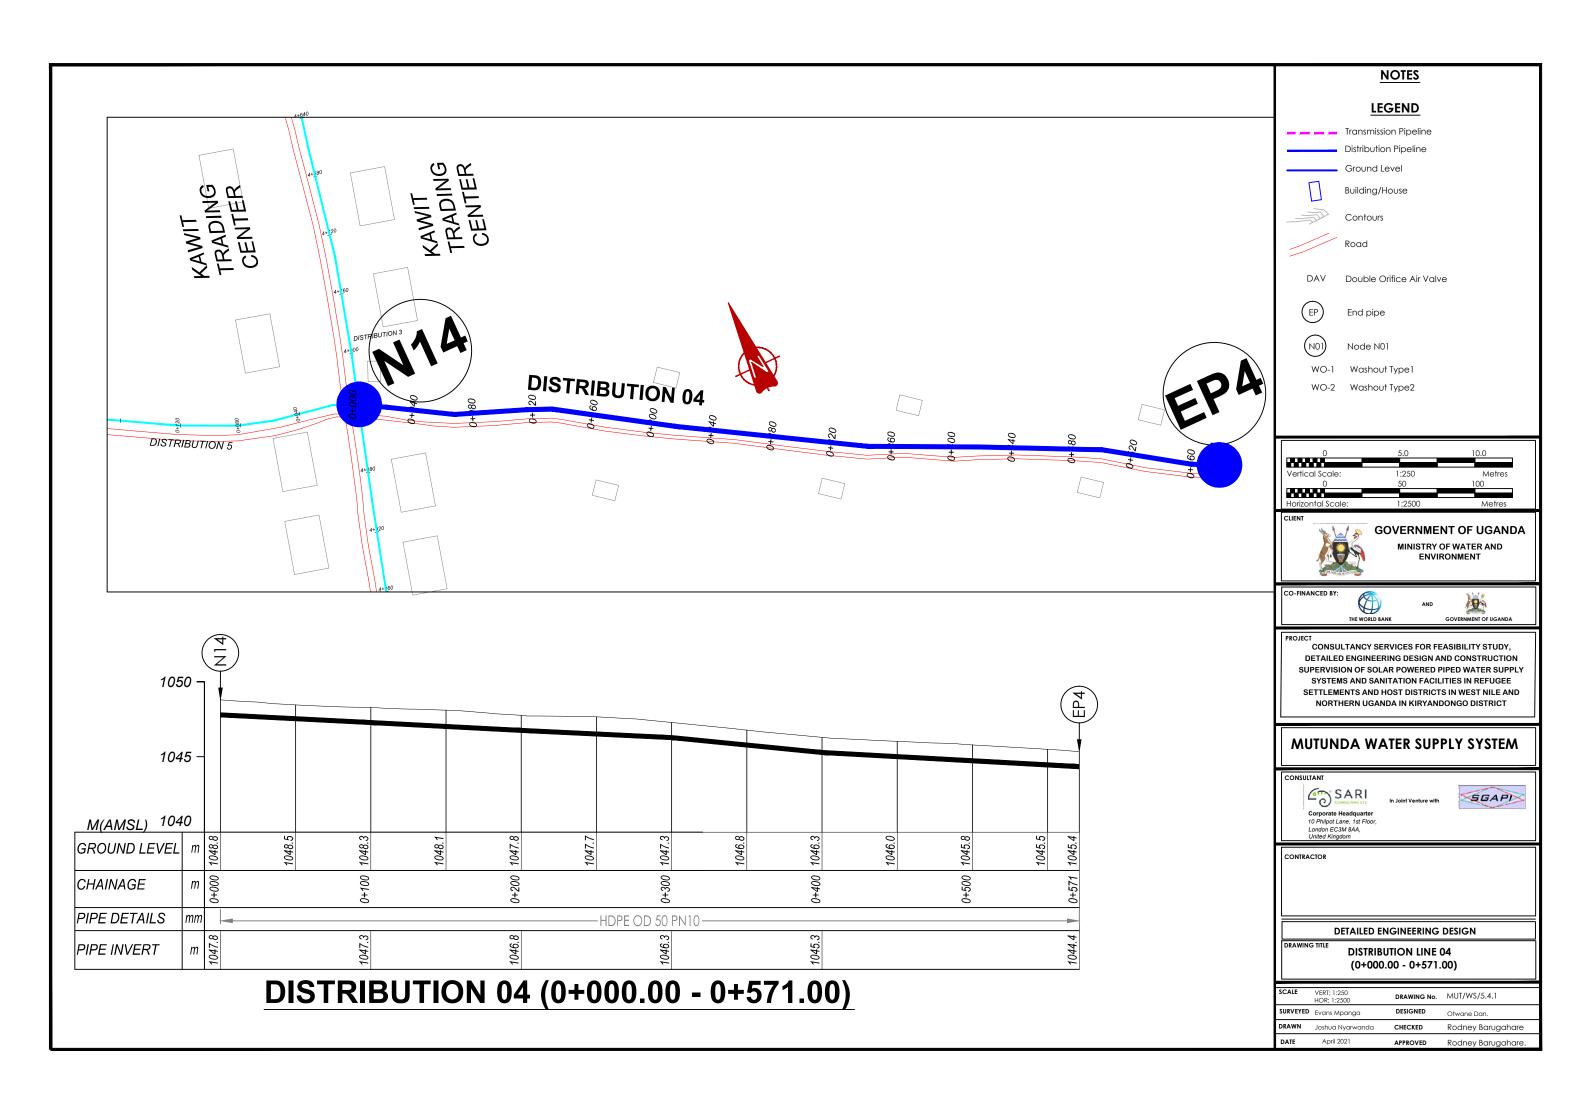


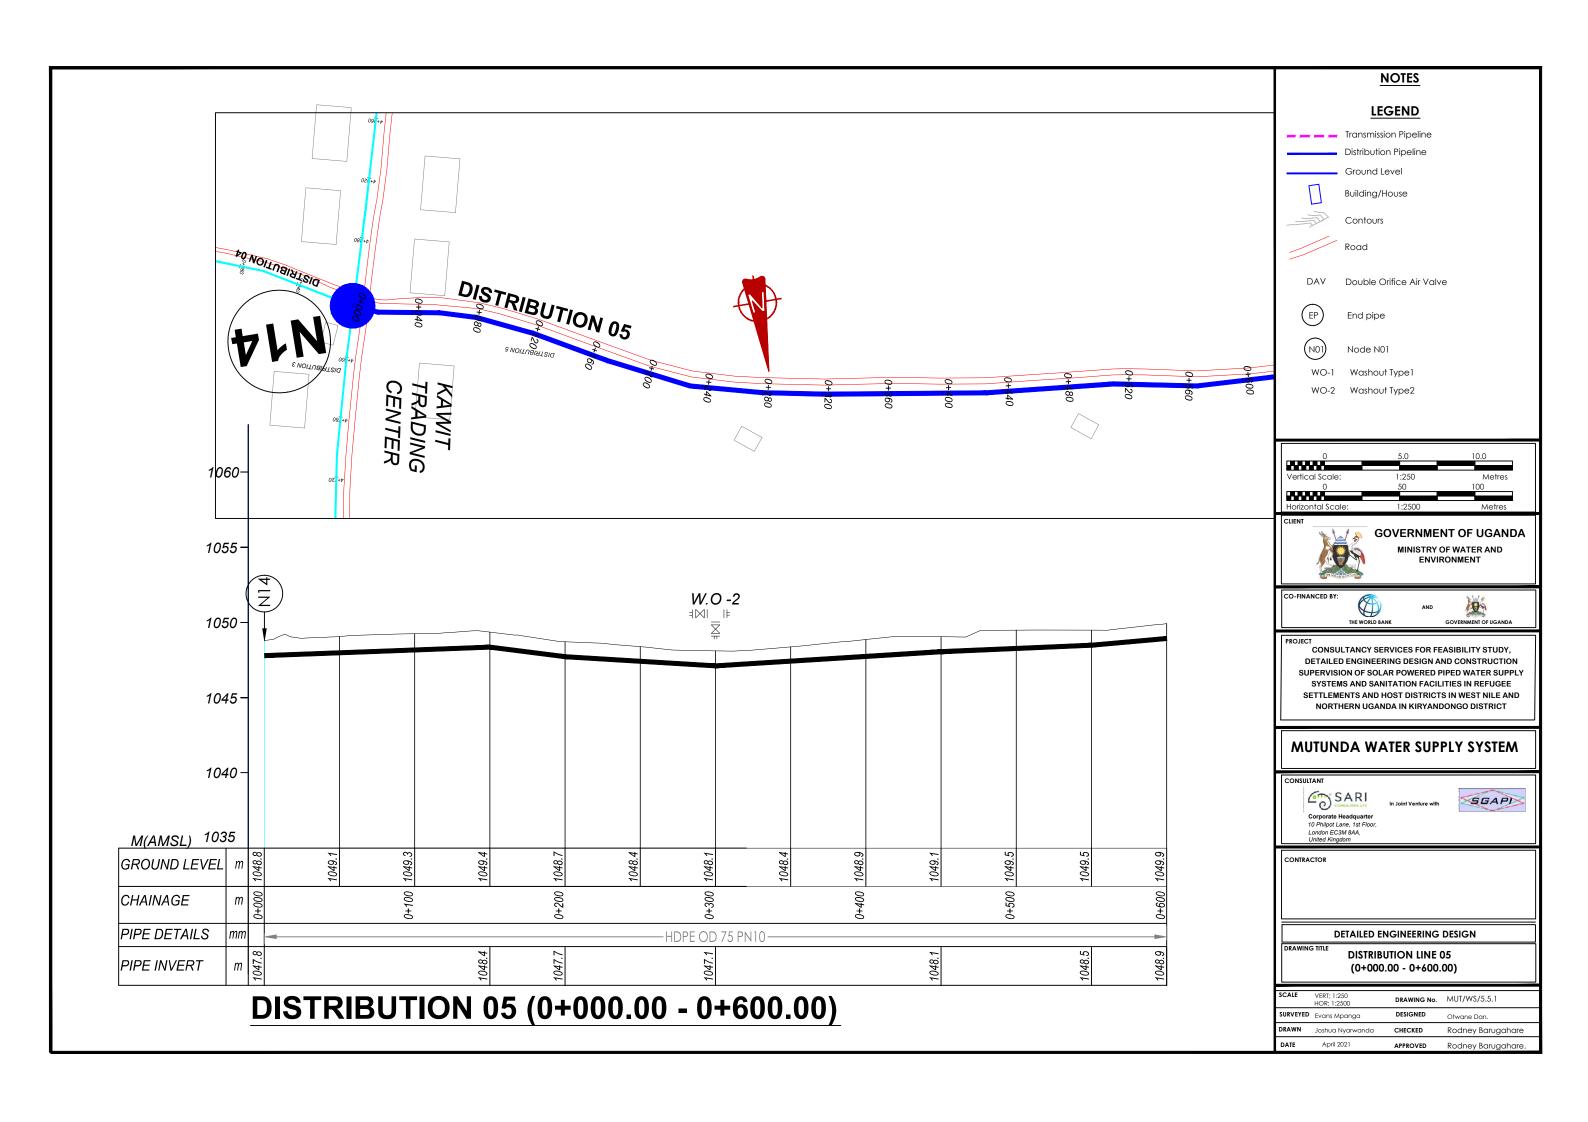


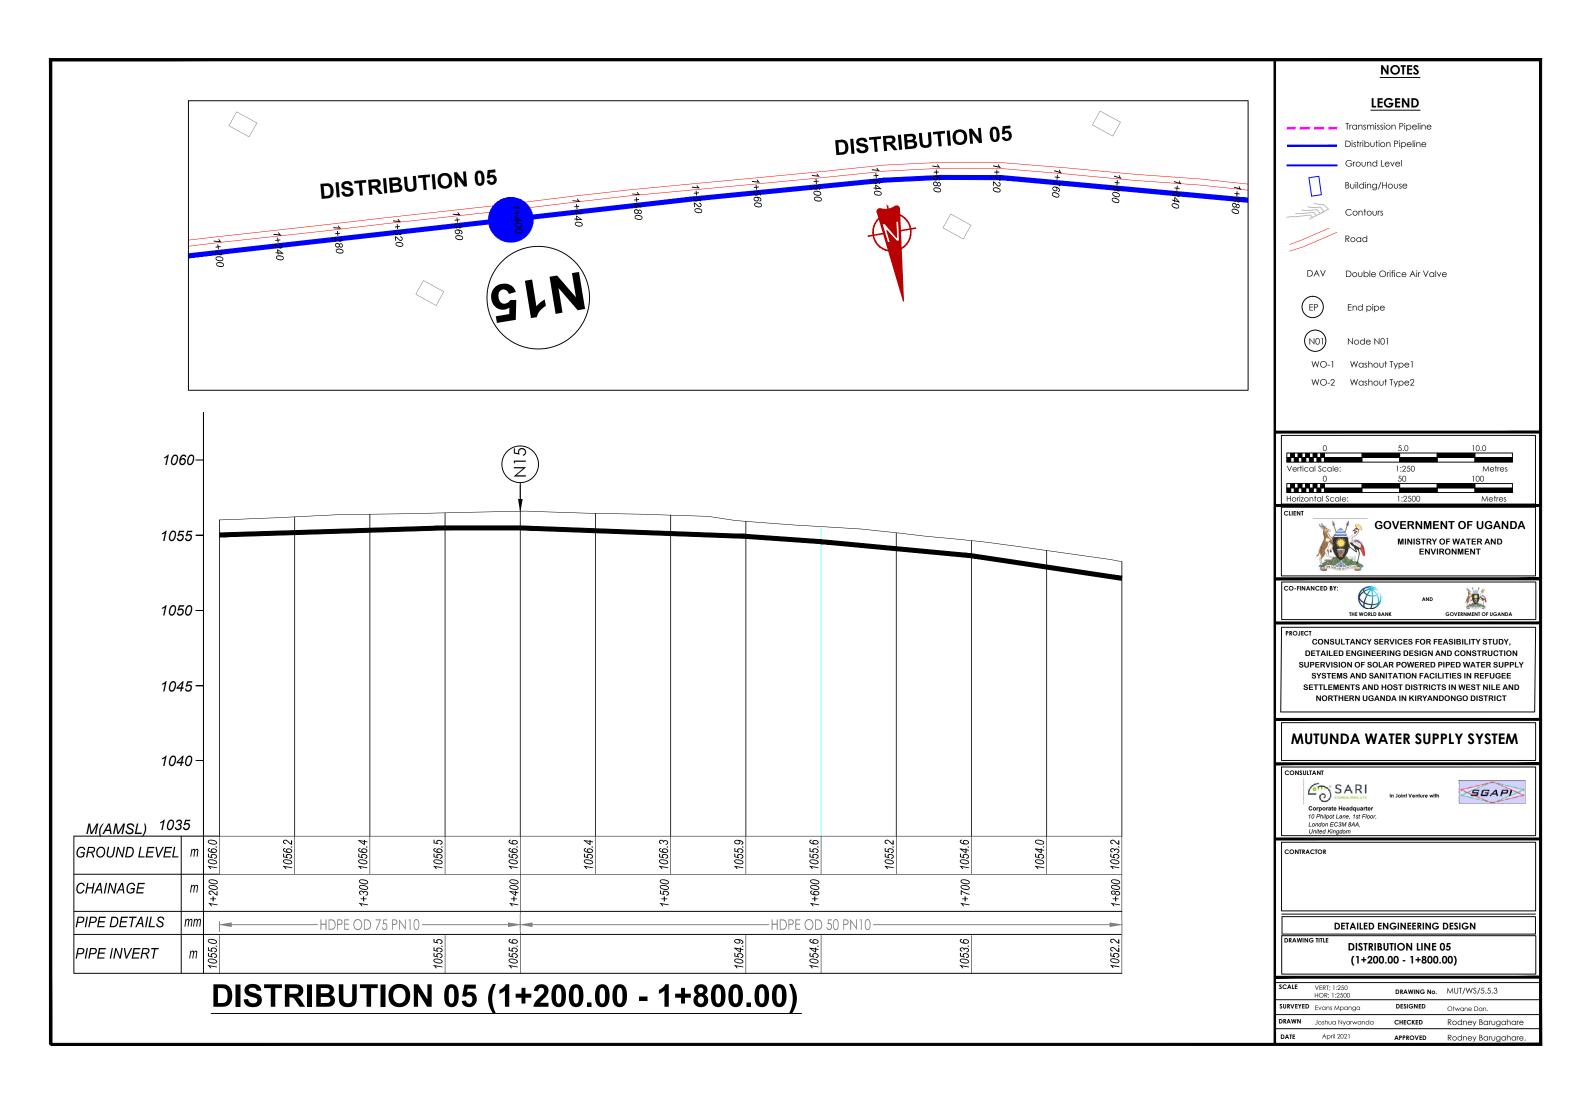


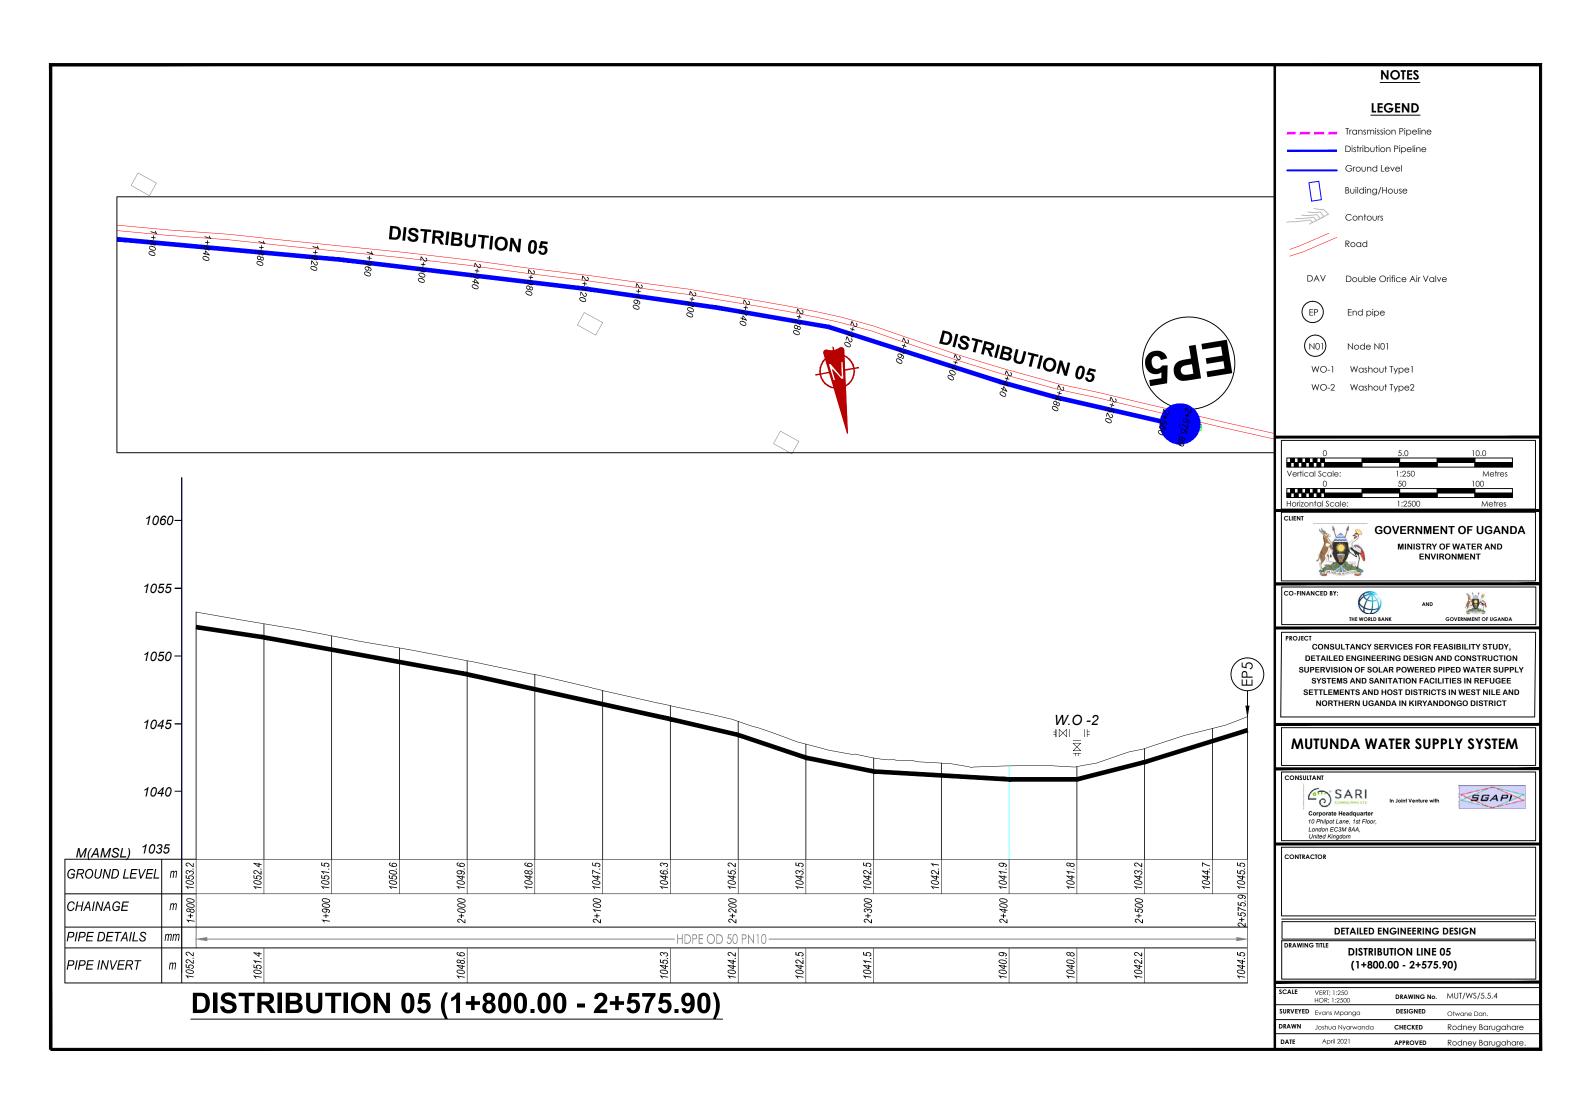


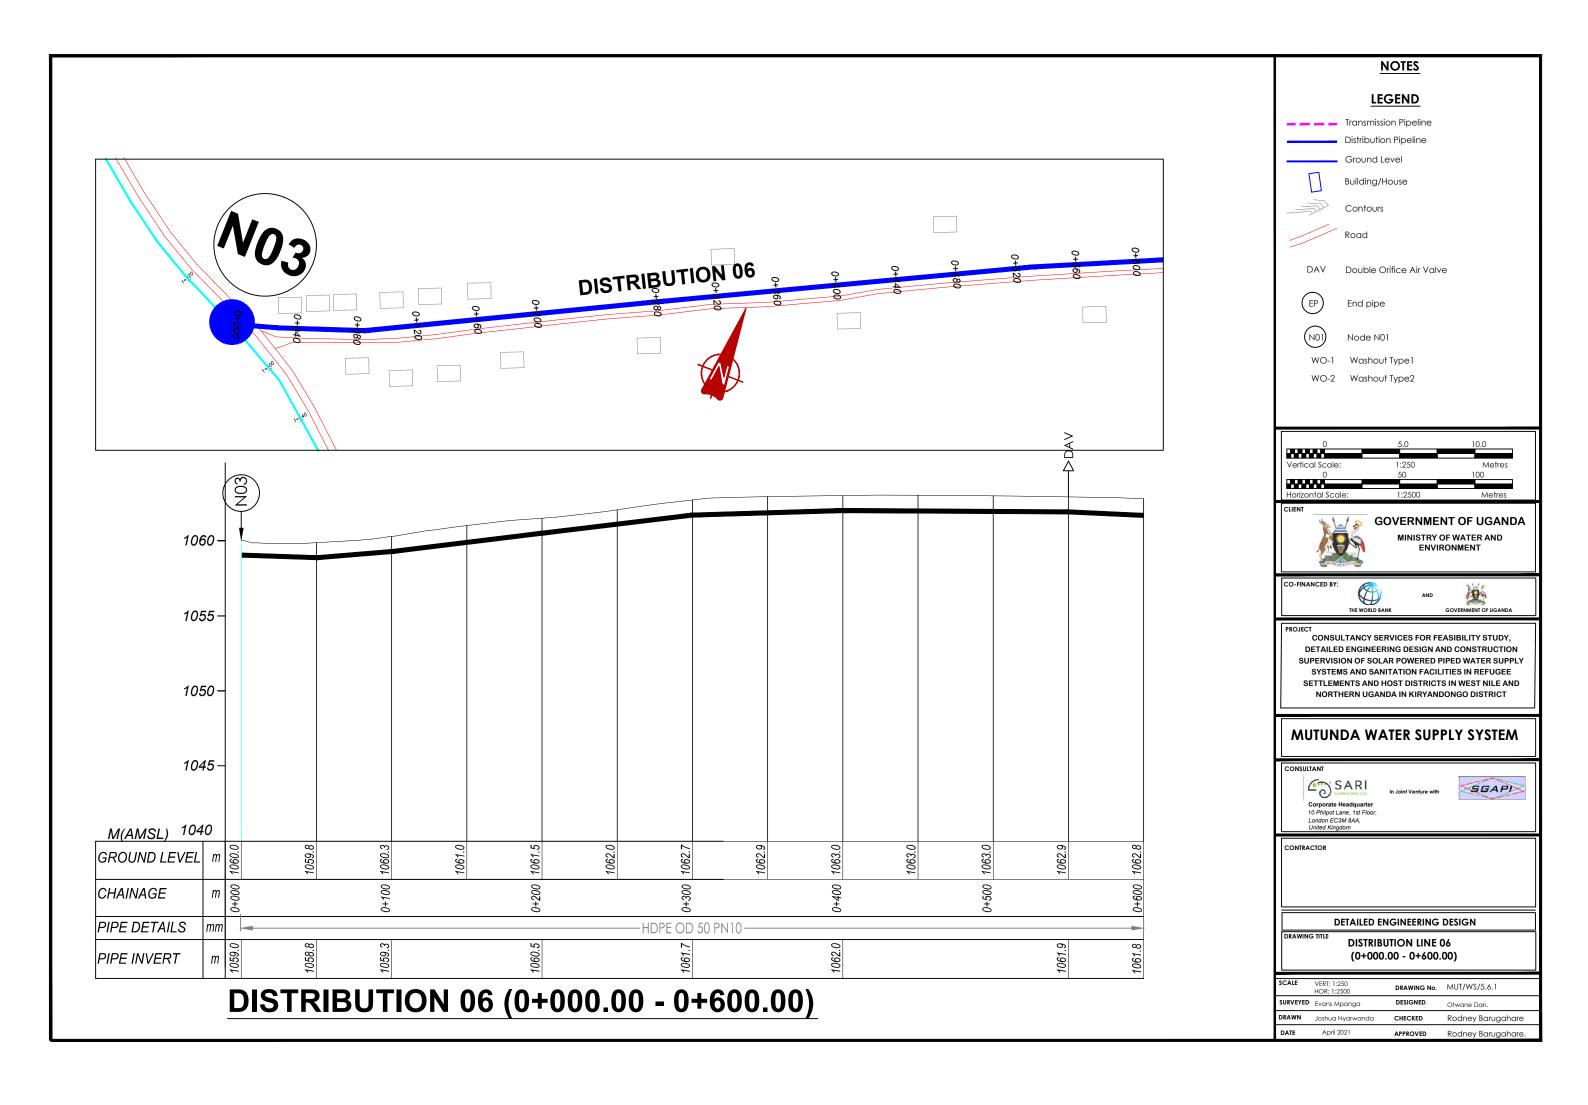

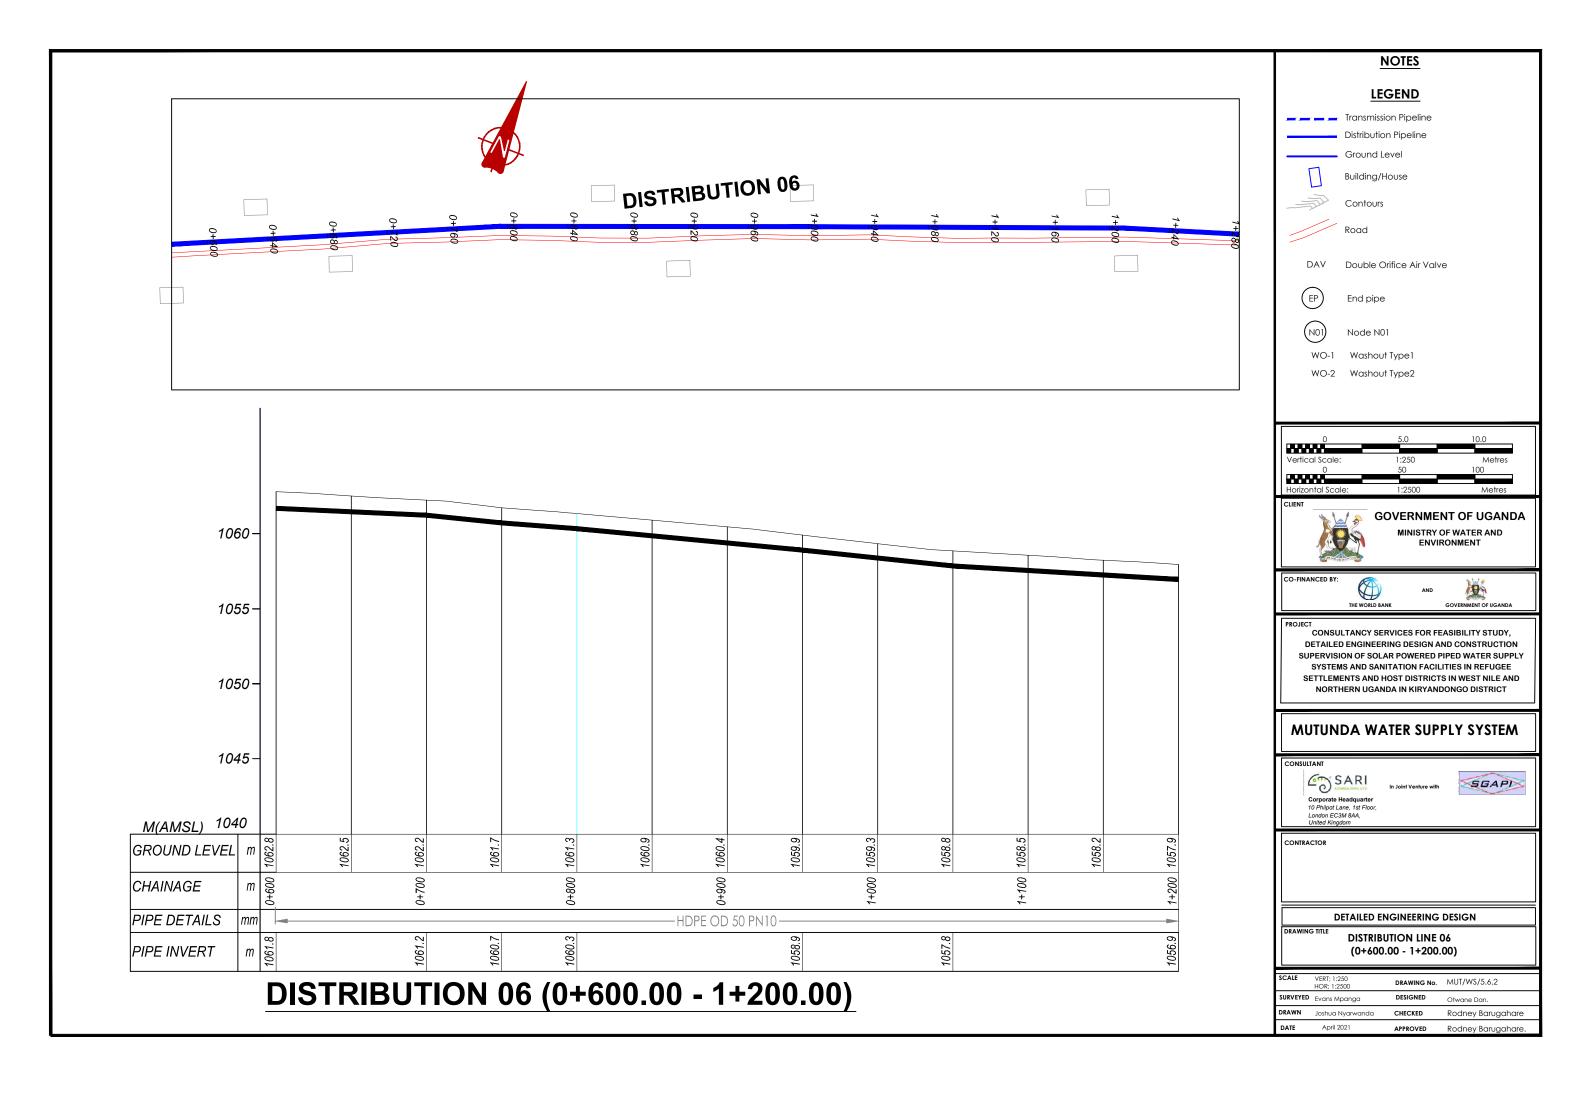


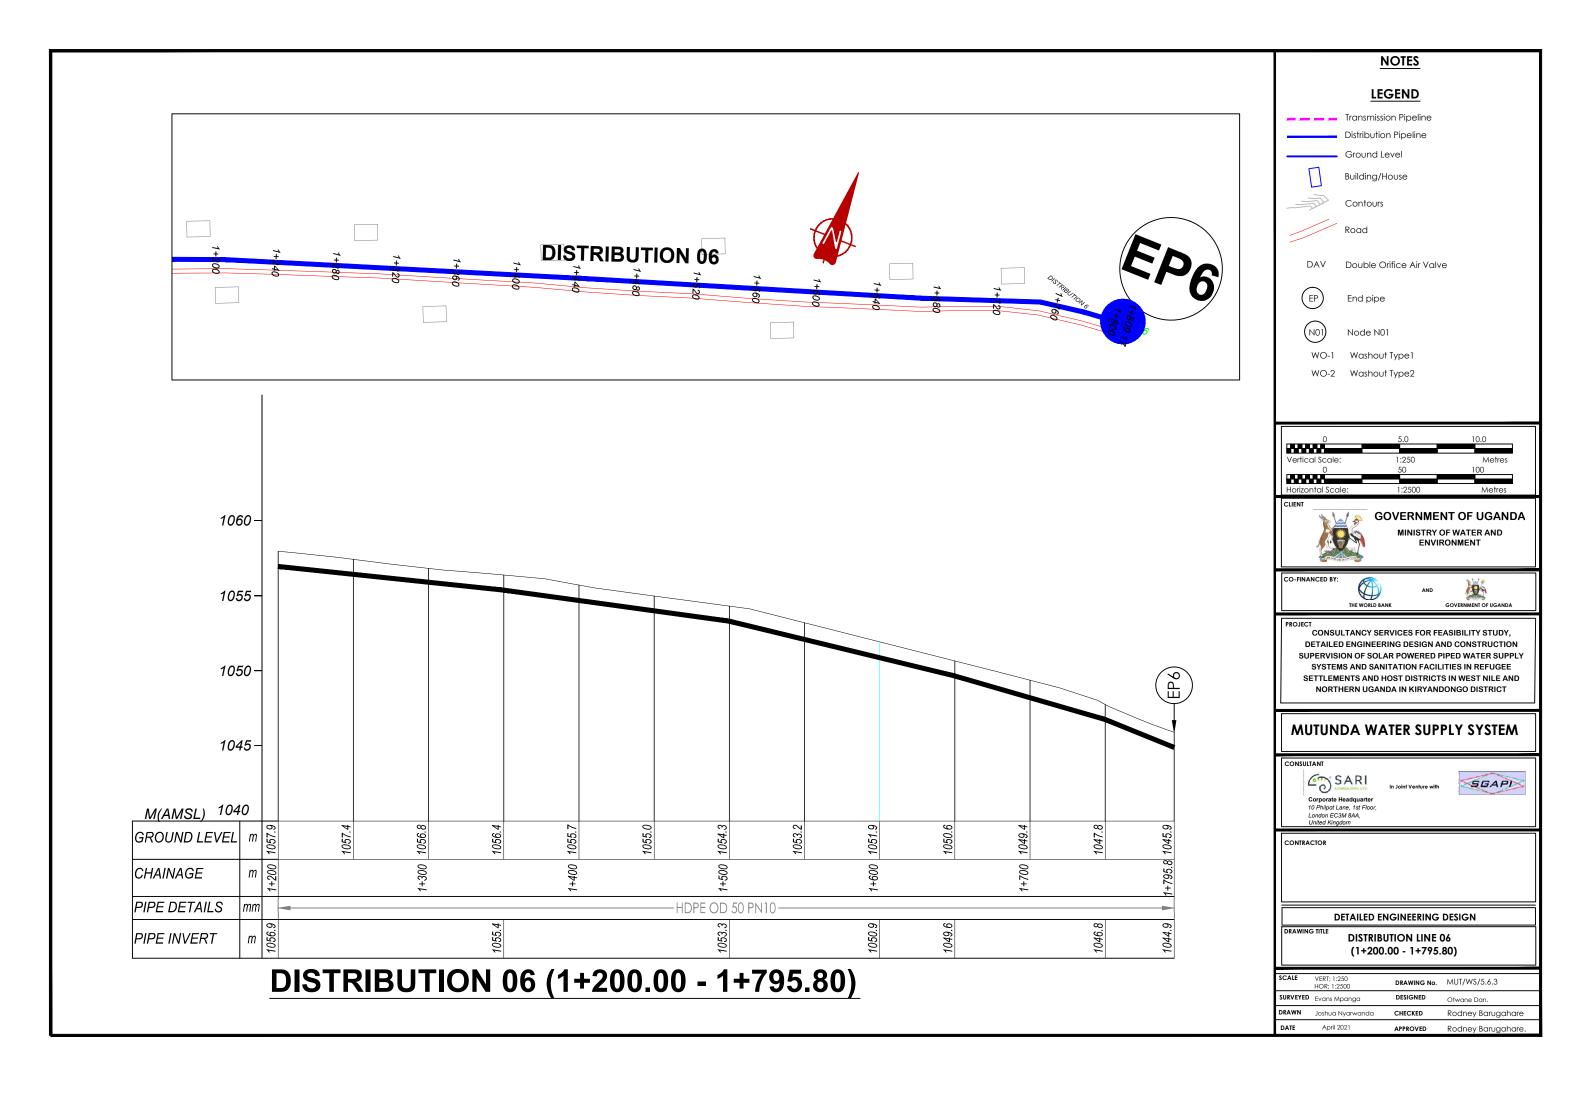

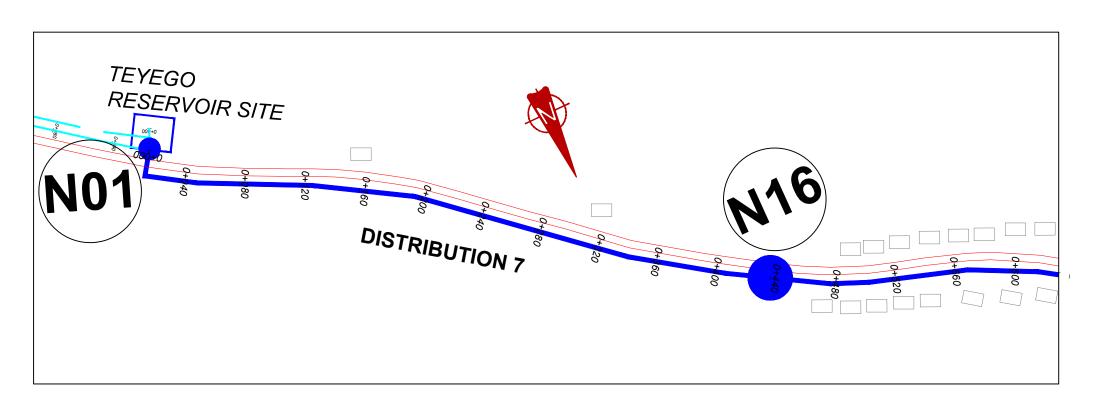


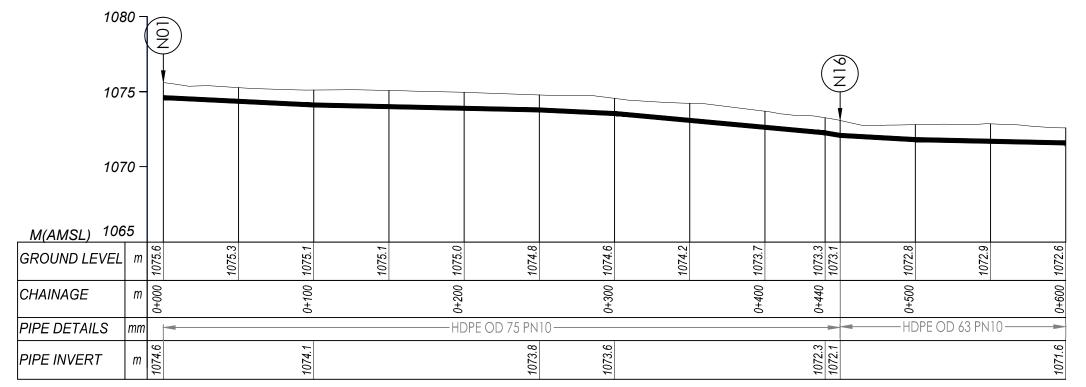


DISTRIBUTION 07 (0+000.00 - 0+600.00)

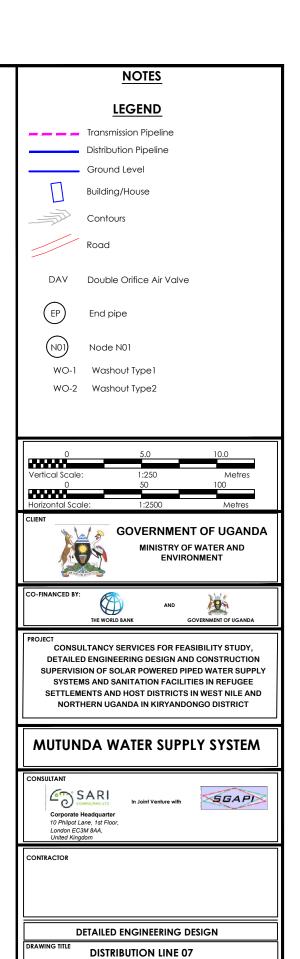

(0+000.00 - 0+600.00)

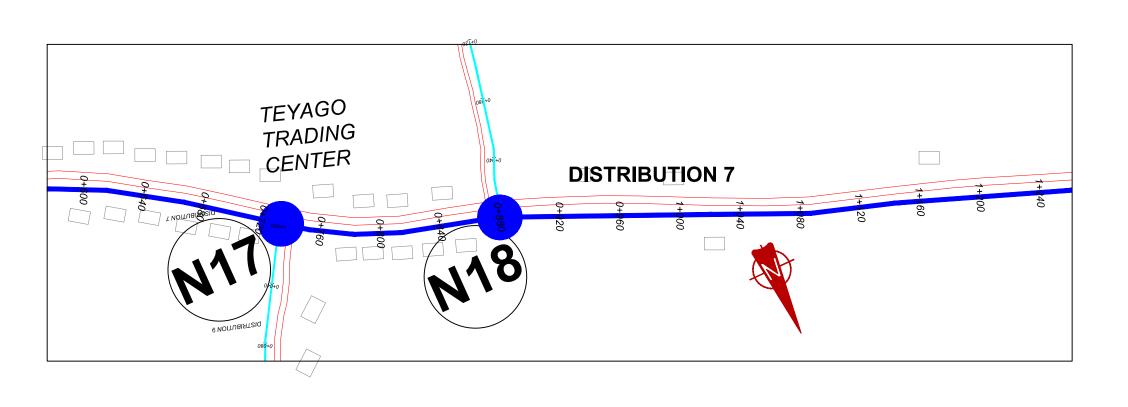

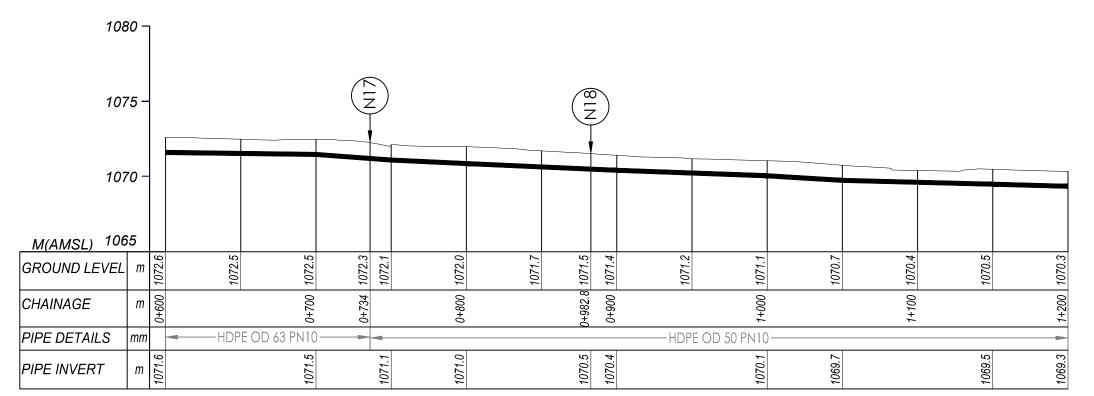

DISTRIBUTION 07 (0+600.00 - 1+200.00)

NOTES LEGEND Transmission Pipeline Distribution Pipeline Ground Level Building/House Contours Road DAV Double Orifice Air Valve End pipe Node N01 WO-1 Washout Type 1 WO-2 Washout Type2 **GOVERNMENT OF UGANDA** MINISTRY OF WATER AND ENVIRONMENT CONSULTANCY SERVICES FOR FEASIBILITY STUDY, DETAILED ENGINEERING DESIGN AND CONSTRUCTION SUPERVISION OF SOLAR POWERED PIPED WATER SUPPLY SYSTEMS AND SANITATION FACILITIES IN REFUGEE SETTLEMENTS AND HOST DISTRICTS IN WEST NILE AND NORTHERN UGANDA IN KIRYANDONGO DISTRICT

MUTUNDA WATER SUPPLY SYSTEM

Corporate Headquarter
10 Philipot Lane, 1st Floor,
London EC3M 8AA,
United Kingdom


In Joint Venture with




DETAILED ENGINEERING DESIGN

DISTRIBUTION LINE 07 (0+600.00 - 1+200.00)


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SURVEYED	Evans Mpanga	DESIGNED	Otwane Dan.
DRAWN	Joshua Nyarwanda	CHECKED	Rodney Barugahare
DATE	April 2021	APPROVED	Rodney Barugahare.

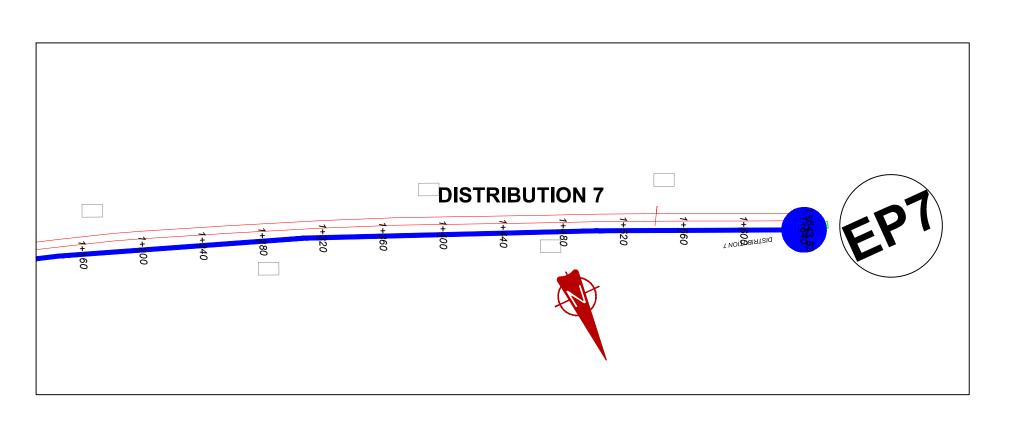


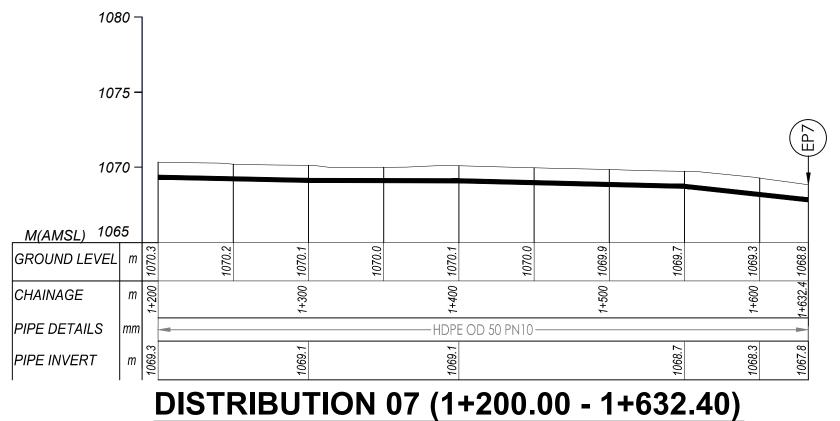

NOTES LEGEND Transmission Pipeline Distribution Pipeline Ground Level Building/House Contours Road DAV Double Orifice Air Valve End pipe Node N01 WO-1 Washout Type 1 WO-2 Washout Type2 **GOVERNMENT OF UGANDA** MINISTRY OF WATER AND ENVIRONMENT CONSULTANCY SERVICES FOR FEASIBILITY STUDY, DETAILED ENGINEERING DESIGN AND CONSTRUCTION SUPERVISION OF SOLAR POWERED PIPED WATER SUPPLY SYSTEMS AND SANITATION FACILITIES IN REFUGEE SETTLEMENTS AND HOST DISTRICTS IN WEST NILE AND NORTHERN UGANDA IN KIRYANDONGO DISTRICT **MUTUNDA WATER SUPPLY SYSTEM** SARI COMBULTING LTD SGAPI Corporate Headquarter 10 Philpot Lane, 1st Floor, London EC3M 8AA, United Kingdom DETAILED ENGINEERING DESIGN DISTRIBUTION LINE 07

(1+200.00 - 1+632.40)

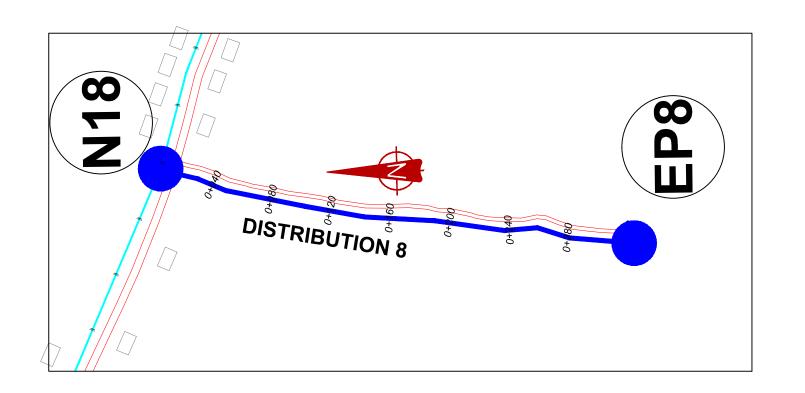

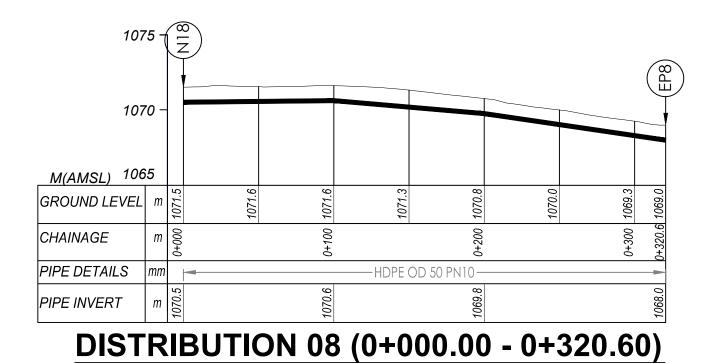



NOTES LEGEND Transmission Pipeline Distribution Pipeline Ground Level Building/House Contours Road DAV Double Orifice Air Valve End pipe Node N01 WO-1 Washout Type 1 WO-2 Washout Type2 **GOVERNMENT OF UGANDA** MINISTRY OF WATER AND ENVIRONMENT CONSULTANCY SERVICES FOR FEASIBILITY STUDY, DETAILED ENGINEERING DESIGN AND CONSTRUCTION SUPERVISION OF SOLAR POWERED PIPED WATER SUPPLY SYSTEMS AND SANITATION FACILITIES IN REFUGEE SETTLEMENTS AND HOST DISTRICTS IN WEST NILE AND NORTHERN UGANDA IN KIRYANDONGO DISTRICT **MUTUNDA WATER SUPPLY SYSTEM** SARI SGAPI Corporate Headquarter 10 Philpot Lane, 1st Floor, London EC3M 8AA, United Kingdom

DETAILED ENGINEERING DESIGN


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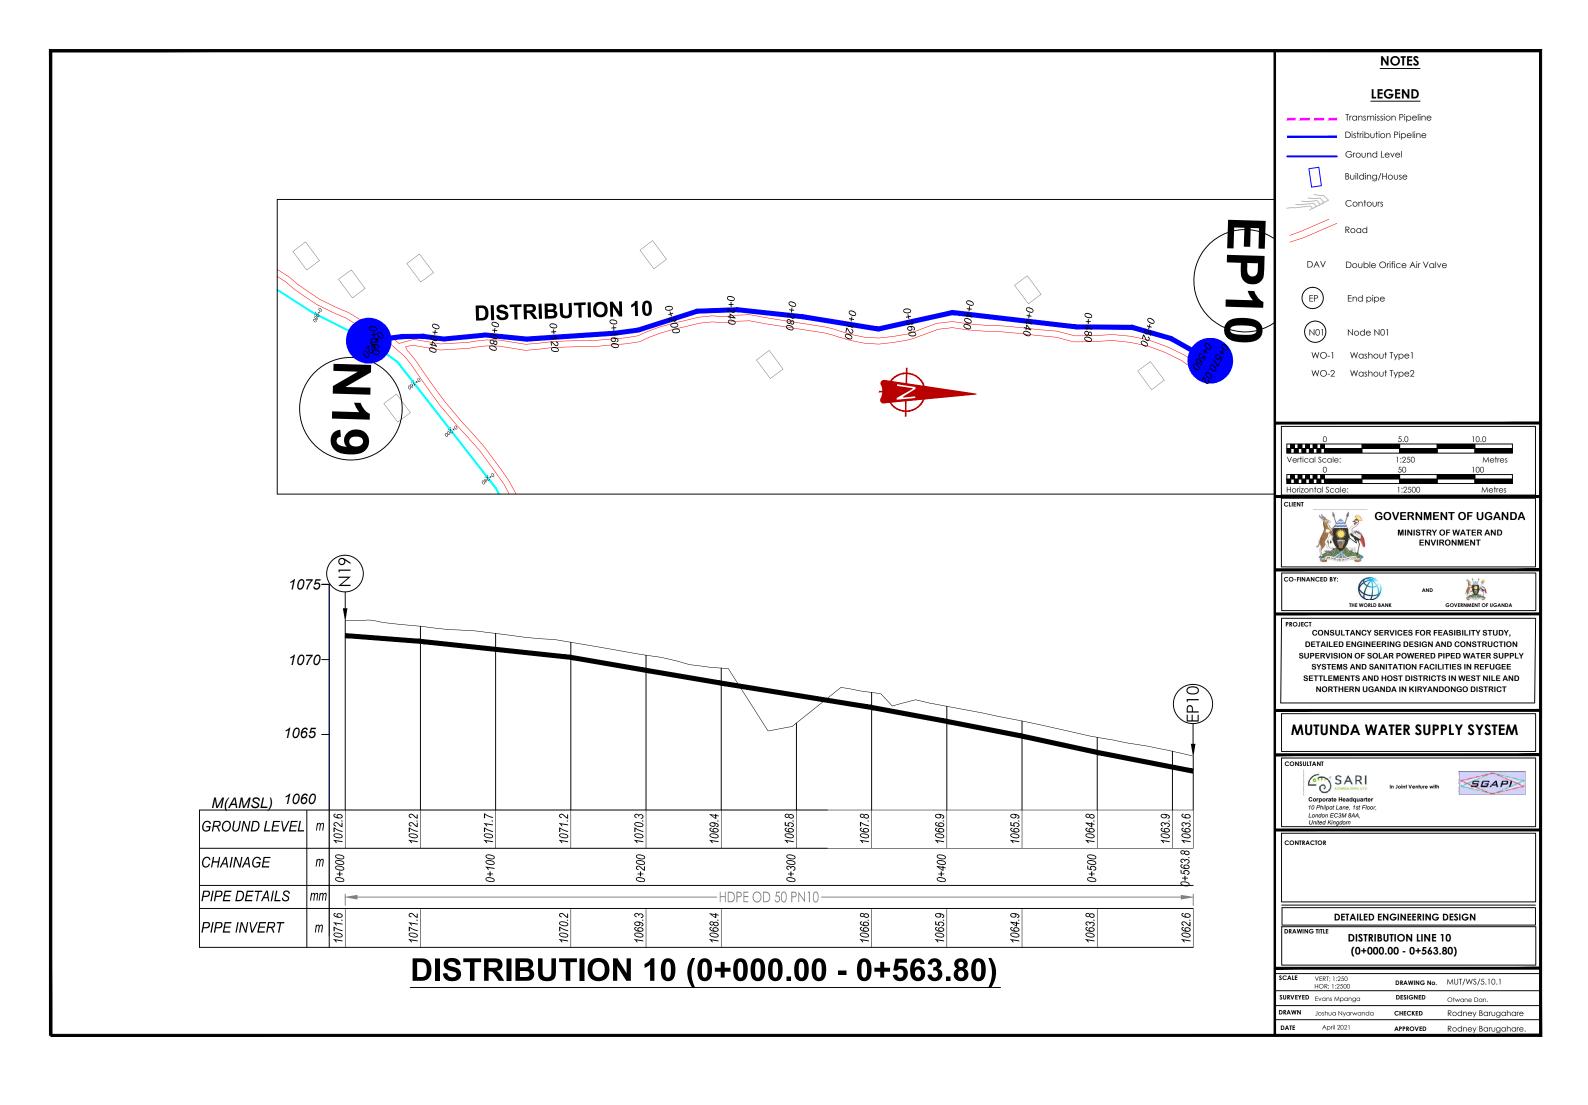
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SURVEYED	Evans Mpanga	DESIGNED	Otwane Dan.
DRAWN	Joshua Nyarwanda	CHECKED	Rodney Barugahare
DATE	April 2021	APPROVED	Rodney Barugahare.




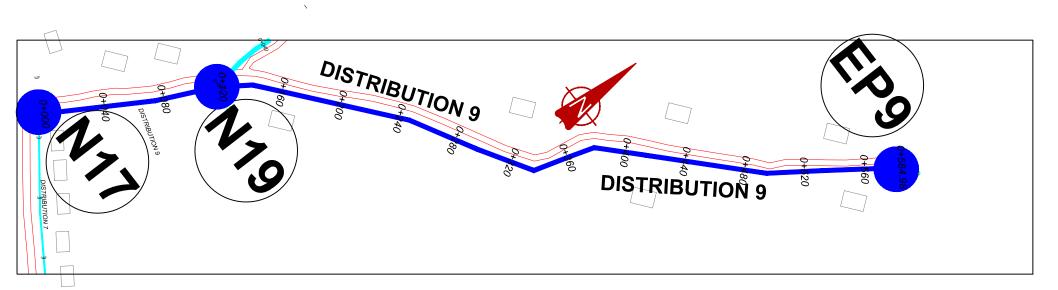


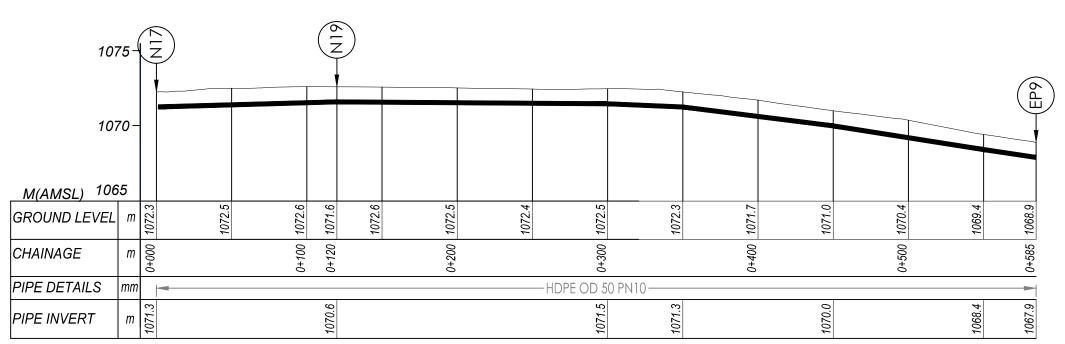DISTRIBUTION 09 (0+000.00 - 0+585.00)



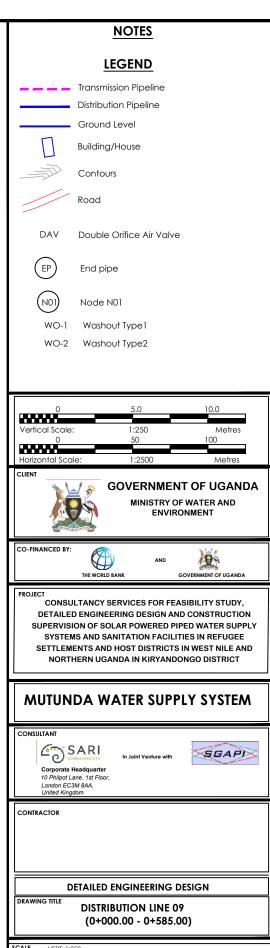

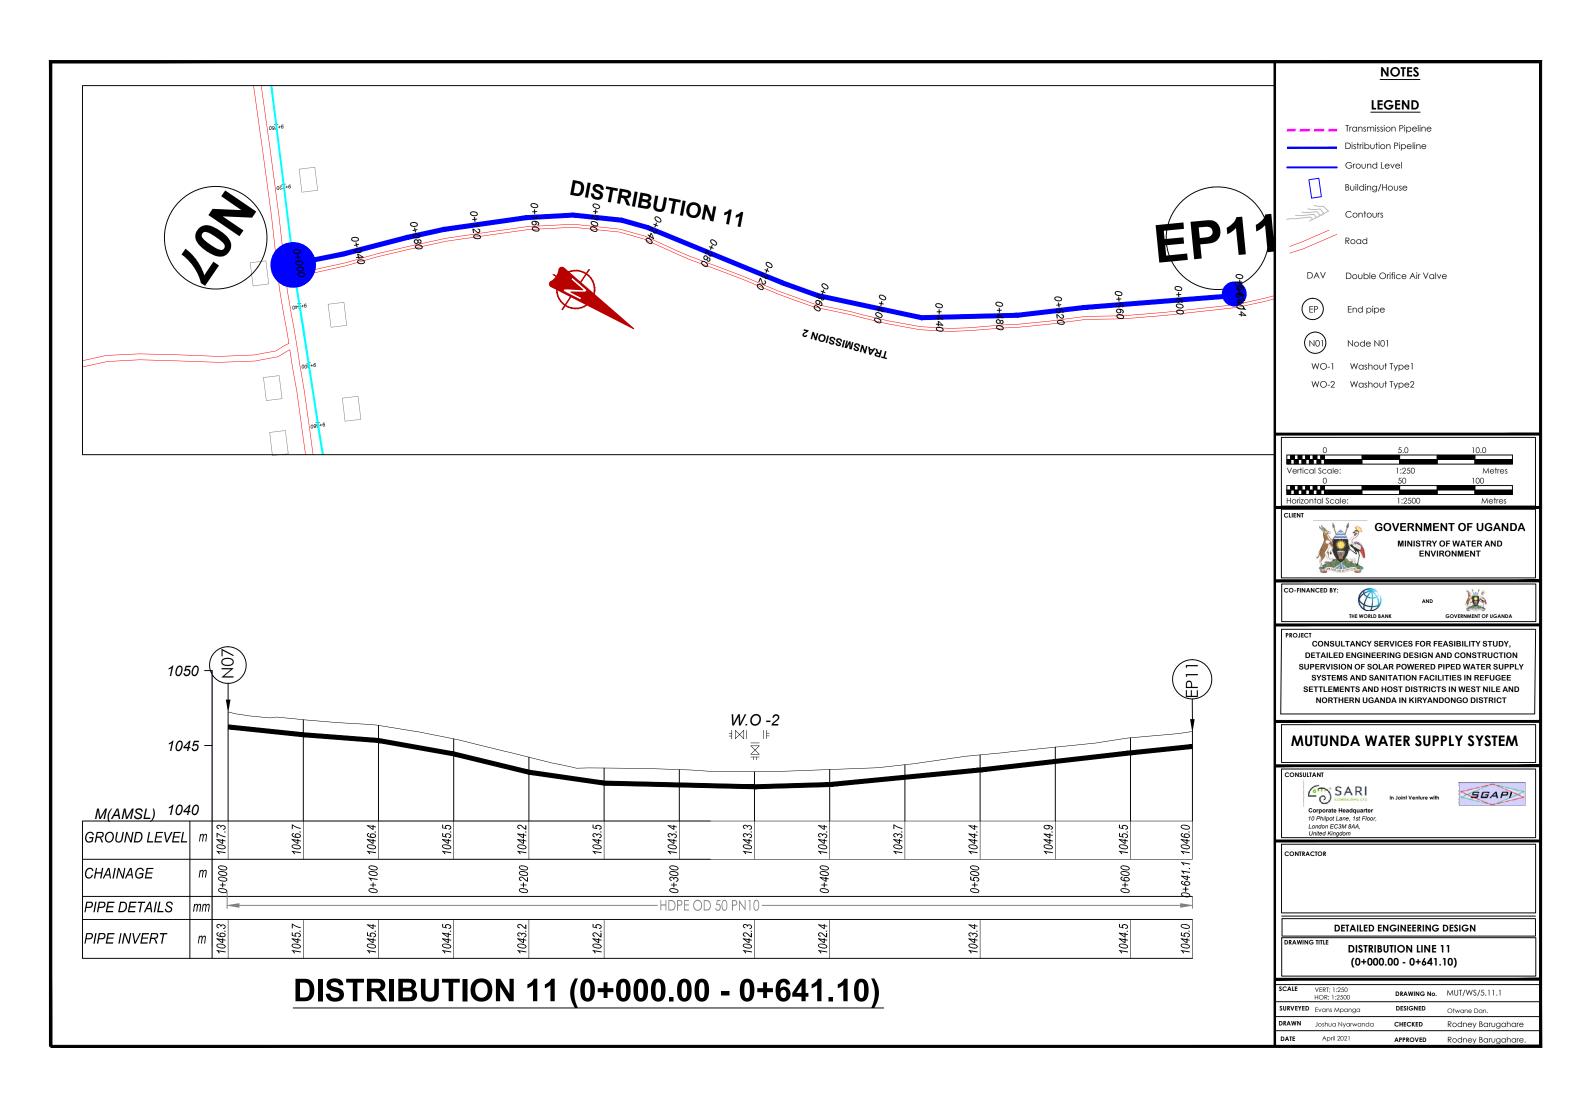

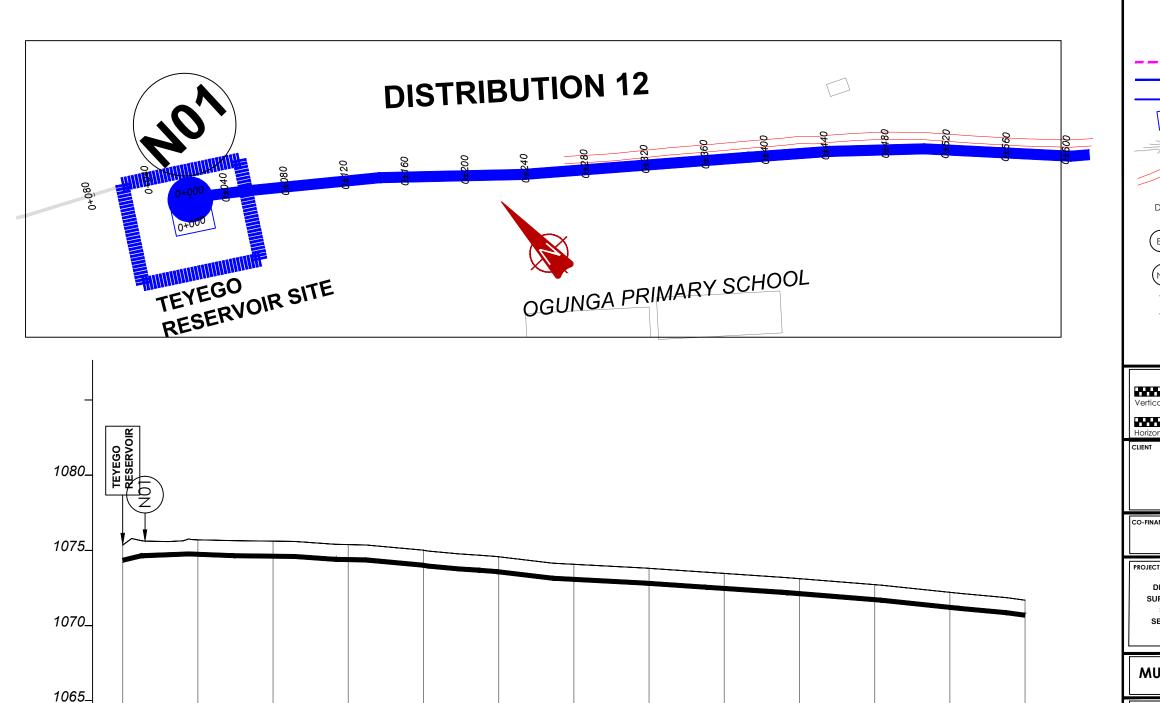

-HDPE OD 75 PN10-

DISTRIBUTION 12 (0+000.00 - 0+600.00)


M(AMSL) 1060 GROUND LEVEL m

CHAINAGE

PIPE DETAILS

PIPE INVERT

LEGEND Transmission Pipeline Distribution Pipeline Ground Level Building/House Contours Road DAV Double Orifice Air Valve EP End pipe NOI) Node NO1 WO-1 Washout Type1 WO-2 Washout Type2

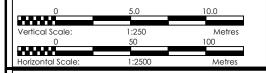

GOVERNMENT OF UGANDA MINISTRY OF WATER AND ENVIRONMENT

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PROJECT
CONSULTANCY SERVICES FOR FEASIBILITY STUDY,
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SUPERVISION OF SOLAR POWERED PIPED WATER SUPPLY
SYSTEMS AND SANITATION FACILITIES IN REFUGEE
SETTLEMENTS AND HOST DISTRICTS IN WEST NILE AND
NORTHERN UGANDA IN KIRYANDONGO DISTRICT

MUTUNDA WATER SUPPLY SYSTEM

Corporate Headquarter
10 Philipot Lane, 1st Floor,
London EC3M 8AA,
United Kingdom

n Joint Venture with





CONTRACTO

DETAILED ENGINEERING DESIGN

DISTRIBUTION LINE 12 (0+000.00 - 0+600.00)

SCALE	VERT; 1:250 HOR; 1:2500	DRAWING No.	MUT/WS/5.12.1
SURVEYED	Evans Mpanga	DESIGNED	Otwane Dan.
DRAWN	Joshua Nyarwanda	CHECKED	Rodney Barugahare
DATE	April 2021	APPROVED	Rodney Barugahare.

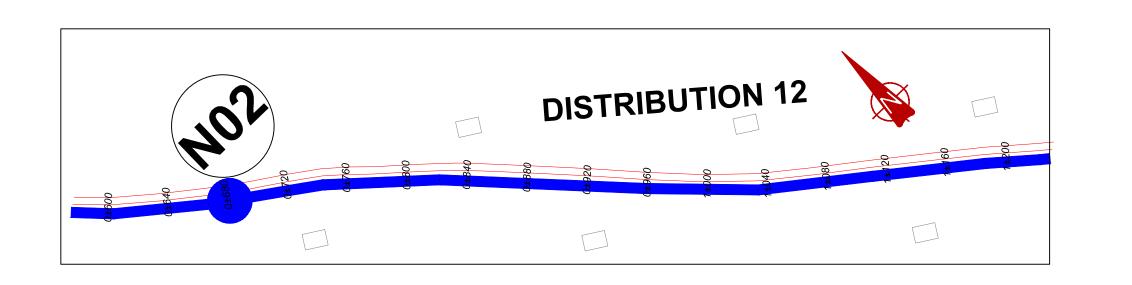

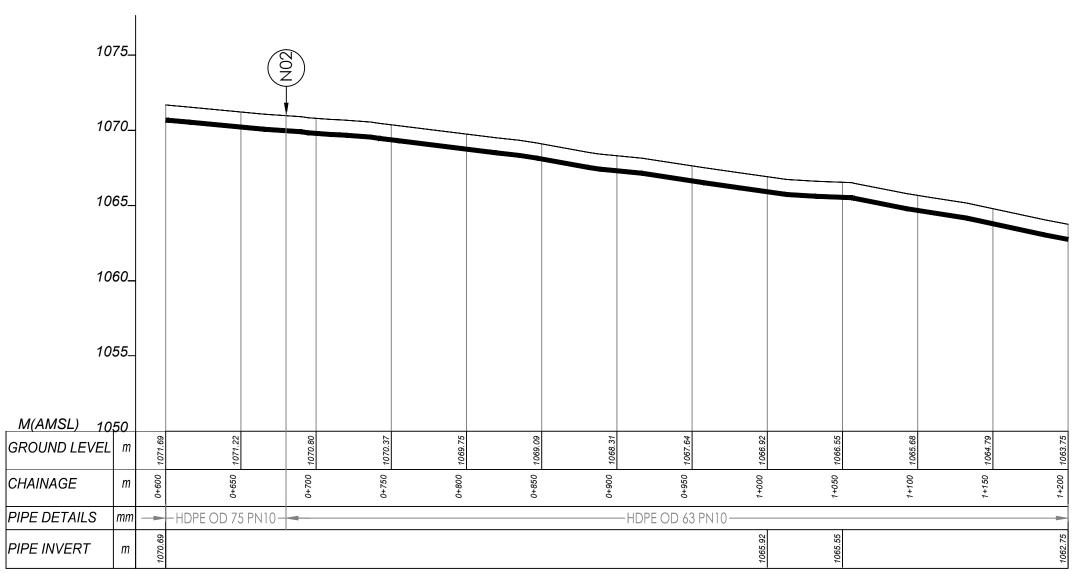

DISTRIBUTION 12 (0+600.00 - 1+200.00)

1080

NOTES

LEGEND

Transmission Pipeline
Distribution Pipeline



Ground Level
Building/House



Contours

Road



DAV Double Orifice Air Valve




End pipe



Node N01

WO-1 Washout Type 1
WO-2 Washout Type 2

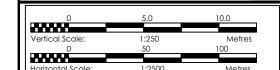



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SETTLEMENTS AND HOST DISTRICTS IN WEST NILE AND
NORTHERN UGANDA IN KIRYANDONGO DISTRICT

MUTUNDA WATER SUPPLY SYSTEM

Corporate Headquarter
10 Philipot Lane, 1st Floor,
London EC3M 8AA,
United Kingdom

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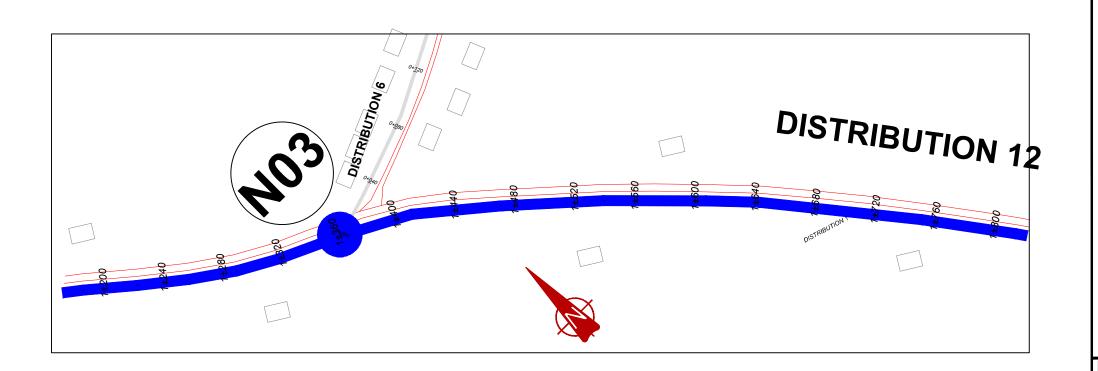



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DETAILED ENGINEERING DESIGN

DISTRIBUTION LINE 12 (0+600.00 - 1+200.00)


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SURVEYED	Evans Mpanga	DESIGNED	Otwane Dan.
DRAWN	Joshua Nyarwanda	CHECKED	Rodney Barugahare
DATE	April 2021	APPROVED	Rodney Barugahare.



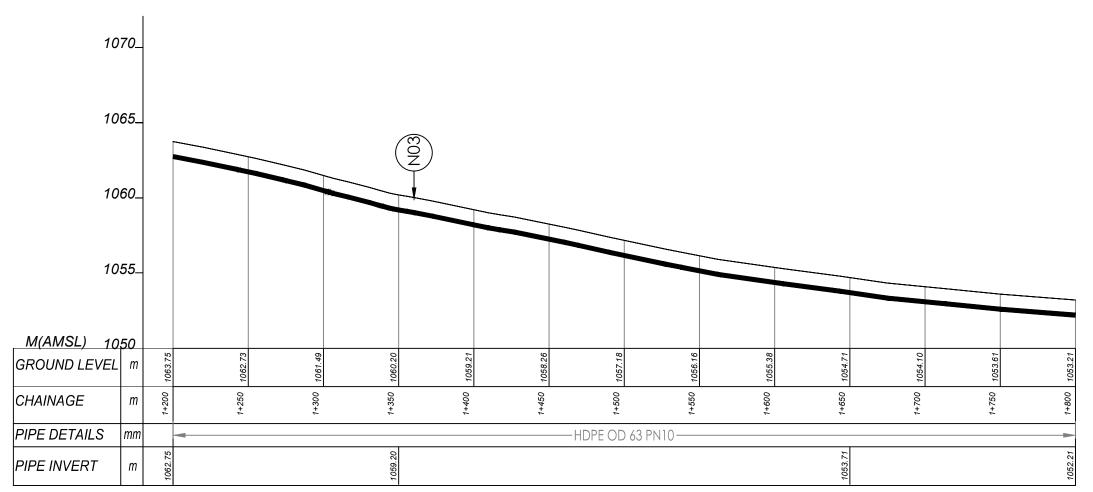

DISTRIBUTION 12 (1+200.00 - 1+800.00)

NOTES LEGEND Transmission Pipeline Distribution Pipeline Ground Level Building/House Contours Road DAV Double Orifice Air Valve EP End pipe NOI Node NO1

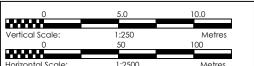

G

GOVERNMENT OF UGANDA MINISTRY OF WATER AND ENVIRONMENT

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WO-1 Washout Type 1
WO-2 Washout Type 2



PROJECT

CONSULTANCY SERVICES FOR FEASIBILITY STUDY,
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SUPERVISION OF SOLAR POWERED PIPED WATER SUPPLY
SYSTEMS AND SANITATION FACILITIES IN REFUGEE
SETTLEMENTS AND HOST DISTRICTS IN WEST NILE AND
NORTHERN UGANDA IN KIRYANDONGO DISTRICT

MUTUNDA WATER SUPPLY SYSTEM

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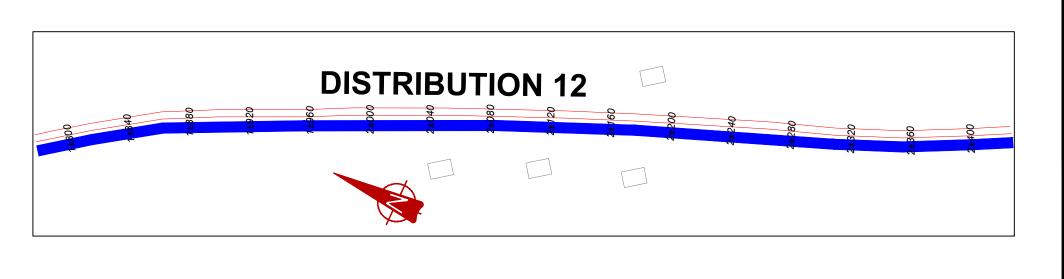
In Joint Venture with




DETAILED ENGINEERING DESIGN

DISTRIBUTION LINE 12 (1+200.00 - 1+800.00)

SCALE	VERT; 1:250 HOR; 1:2500	DRAWING No.	MUT/WS/5.12.3
SURVEYED	Evans Mpanga	DESIGNED	Otwane Dan.
DRAWN	Joshua Nyarwanda	CHECKED	Rodney Barugahare
DATE	April 2021	APPROVED	Rodney Barugahare.



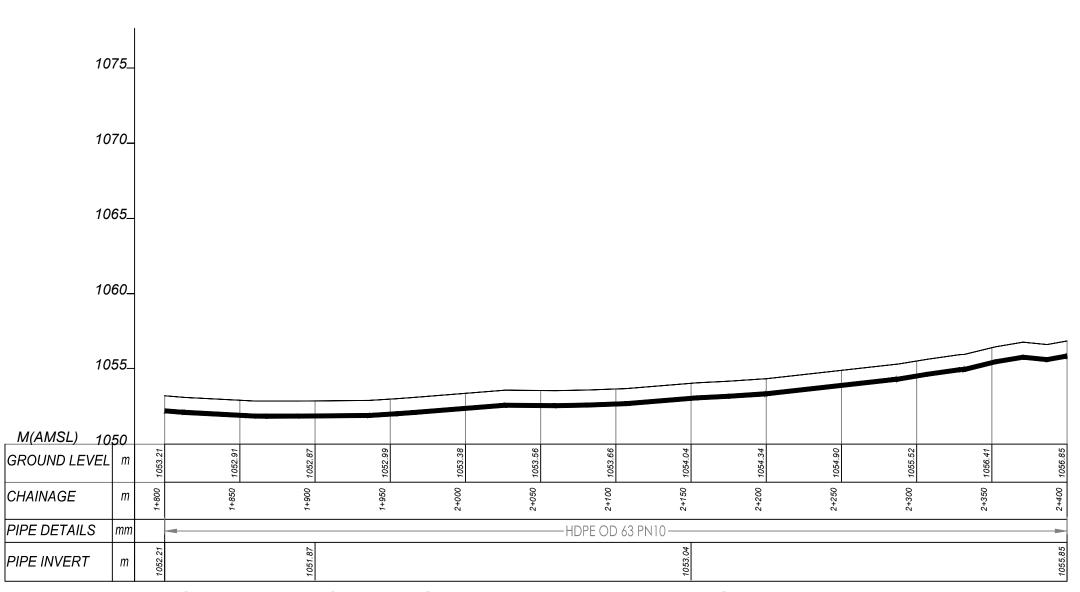

DISTRIBUTION 12 (1+800.00 - 2+400.00)

1080

NOTES

LEGEND

Transmission Pipeline
Distribution Pipeline



Ground Level
Building/House



Contours

Road



DAV Double Orifice Air Valve




End pipe



Node N01

WO-1 Washout Type 1
WO-2 Washout Type 2

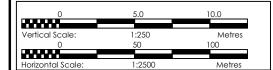

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SUPERVISION OF SOLAR POWERED PIPED WATER SUPPLY
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SETTLEMENTS AND HOST DISTRICTS IN WEST NILE AND
NORTHERN UGANDA IN KIRYANDONGO DISTRICT

MUTUNDA WATER SUPPLY SYSTEM

Corporate Headquarter
10 Philipot Lane, 1st Floor,
London ECSM ABA,
United Kingdom

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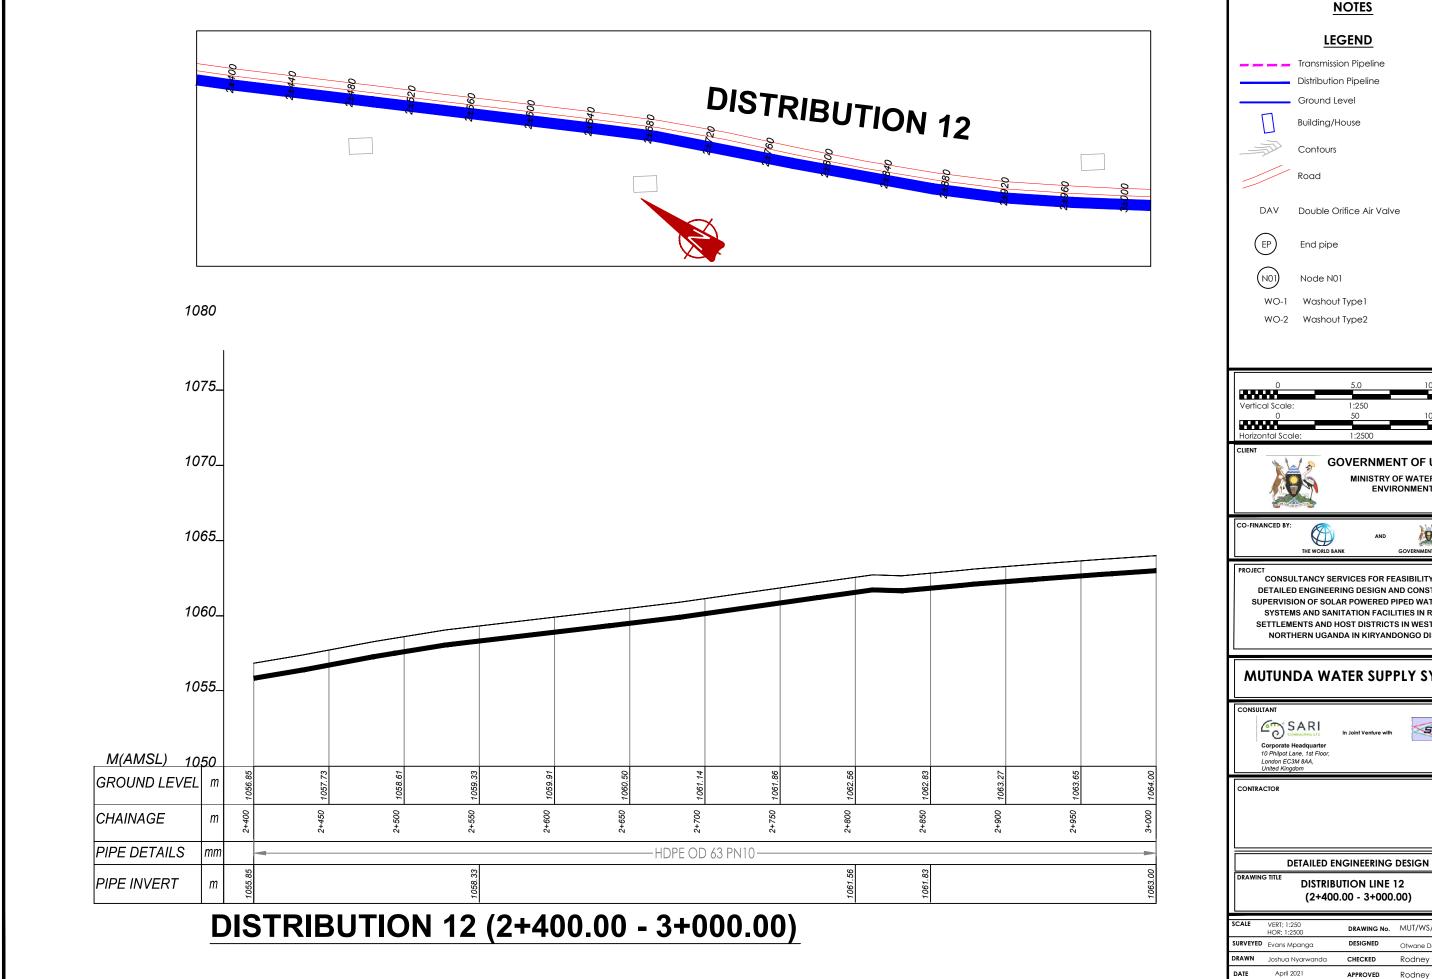


CONTRACTO

DETAILED ENGINEERING DESIGN

DISTRIBUTION LINE 12 (1+800.00 - 2+400.00)

SCALE	VERT; 1:250 HOR; 1:2500	DRAWING No.	MUT/WS/5.12.4
SURVEYED	Evans Mpanga	DESIGNED	Otwane Dan.
DRAWN	Joshua Nyarwanda	CHECKED	Rodney Barugahare
DATE	April 2021	APPROVED	Rodney Barugahare.





NOTES LEGEND Transmission Pipeline Distribution Pipeline Ground Level Building/House Contours DAV Double Orifice Air Valve End pipe Node N01 WO-1 Washout Type 1 WO-2 Washout Type2 **GOVERNMENT OF UGANDA** MINISTRY OF WATER AND ENVIRONMENT CONSULTANCY SERVICES FOR FEASIBILITY STUDY, DETAILED ENGINEERING DESIGN AND CONSTRUCTION SUPERVISION OF SOLAR POWERED PIPED WATER SUPPLY SYSTEMS AND SANITATION FACILITIES IN REFUGEE SETTLEMENTS AND HOST DISTRICTS IN WEST NILE AND NORTHERN UGANDA IN KIRYANDONGO DISTRICT **MUTUNDA WATER SUPPLY SYSTEM** SGAPI Corporate Headquarter 10 Philpot Lane, 1st Floor, London EC3M 8AA, United Kingdom

DRAWING No. MUT/WS/5.12.5

Rodney Barugahare

CHECKED

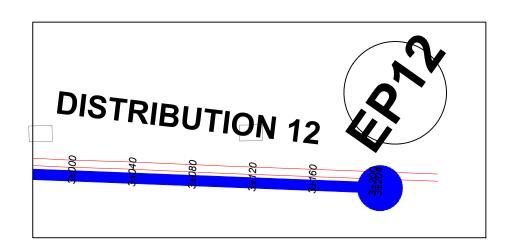

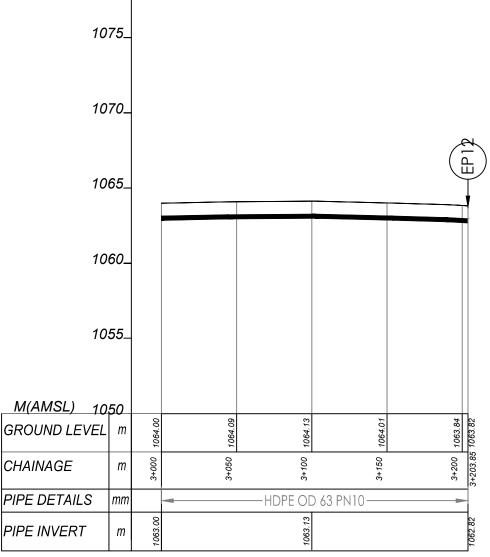

DISTRIBUTION 12 (3+000.00 - 3+203.85)

NOTES LEGEND Transmission Pipeline Distribution Pipeline Ground Level Building/House Contours



DAV Double Orifice Air Valve




End pipe



Node N01

WO-1 Washout Type 1
WO-2 Washout Type 2

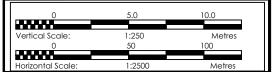

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SUPERVISION OF SOLAR POWERED PIPED WATER SUPPLY
SYSTEMS AND SANITATION FACILITIES IN REFUGEE
SETTLEMENTS AND HOST DISTRICTS IN WEST NILE AND
NORTHERN UGANDA IN KIRYANDONGO DISTRICT

MUTUNDA WATER SUPPLY SYSTEM

Corporate Headquarter
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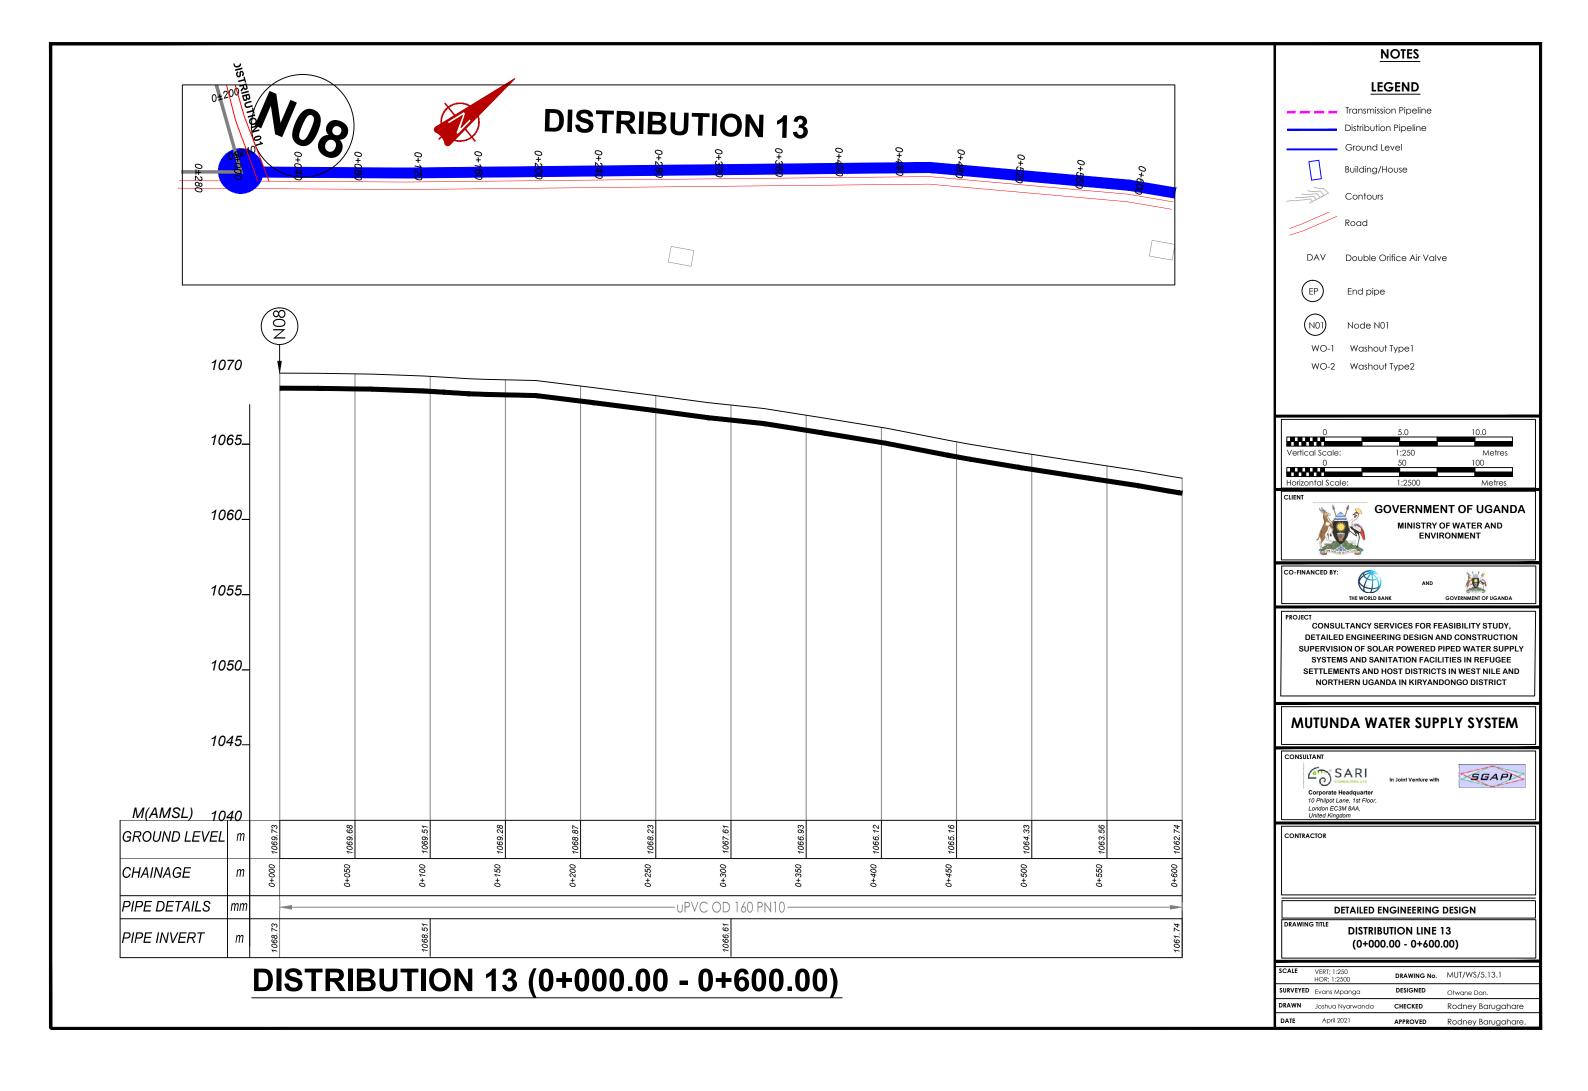
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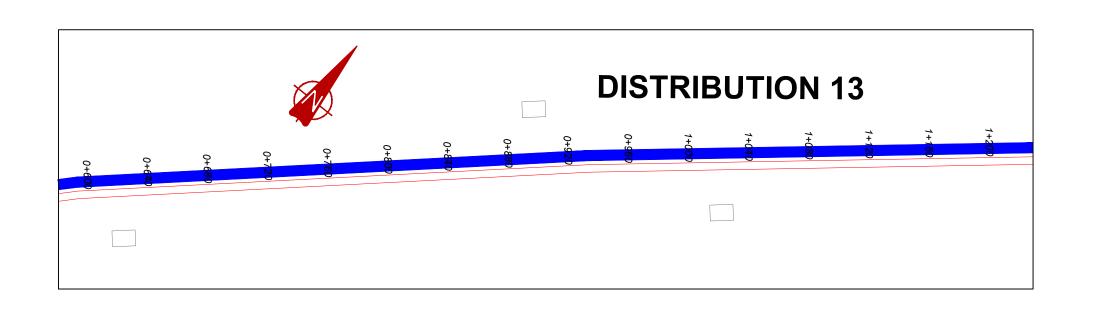
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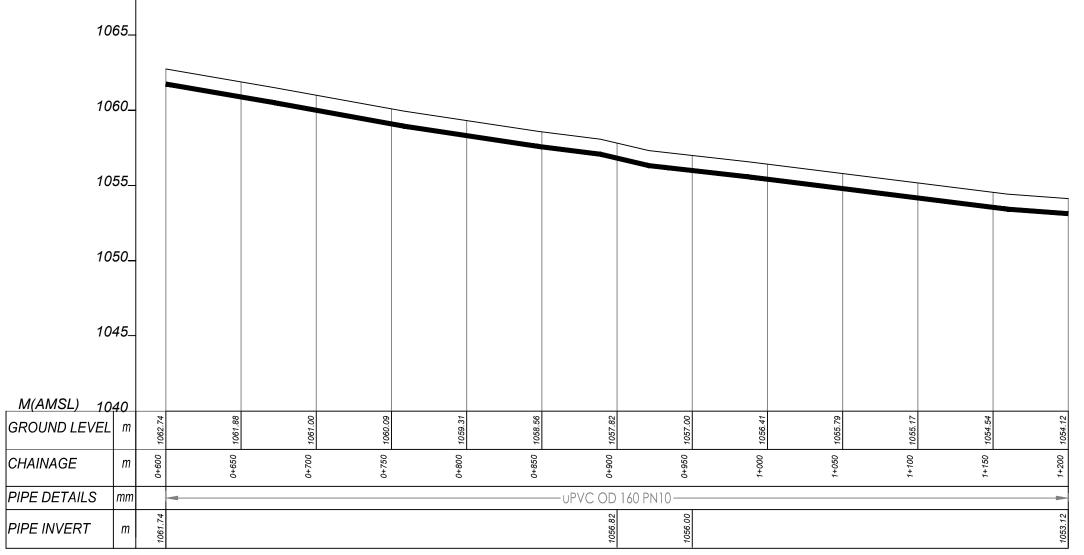
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DISTRIBUTION LINE 12 (3+000.00 - 3+203.85)

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SURVEYED	Evans Mpanga	DESIGNED	Otwane Dan.
DRAWN	Joshua Nyarwanda	CHECKED	Rodney Barugahare
DATE	April 2021	APPROVED	Rodney Barugahare.







DISTRIBUTION 13 (0+600.00 - 1+200.00)

NOTES LEGEND Transmission Pipeline Distribution Pipeline Ground Level

Building/House

Contours

Road

DAV Double Orifice Air Valve




End pipe



Node N01

WO-2 Washout Type2

WO-1 Washout Type 1

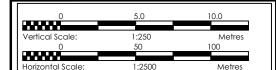

GOVERNMENT OF UGANDA

MINISTRY OF WATER AND
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CONSULTANCY SERVICES FOR FEASIBILITY STUDY,
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SUPERVISION OF SOLAR POWERED PIPED WATER SUPPLY
SYSTEMS AND SANITATION FACILITIES IN REFUGEE
SETTLEMENTS AND HOST DISTRICTS IN WEST NILE AND
NORTHERN UGANDA IN KIRYANDONGO DISTRICT

MUTUNDA WATER SUPPLY SYSTEM

CONSULTANT

SARI

Corporate Headquarter
10 Philipot Lane, 1st Floor,
London EC3M 8AA,
United Kingdom

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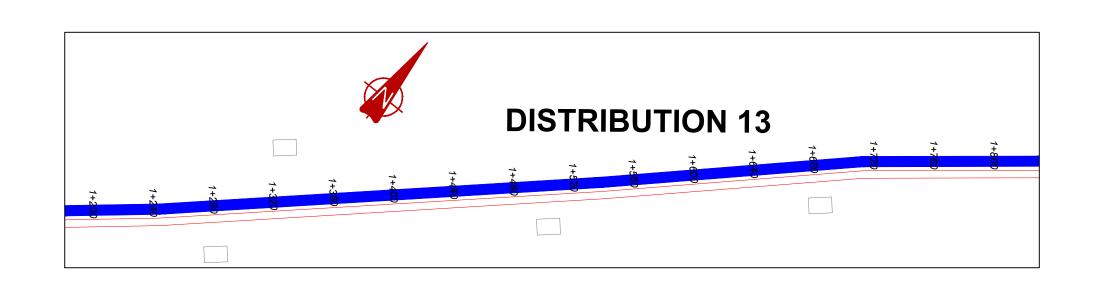



CONTRACTO

DETAILED ENGINEERING DESIGN

DISTRIBUTION LINE 13 (0+600.00 - 1+200.00)

SCALE	VERT; 1:250 HOR; 1:2500	DRAWING No.	MUT/W\$/5.13.2
SURVEYED	Evans Mpanga	DESIGNED	Otwane Dan.
DRAWN	Joshua Nyarwanda	CHECKED	Rodney Barugahare
DATE	April 2021	APPROVED	Rodney Barugahare.



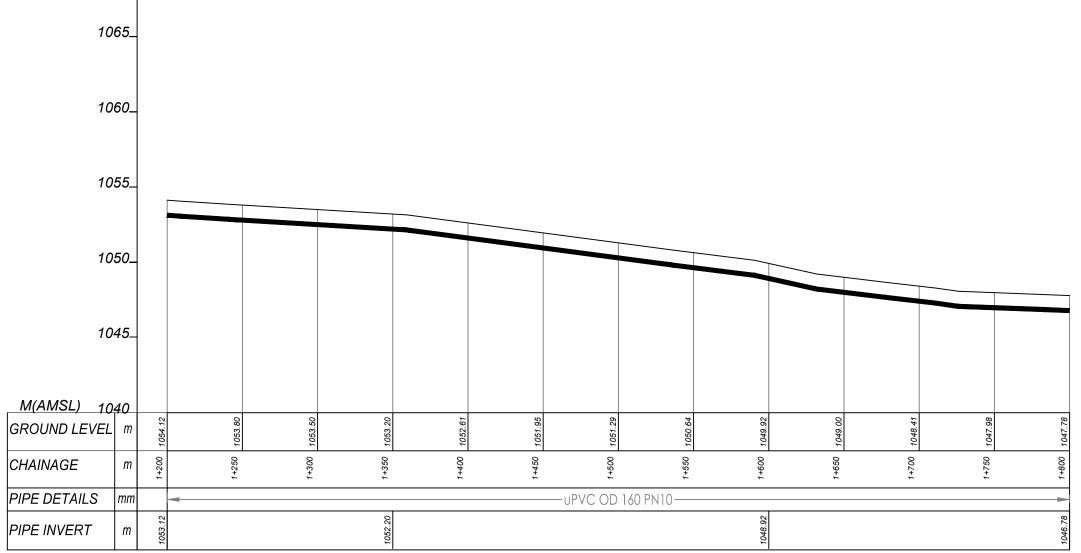

DISTRIBUTION 13 (1+200.00 - 1+800.00)

NOTES

LEGEND

Transmission Pipeline Distribution Pipeline Ground Level



Building/House



Contours Road



DAV Double Orifice Air Valve




End pipe



Node N01

WO-2 Washout Type2

WO-1 Washout Type 1

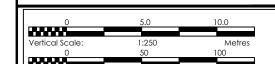

GOVERNMENT OF UGANDA MINISTRY OF WATER AND ENVIRONMENT







CONSULTANCY SERVICES FOR FEASIBILITY STUDY, DETAILED ENGINEERING DESIGN AND CONSTRUCTION SUPERVISION OF SOLAR POWERED PIPED WATER SUPPLY SYSTEMS AND SANITATION FACILITIES IN REFUGEE SETTLEMENTS AND HOST DISTRICTS IN WEST NILE AND NORTHERN UGANDA IN KIRYANDONGO DISTRICT

MUTUNDA WATER SUPPLY SYSTEM


SARI Corporate Headquarter 10 Philpot Lane, 1st Floor, London EC3M 8AA, United Kingdom




DETAILED ENGINEERING DESIGN

DISTRIBUTION LINE 13 (1+200.00 - 1+800.00)

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SURVEYED	Evans Mpanga	DESIGNED	Otwane Dan.
DRAWN	Joshua Nyarwanda	CHECKED	Rodney Barugahare
DATE	April 2021	APPROVED	Rodney Barugahare.

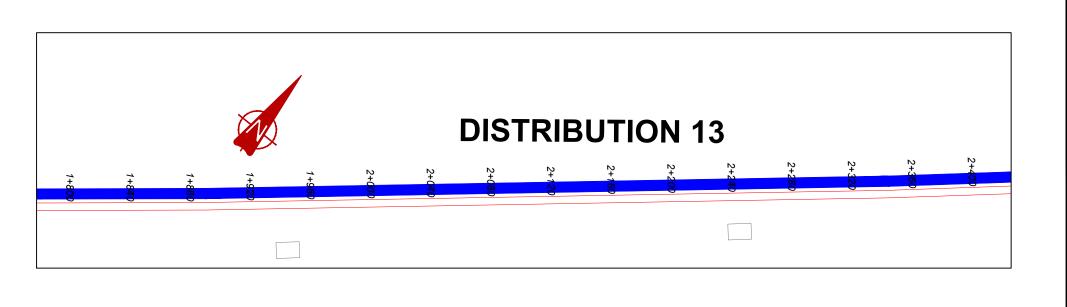

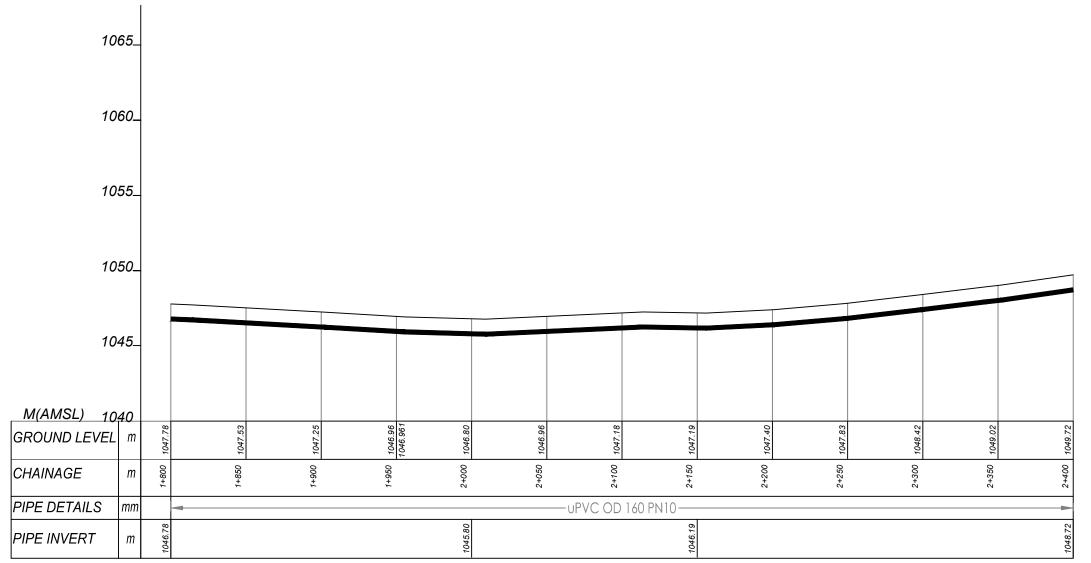

DISTRIBUTION 13 (1+800.00 - 2+400.00)

NOTES

LEGEND

Transmission Pipeline
Distribution Pipeline



Ground Level
Building/House



Contours

Road



DAV Double Orifice Air Valve




End pipe



Node N01

WO-2 Washout Type2

WO-1 Washout Type 1

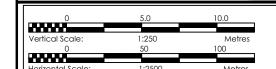

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SUPERVISION OF SOLAR POWERED PIPED WATER SUPPLY
SYSTEMS AND SANITATION FACILITIES IN REFUGEE
SETTLEMENTS AND HOST DISTRICTS IN WEST NILE AND
NORTHERN UGANDA IN KIRYANDONGO DISTRICT

MUTUNDA WATER SUPPLY SYSTEM

Corporate Headquarter
10 Philipot Lane, 1st Floor,
London EC3M 8AA,
United Kingdom

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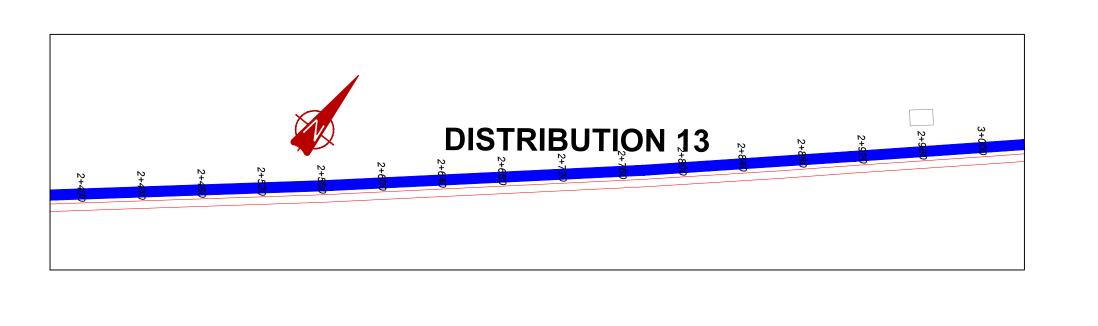



CONTRACTO

DETAILED ENGINEERING DESIGN

DISTRIBUTION LINE 13 (1+800.00 - 2+400.00)

SCALE	VERT; 1:250 HOR; 1:2500	DRAWING No.	MUT/WS/5.13.4
SURVEYED	Evans Mpanga	DESIGNED	Otwane Dan.
DRAWN	Joshua Nyarwanda	CHECKED	Rodney Barugahare
DATE	April 2021	APPROVED	Rodney Barugahare.



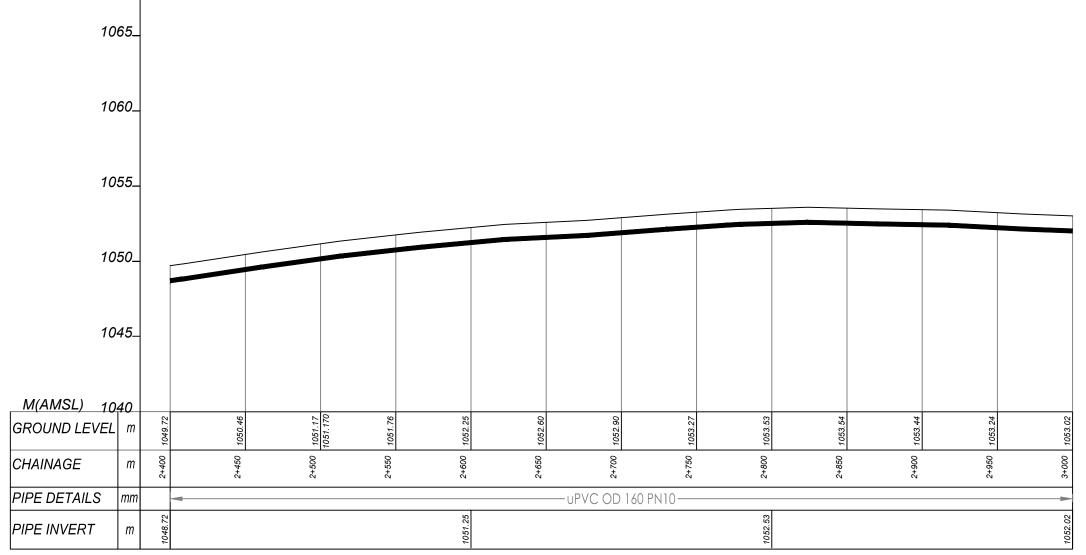

DISTRIBUTION 13 (2+400.00 - 3+000.00)

NOTES LEGEND Transmission Pipeline Distribution Pipeline Ground Level Building/House Contours Road DAV Double Orifice Air Valve End pipe Node N01 WO-1 Washout Type 1 WO-2 Washout Type2 **GOVERNMENT OF UGANDA** MINISTRY OF WATER AND ENVIRONMENT CONSULTANCY SERVICES FOR FEASIBILITY STUDY, DETAILED ENGINEERING DESIGN AND CONSTRUCTION SUPERVISION OF SOLAR POWERED PIPED WATER SUPPLY SYSTEMS AND SANITATION FACILITIES IN REFUGEE SETTLEMENTS AND HOST DISTRICTS IN WEST NILE AND NORTHERN UGANDA IN KIRYANDONGO DISTRICT

MUTUNDA WATER SUPPLY SYSTEM

Consultant

Corporate Headquarter
10 Philipot Lane, 1st Floor,
London EC3M 8AA,
United Kingdom


n Joint Venture with





DETAILED ENGINEERING DESIGN


DISTRIBUTION LINE 13 (2+400.00 - 3+000.00)


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DRAWN	Joshua Nyarwanda	CHECKED	Rodney Barugahare
DATE	April 2021	APPROVED	Rodney Barugahare.

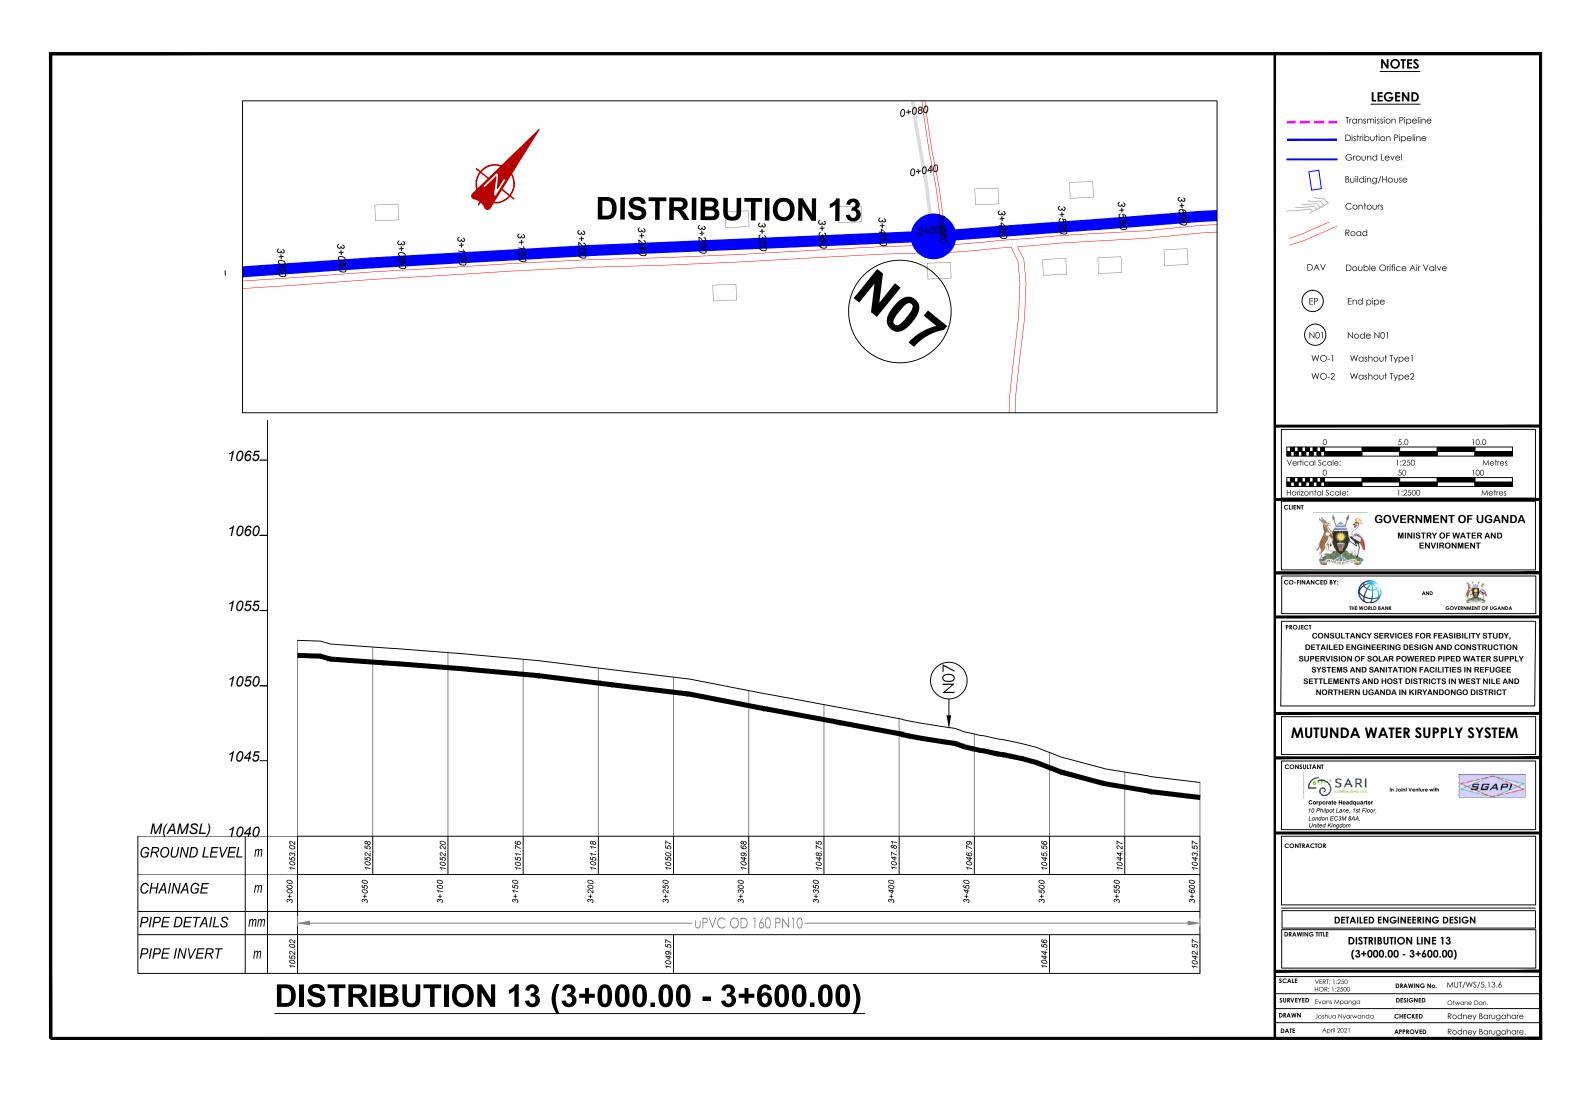


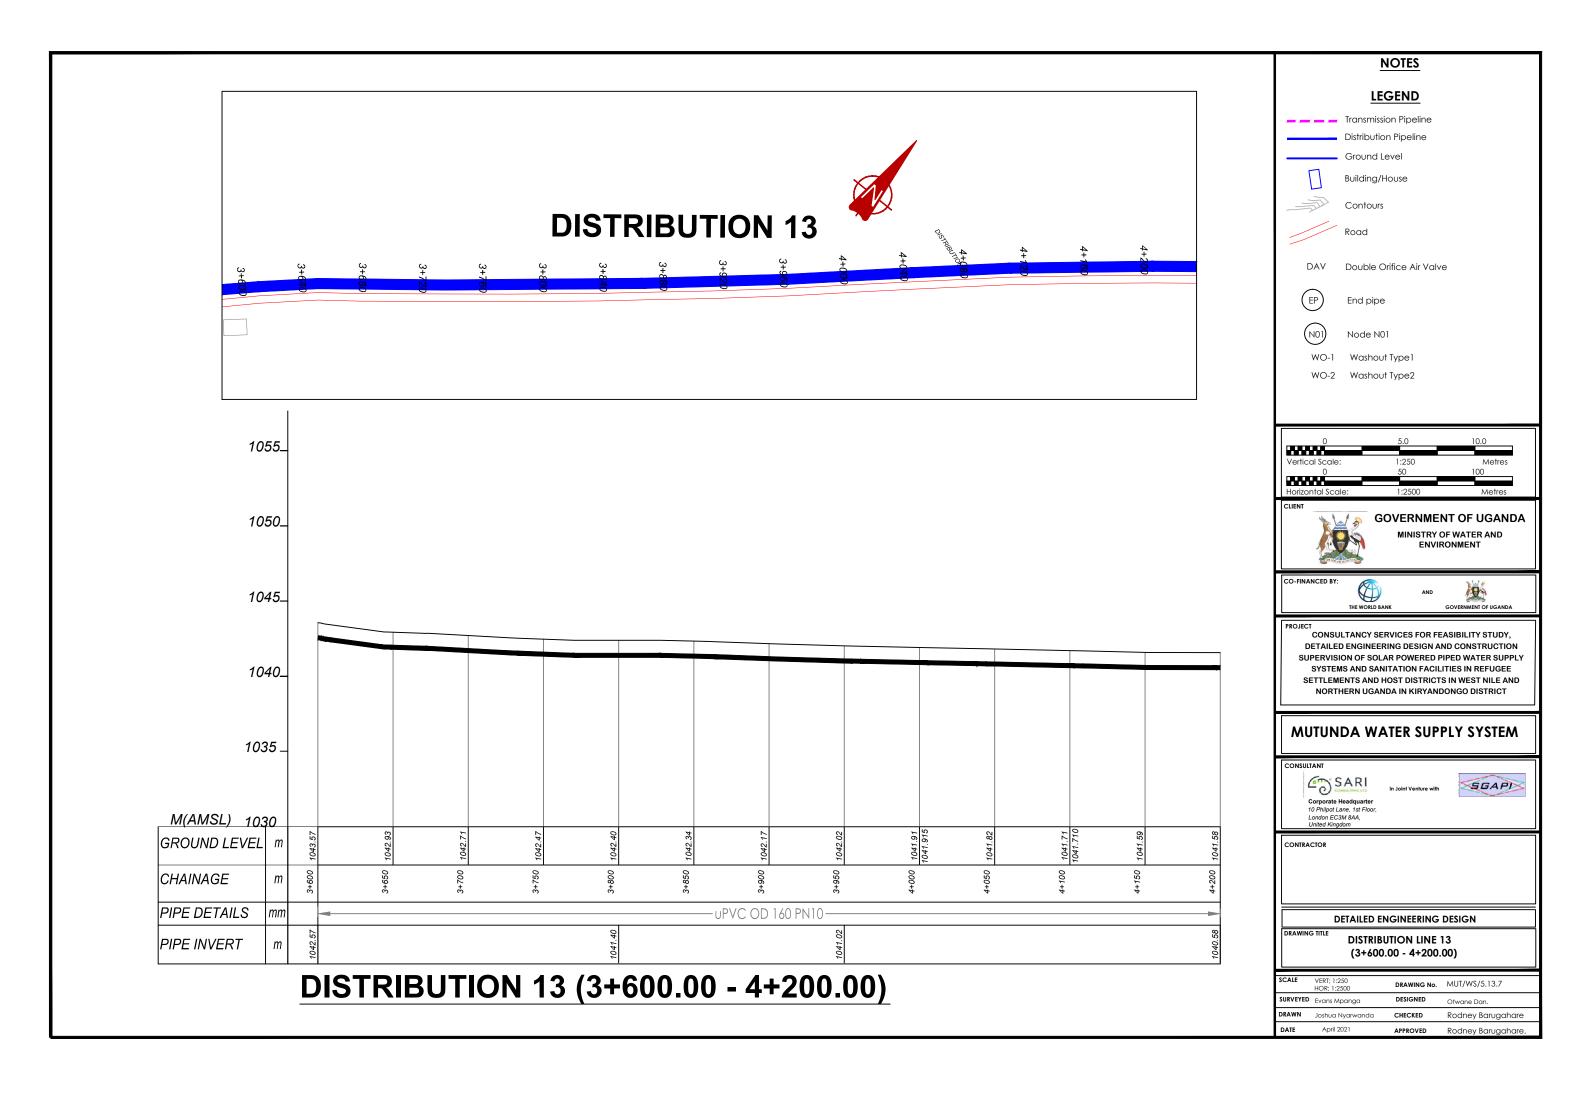

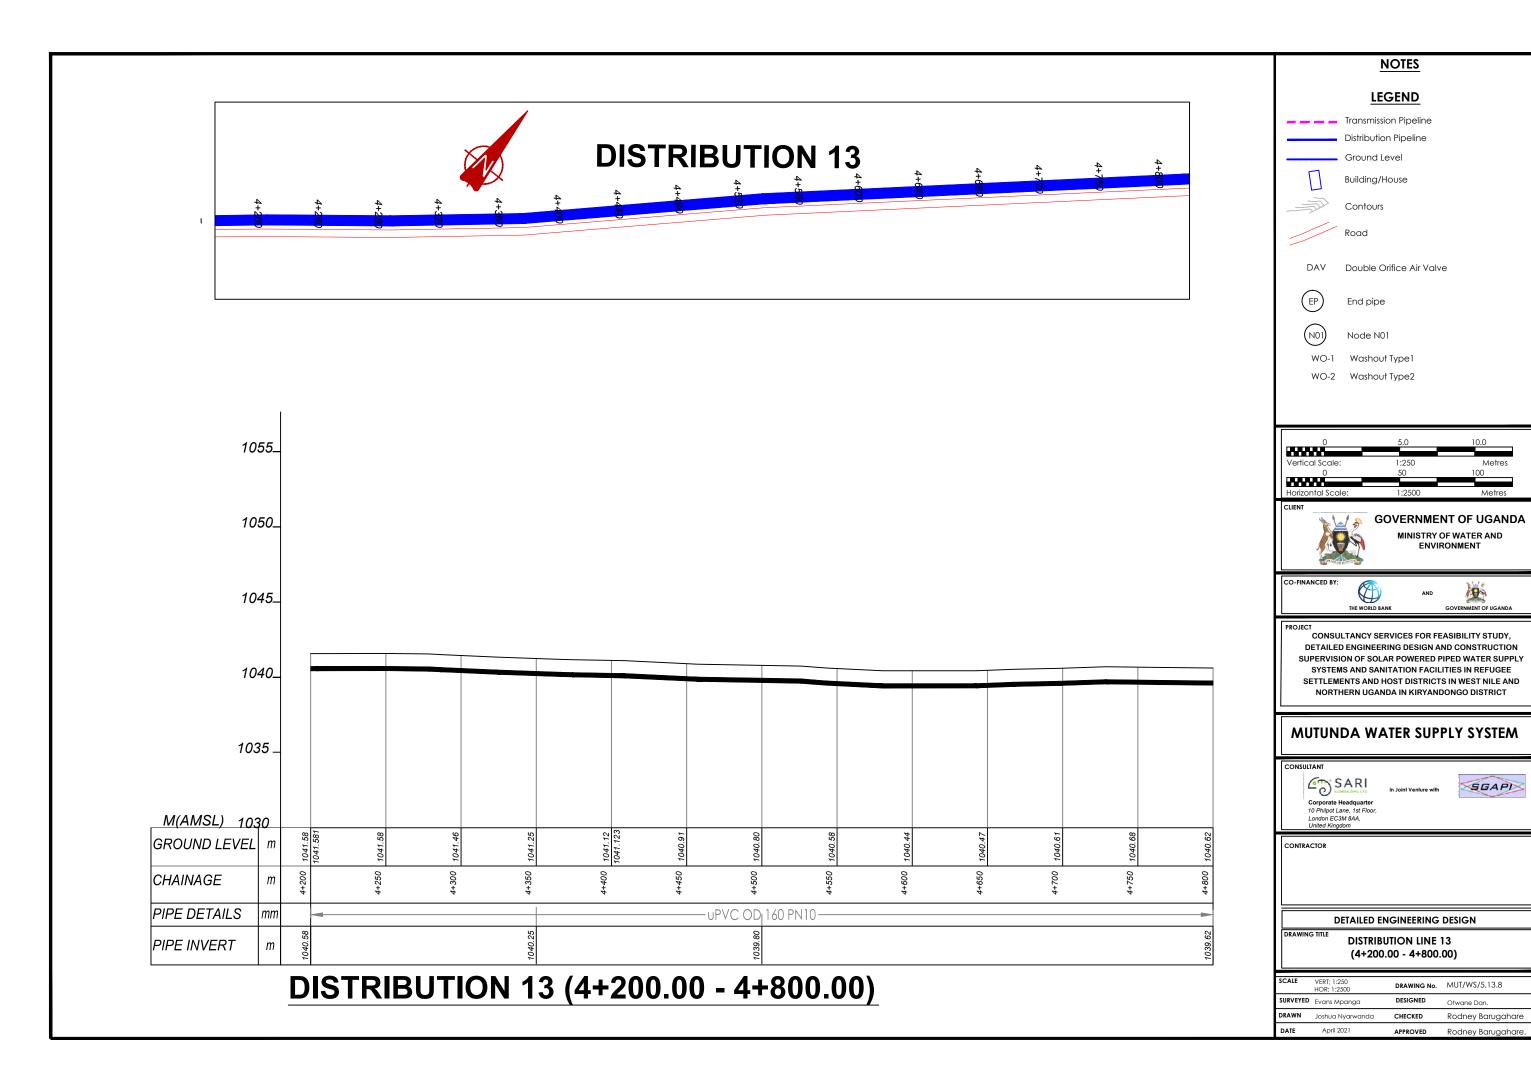

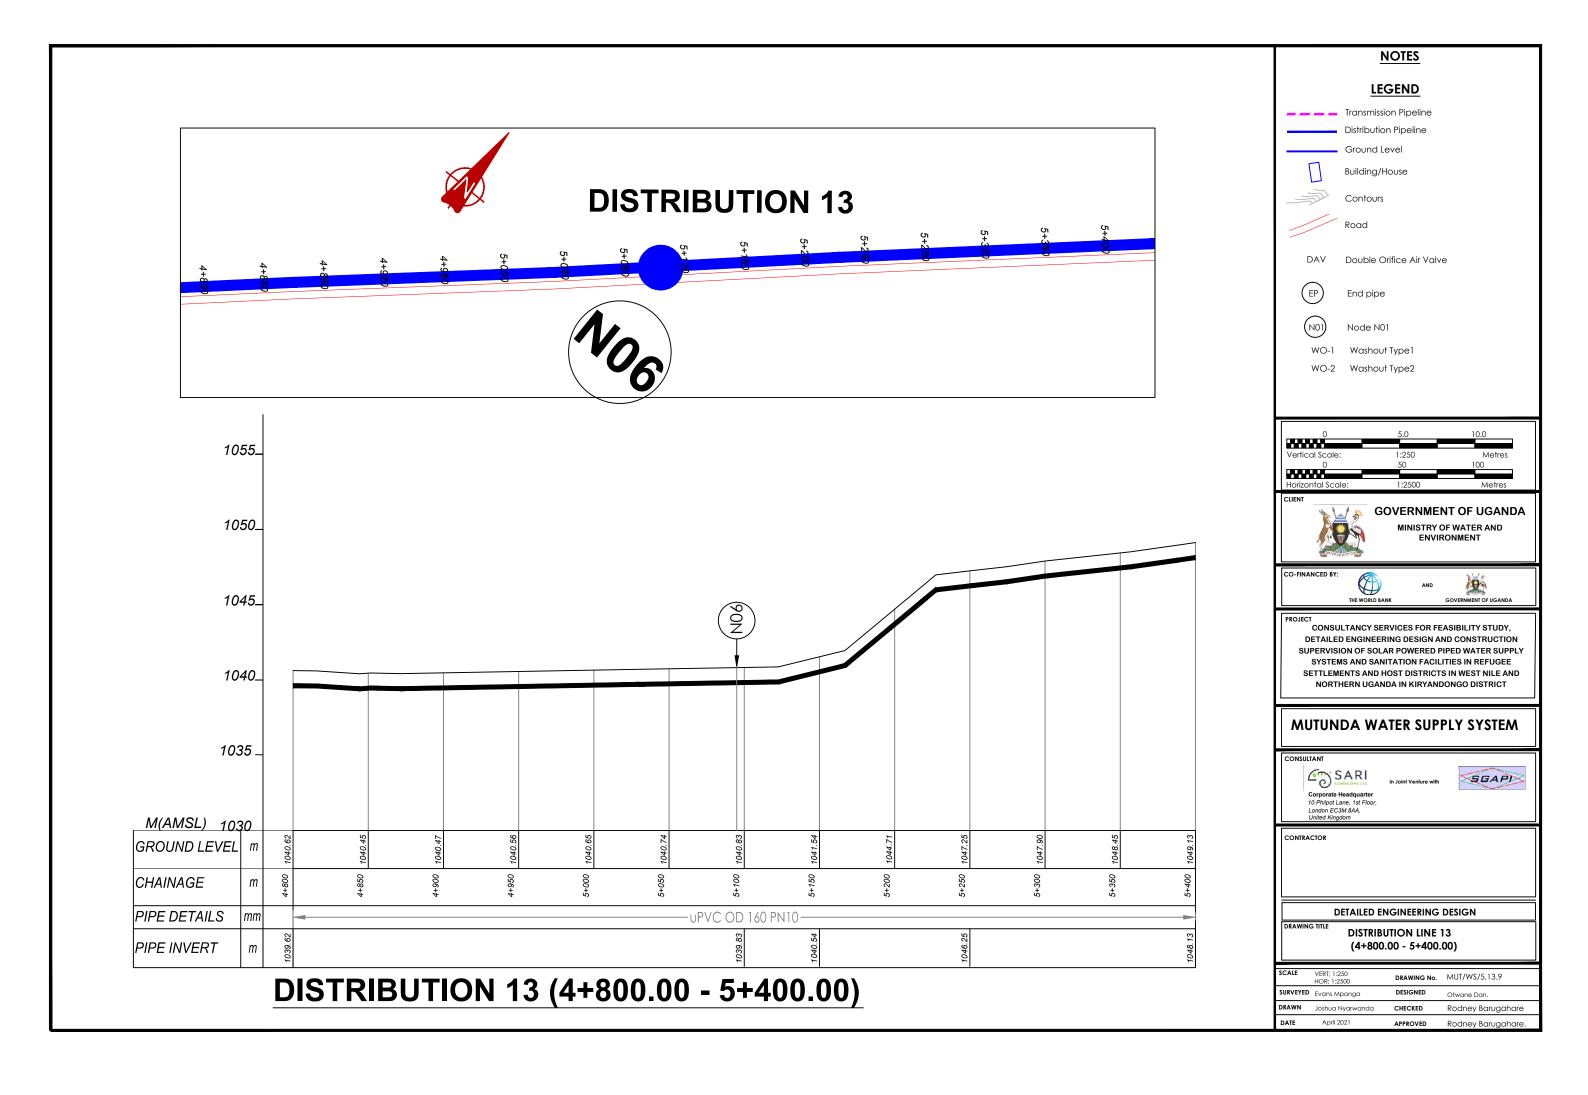

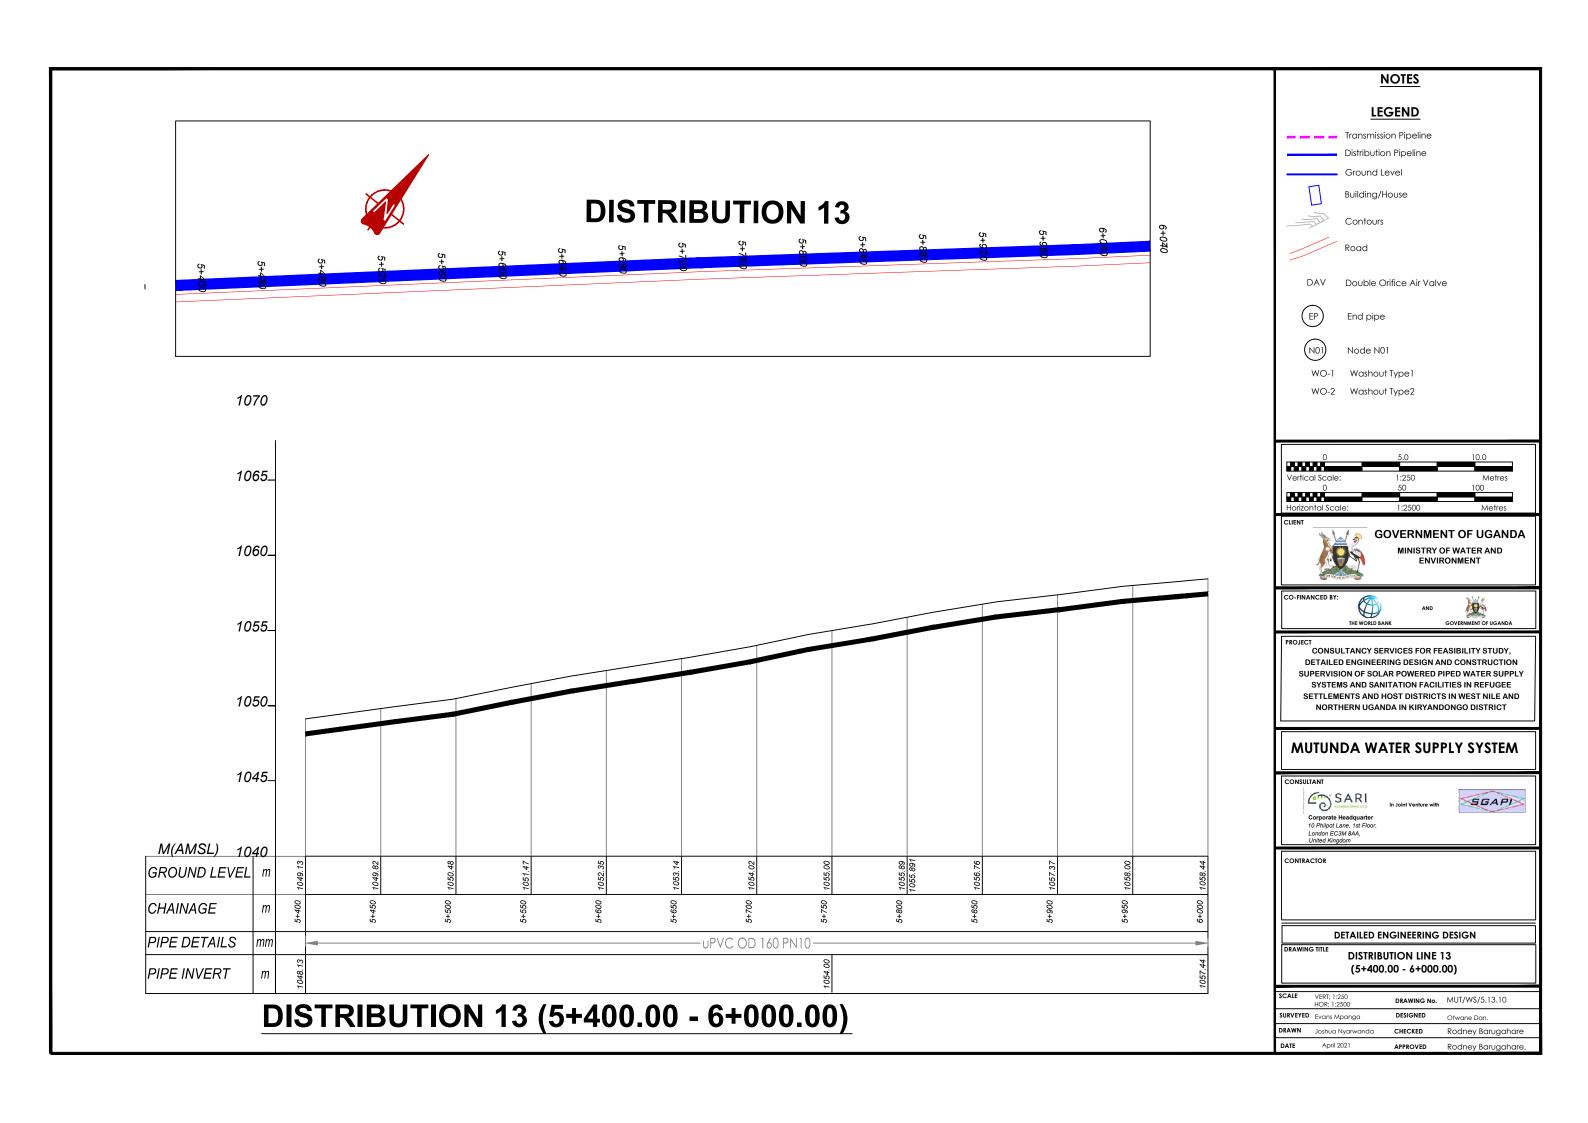

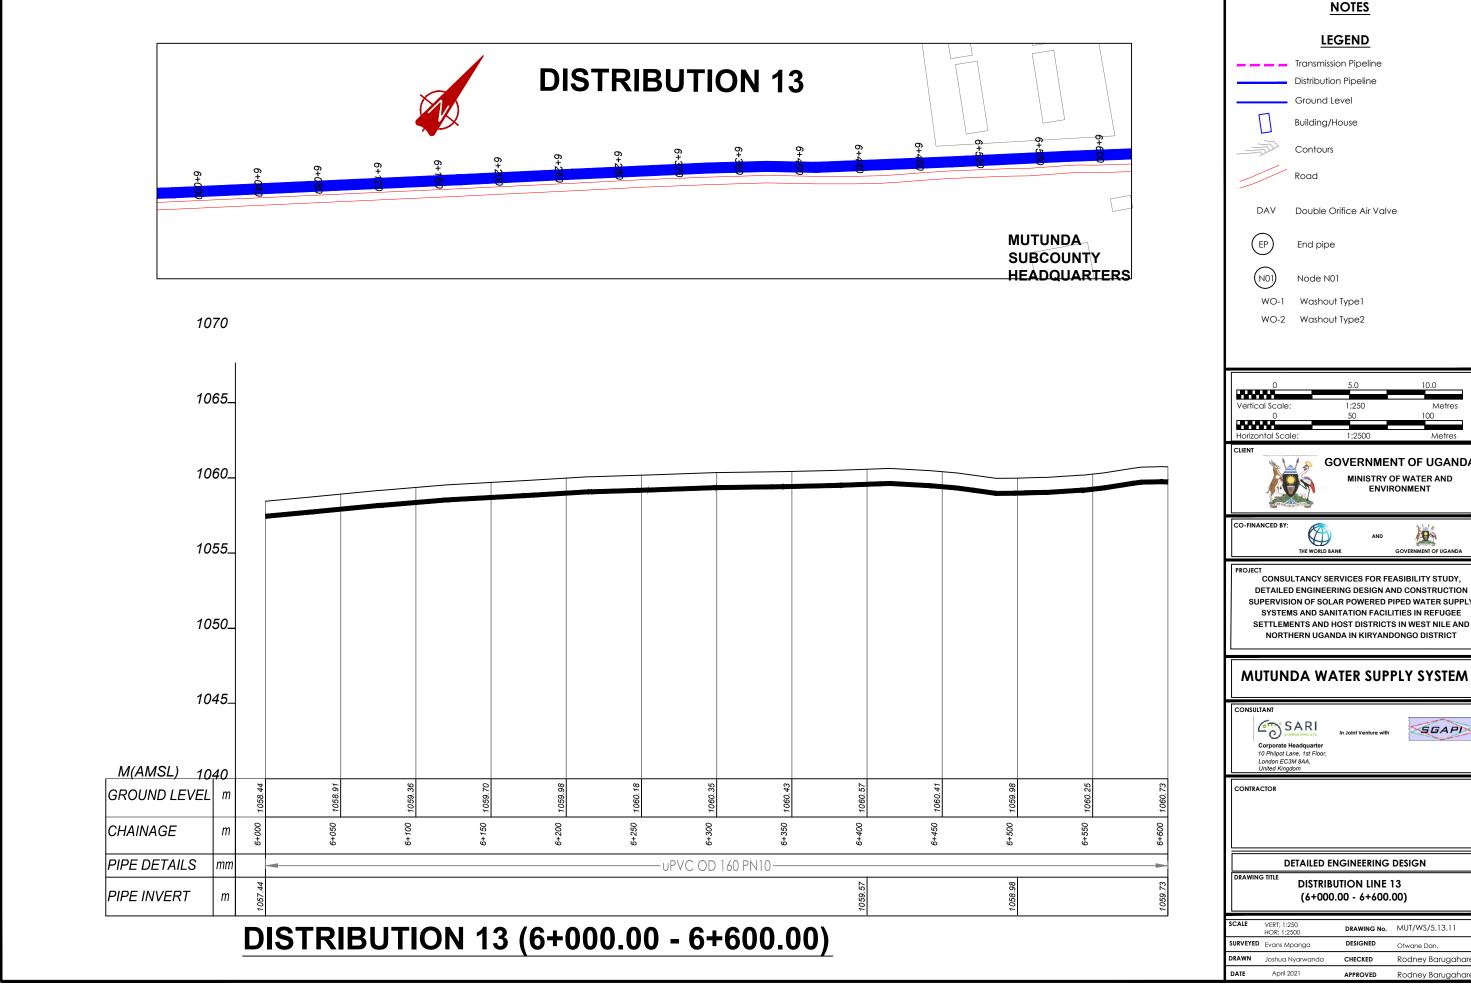



NOTES Transmission Pipeline Distribution Pipeline DAV Double Orifice Air Valve **GOVERNMENT OF UGANDA** MINISTRY OF WATER AND CONSULTANCY SERVICES FOR FEASIBILITY STUDY, DETAILED ENGINEERING DESIGN AND CONSTRUCTION SUPERVISION OF SOLAR POWERED PIPED WATER SUPPLY SYSTEMS AND SANITATION FACILITIES IN REFUGEE SETTLEMENTS AND HOST DISTRICTS IN WEST NILE AND


NORTHERN UGANDA IN KIRYANDONGO DISTRICT



SCALE	VERT; 1:250 HOR; 1:2500	DRAWING No.	MUT/WS/5.13.11
SURVEYED	Evans Mpanga	DESIGNED	Otwane Dan.
DRAWN	Joshua Nyarwanda	CHECKED	Rodney Barugahare
DATE	April 2021	APPROVED	Rodney Barugahare.

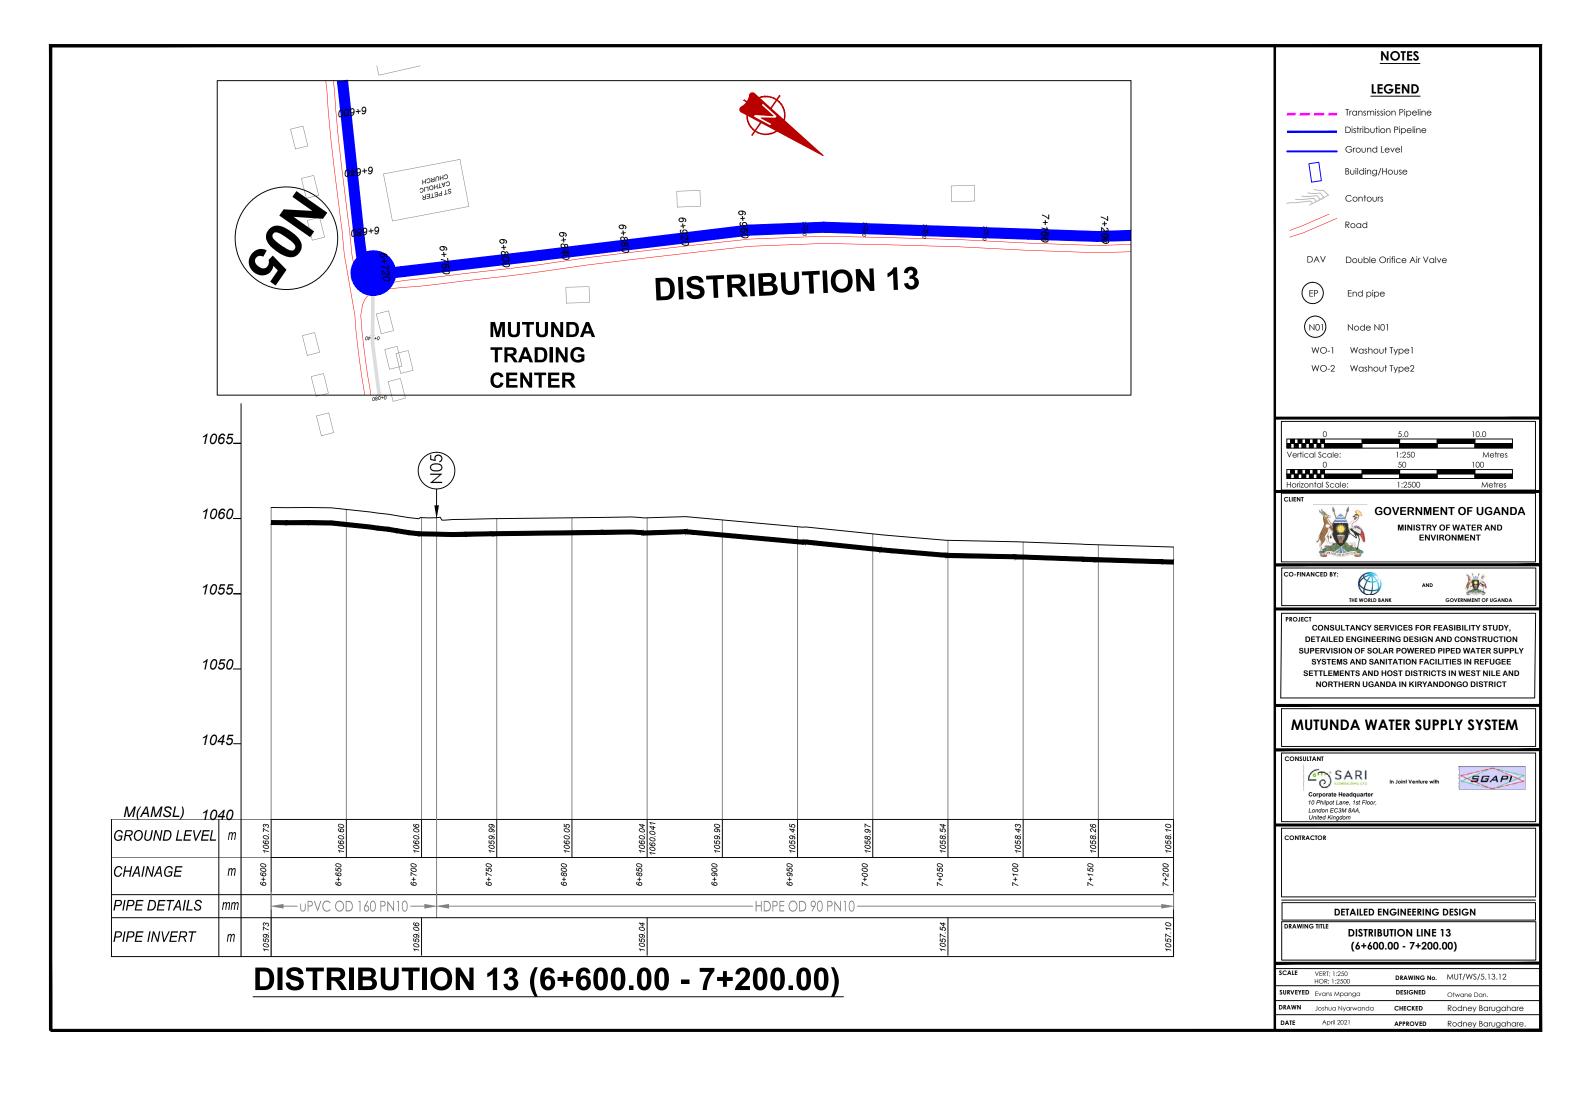

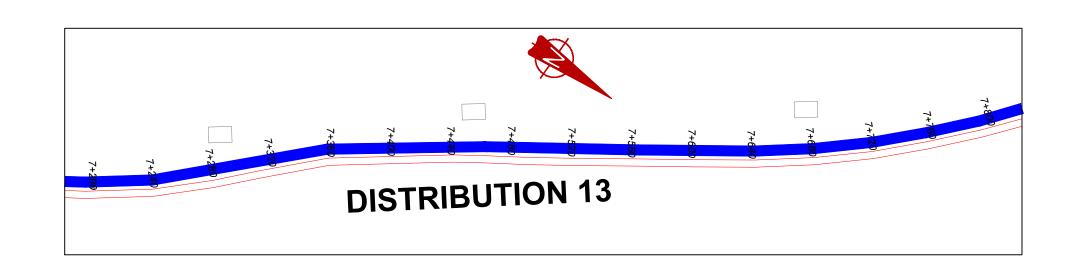

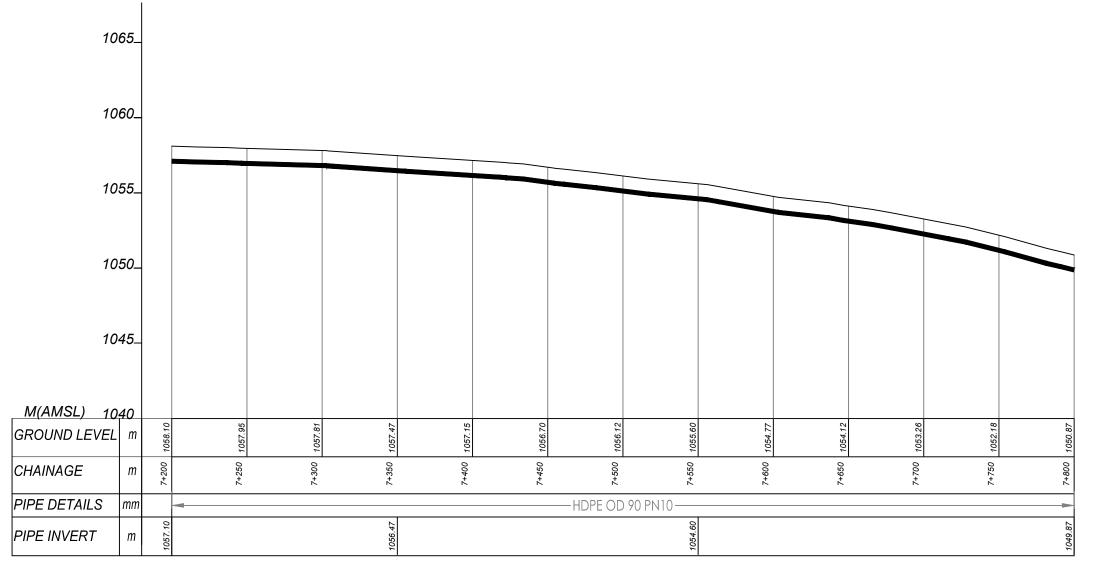

DISTRIBUTION 13 (7+200.00 - 7+800.00)

NOTES

LEGEND

Transmission Pipeline
Distribution Pipeline



Ground Level
Building/House



Contours



DAV Double Orifice Air Valve




End pipe

Road



Node N01

WO-1 Washout Type 1
WO-2 Washout Type 2

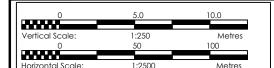



GOVERNMENT OF UGANDA MINISTRY OF WATER AND ENVIRONMENT

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SUPERVISION OF SOLAR POWERED PIPED WATER SUPPLY
SYSTEMS AND SANITATION FACILITIES IN REFUGEE
SETTLEMENTS AND HOST DISTRICTS IN WEST NILE AND
NORTHERN UGANDA IN KIRYANDONGO DISTRICT

MUTUNDA WATER SUPPLY SYSTEM

Corporate Headquarter 10 Philipot Lane, 1st Floor, London EC3M 8AA, United Kingdom

In Joint Venture with




CONTRACTO

DETAILED ENGINEERING DESIGN

DISTRIBUTION LINE 13 (7+200.00 - 7+800.00)


SCALE	VERT; 1:250 HOR; 1:2500	DRAWING No.	MUT/WS/5.13.13
SURVEYED	Evans Mpanga	DESIGNED	Otwane Dan.
DRAWN	Joshua Nyarwanda	CHECKED	Rodney Barugahare
DATE	April 2021	APPROVED	Rodney Barugahare.

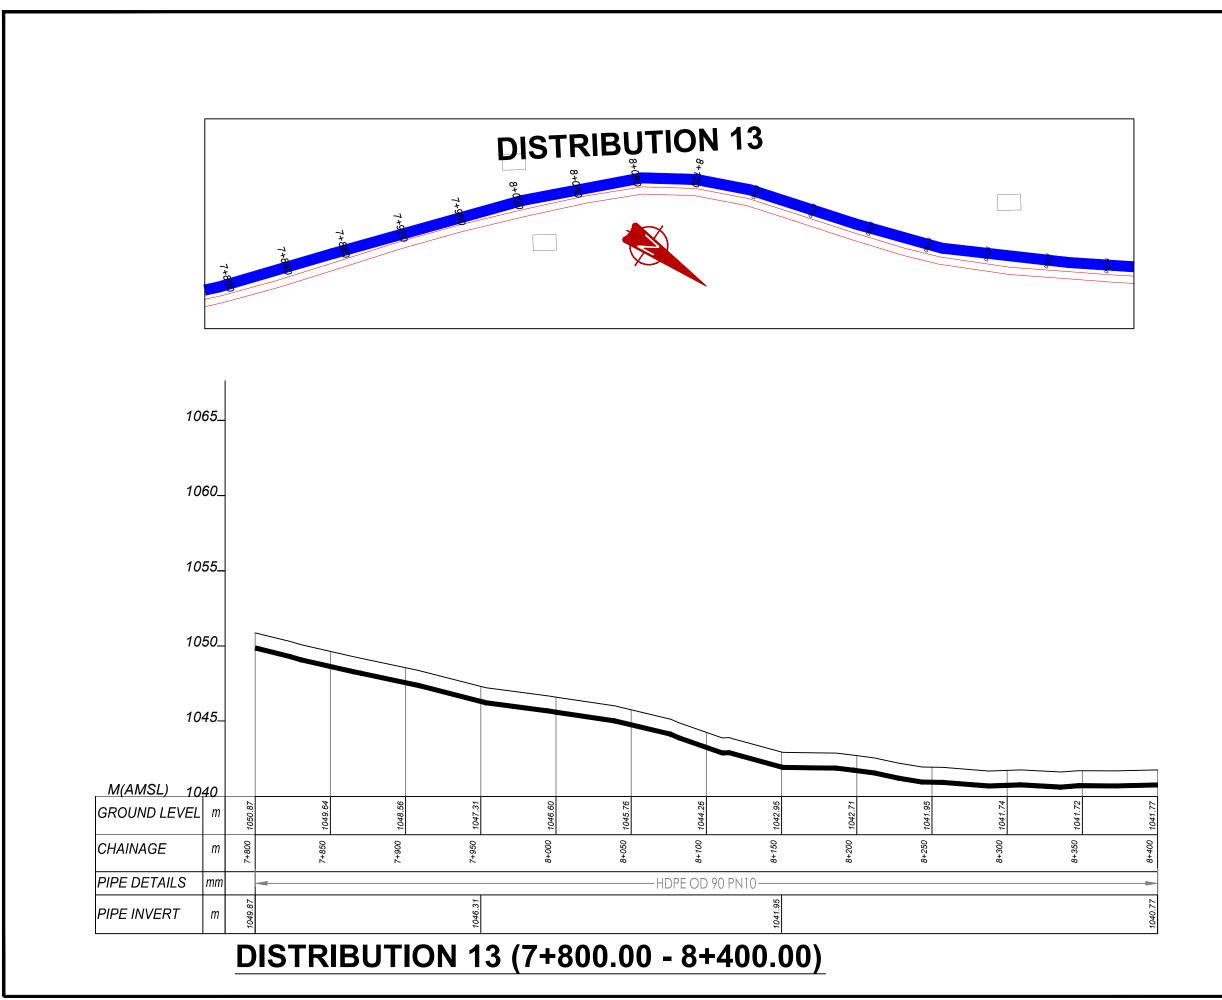



NOTES LEGEND Transmission Pipeline Distribution Pipeline Ground Level Building/House Contours Road DAV Double Orifice Air Valve End pipe Node N01 WO-1 Washout Type 1 WO-2 Washout Type2 **GOVERNMENT OF UGANDA** MINISTRY OF WATER AND ENVIRONMENT CONSULTANCY SERVICES FOR FEASIBILITY STUDY, DETAILED ENGINEERING DESIGN AND CONSTRUCTION SUPERVISION OF SOLAR POWERED PIPED WATER SUPPLY SYSTEMS AND SANITATION FACILITIES IN REFUGEE SETTLEMENTS AND HOST DISTRICTS IN WEST NILE AND NORTHERN UGANDA IN KIRYANDONGO DISTRICT **MUTUNDA WATER SUPPLY SYSTEM** SARI SGAPI Corporate Headquarter 10 Philpot Lane, 1st Floor, London EC3M 8AA, United Kingdom DETAILED ENGINEERING DESIGN **DISTRIBUTION LINE 13**


(7+800.00 - 8+400.00)

CHECKED

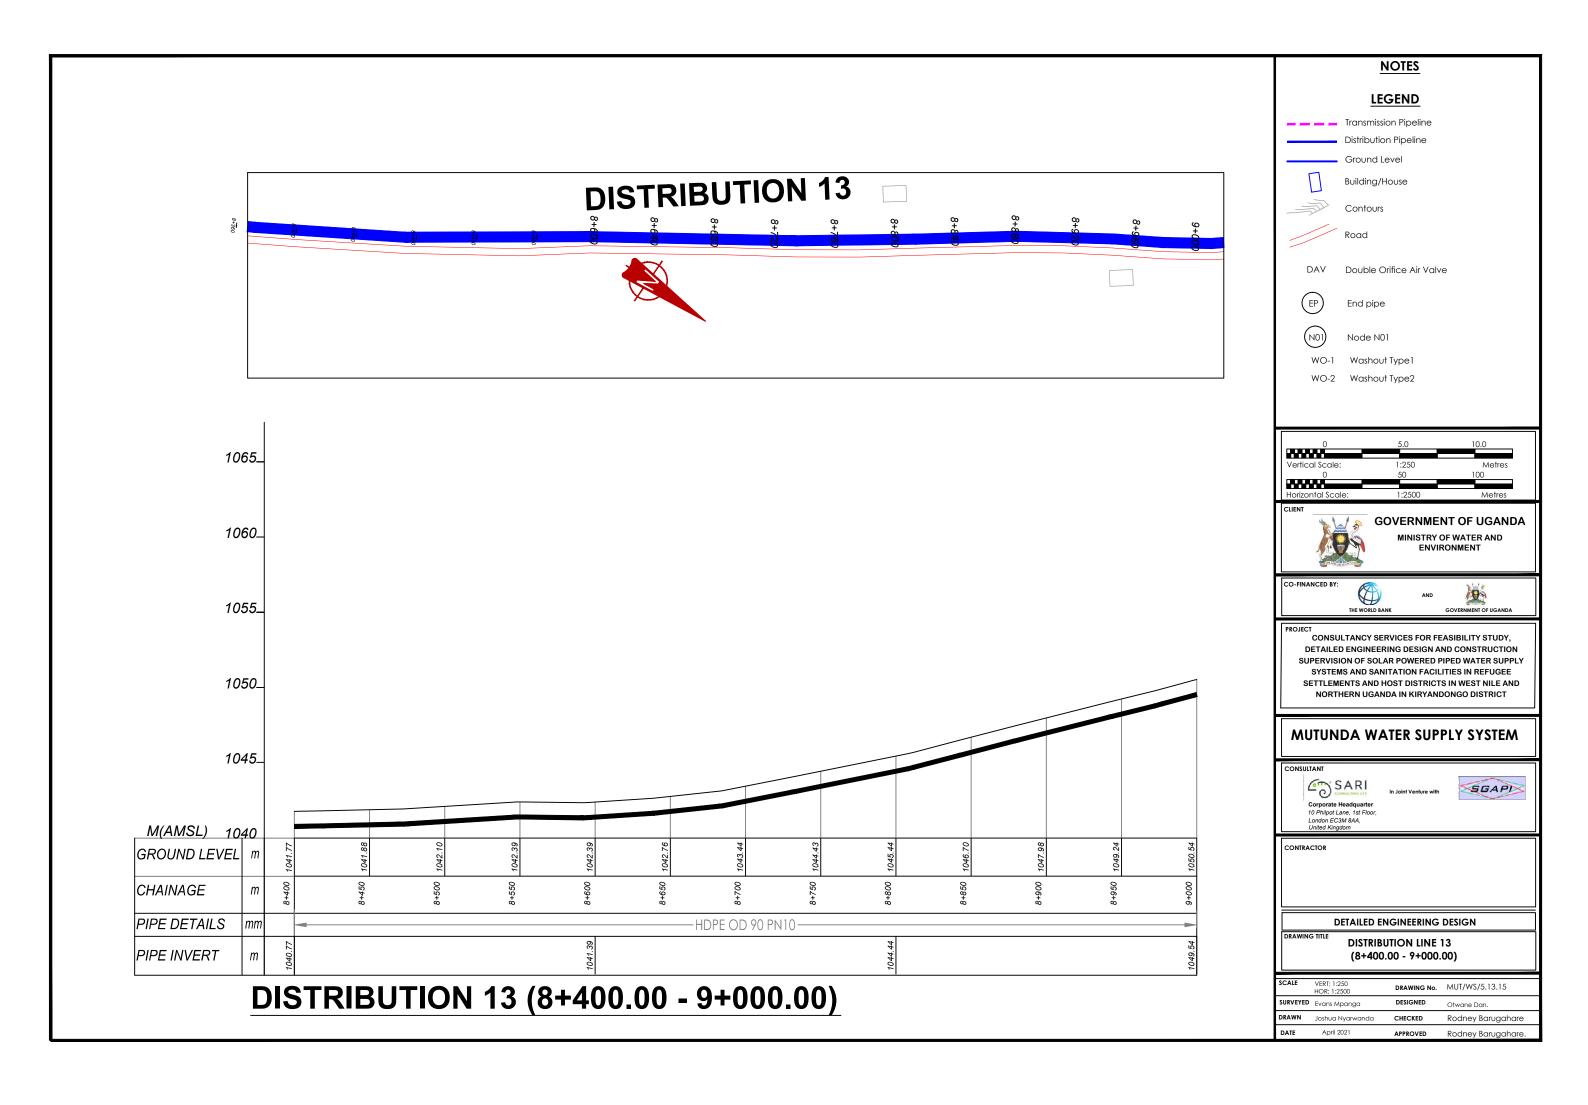


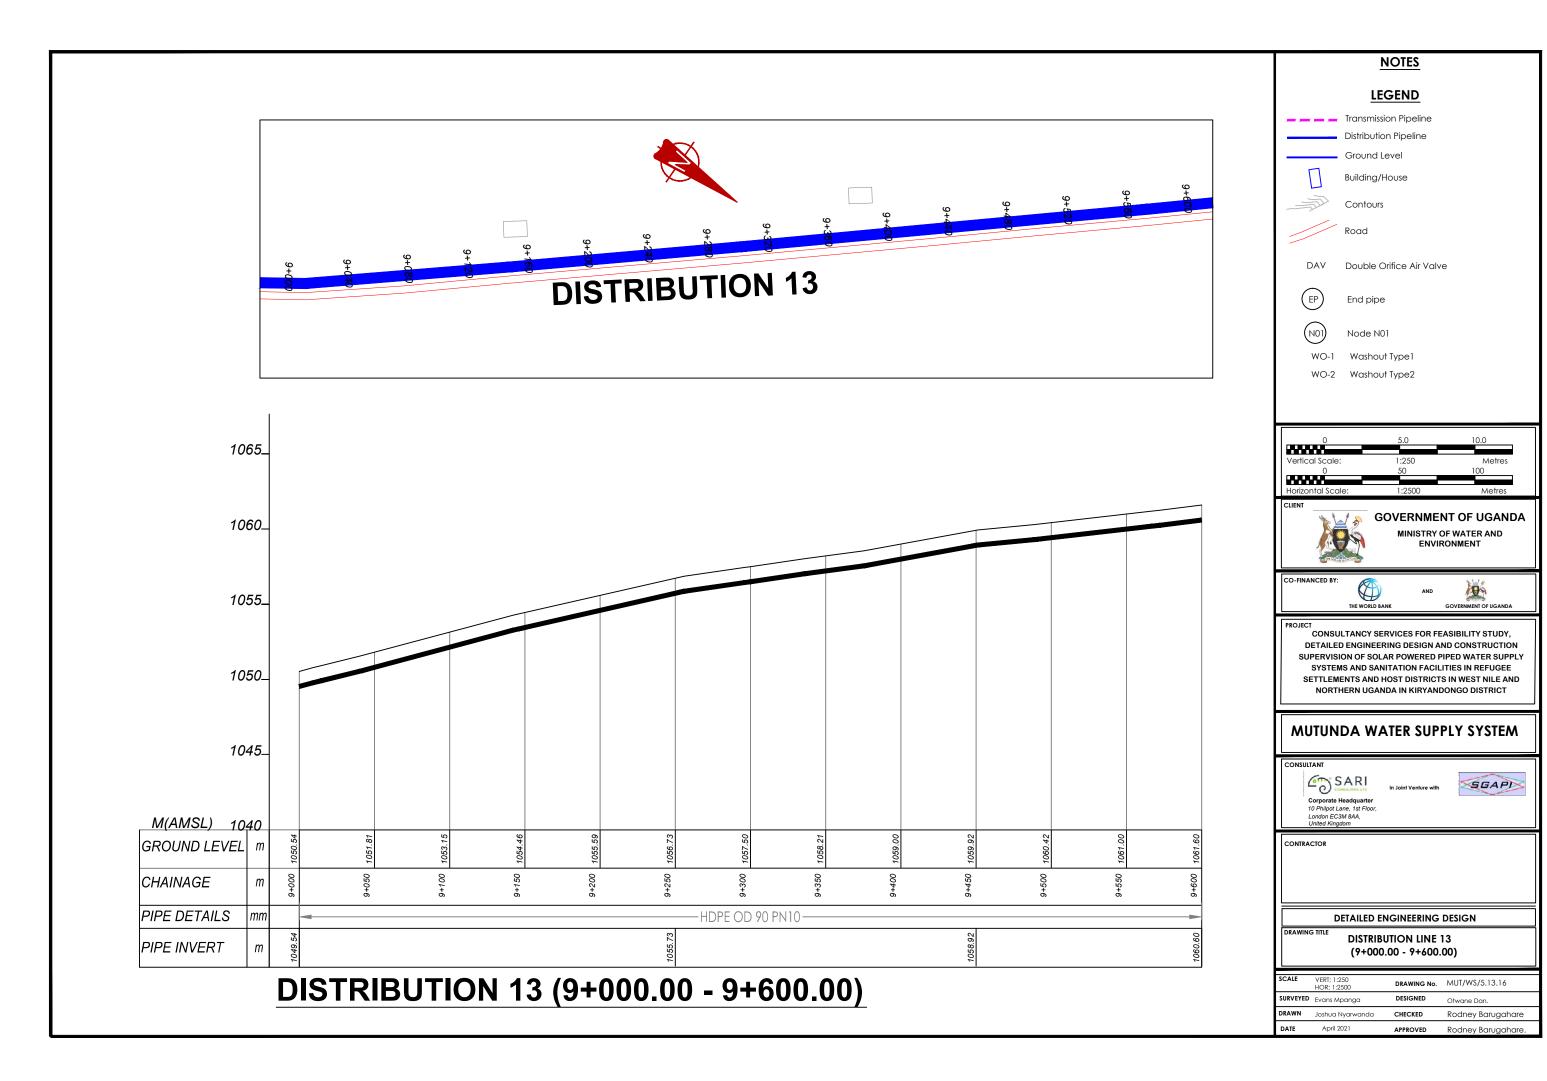

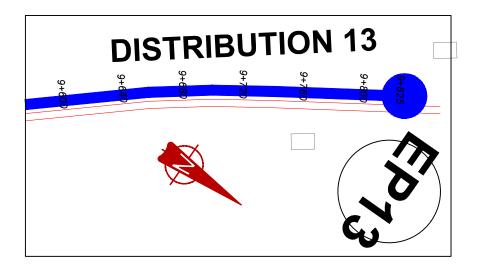

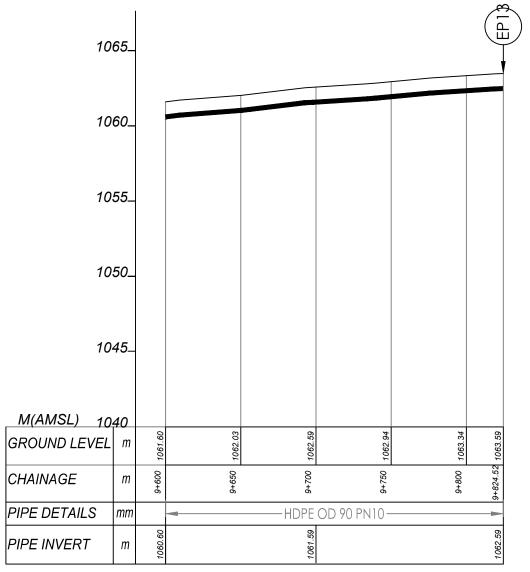

DISTRIBUTION 13 (9+600.00 - 9+824.52)

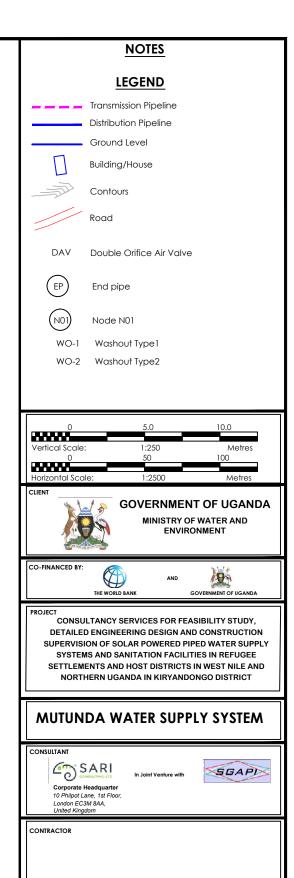


DETAILED ENGINEERING DESIGN
DISTRIBUTION LINE 13

(9+600.00 - 9+824.52)

CHECKED

Rodney Barugahare

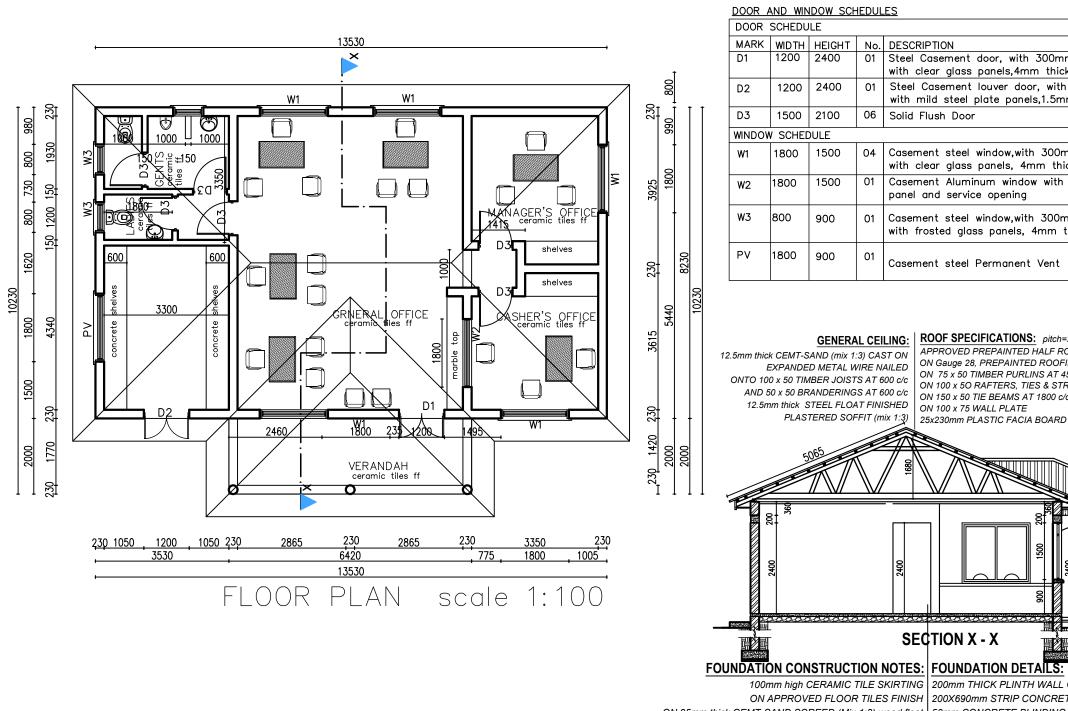


DOOR AND WINDOW SCHEDULES

DOOR	DOOR SCHEDULE					
MARK	WIDTH	HEIGHT	No.	DESCRIPTION		
D1	1200	2400	01	Steel Casement door, with 300mm vent over with clear glass panels,4mm thick		
D2	1200	2400	01	Steel Casement louver door, with 300mm vent over with mild steel plate panels,1.5mm thick		
D3	1500	2100	06	Solid Flush Door		
WINDOV	SCHEE	ULE				
W1	1800	1500	04	Casement steel window, with 300mm vent over with clear glass panels, 4mm thick		
W2	1800	1500	01	Casement Aluminum window with 4mm thick glass panel and service opening		
W3	800	900	01	Casement steel window,with 300mm vent over with frosted glass panels, 4mm thick		
PV	1800	900	01	Casement steel Permanent Vent		

12.5mm thick CEMT-SAND (mix 1:3) CAST ON EXPANDED METAL WIRE NAILED ONTO 100 x 50 TIMBER JOISTS AT 600 c/c AND 50 x 50 BRANDERINGS AT 600 c/c 12.5mm thick STEEL FLOAT FINISHED PLASTERED SOFFIT (mix 1:3)

GENERAL CEILING: | ROOF SPECIFICATIONS: pitch=22.5° APPROVED PREPAINTED HALF ROUND RIDGE ON Gauge 28, PREPAINTED ROOFING IRON TILE SHEETS ON 75 x 50 TIMBER PURLINS AT 450 c/c ON 100 x 50 RAFTERS, TIES & STRUTS SUPPORTED ON 150 x 50 TIE BEAMS AT 1800 c/c ON 100 x 75 WALL PLATE 25x230mm PLASTIC FACIA BOARD

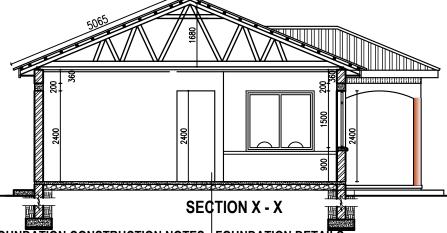

100mm high CERAMIC TILE SKIRTING 200mm THICK PLINTH WALL ON ON 25mm thick CEMT-SAND SCREED (Mix 1:3) wood float | 50mm CONCRETE BLINDING ON ON 100mm thick OVERSITE CONCRETE SLAB (Mix 1:3:6) APPROVED LOAD BEARING SOIL ON 1000 gauge POLYETHENE DPM ON FOUNDATION DEPTH TO BE DETERMINED ON SITE ON 150 Minimum SAND BLINDED HARDCORE ON COMPACTED EARTH / MURRAM

ON APPROVED FLOOR TILES FINISH | 200X690mm STRIP CONCRETE FOUNDATION ON

NOTES

- 1. All dimensions are in mm unless stated otherwise.
- 2. All levels are in metres above sea level.
- 3. For Site location see Dwg. GOD/0.0.0
- 4. Structural details are not included. 5. All structural concrete is Class 25/10.
- 6. All mass concrete is Class 15/10.



GOVERNMENT OF UGANDA MINISTRY OF WATER AND ENVIRONMENT



99

CONSULTANCY SERVICES FOR FEASIBILITY STUDY,

DETAILED ENGINEERING DESIGN AND CONSTRUCTION SUPERVISION OF SOLAR POWERED PIPED WATER SUPPLY SYSTEMS AND SANITATION FACILITIES IN REFUGEE SETTLEMENTS AND HOST DISTRICTS IN WEST NILE AND NORTHERN UGANDA IN KIRYANDONGO DISTRICT


MUTUNDA WATER SUPPLY SYSTEM




DETAILED ENGINEERING DESIGN

WATER OFFICE FLOOR PLAN & SECTION

SCALE	As Shown	DRAWING No.	MUT/WS/7.1
SURVEYED	ı	DESIGNED	Otwane Dan.
DRAWN	Joshua Nyarwanda	CHECKED	Rodney Barugahare
DATE	OCT 2021	APPROVED	Rodney Barugahare.

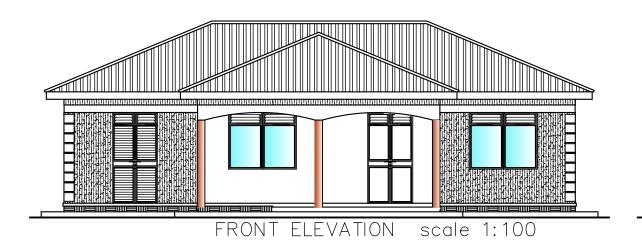



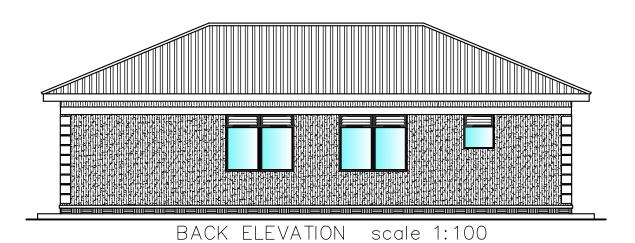





GOVERNMENT OF UGANDA MINISTRY OF WATER AND ENVIRONMENT





CONSULTANCY SERVICES FOR FEASIBILITY STUDY, DETAILED ENGINEERING DESIGN AND CONSTRUCTION SUPERVISION OF SOLAR POWERED PIPED WATER SUPPLY SYSTEMS AND SANITATION FACILITIES IN REFUGEE SETTLEMENTS AND HOST DISTRICTS IN WEST NILE AND NORTHERN UGANDA IN KIRYANDONGO DISTRICT

MUTUNDA WATER SUPPLY SYSTEM


SGAPI

CONTRACTOR


DETAILED ENGINEERING DESIGN

WATER OFFICE ELEVATIONS

SCALE	As Shown	DRAWING No.	MUT/WS/7.2
SURVEYED)	DESIGNED	Otwane Dan.
DRAWN	Joshua Nyarwanda	CHECKED	Rodney Barugahare
DATE	OCT 2021	APPROVED	Rodney Barugahare.

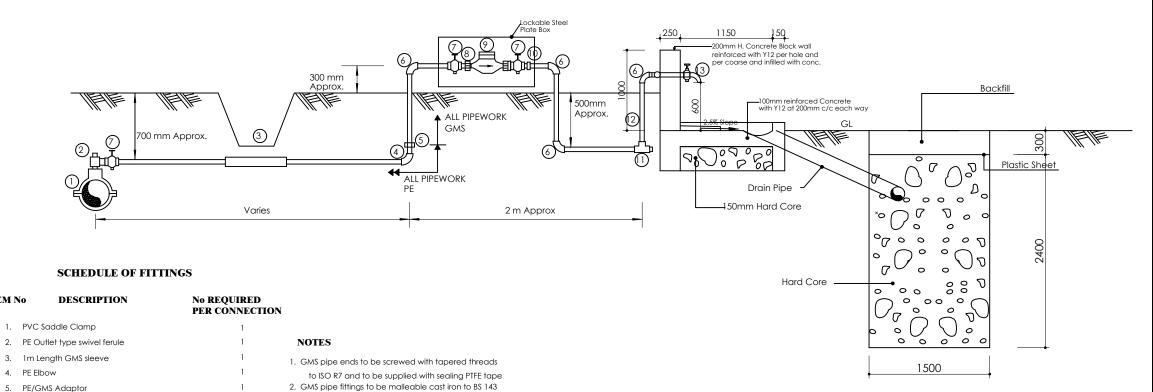

SECTION A-A

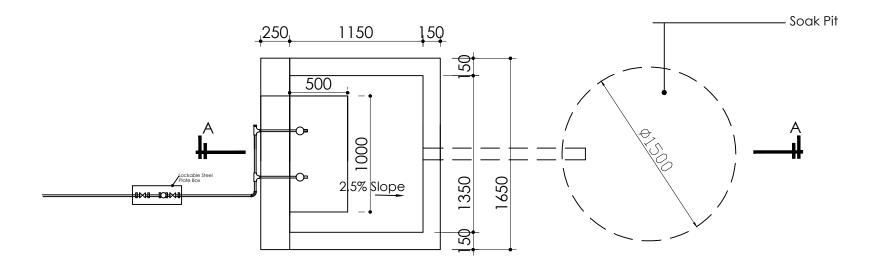

Standpost With 2 No. Faucets PLAN

and BS 1256 with female threaded ends

4. All PE connections shall be of the push fit type

permit removal at the meter

5. Diameter of pipe varies

The adjusting coupling shall be made of bronze or brass with a threaded female connection at the outlet end. It shall incorporate sufficient adjustment to

ITEM No

6. GMS Elbow

9. Water meter

10. Adjusting coupling 11. GMS equal tee 12. Plug 13. Tap

8. Male threaded connector

7. Stop tap

NOTES

- 1. For site location see dwg. MUT/WS/0.0.0
- 2. All levels in metres above mean sea level
- 3. Unless otherwise stated, all dimensions are in mm
- 4. Check all dimensions and elevations on site



GOVERNMENT OF UGANDA

MINISTRY OF WATER AND ENVIRONMENT





CONSULTANCY SERVICES FOR FEASIBILITY STUDY, DETAILED ENGINEERING DESIGN AND CONSTRUCTION SUPERVISION OF SOLAR POWERED PIPED WATER SUPPLY SYSTEMS AND SANITATION FACILITIES IN REFUGEE SETTLEMENTS AND HOST DISTRICTS IN WEST NILE AND NORTHERN UGANDA IN KIRYANDONGO DISTRICT

MUTUNDA WATER SUPPLY SYSTEM






CONTRACTOR

DETAILED ENGINEERING DESIGN

PUBLIC STAND POST CONNECTION AND SOAK PIT DETAILS

SCALE		DRAWING No.	MUT/WS/8.1.1
SURVEYED		DESIGNED	Otwane Dan.
DRAWN	Joshua Nyarwanda	CHECKED	Rodney Barugahare
DATE	OCT 2021	APPROVED	Rodney Barugahare.

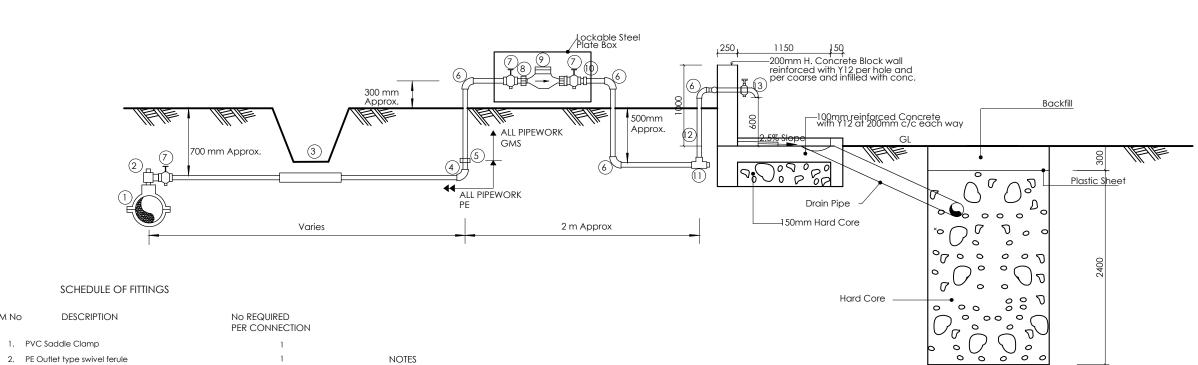

NOTES , o 1. GMS pipe ends to be screwed with tapered threads 2000

to ISO R7 and to be supplied with sealing PTFE tape

2. GMS pipe fittings to be malleable cast iron to BS 143 and BS 1256 with female threaded ends

3. The adjusting coupling shall be made of bronze or brass with a threaded female connection at the outlet end. It shall incorporate sufficient adjustment to permit removal at the meter

- 4. All PE connections shall be of the push fit type
- 5. Diameter of pipe varies

ITEM No

DESCRIPTION

1. PVC Saddle Clamp

3. 1m Length GMS sleeve

8. Male threaded connector

10. Adjusting coupling 11. GMS equal tee 12. Plug

5. PE/GMS Adaptor

4. PE Elbow

6. GMS Elbow

Stop tap

13. Tap

NOTES

- 1. For site location see dwg. MUT/WS/0.0.0
- 2. All levels in metres above mean sea level
- 3. Unless otherwise stated, all dimensions are in mm
- 4. Check all dimensions and elevations on site



GOVERNMENT OF UGANDA

MINISTRY OF WATER AND ENVIRONMENT





CONSULTANCY SERVICES FOR FEASIBILITY STUDY, DETAILED ENGINEERING DESIGN AND CONSTRUCTION SUPERVISION OF SOLAR POWERED PIPED WATER SUPPLY SYSTEMS AND SANITATION FACILITIES IN REFUGEE SETTLEMENTS AND HOST DISTRICTS IN WEST NILE AND NORTHERN UGANDA IN KIRYANDONGO DISTRICT

MUTUNDA WATER SUPPLY SYSTEM







CONTRACTOR


DETAILED ENGINEERING DESIGN

TYPICAL YARD CONNECTION CONNECTION AND SOAK PIT DETAILS

SCALE	As Shown	DRAWING No.	MUT/W/8.1.2
SURVEYED)	DESIGNED	Otwane Dan.
DRAWN	Joshua Nyarwanda	CHECKED	Rodney Barugahare
DATE	OCT 2021	APPROVED	Rodney Barugahare.

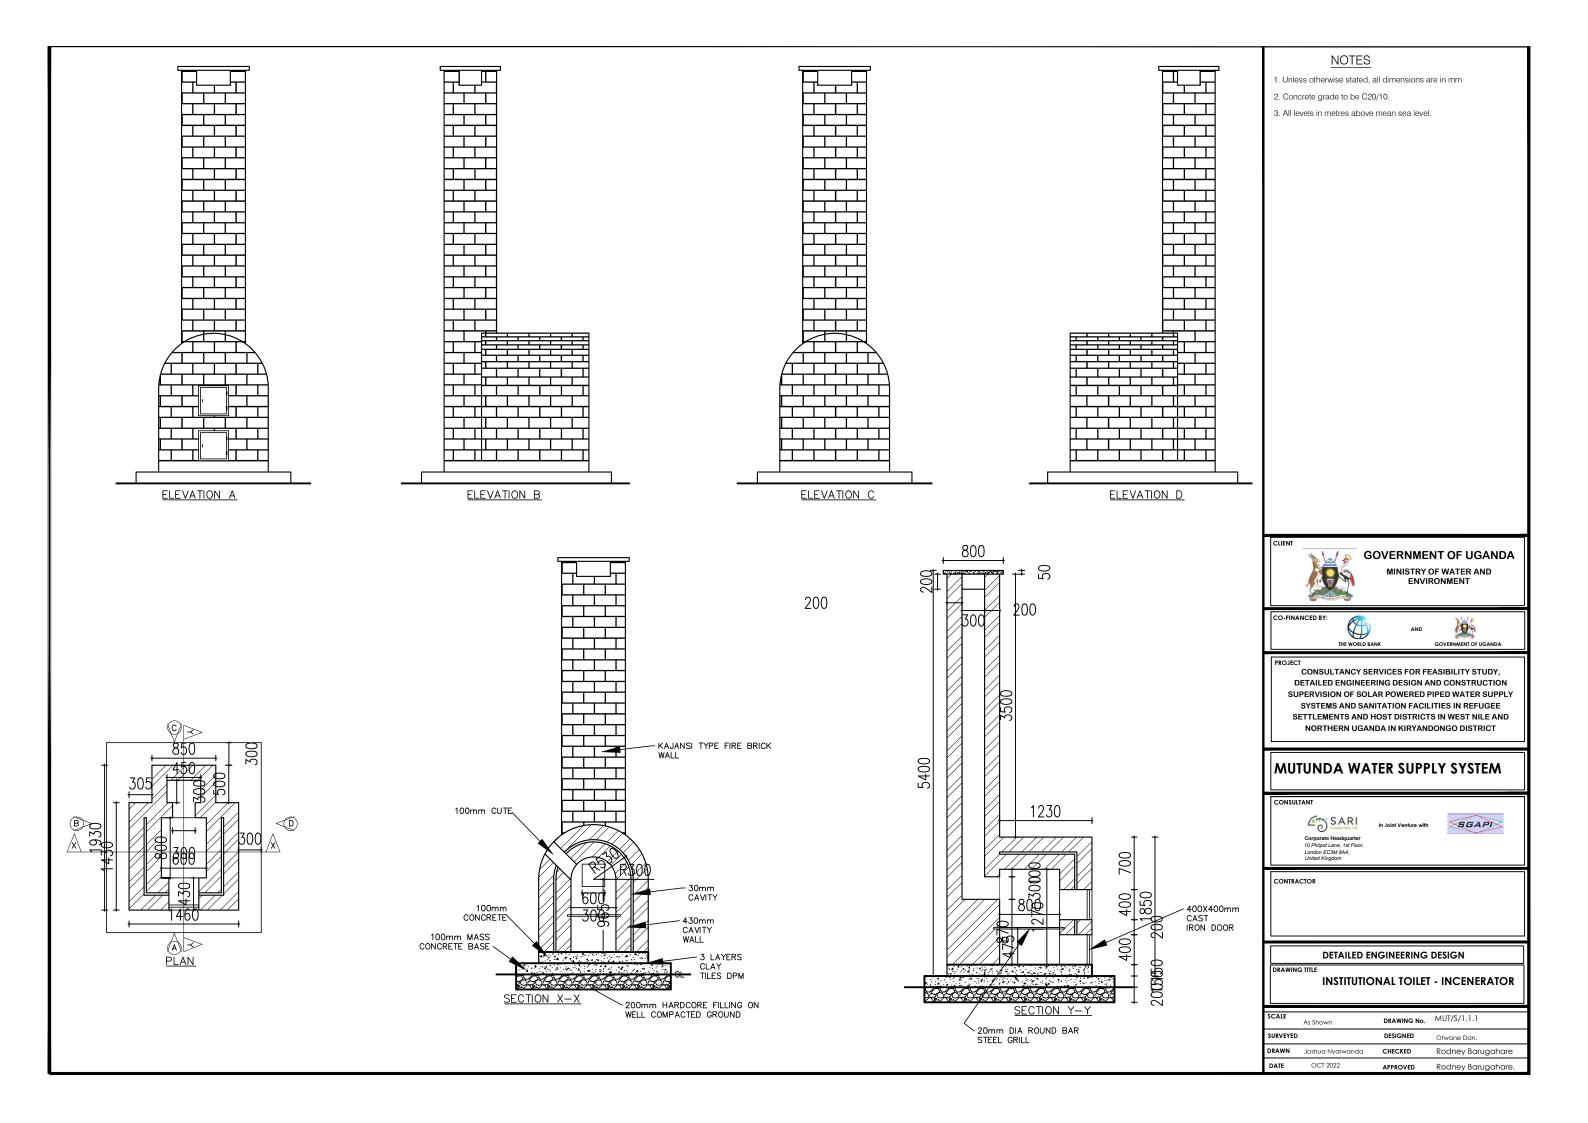

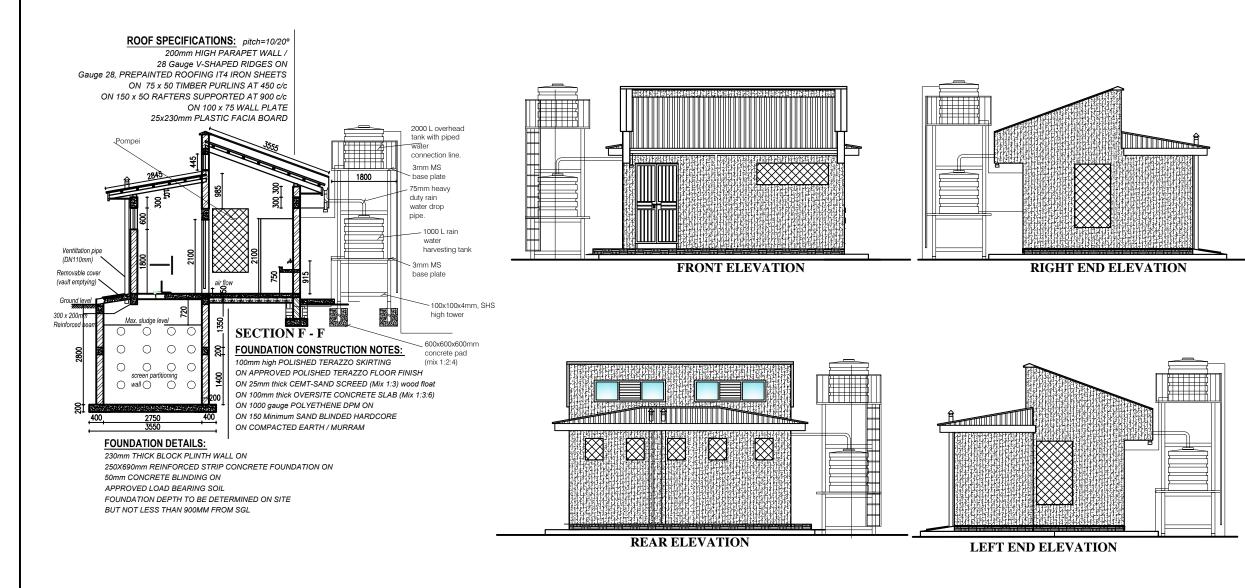

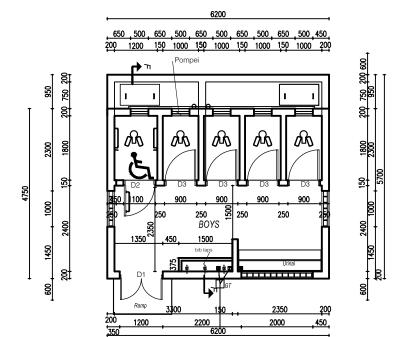

FLOOR PLAN



Mark D1/pv D2 D3 W3/pv Quantity 2 No. 1 No. 6 No. 02 No. Type & Remarks Lockable, mahogany hardwood timber-frame and solid TNG door. Type & Remarks Lockable, mahogany hardwood timber-frame and solid TNG door. Standard solid flush door lockable both internally and externally with low level indicator locks complete with grab bar both internally and externally and externally with indicator locks with centered permanent vent.

NOTES

- 1. Unless otherwise stated, all dimensions are in mm
- 2. Concrete grade to be C20/10.
- 3. All levels in metres above mean sea level.



GOVERNMENT OF UGANDA

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AND



PROJECT

CONSULTANCY SERVICES FOR FEASIBILITY STUDY,
DETAILED ENGINEERING DESIGN AND CONSTRUCTION
SUPERVISION OF SOLAR POWERED PIPED WATER SUPPLY
SYSTEMS AND SANITATION FACILITIES IN REFUGEE
SETTLEMENTS AND HOST DISTRICTS IN WEST NILE AND
NORTHERN UGANDA IN KIRYANDONGO DISTRICT

MUTUNDA WATER SUPPLY SYSTEM

CONSULTANT

Corporate Headquarter
10 Philipot Lane, 1st Floor,
London ECSM 8AA,
United Kingdom

n Joint Venture with




CONTRACTOR

DETAILED ENGINEERING DESIGN


INSTITUTIONAL TOILET - BOYS

SCALE	As Shown	DRAWING No.	MUT/S/1.1.2
SURVEYED		DESIGNED	Otwane Dan.
DRAWN	Joshua Nyarwanda	CHECKED	Rodney Barugahare
DATE	OCT 2022	APPROVED	Rodney Barugahare.

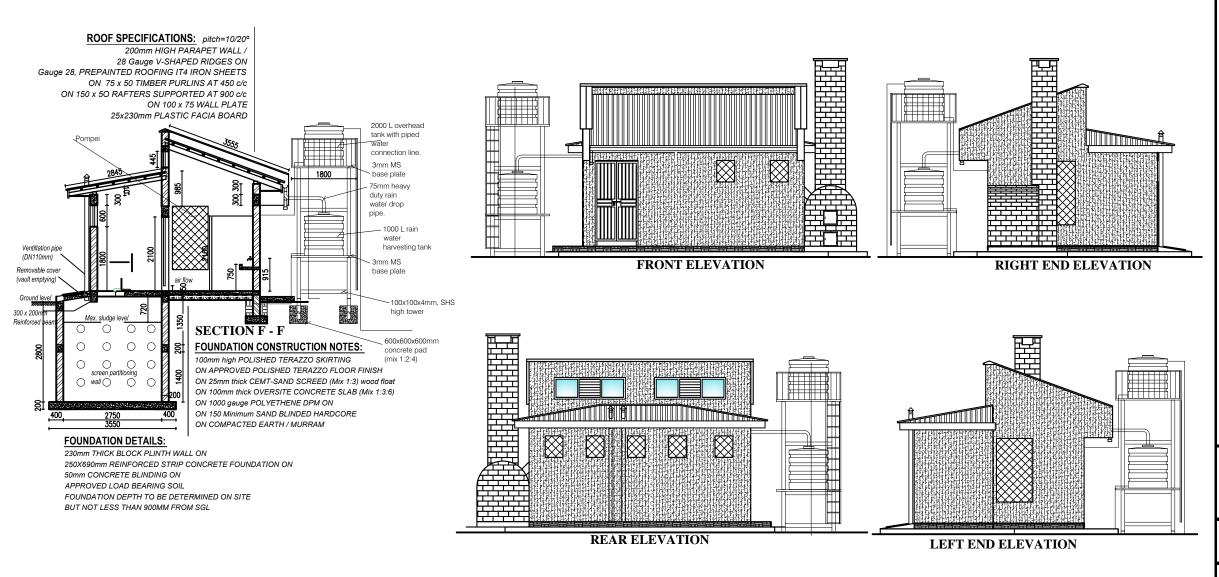

650 500 650 500 650 500 650 500 650 500 450 200 1200 150 1000 150 1000 150 1000 150 1000 200 750 200 950 좗 250 GIRLS 55 Ramp 1200 500 650 500 450

FLOOR PLAN

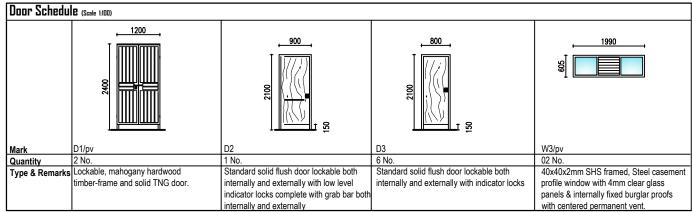

DOOR AND WINDOW SCHEDULE

NOTES

- 1. Unless otherwise stated, all dimensions are in mm
- 2. Concrete grade to be C20/10.
- 3. All levels in metres above mean sea level.



GOVERNMENT OF UGANDA

MINISTRY OF WATER AND **ENVIRONMENT**



CONSULTANCY SERVICES FOR FEASIBILITY STUDY, DETAILED ENGINEERING DESIGN AND CONSTRUCTION SUPERVISION OF SOLAR POWERED PIPED WATER SUPPLY SYSTEMS AND SANITATION FACILITIES IN REFUGEE SETTLEMENTS AND HOST DISTRICTS IN WEST NILE AND NORTHERN UGANDA IN KIRYANDONGO DISTRICT

MUTUNDA WATER SUPPLY SYSTEM


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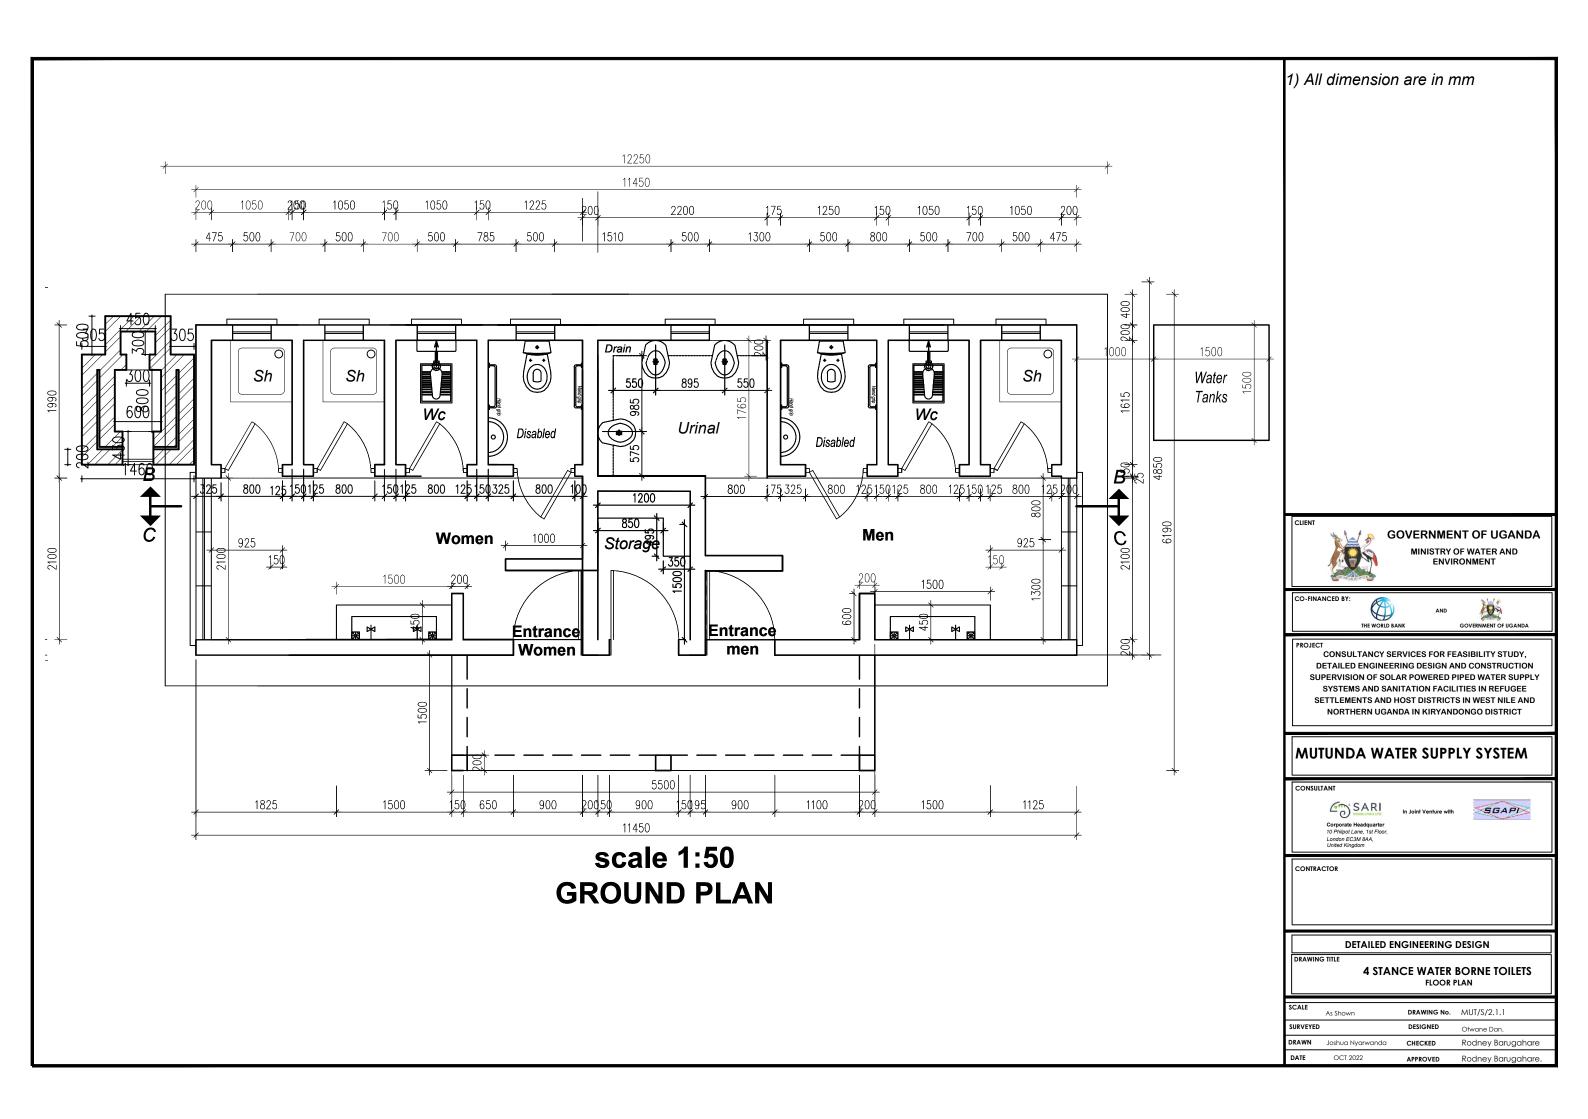



DETAILED ENGINEERING DESIGN


INSTITUTIONAL TOILET - GIRLS

SCALE	As Shown	DRAWING No.	MUT/S/1.1.3
SURVEYED		DESIGNED	Otwane Dan.
DRAWN	Joshua Nyarwanda	CHECKED	Rodney Barugahare
DATE	OCT 2022	APPROVED	Rodney Barugahare.




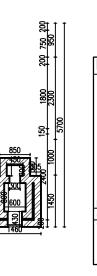

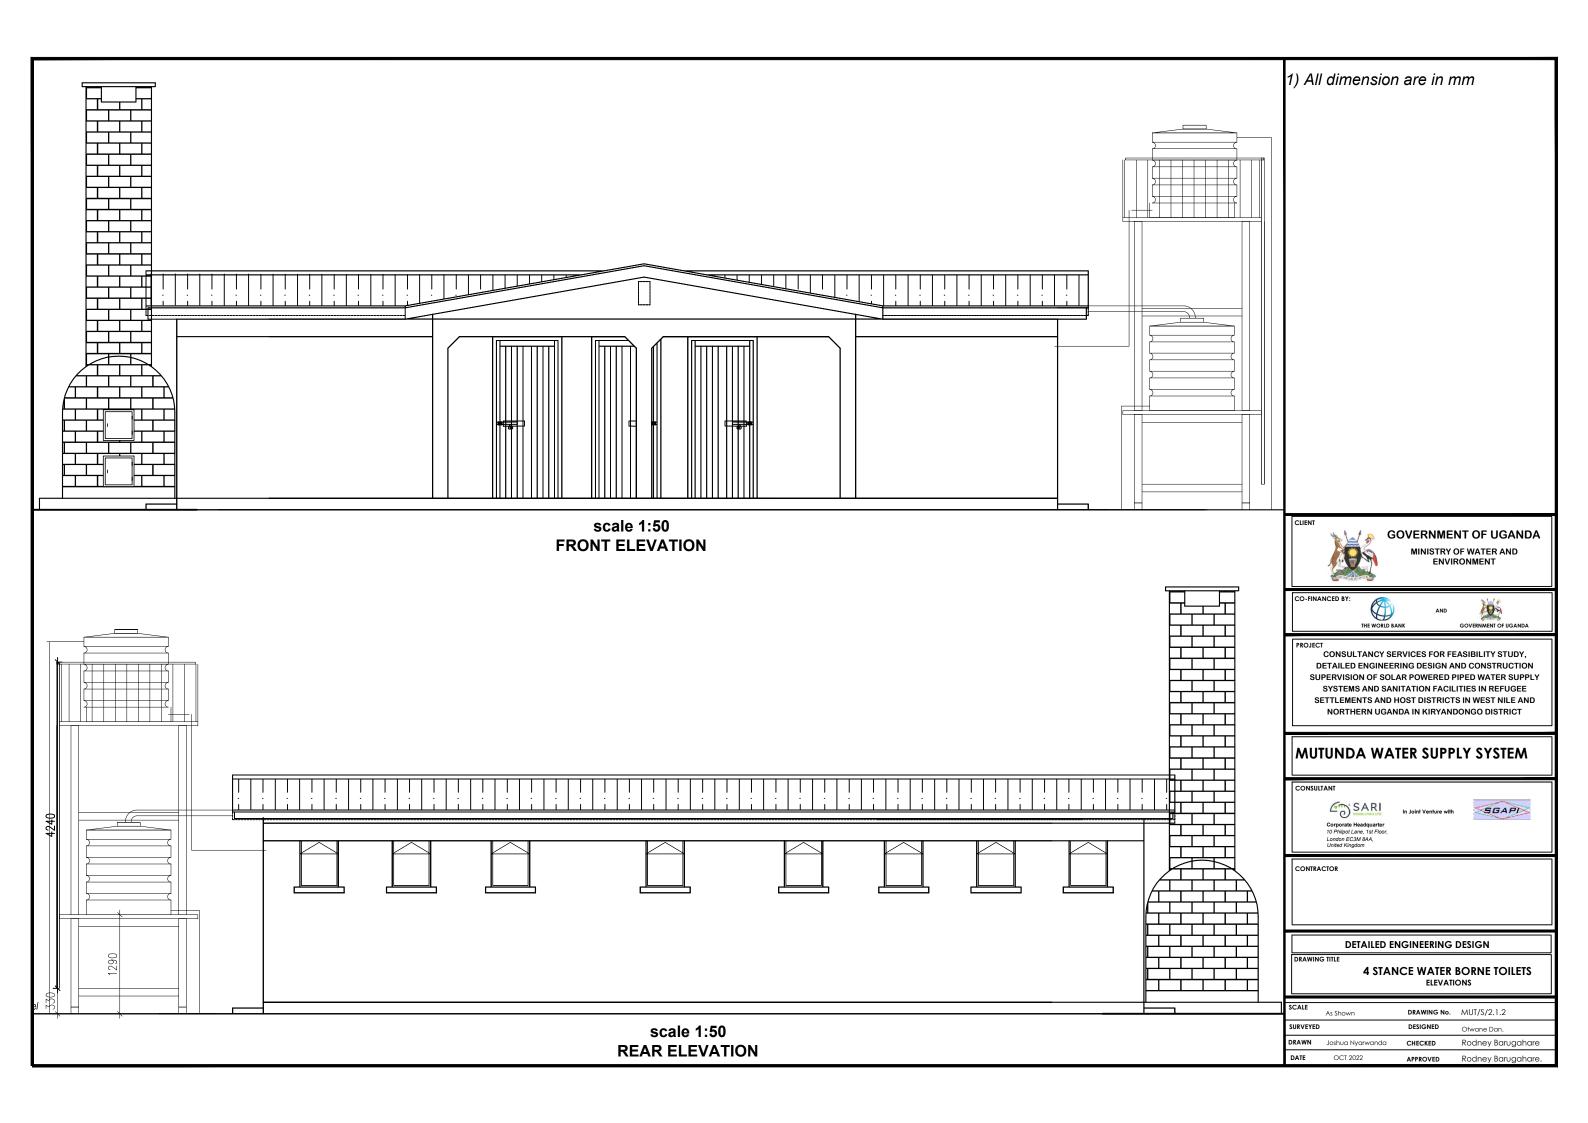

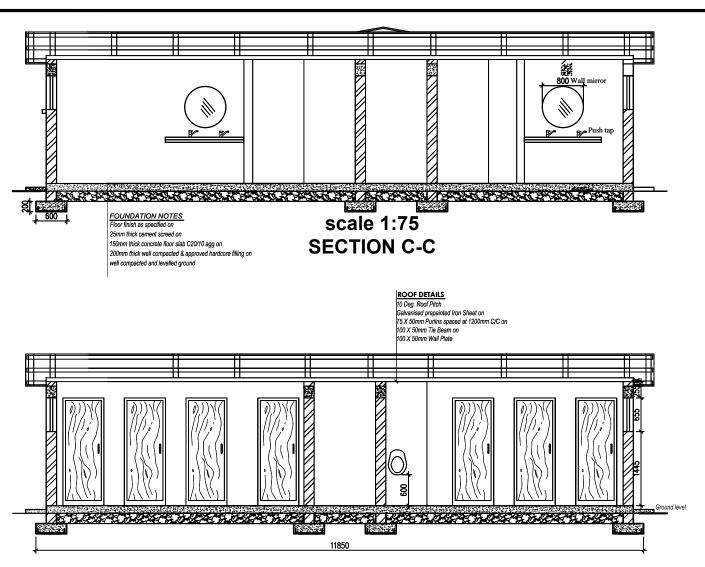

scale 1:75 SECTION B-B

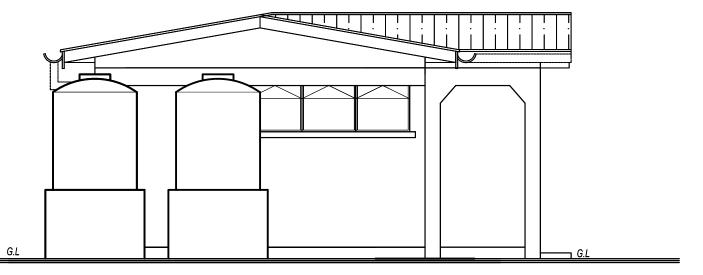

scale 1:50 SIDE VIEW

1) All dimension are in mm



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CONSULTANCY SERVICES FOR FEASIBILITY STUDY,
DETAILED ENGINEERING DESIGN AND CONSTRUCTION
SUPERVISION OF SOLAR POWERED PIPED WATER SUPPLY
SYSTEMS AND SANITATION FACILITIES IN REFUGEE
SETTLEMENTS AND HOST DISTRICTS IN WEST NILE AND
NORTHERN LIGANDA IN KIRYANDONGO DISTRICT

MUTUNDA WATER SUPPLY SYSTEM

CONSULTAN



In Joint Venture with

SGAPI


CONTRACTOR

DETAILED ENGINEERING DESIGN


DRAWING

4 STANCE WATER BORNE TOILETS SECTIONS AND ELEVATIONS

SCALE	As Shown	DRAWING No.	MUT/S/2.1.3
SURVEYED		DESIGNED	Otwane Dan.
DRAWN	Joshua Nyarwanda	CHECKED	Rodney Barugahare
DATE	OCT 2022	APPROVED	Rodney Barugahare.

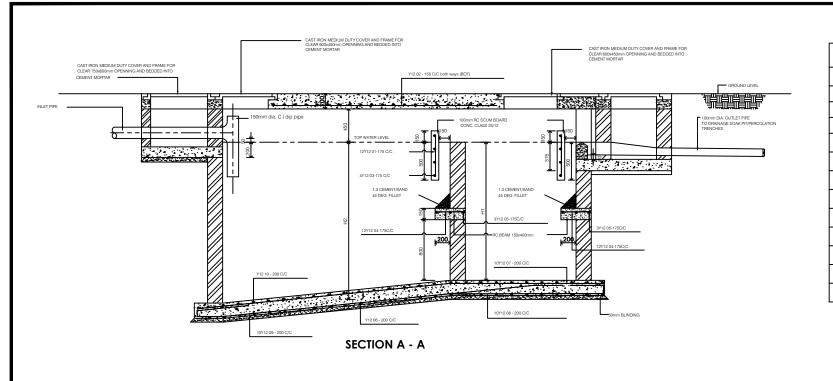


	INTERNAL D	CAPACITY	NO. OF USERS			
L1	L2	H1	H2	В	Cu. M	
1540mm	760mm	1600mm	1750mm	760mm	3.2	10
1900mm	900mm	1800mm	2000mm	900mm	4.5	20
2000mm	1000mm	1800mm	2100mm	1100mm	5.9	30
2400mm	1100mm	1800mm	2100mm	1150mm	7.24	40
2500mm	1200mm	1800mm	2100mm	1300mm	8.6	50
2700mm	1300mm	1800mm	2100mm	1400mm	10	60
29000mm	1400mm	1800mm	2100mm	1450mm	11.3	70
3000mm	1500mm	1800mm	2100mm	1560mm	12.7	80
3200mm	1600mm	1800mm	2100mm	1600mm	14	90
3300mm	1700mm	1800mm	2100mm	1700mm	15.4	100
4000mm	2200mm	1800mm	2100mm	2190mm	24	150
4500mm	2700mm	1800mm	2100mm	2650mm	34.3	200

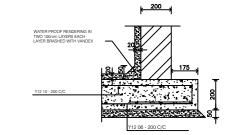


INTERNAL WATER PROOF TO WALLS AND SLABS

SCALE 1:10

SCALE 1:20

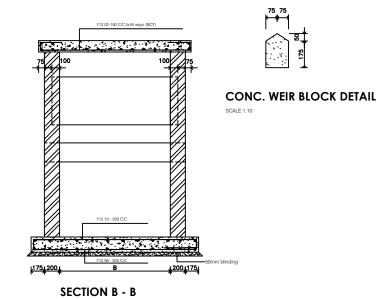

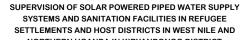

1) All dimension are in mm

SYSTEMS AND SANITATION FACILITIES IN REFUGEE SETTLEMENTS AND HOST DISTRICTS IN WEST NILE AND

CONSULTANCY SERVICES FOR FEASIBILITY STUDY,

DETAILED ENGINEERING DESIGN AND CONSTRUCTION

GOVERNMENT OF UGANDA MINISTRY OF WATER AND ENVIRONMENT


MUTUNDA WATER SUPPLY SYSTEM


SGAPI


DETAILED ENGINEERING DESIGN

WATER BORNE TOILETS
SEPTIC TANK DETAILS

CALE	As Shown	DRAWING No.	MUT/S/2.1.4
JRVEYED		DESIGNED	Otwane Dan.
RAWN	Joshua Nyarwanda	CHECKED	Rodney Barugahare
ATE	OCT 2022	APPROVED	Rodney Barugahare.

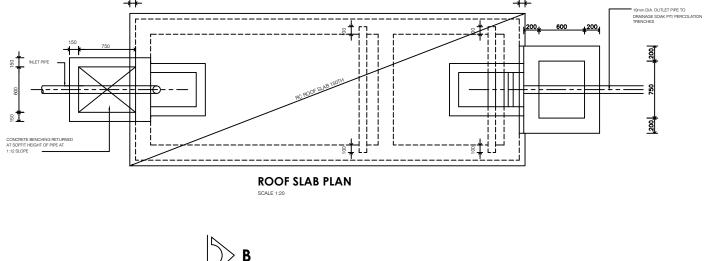

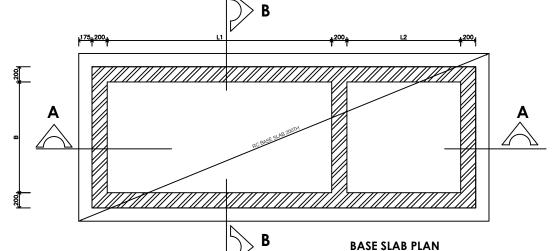

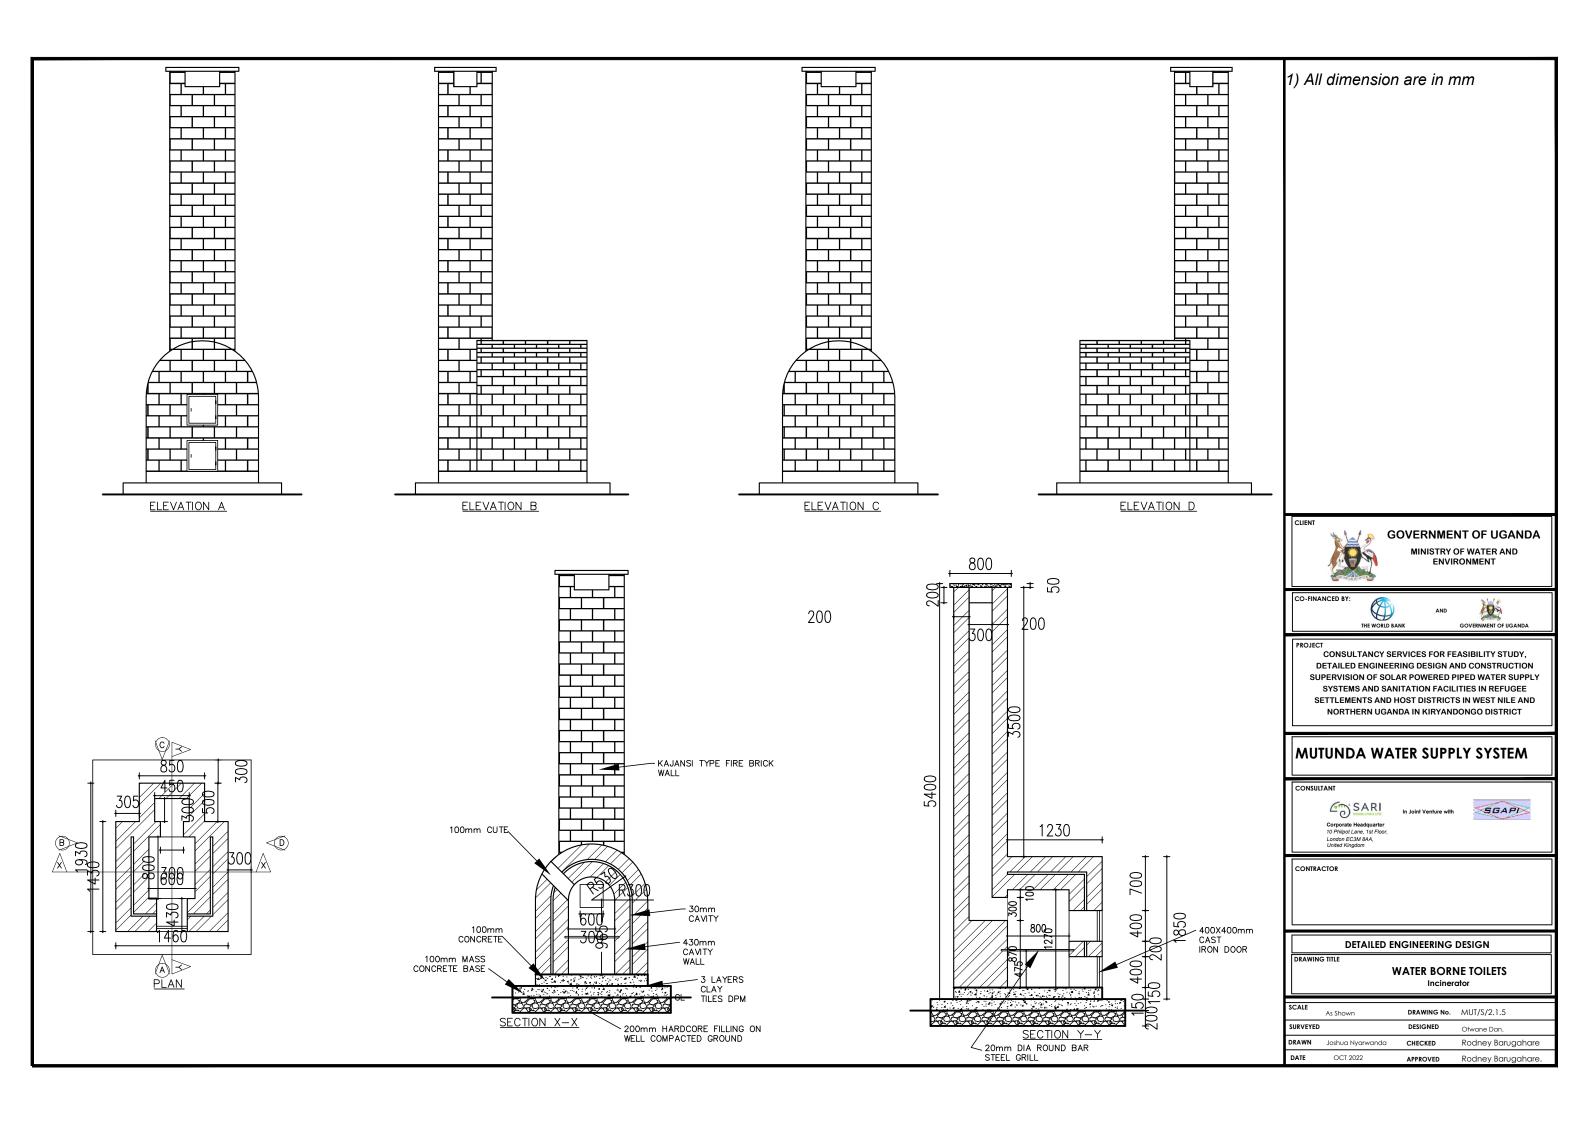

GENERAL NOTES FOR STANDARD DETAIL DRAWINGS

- 1) Unless flexibility is otherwise provided, where pipes enter or leave concrete structures, or anchor blocks, flexible joints are to be provided as shown in standard Detail Nr SD 137 .
- 2) Anchor block designs are based on the following ground conditions.

Dry soil density: 1800 kg/m³ Submerged soil density: 1090 kg/m³

Angle of internal friction: 30° Passive resistance factor: 3

Where considerably better ground conditions, such as rock, are encountered, the dimensions of anchor blocks may be reduced. Supporting calculations for any reduced size anchor blocks must be submitted to the Project Manager 48 hours before construction of the particular anchor block commences and may be concreted only after his approval.

- Bases and thrust faces of anchor blocks are to be cast against undisturbed ground, or against blinding cast against undisturbed ground.
- Pipework joints as shown for the water supply details are diagrammatic only.
- The following notes apply to reinforced concrete chambers.

a) Concrete in walls and base and cover slab

Characteristic strength (N/mm²): Maximum aggregate size (mm): Cement type: Minimum cement content (kg/m³): Maximum cement content (kg/m³): 400 Maximum free water/cement ratio: 0.47

b) Concrete in blinding

Characteristic strength (N/mm²): Maximum aggregate size (mm): 40 Cement type: Minimum cement content (kg/m³):

Cover to reinforcement 40mm unless positioned centrally

- d) Minimum reinforcement lap 300 mm
- For details of step irons see Standard Detail Nr SD 136
- Corners of rectangular openings to have T8 bars 500 mm long set diagonally
- All dimensions are in millimetres unless shown otherwise.
- Do not scale dimensions from standard Detail drawings.



GOVERNMENT OF UGANDA

MINISTRY OF WATER AND



CONSULTANCY SERVICES FOR FEASIBILITY STUDY, DETAILED ENGINEERING DESIGN AND CONSTRUCTION SUPERVISION OF SOLAR POWERED PIPED WATER SUPPLY SYSTEMS AND SANITATION FACILITIES IN REFUGEE SETTLEMENTS AND HOST DISTRICTS IN WEST NILE AND NORTHERN UGANDA IN KIRYANDONGO DISTRICT

MUTUNDA WATER SUPPLY SYSTEM








CONTRACTOR

DETAILED ENGINEERING DESIGN **GENERAL NOTES FOR STANDARD DRAWINGS**

SCALE DRAWING No. SD100 DESIGNED SURVEYED DRAWN Joshua Nyarwanda CHECKED Rodney Barugahare DATE OCT 2021 Rodnev Baruaahare.

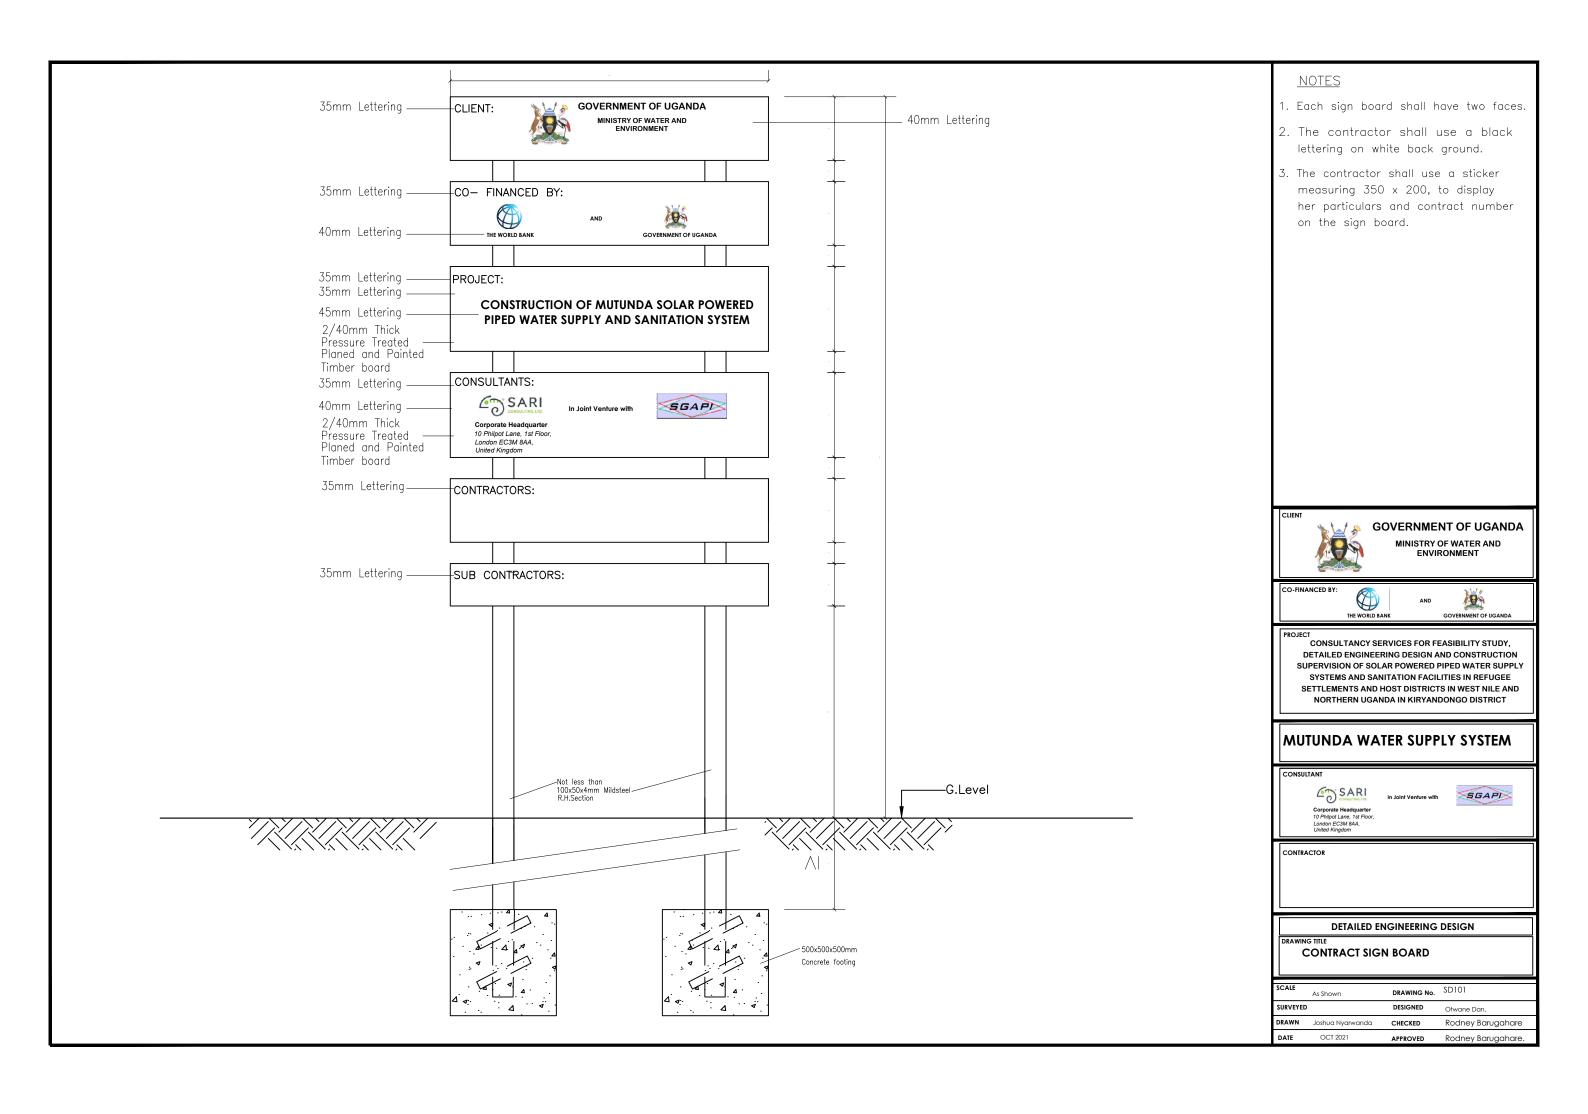

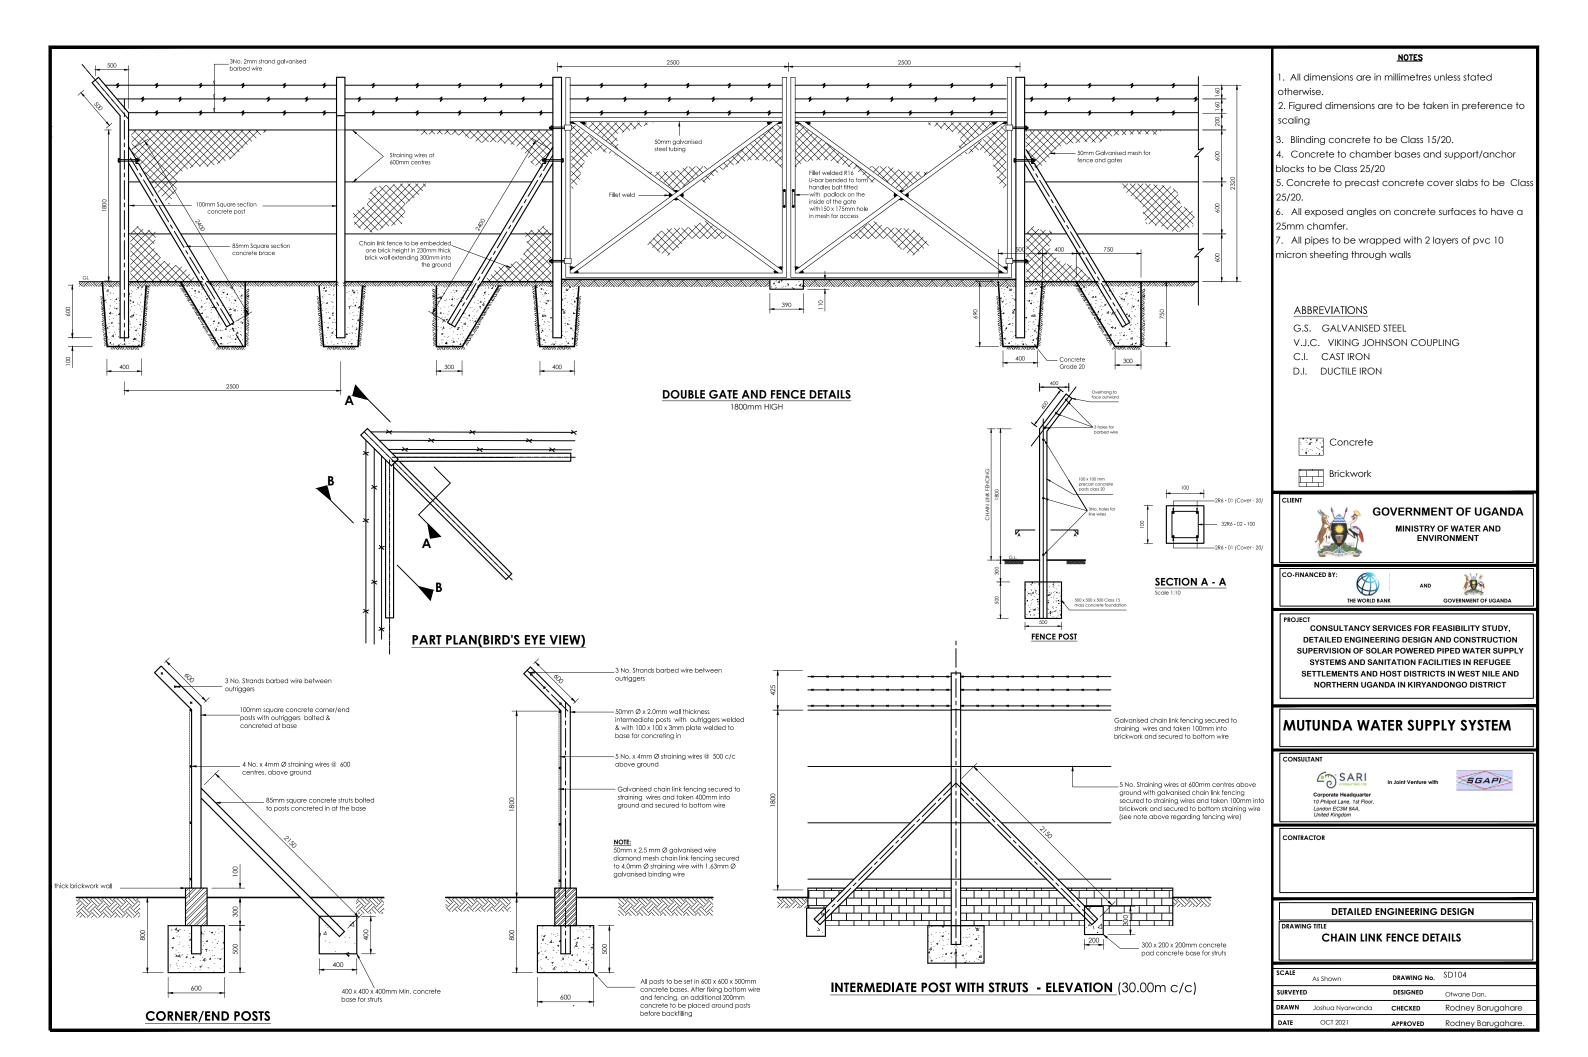

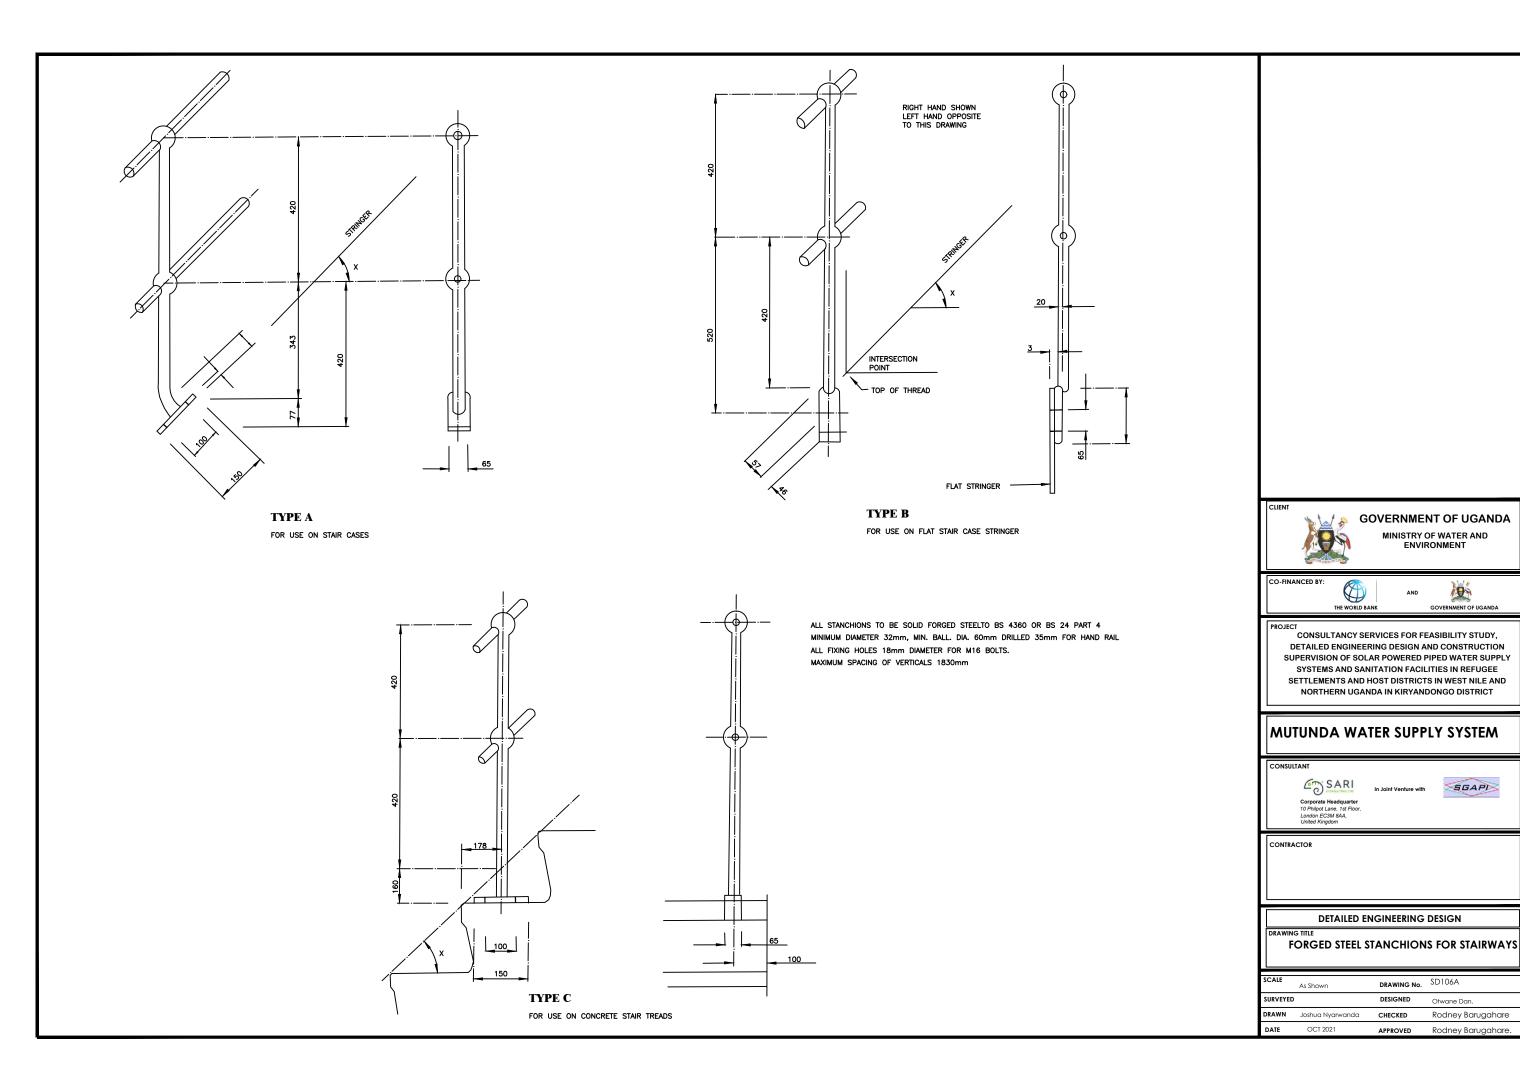

GOVERNMENT OF UGANDA

MINISTRY OF WATER AND ENVIRONMENT

SGAPI

Rodney Barugahare

CONSULTANCY SERVICES FOR FEASIBILITY STUDY,

DETAILED ENGINEERING DESIGN AND CONSTRUCTION

SYSTEMS AND SANITATION FACILITIES IN REFUGEE SETTLEMENTS AND HOST DISTRICTS IN WEST NILE AND NORTHERN UGANDA IN KIRYANDONGO DISTRICT

DETAILED ENGINEERING DESIGN

DESIGNED


CHECKED

DRAWING No. SD106A

SARI CONSULTERE LTO

Corporate Headquarter 10 Philpot Lane, 1st Floor, London EC3M 8AA, United Kingdom


OCT 2021

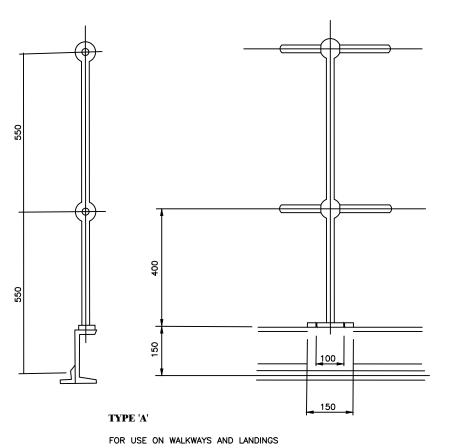

TYPE 'B'

FOR USE WITH 150 HIGH CONCRETE KERB

ALL STANCHIONS TO BE SOLID FORGED STEEL TO BS.4360 OR BS.24 PART 4, MIN DIA. 60mm, DRILLED 35mm DIA. FOR HANDRAIL. ALL FIXING HOLES 18mm DIA. FOR M16 BOLTS. MAXIMUM SPACING OF VERTICALS 1830mm.

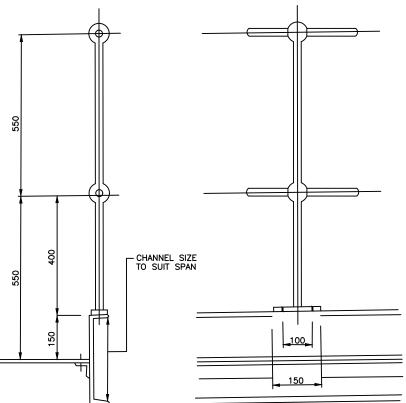

TYPE 'C'

FOR USE ON LONG SPAN WALKWAYS



GOVERNMENT OF UGANDA

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PROJECT

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SUPERVISION OF SOLAR POWERED PIPED WATER SUPPLY
SYSTEMS AND SANITATION FACILITIES IN REFUGEE
SETTLEMENTS AND HOST DISTRICTS IN WEST NILE AND
NORTHERN UGANDA IN KIRYANDONGO DISTRICT

MUTUNDA WATER SUPPLY SYSTEM

CONSULTANT



In Joint Venture with




CONTRACTOR


DETAILED ENGINEERING DESIGN

FORCED STEEL STANCHIONS FOR PLATFORMS AND WALKWAYS-1

SCALE	As Shown	DRAWING No.	SD106B
SURVEYED)	DESIGNED	Otwane Dan.
DRAWN	Joshua Nyarwanda	CHECKED	Rodney Barugahare
DATE	OCT 2021	APPROVED	Rodney Barugahare.

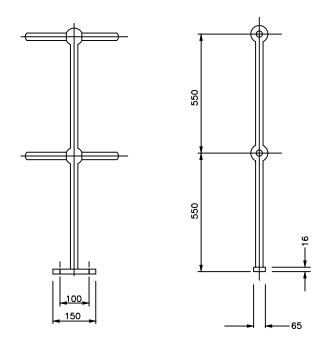


TYPE 'D' FOR USE ON FLAT SURFACES

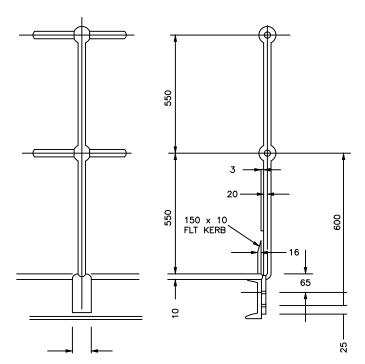


TYPE 'F'

FOR USE ON PLATFORMS HAVING 10 THK. CHEQUER PLATE DECKING

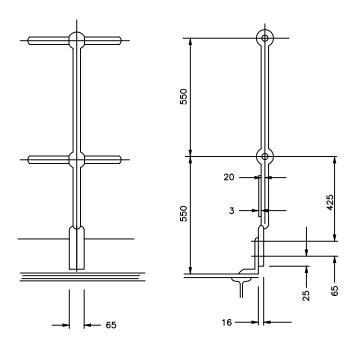

TYPE 'E' FOR USE ON KERB ANGLES

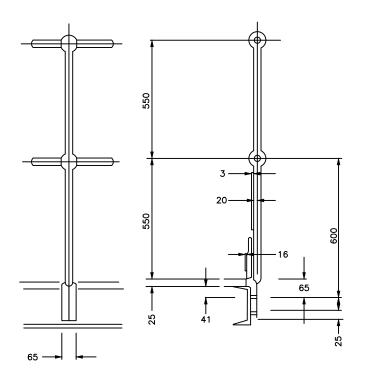

TYPE 'H'

FOR USE ON PLATFORMS HAVING 20 THK. OPEN GRILL DECKING

ALL STANCHIONS TO BE SOLID FORGED STEEL TO BSS. 4360 OR BS.24 PART 4 MIN DIA. 32mm MIN BALL DIA. 60mm. DRILLED 35mm DIA. FOR HANDRAIL ALL FIXING HOLES 18mm DIA. FOR M16 BOLTS. MAXIMUM SPACING OF VERTICALS 1830mm.



GOVERNMENT OF UGANDA MINISTRY OF WATER AND ENVIRONMENT





CONSULTANCY SERVICES FOR FEASIBILITY STUDY, DETAILED ENGINEERING DESIGN AND CONSTRUCTION SUPERVISION OF SOLAR POWERED PIPED WATER SUPPLY SYSTEMS AND SANITATION FACILITIES IN REFUGEE SETTLEMENTS AND HOST DISTRICTS IN WEST NILE AND NORTHERN UGANDA IN KIRYANDONGO DISTRICT

MUTUNDA WATER SUPPLY SYSTEM






CONTRACTOR

DETAILED ENGINEERING DESIGN

DRAWING TITLE FORCED STEEL STANCHIONS FOR PLATFORMS AND WALKWAYS-2

SCALE	As Shown	DRAWING No.	SD106C
SURVEYED		DESIGNED	Otwane Dan.
DRAWN	Joshua Nyarwanda	CHECKED	Rodney Barugahare
DATE	OCT 2021	APPROVED	Rodney Barugahare.

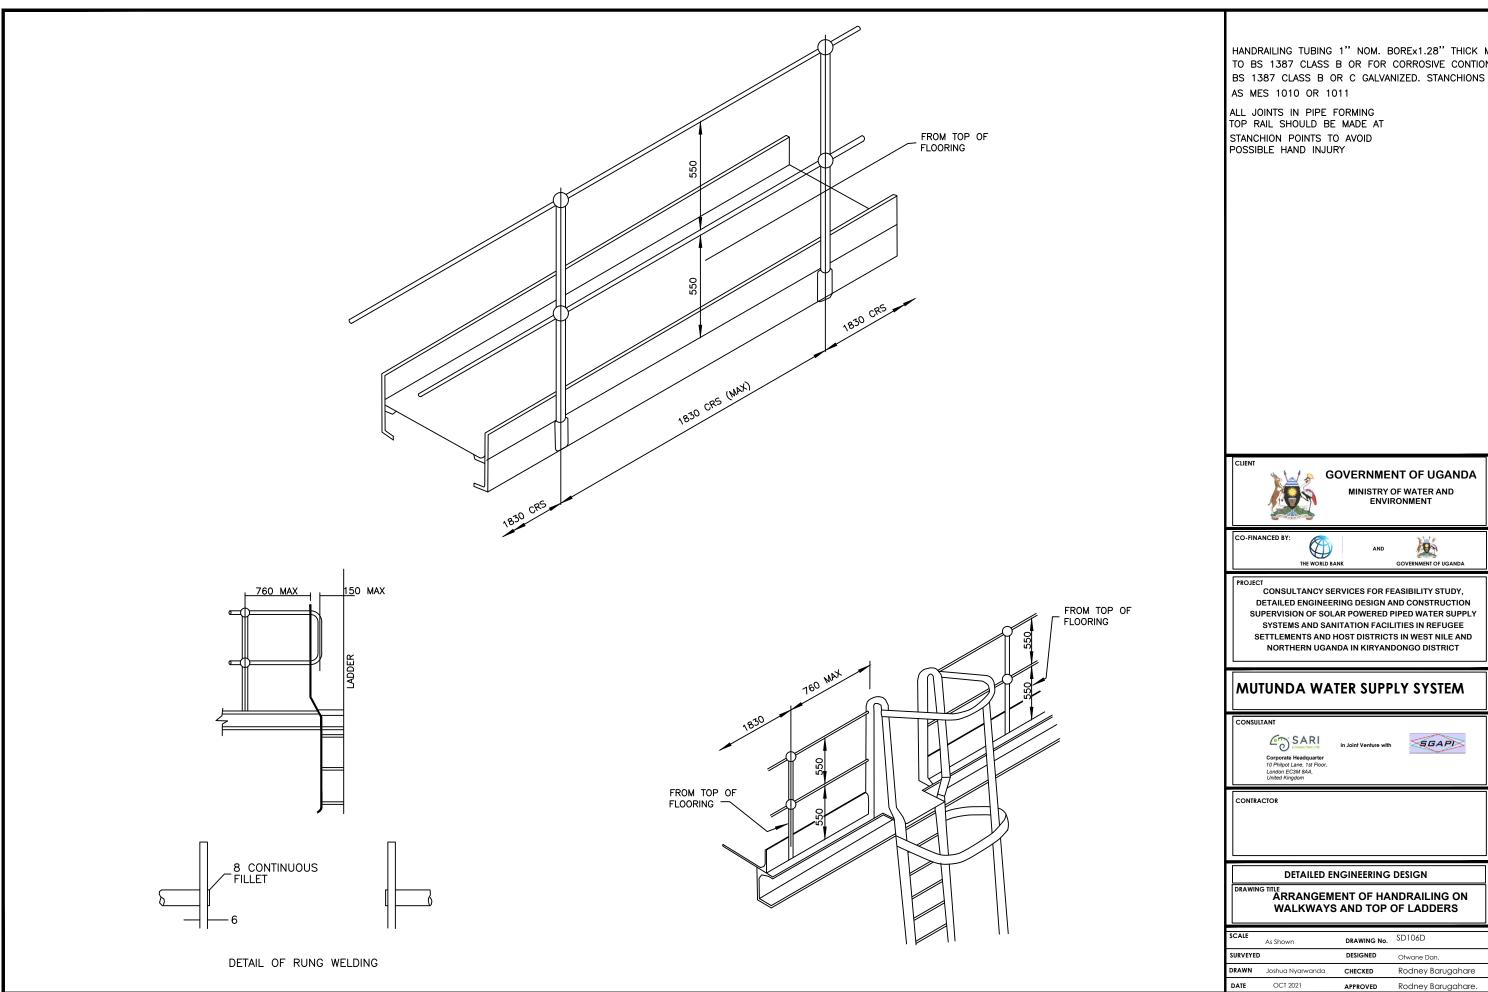

TO BS 1387 CLASS B OR FOR CORROSIVE CONTION BS 1387 CLASS B OR C GALVANIZED. STANCHIONS

GOVERNMENT OF UGANDA

MINISTRY OF WATER AND ENVIRONMENT




DETAILED ENGINEERING DESIGN AND CONSTRUCTION SUPERVISION OF SOLAR POWERED PIPED WATER SUPPLY SYSTEMS AND SANITATION FACILITIES IN REFUGEE SETTLEMENTS AND HOST DISTRICTS IN WEST NILE AND NORTHERN UGANDA IN KIRYANDONGO DISTRICT



DETAILED ENGINEERING DESIGN

ARRANGEMENT OF HANDRAILING ON WALKWAYS AND TOP OF LADDERS

SCALE As Shown		DRAWING No. SD106D	
SURVEYED		DESIGNED	Otwane Dan.
DRAWN	Joshua Nyarwanda	CHECKED	Rodney Barugahare
DATE	OCT 2021	APPROVED	Rodney Barugahare.

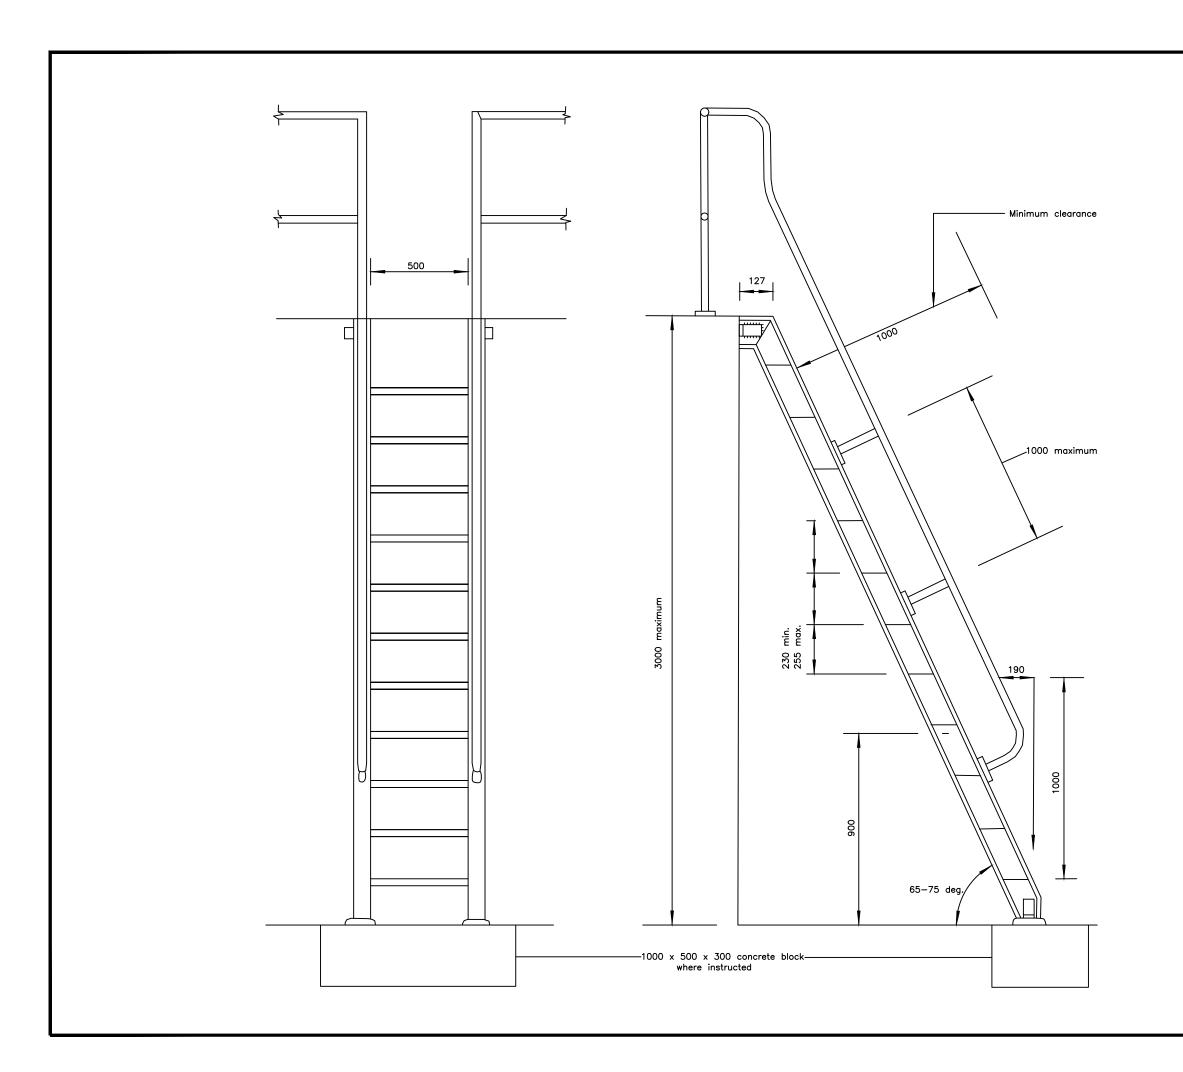

- 1. Stringers 127 x 64 x 14.9 kg/m rolled steel
- 2. Steps 8 mm thick chequer plate with nosed
- 3. Step supports 30 x 30 x 5 angle welded to fixed to stringers with 12 dia bolts and nuts.
- 4. All welds to be 8 mm fillet welds.
- 5. Cleats 90 x 90 x 10 angle.
- 6. Holding down bolts 20 dia.
- 7. Handrailing in accordance with the specificati
- 8. For details see SD107B.





GOVERNMENT OF UGANDA

MINISTRY OF WATER AND ENVIRONMENT

CO-FINANCED B



IND 🜡



PROJEC

CONSULTANCY SERVICES FOR FEASIBILITY STUDY,
DETAILED ENGINEERING DESIGN AND CONSTRUCTION
SUPERVISION OF SOLAR POWERED PIPED WATER SUPPLY
SYSTEMS AND SANITATION FACILITIES IN REFUGEE
SETTLEMENTS AND HOST DISTRICTS IN WEST NILE AND
NORTHERN UGANDA IN KIRYANDONGO DISTRICT

MUTUNDA WATER SUPPLY SYSTEM

CONSULTANT



In Joint Venture with



CONTRACTOR

DETAILED ENGINEERING DESIGN


RAWING TITLE

ARRANGEMENT OF HANDRAILING ON WALKWAYS AND TOP OF LADDERS

SCALE	As Shown DRAWING No.		SD107A
SURVEYED	SURVEYED DESIGNED		Otwane Dan.
DRAWN	Joshua Nyarwanda	CHECKED	Rodney Barugahare
DATE	OCT 2021	APPROVED	Rodney Barugahare.

Top step flush with platform Platform level 127 x 64 stringer 127 x 64 stringer _2 no.12 dia. 90 x 90 x 10 40 cleat HANDRAIL FIXING SECTION A-A



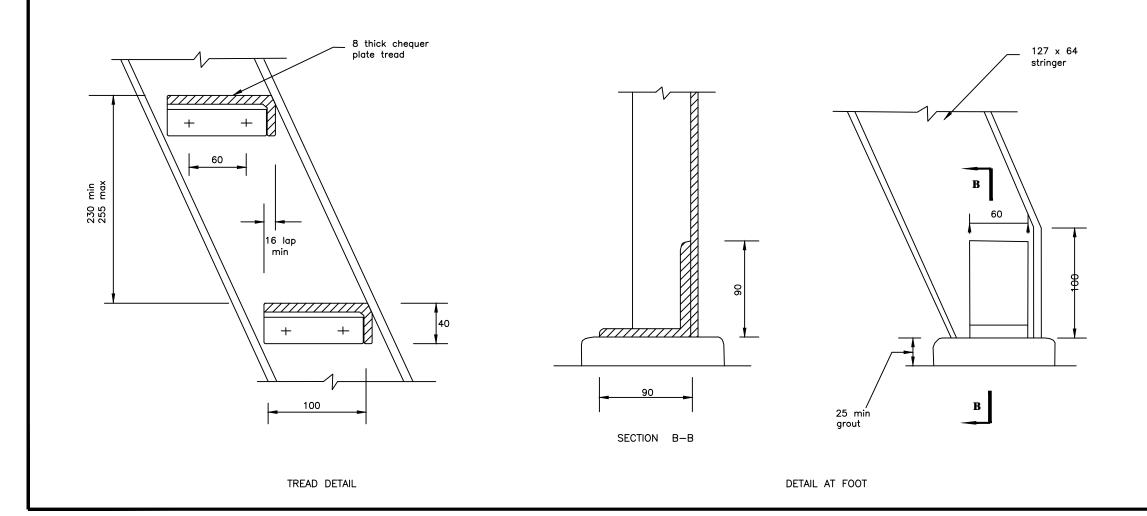

NOTES

- 1. All welds to be 81 then to welds
- 2. Holding down b20tsdia.





CONSULTANCY SERVICES FOR FEASIBILITY STUDY, DETAILED ENGINEERING DESIGN AND CONSTRUCTION SUPERVISION OF SOLAR POWERED PIPED WATER SUPPLY SYSTEMS AND SANITATION FACILITIES IN REFUGEE SETTLEMENTS AND HOST DISTRICTS IN WEST NILE AND NORTHERN UGANDA IN KIRYANDONGO DISTRICT

MUTUNDA WATER SUPPLY SYSTEM







CONTRACTOR


DETAILED ENGINEERING DESIGN


MILD STEEL SHIPTYPE LADDER - DETAIL


SCALE	As Shown	DRAWING No.	SD107B
SURVEYED		DESIGNED	Otwane Dan.
DRAWN	Joshua Nyarwanda	CHECKED	Rodney Barugahare
DATE	OCT 2021	APPROVED	Rodney Barugahare.

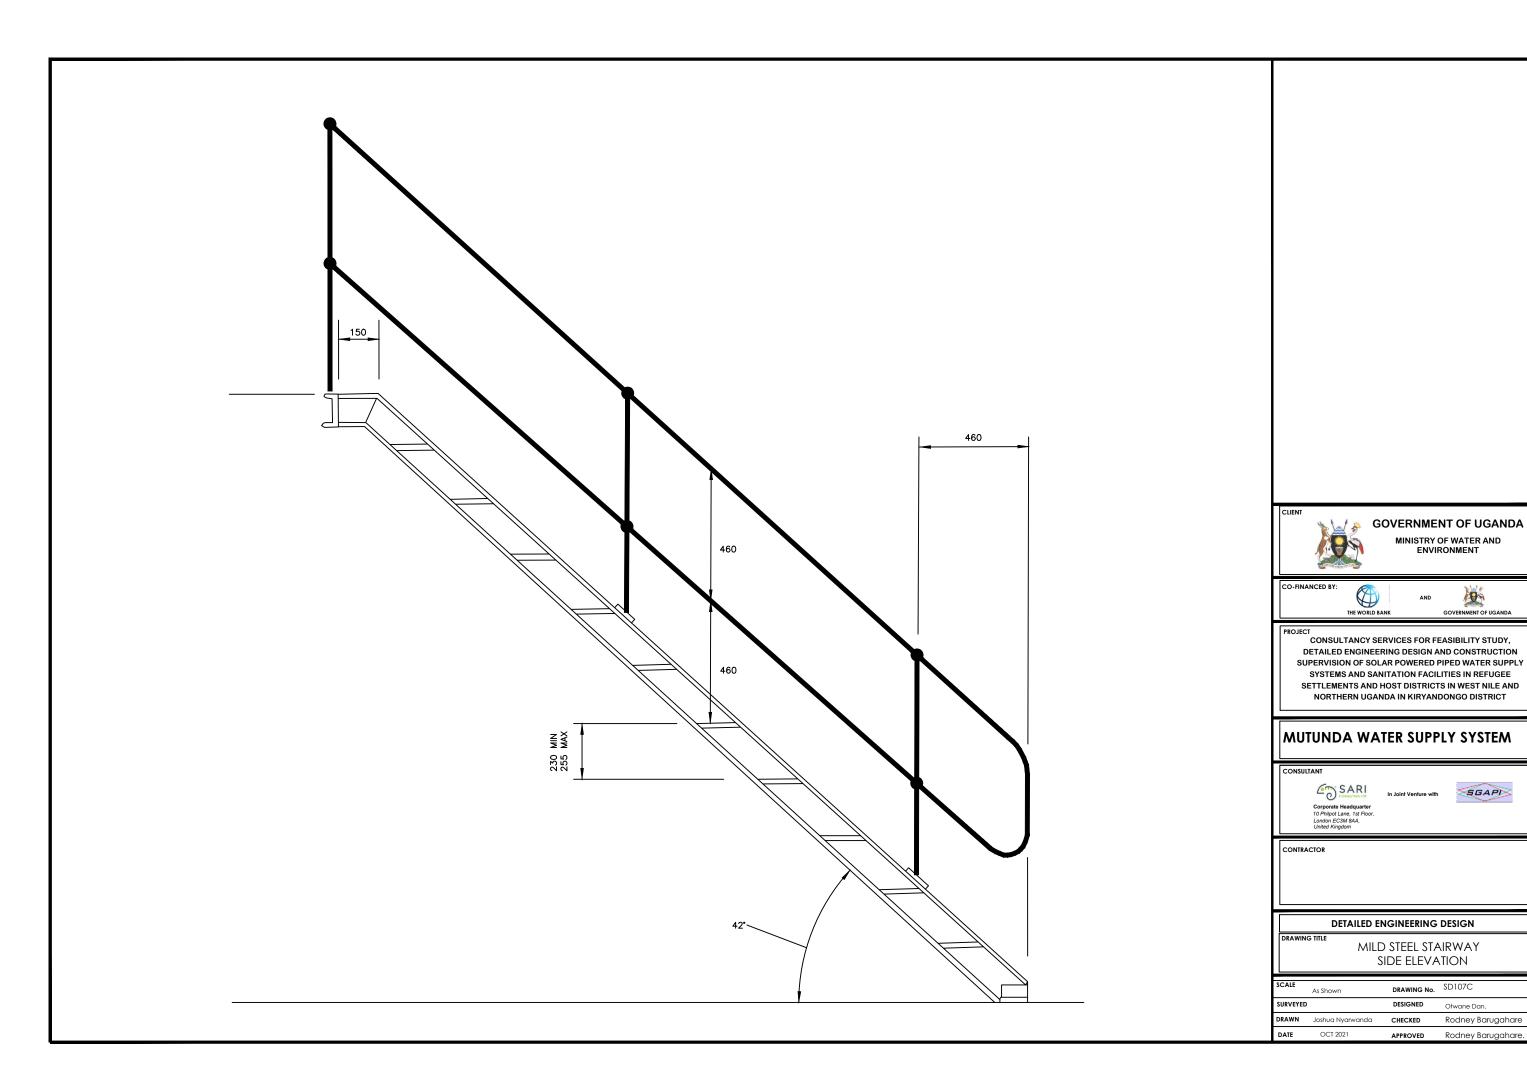

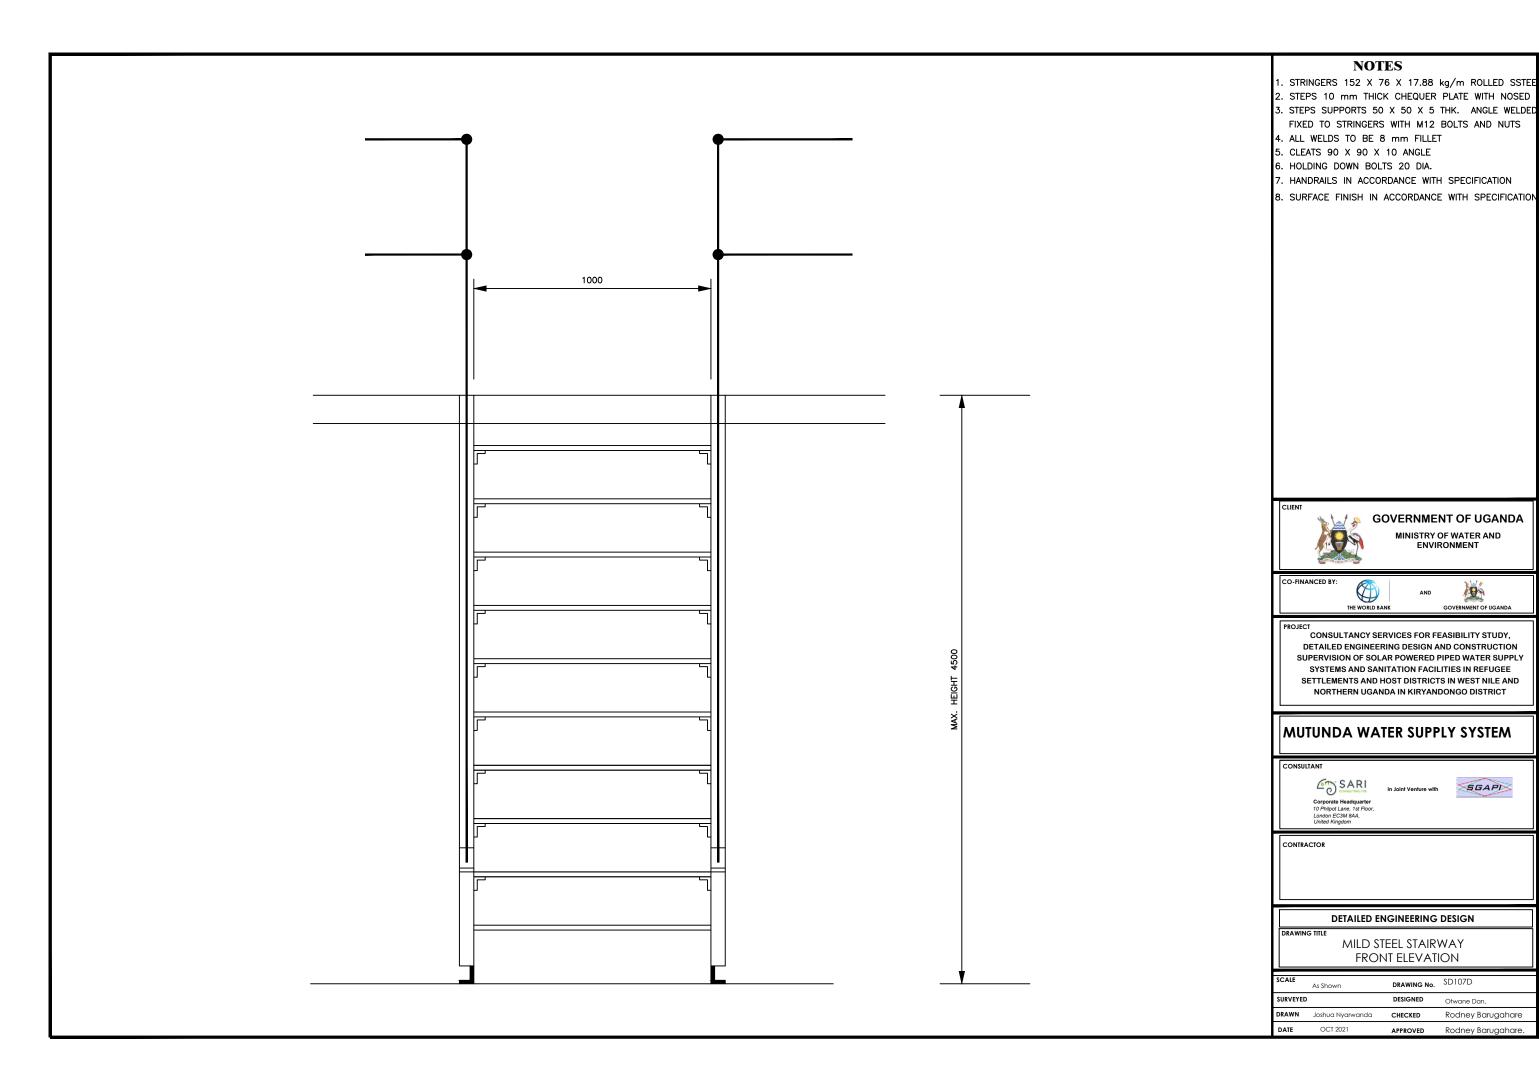

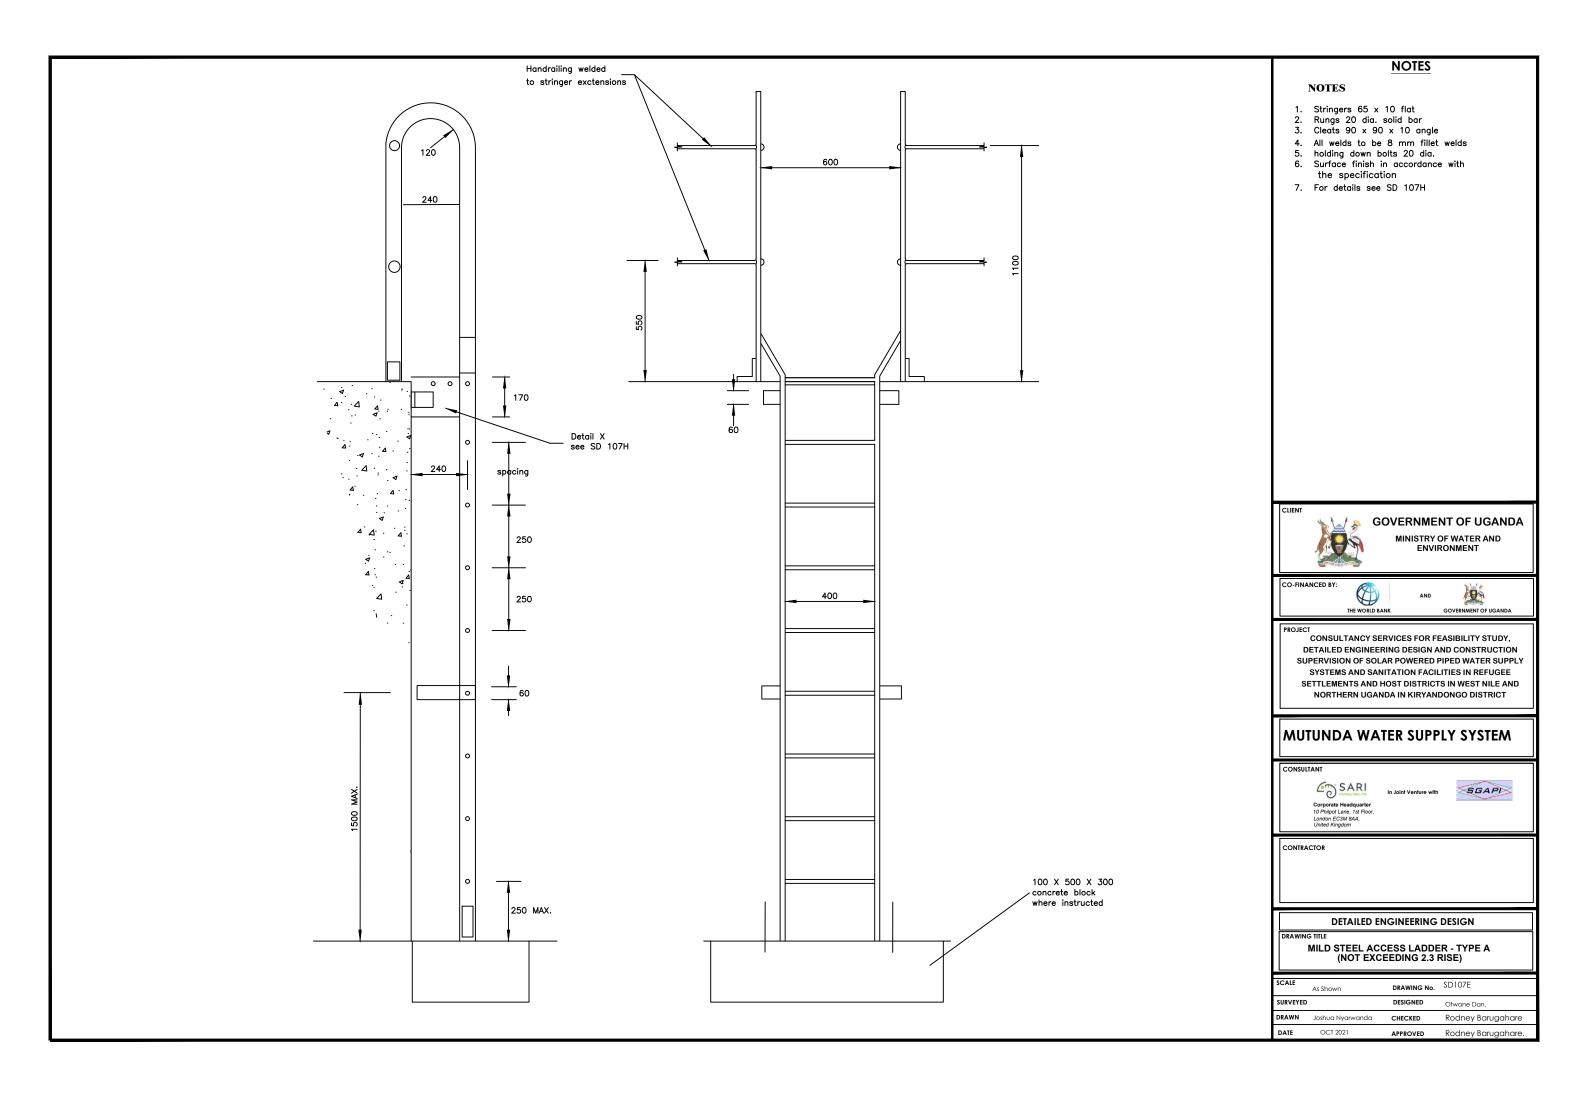

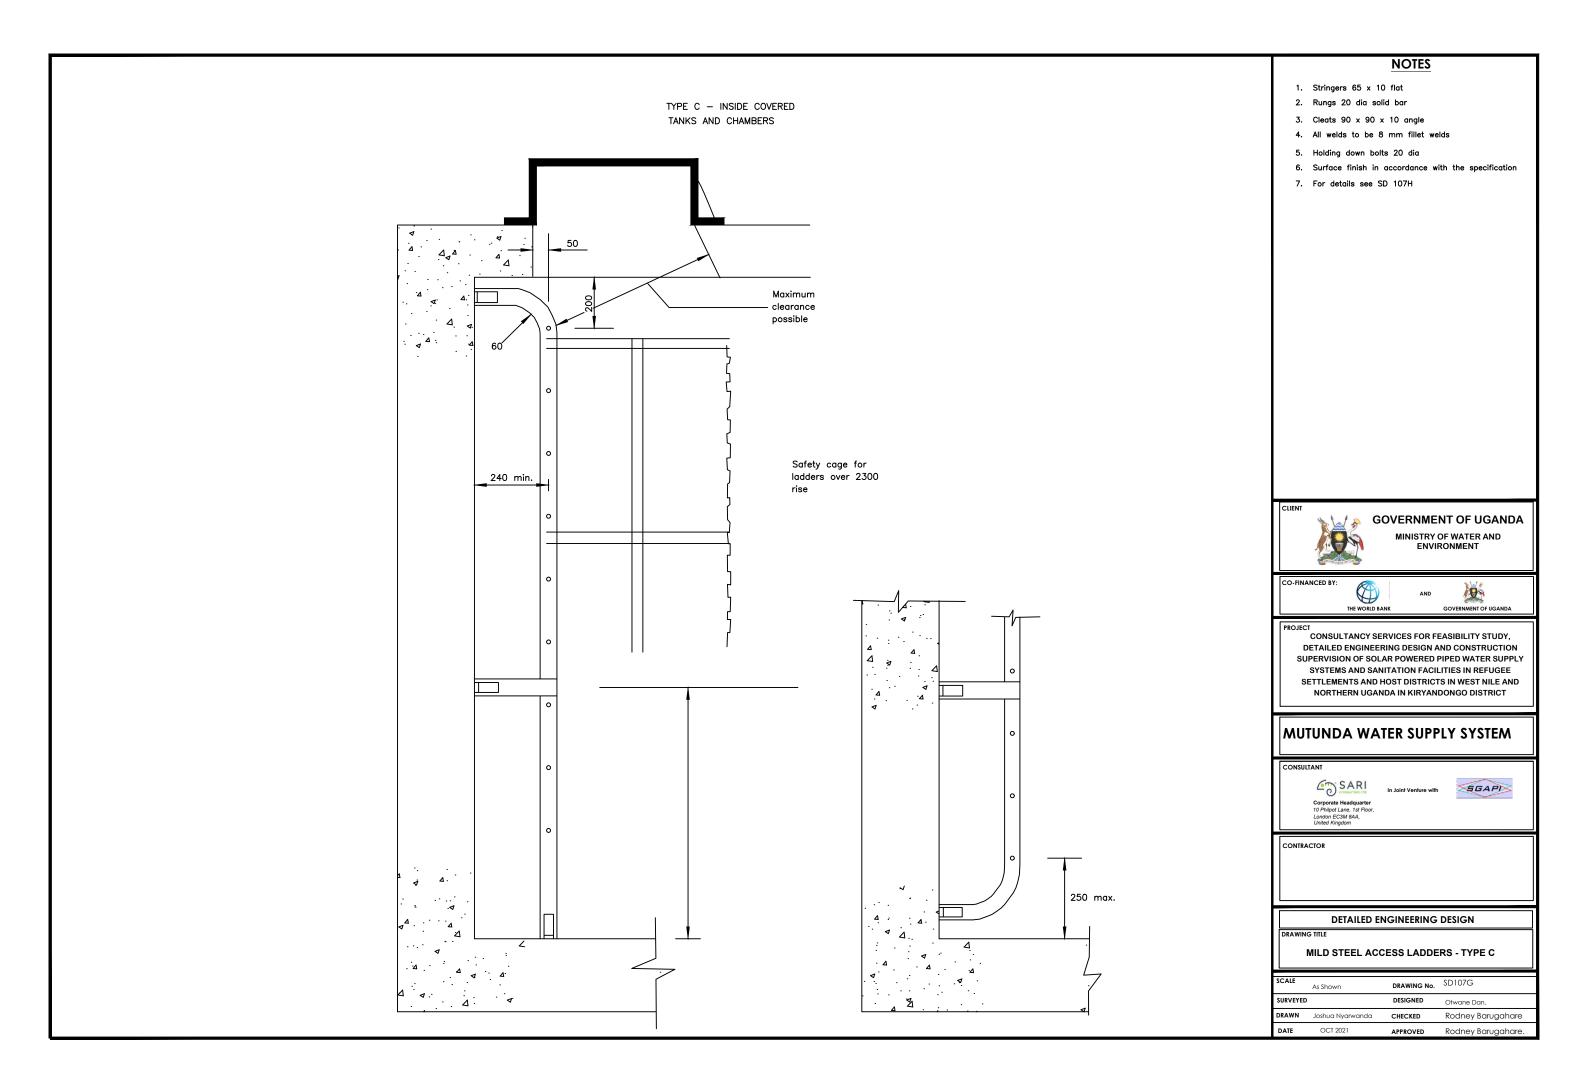

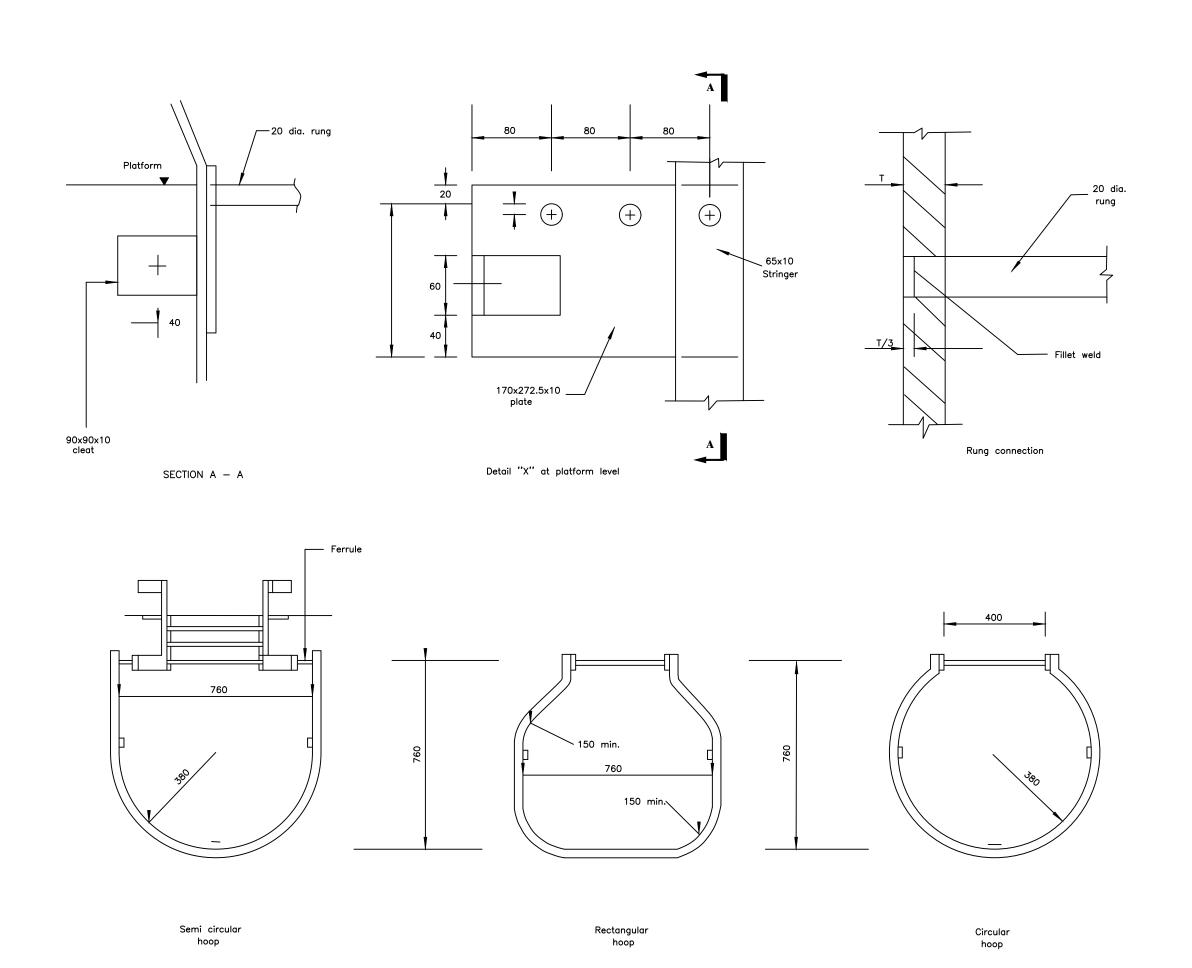

- 1. All welds to be 8 mm fillet welds
- 2. Hoops and vertical cage members to be 50x10 flat welded together or fixed with 12 dia. bolts and nuts
- 3. Holding down bolts 20 dia.





GOVERNMENT OF UGANDA

MINISTRY OF WATER AND ENVIRONMENT





CONSULTANCY SERVICES FOR FEASIBILITY STUDY, DETAILED ENGINEERING DESIGN AND CONSTRUCTION SUPERVISION OF SOLAR POWERED PIPED WATER SUPPLY SYSTEMS AND SANITATION FACILITIES IN REFUGEE SETTLEMENTS AND HOST DISTRICTS IN WEST NILE AND NORTHERN UGANDA IN KIRYANDONGO DISTRICT

MUTUNDA WATER SUPPLY SYSTEM






CONTRACTOR

DETAILED ENGINEERING DESIGN

MILD STEEL ACCESS LADDERS - DETAILS

SCALE	SCALE As Shown DRAWING No.		SD107H
SURVEYED)	DESIGNED	Otwane Dan.
DRAWN	Joshua Nyarwanda	CHECKED	Rodney Barugahare
DATE	OCT 2021	APPROVED	Rodney Barugahare.

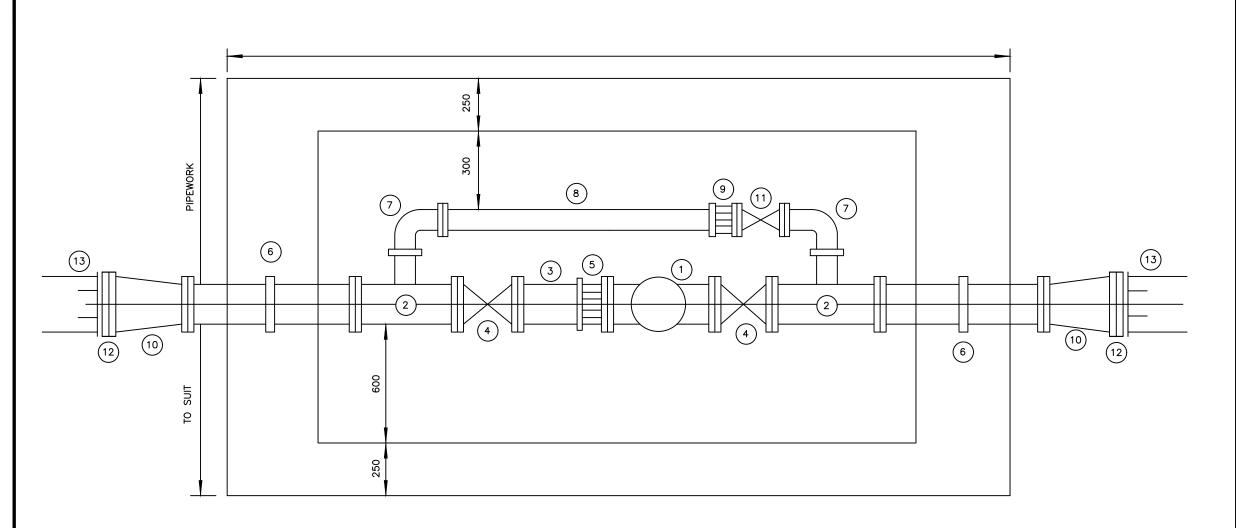

(SD 131 PRV CHAMBER)

MAIN SIZE (mm DIAMETER)	PRV SIZE (mm DIAMETER)
100	80
150	100
200	150
250	200
300	250
350	300

- 1 All dimensions in millimetres
- 2 For details of reinforced concrete chamber see SD 132
- ITEM
- 1 Pressure reducing valve
- 2 All flanged tee (DN100 branch)
- 3 Flanged spigot pipe
- 4 Flanged gate valve
- 5 Flange adaptor
- 6 Flange spigot pipe with puddle Flange
- 7 Flanged 90° bend DN100
- 8 Flanged spigot pipe cut to fit
- 9 Flanged adaptor DN100
- 10 Flanged taper
- 11 Gate valve DN100
- 12 Flange adaptor (Viking Johnson 'maxi' or similar approved)
- 13 Distribution main





GOVERNMENT OF UGANDA

MINISTRY OF WATER AND ENVIRONMENT





CONSULTANCY SERVICES FOR FEASIBILITY STUDY, DETAILED ENGINEERING DESIGN AND CONSTRUCTION SUPERVISION OF SOLAR POWERED PIPED WATER SUPPLY SYSTEMS AND SANITATION FACILITIES IN REFUGEE SETTLEMENTS AND HOST DISTRICTS IN WEST NILE AND NORTHERN UGANDA IN KIRYANDONGO DISTRICT

MUTUNDA WATER SUPPLY SYSTEM






CONTRACTOR

DETAILED ENGINEERING DESIGN

PRESSURE REDUCING VALVE - PIPEWORK

SCALE As Shown DRAWING No.		SD109	
SURVEYED		DESIGNED	Otwane Dan.
DRAWN	Joshua Nyarwanda	CHECKED	Rodney Barugahare
DATE	OCT 2021	APPROVED	Rodney Barugahare.

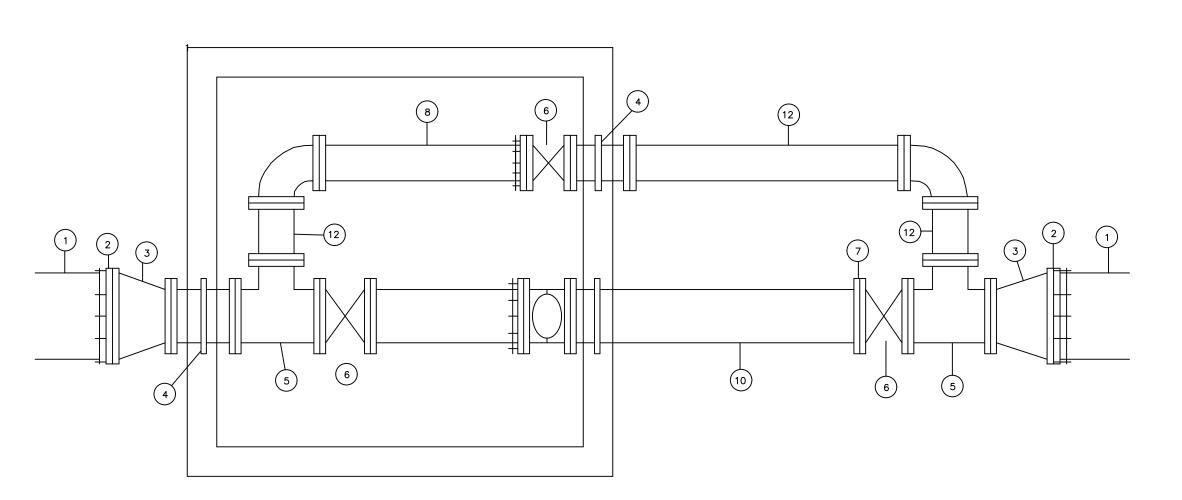

MAIN SIZE (mm DIAMETER)	FLOWMETER SIZE (mm DIAMETER)
100	80
150	100
200	150
250	200
300	250
350	300

- 1 All dimensions in millimetres
- 2 For details of reinforced concrete chamber see SD 132
- 2 Length of each item of pipework shall be specified by the Project Manager

ITEM

- 1 Distribution main
- 2 Flange adaptor (Viking Johnson 'maxi' or similar approved) 3 Flanged taper
- 4 All flanged piece with central thrust flange
- 5 All flanged equal tee
- 6 Flange gate valve
- 7 Flanged adaptor
- 8 Flanged spigot pipe
- 9 Water meter
 10 Flanged spigot with thrust flange 500mm from flanged end
 11 Flanged 90° bend
 12 Double flanged pipe



GOVERNMENT OF UGANDA

MINISTRY OF WATER AND ENVIRONMENT





CONSULTANCY SERVICES FOR FEASIBILITY STUDY, DETAILED ENGINEERING DESIGN AND CONSTRUCTION SUPERVISION OF SOLAR POWERED PIPED WATER SUPPLY SYSTEMS AND SANITATION FACILITIES IN REFUGEE SETTLEMENTS AND HOST DISTRICTS IN WEST NILE AND NORTHERN UGANDA IN KIRYANDONGO DISTRICT

MUTUNDA WATER SUPPLY SYSTEM






CONTRACTOR


DETAILED ENGINEERING DESIGN

FLOWMETER - PIPEWORK

SCALE As Shown DRAWING No.		SD110	
SURVEYED		DESIGNED	Otwane Dan.
DRAWN	Joshua Nyarwanda	CHECKED	Rodney Barugahare
DATE	OCT 2021	APPROVED	Rodney Barugahare.

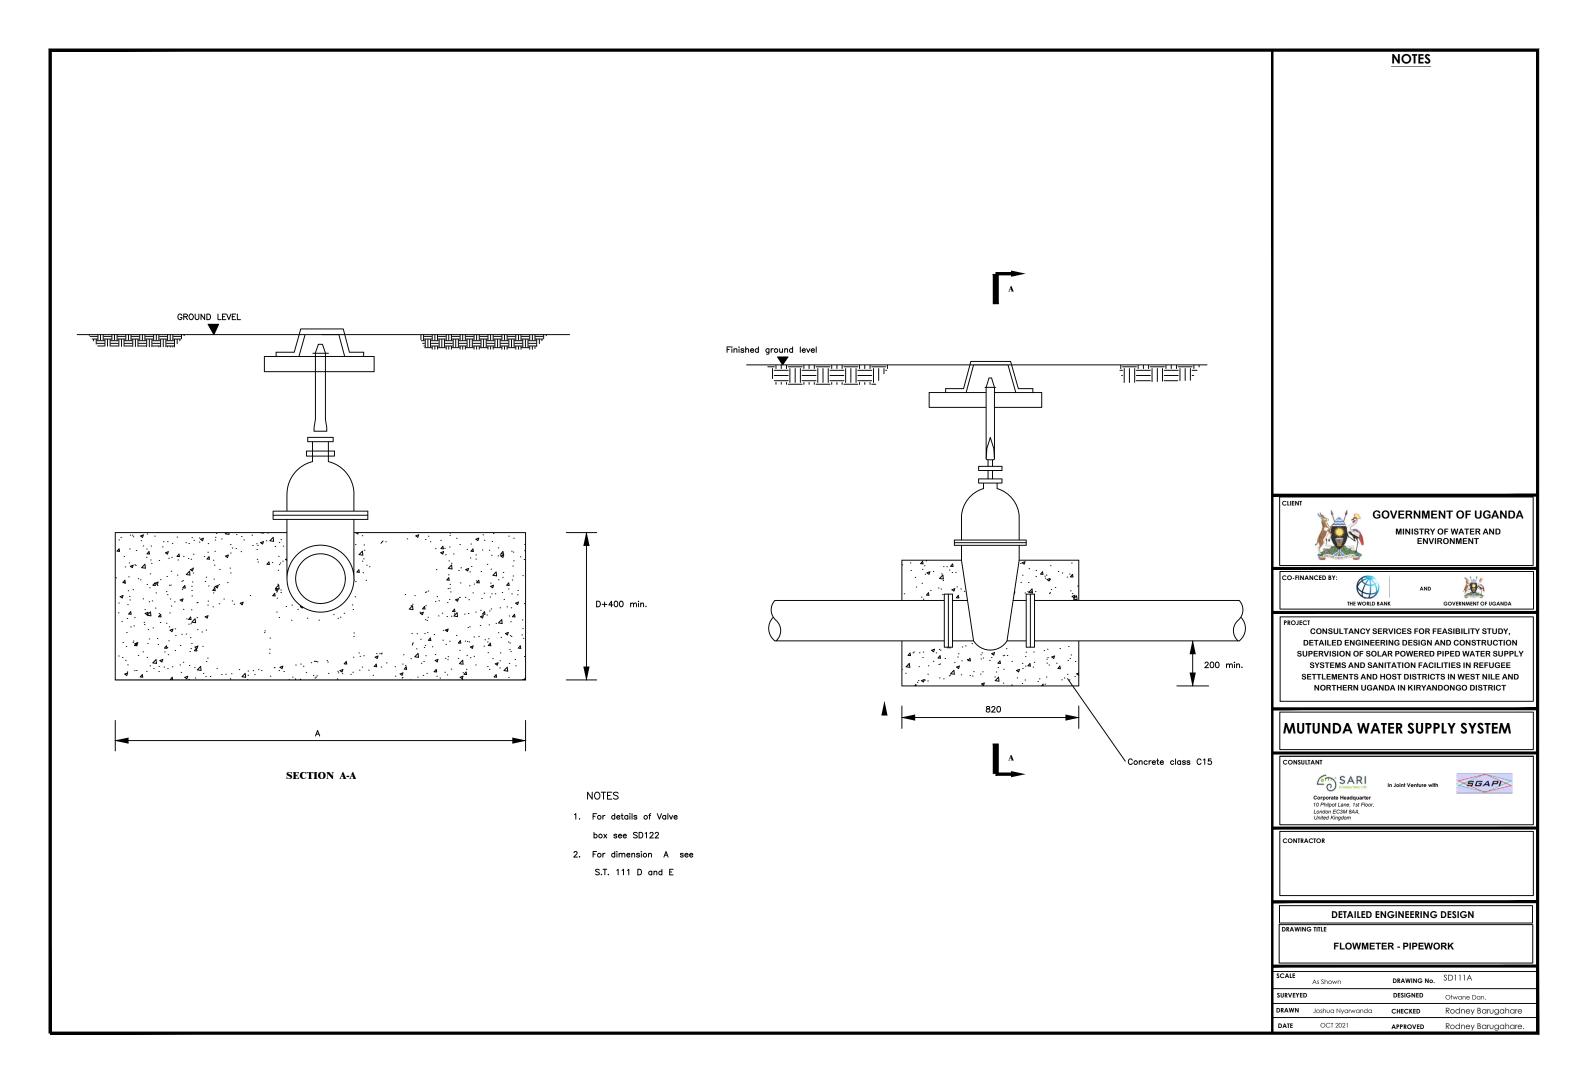

A/2 - Trench side 300 max. 300 max. A/2 Concrete to be cast against undisturbed ground 200 PLAN

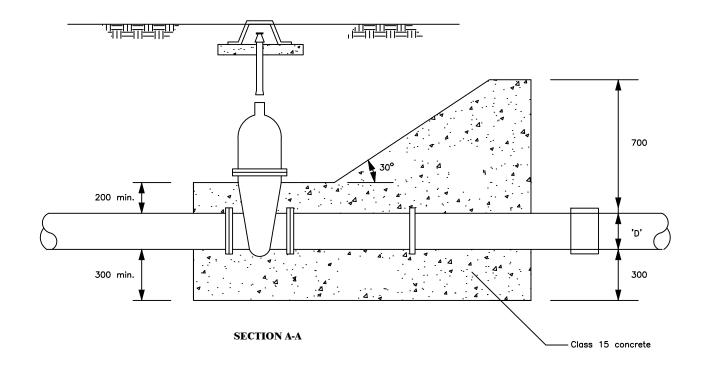

NOTES

- 1. For details of surface box see SD122
- 2. For dimension A see SD 111 D and E





GOVERNMENT OF UGANDA

MINISTRY OF WATER AND ENVIRONMENT





CONSULTANCY SERVICES FOR FEASIBILITY STUDY, DETAILED ENGINEERING DESIGN AND CONSTRUCTION SUPERVISION OF SOLAR POWERED PIPED WATER SUPPLY SYSTEMS AND SANITATION FACILITIES IN REFUGEE SETTLEMENTS AND HOST DISTRICTS IN WEST NILE AND NORTHERN UGANDA IN KIRYANDONGO DISTRICT

MUTUNDA WATER SUPPLY SYSTEM






CONTRACTOR

DETAILED ENGINEERING DESIGN

GATE VALVE - TYPE 2

SCALE	SCALE As Shown DRAWING No.		SD111B
SURVEYE	D	DESIGNED	Otwane Dan.
DRAWN	Joshua Nyarwanda	CHECKED	Rodney Barugahare
DATE	OCT 2021	APPROVED	Rodney Barugahare.

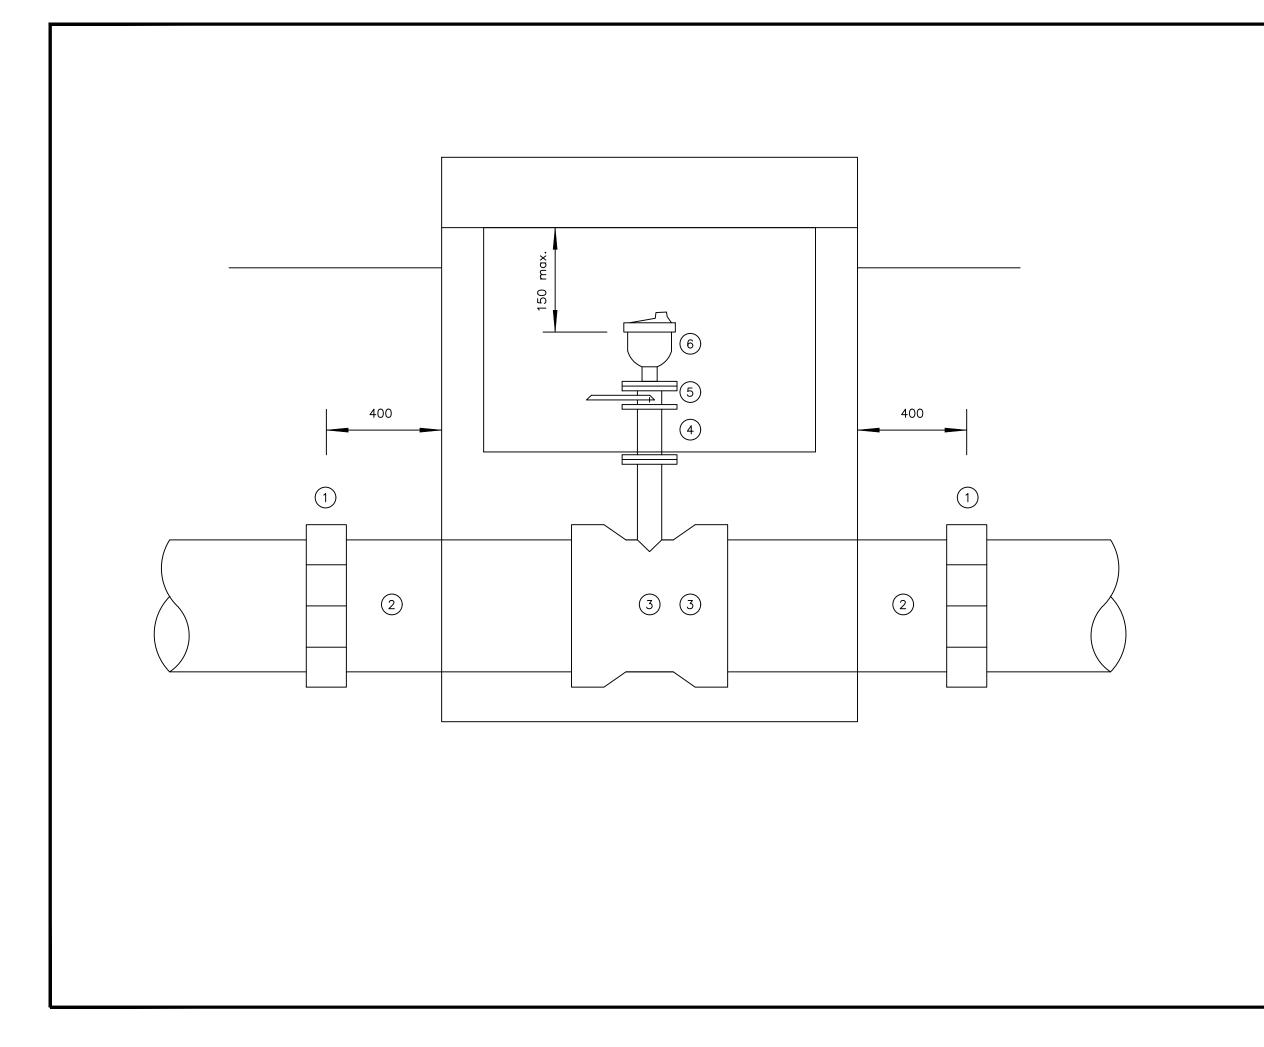

- 1 All dimensions are in millimetres
- 2 Flanged pipework to be ductile iron
- 3 Make up pipes to be ductile iron
 - For details see standard drawing SD 112D

4 Chamber to be 1200x900 internal dimensions

5 See General Notes

SCHEDULE

ITEM DESCRIPTION

- 1 Flexible adaptor if required
- 2 Make-up pipe
- 3 Socket tee flanged branch 80/50 dia as required
- 4 Flanged pipe 80/50 dia as required

main 100-300dia valve 50 dia

5 Isolating valve
6 Air valve

main 350-600dia valve 80dia



GOVERNMENT OF UGANDA

MINISTRY OF WATER AND ENVIRONMENT





NORTHERN UGANDA IN KIRYANDONGO DISTRICT

MUTUNDA WATER SUPPLY SYSTEM

PROJECT
CONSULTANCY SERVICES FOR FEASIBILITY STUDY,

DETAILED ENGINEERING DESIGN AND CONSTRUCTION SUPERVISION OF SOLAR POWERED PIPED WATER SUPPLY SYSTEMS AND SANITATION FACILITIES IN REFUGEE SETTLEMENTS AND HOST DISTRICTS IN WEST NILE AND







CONTRACTOR


DETAILED ENGINEERING DESIGN

AIR VALVE PIPEWORK


SCALE	As Shown DRAWING No.		SD112A
SURVEYED	١	DESIGNED	Otwane Dan.
DRAWN	Joshua Nyarwanda	CHECKED	Rodney Barugahare
DATE	OCT 2021	APPROVED	Rodney Barugahare.

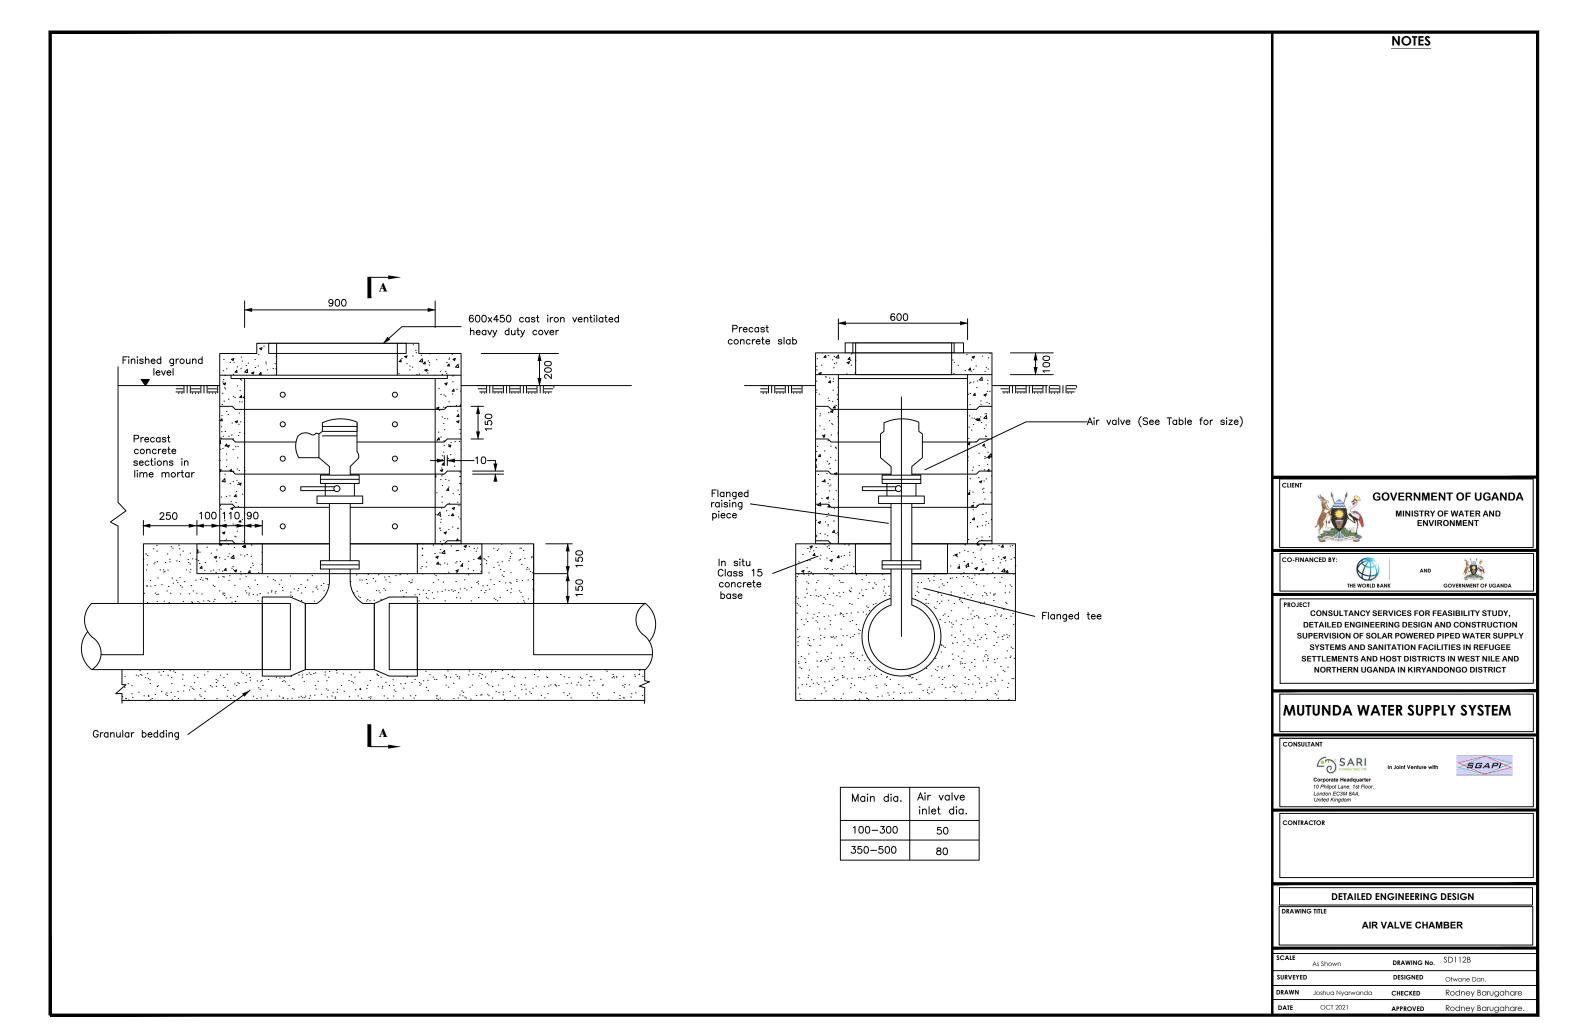

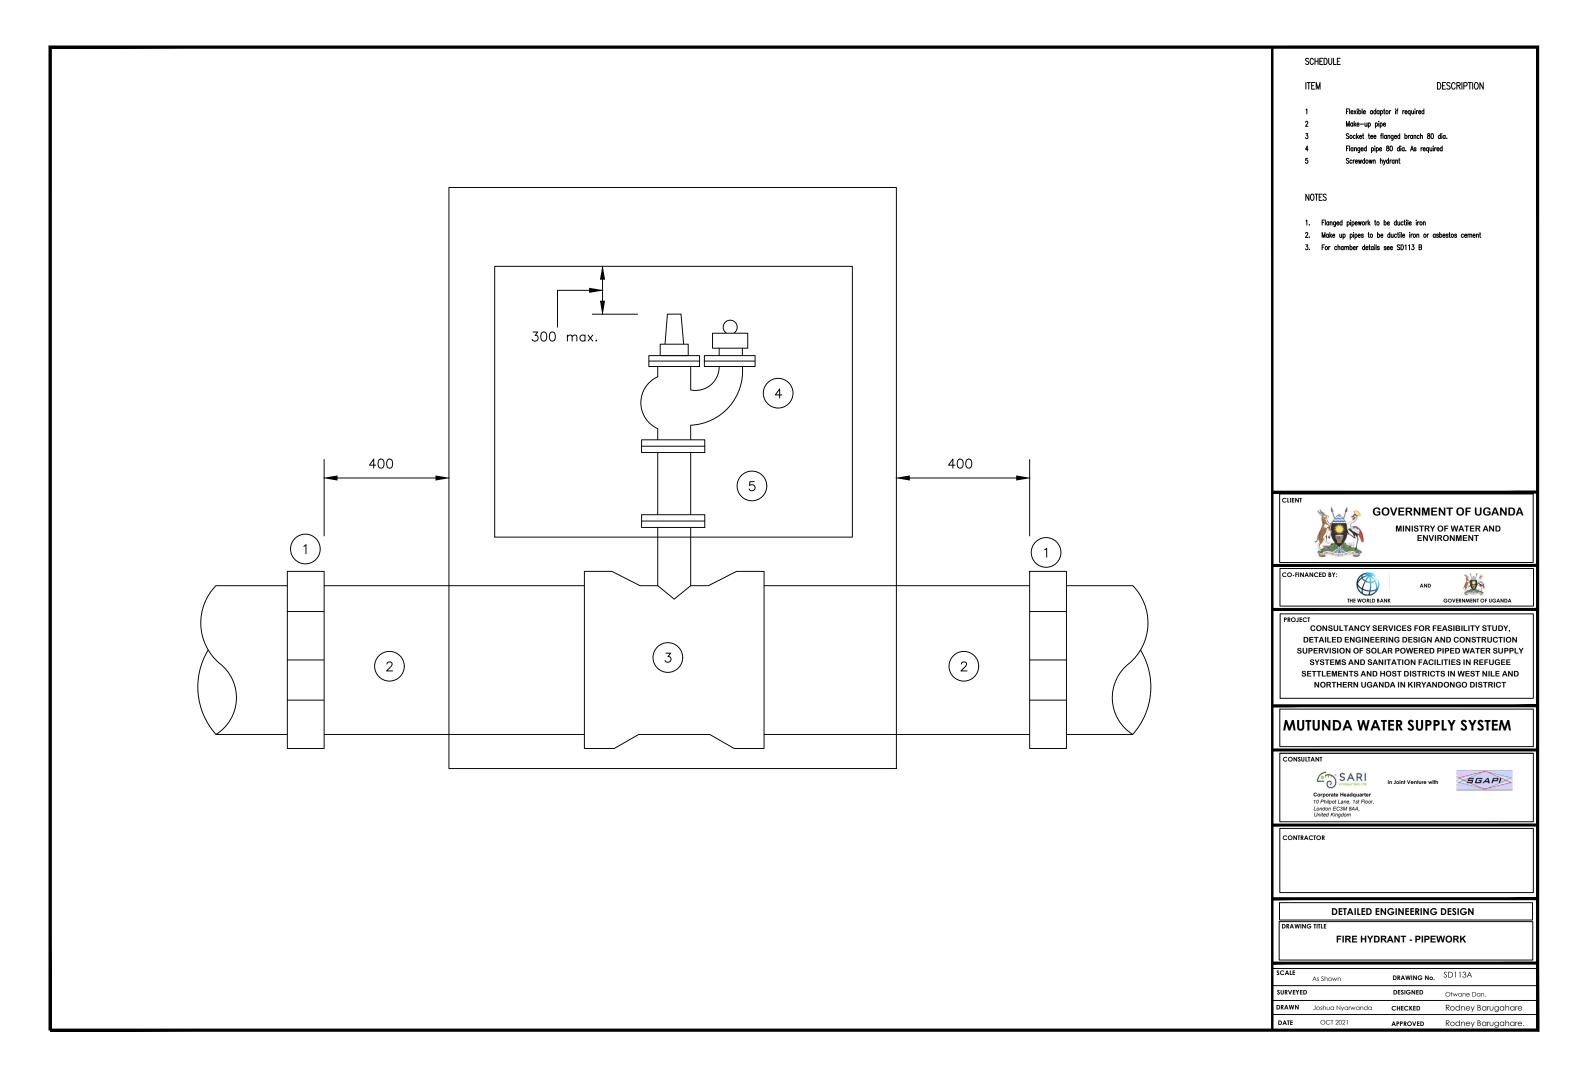

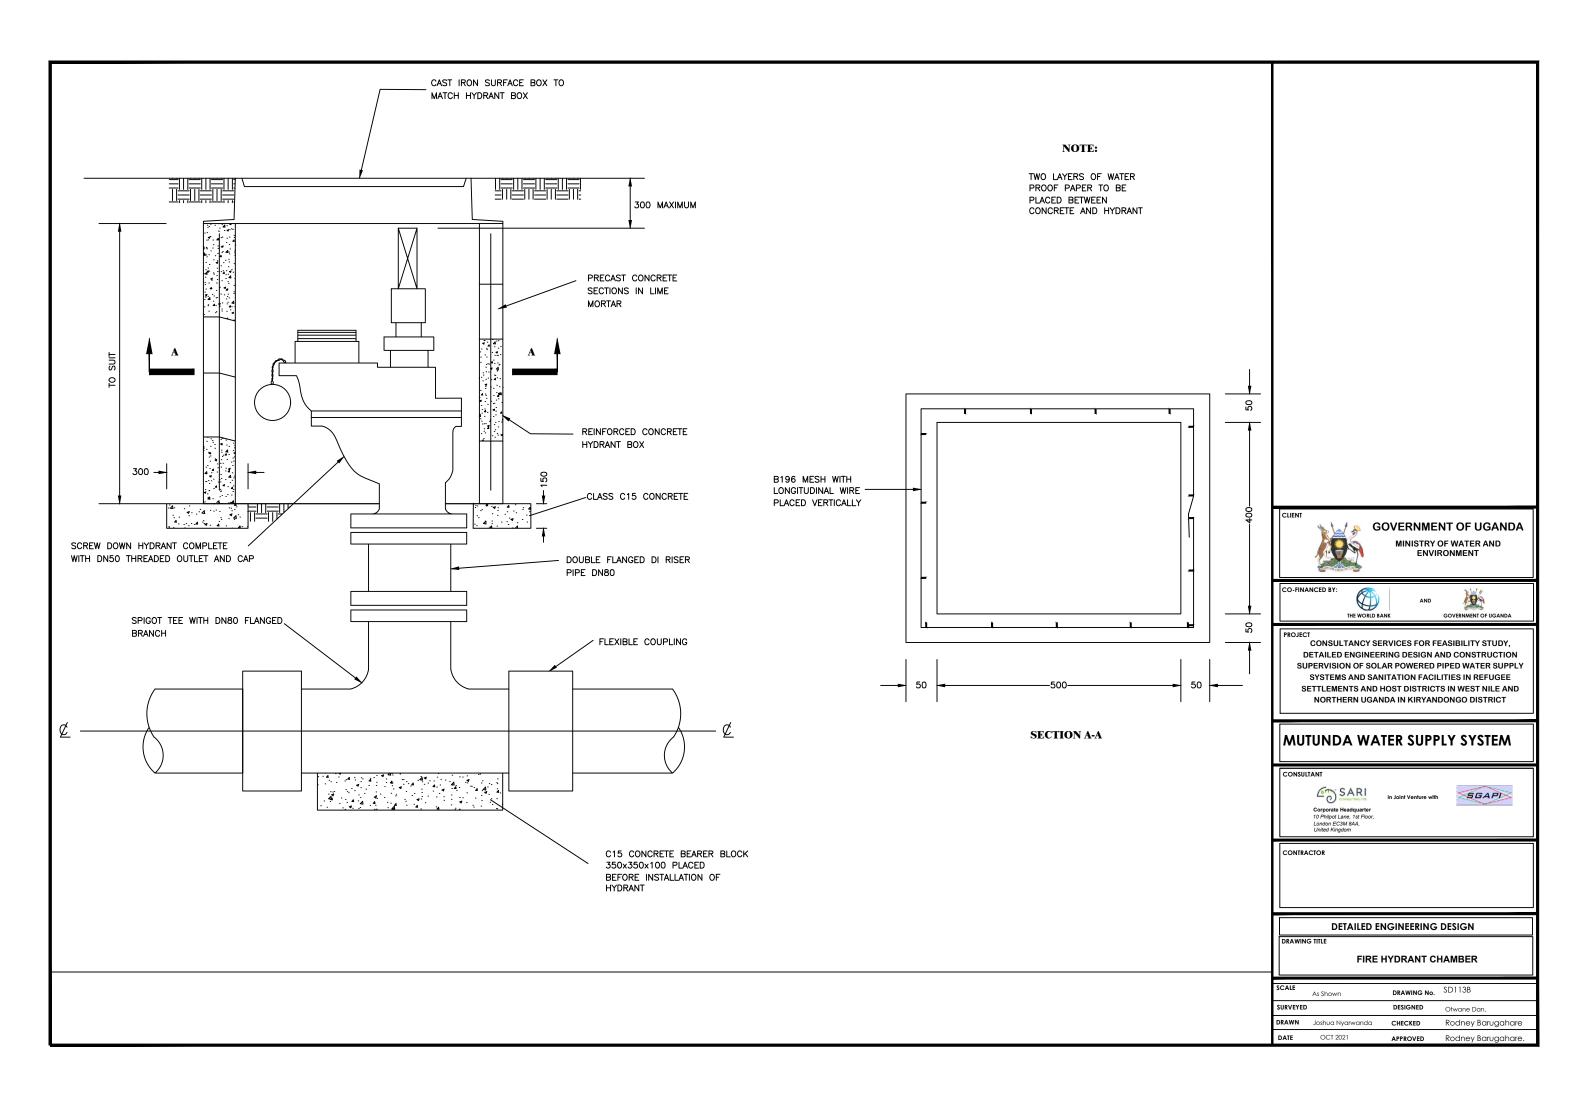


WO TYPE 1

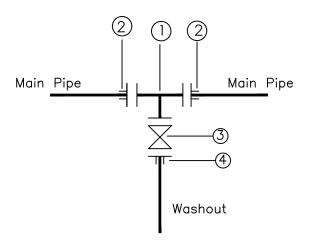

- 1 1No CI Flanged Tee DN A/B
- 2No DI Flange Adaptor, Maxi type or similar type DN A
- 3 1No CI Flanged Gate Valve DN A
- (4) 1No DI Flange Adaptor, Maxi type or similar DN B

WO TYPE 2

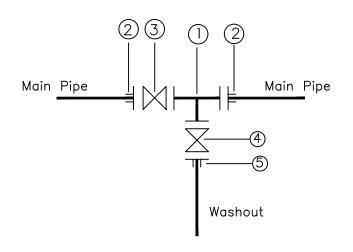

- 1 1No Cl Flanged Tee DN A/B
 2 2No Dl Flange Adaptor, Maxi type or similar type DN A
 1 1No Cl Flanged Gate Valve DN A
 1 1No Dl Flanged Gate Valve DN B

- (5) 1No DI Flange Adaptor, Maxi type or similar DN B

Main Pipe Washout A B OD 50 OD 50 DN 40 DN 40 OD 63 OD 63 DN 50 OD 50 OD 90 OD 63 DN 80 OD 50 OD 110 OD 63 DN 100 OD 50 OD 160 OD 63 DN 150 OD 50 OD 218 OD 110 DN 200 OD 100 OD 250 OD 110 DN 250 OD 100 OD 300 OD 110 DN 300 OD 100 OD 350 OD 110 DN 350 OD 100	Pipe Diam	eter	Fittings (Diameter
OD 63 OD 63 DN 50 OD 50 OD 90 OD 63 DN 80 OD 50 OD 110 OD 63 DN 100 OD 50 OD 160 OD 63 DN 150 OD 50 OD 218 OD 110 DN 200 OD 100 OD 250 OD 110 DN 250 OD 100 OD 300 OD 110 DN 300 OD 100	Main Pipe	Washout	А	В
OD 90 OD 63 DN 80 OD 50 OD 110 OD 63 DN 100 OD 50 OD 160 OD 63 DN 150 OD 50 OD 218 OD 110 DN 200 OD 100 OD 250 OD 110 DN 250 OD 100 OD 300 OD 110 DN 300 OD 100	OD 50	OD 50	DN 40	DN 40
OD 110 OD 63 DN 100 OD 50 OD 160 OD 63 DN 150 OD 50 OD 218 OD 110 DN 200 OD 100 OD 250 OD 110 DN 250 OD 100 OD 300 OD 110 DN 300 OD 100	OD 63	OD 63	DN 50	OD 50
OD 160 OD 63 DN 150 OD 50 OD 218 OD 110 DN 200 OD 100 OD 250 OD 110 DN 250 OD 100 OD 300 OD 110 DN 300 OD 100	OD 90	OD 63	DN 80	OD 50
OD 218 OD 110 DN 200 OD 100 OD 250 OD 110 DN 250 OD 100 OD 300 OD 110 DN 300 OD 100	OD 110	OD 63	DN 100	OD 50
OD 250 OD 110 DN 250 OD 100 OD 300 OD 110 DN 300 OD 100	OD 160	OD 63	DN 150	OD 50
OD 300 OD 110 DN 300 OD 100	OD 218	OD 110	DN 200	OD 100
	OD 250	OD 110	DN 250	OD 100
OD 350 OD 110 DN 350 OD 100	OD 300	OD 110	DN 300	OD 100
	OD 350	OD 110	DN 350	OD 100
OD 400 OD 110 DN 400 OD 100	OD 400	OD 110	DN 400	OD 100
OD 500 OD 110 DN 450 OD 100	OD 500	OD 110	DN 450	OD 100

NOTE: Pressure ratings of Washouts and Fittings shall be similar to those of the main pipe on which the washout is to be installed





CONSULTANCY SERVICES FOR FEASIBILITY STUDY, DETAILED ENGINEERING DESIGN AND CONSTRUCTION SUPERVISION OF SOLAR POWERED PIPED WATER SUPPLY SYSTEMS AND SANITATION FACILITIES IN REFUGEE SETTLEMENTS AND HOST DISTRICTS IN WEST NILE AND NORTHERN UGANDA IN KIRYANDONGO DISTRICT

MUTUNDA WATER SUPPLY SYSTEM


SARI COMBULTERS LTD





DETAILED ENGINEERING DESIGN


WASHOUT DETAILS TYPE 1 & 2

SCALE As Shown DRAWING No.		SD114A	
SURVEYE)	DESIGNED	Otwane Dan.
DRAWN	Joshua Nyarwanda	CHECKED	Rodney Barugahare
DATE	OCT 2021	APPROVED	Rodney Barugahare.

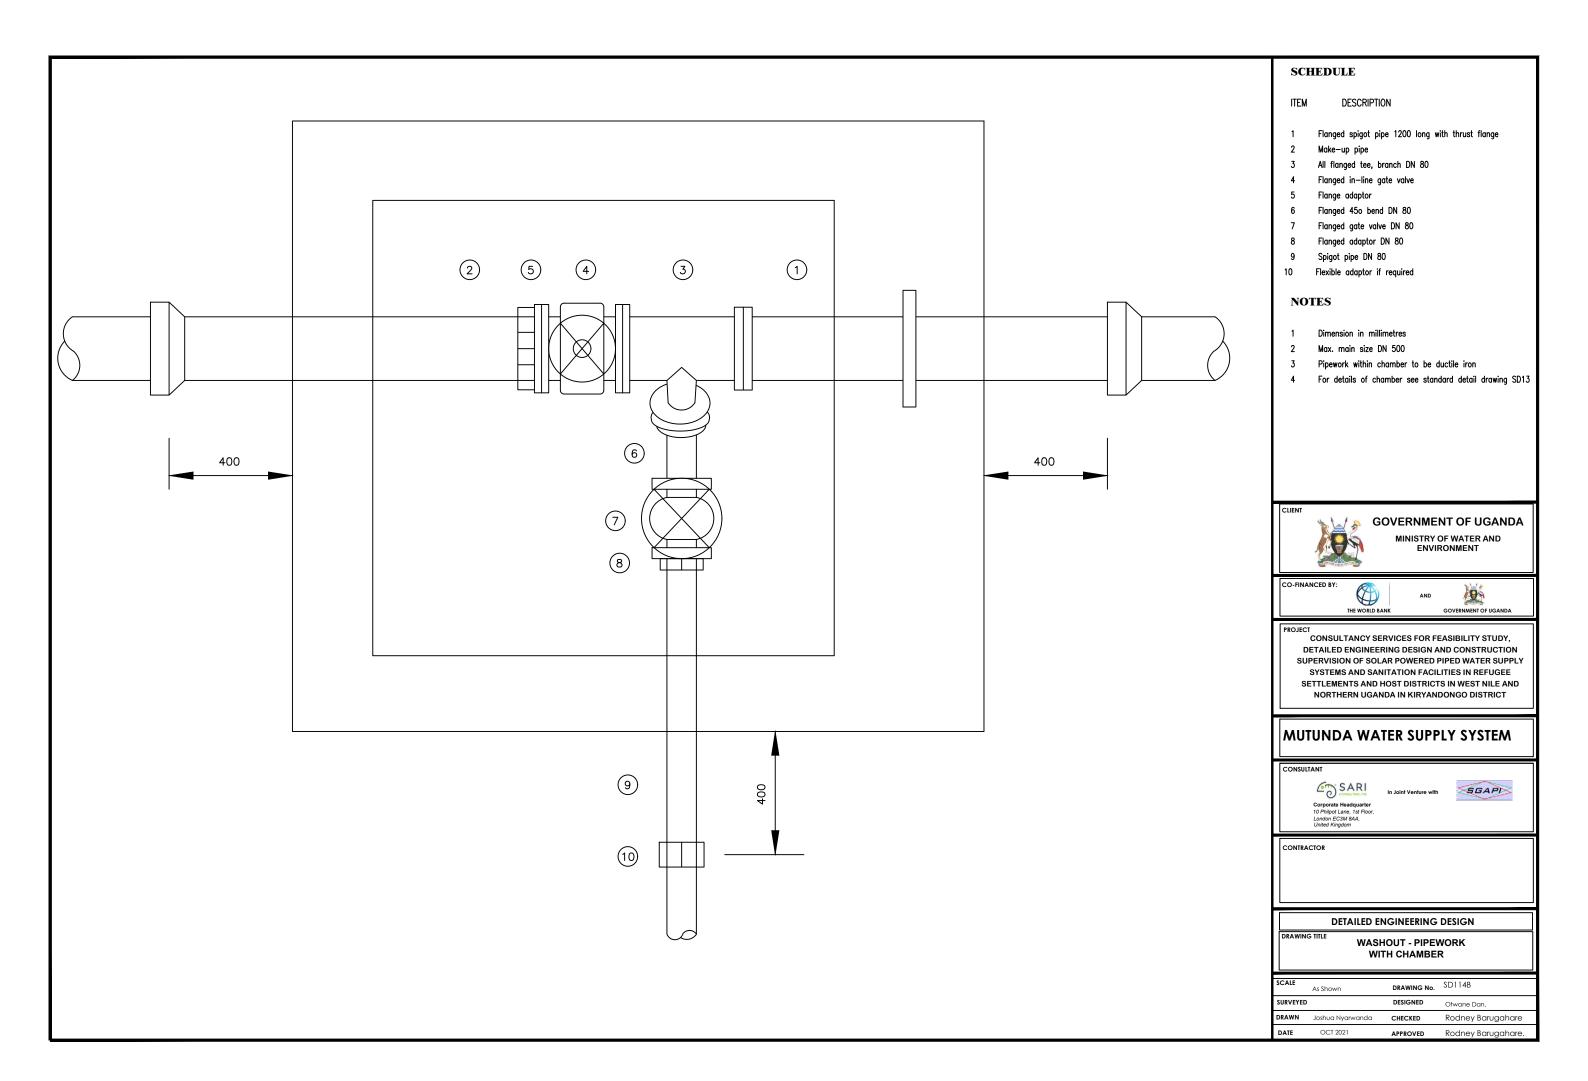


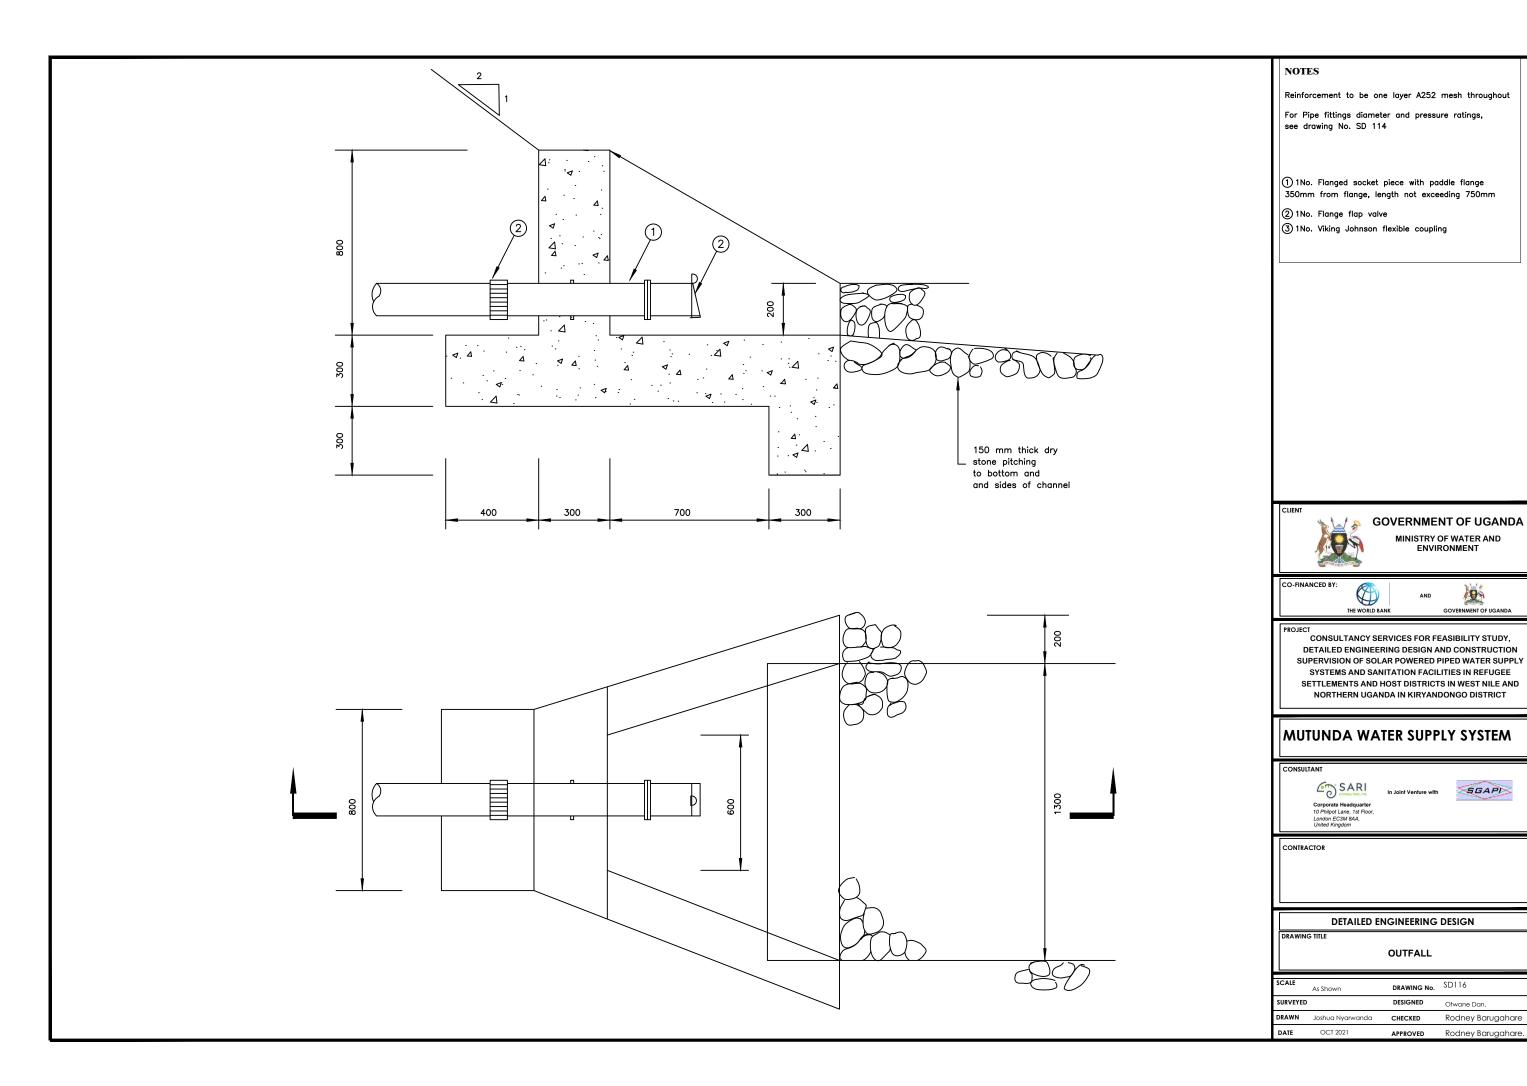

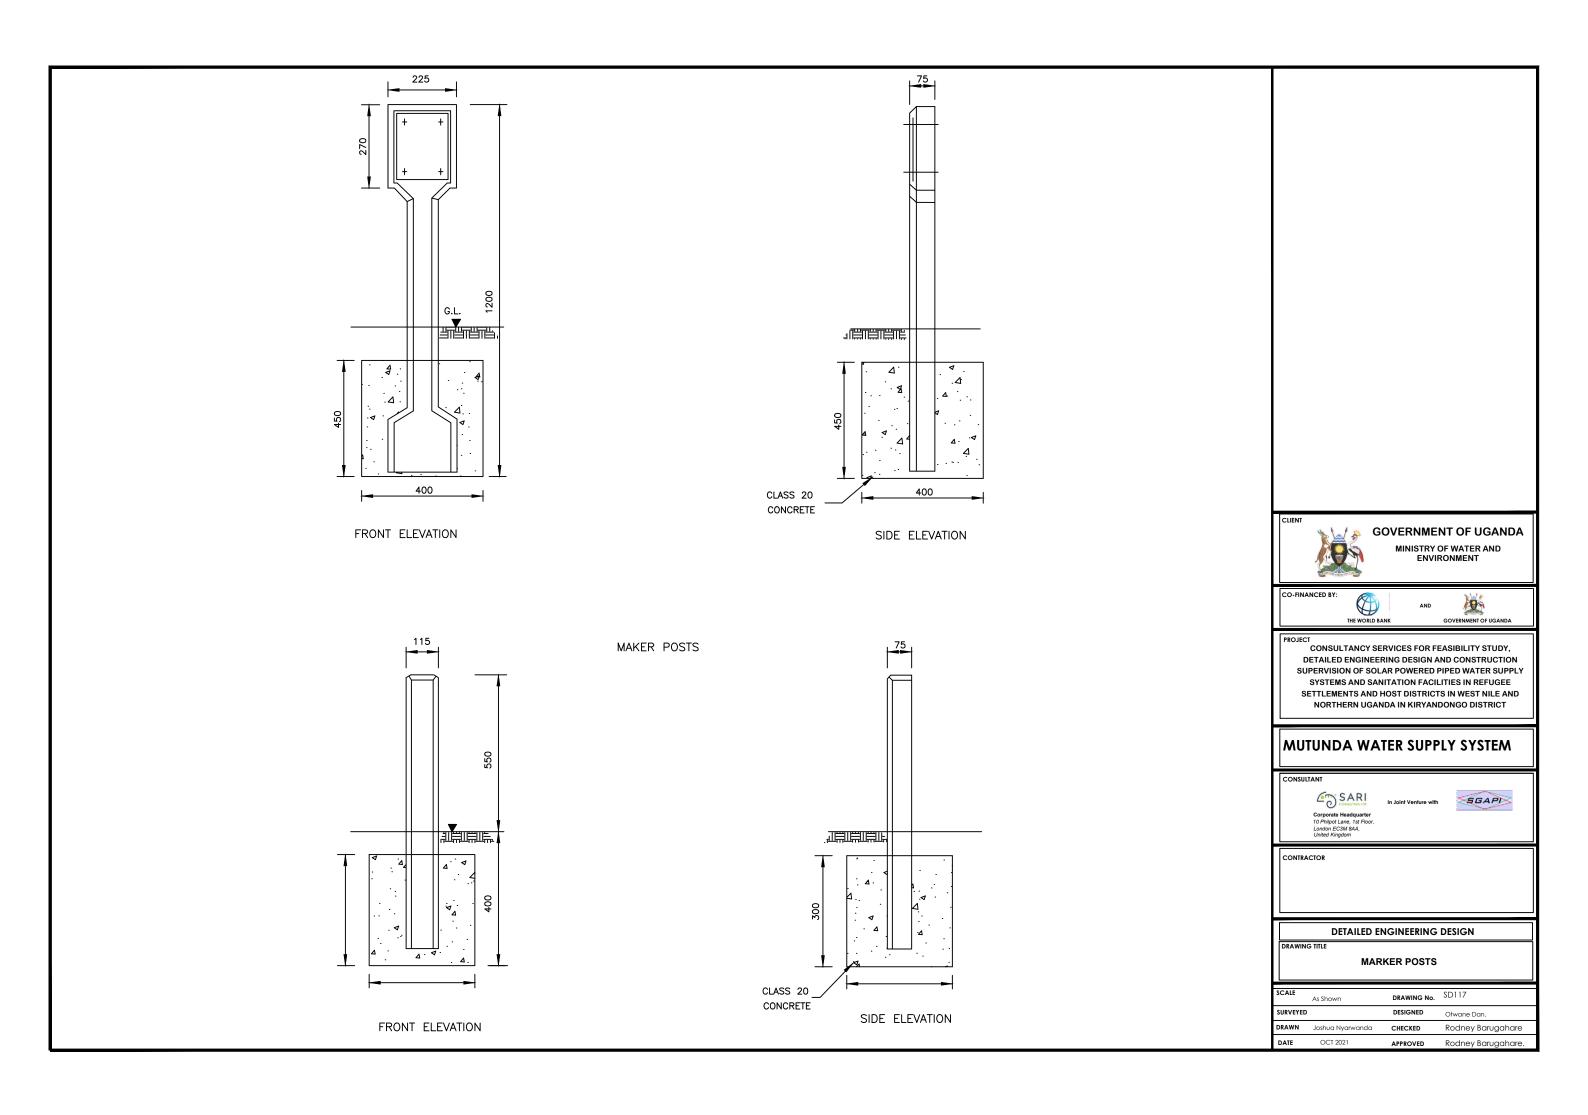

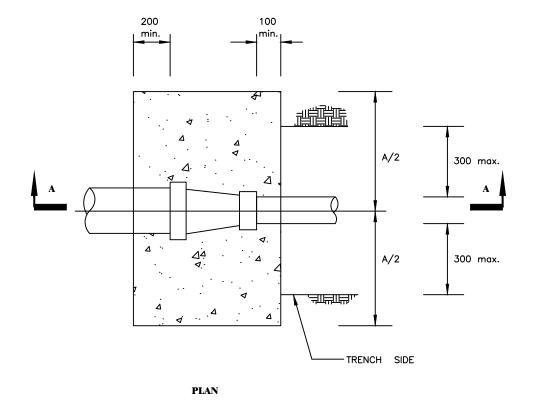



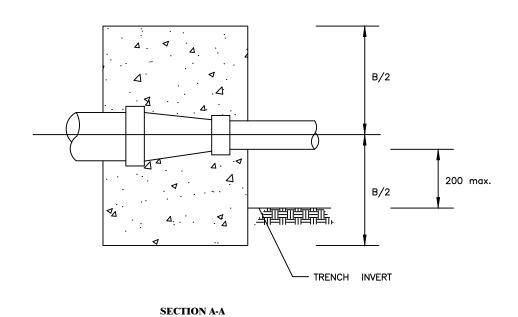

GROUND CONDITION		DRY	SUBMERGED
TEST PRESSURE (BAR)		15	15
80 - 50	A	850	850
	В	650	650
100 - 50	А	1020	1020
100 - 80	В	680	680
150 - 100	Α	1300	1300
	В	700	1000
200 - 100	А	1700	1900
	В	700	1000
200 - 150	A	1350	1350
	В	750	950
250 -100	А	2150	2250
	В	750	1250
250 - 150	А	1950	1950
	В	750	1250
250 - 200	A	1400	1400
	В	800	1200
300 - 200	А	2050	2050
	В	1000	1600
300 - 250	A	1450	1450
	В	850	1350
350 - 300	A	1250	1650
	В	1000	1200
500 - 400	A	2000	2300
	В	1400	1800



MINISTRY OF WATER AND ENVIRONMENT



CONSULTANCY SERVICES FOR FEASIBILITY STUDY, DETAILED ENGINEERING DESIGN AND CONSTRUCTION SUPERVISION OF SOLAR POWERED PIPED WATER SUPPLY SYSTEMS AND SANITATION FACILITIES IN REFUGEE SETTLEMENTS AND HOST DISTRICTS IN WEST NILE AND NORTHERN UGANDA IN KIRYANDONGO DISTRICT

MUTUNDA WATER SUPPLY SYSTEM







DETAILED ENGINEERING DESIGN

ANCHOR BLOCKS FOR TAPERS

SCALE	As Shown	DRAWING No.	SD118A
SURVEYED)	DESIGNED	Otwane Dan.
DRAWN	Joshua Nyarwanda	CHECKED	Rodney Barugahare
DATE	OCT 2021	APPROVED	Rodney Barugahare.

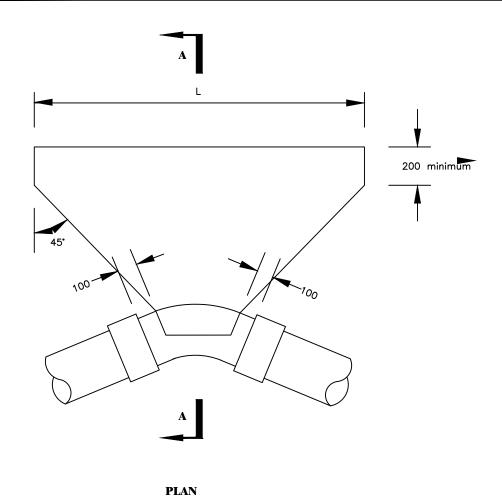

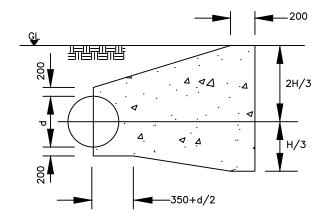

SECTION A-A

Ground Condition		DRY					
Test Pre	essure (Bar)			15			
Bend Angle			111/4*	22½*	45°	90*	
	80	H					
		Н	SEE SD 118C				
(80 < d < 150	L					
DIAMETER (mm)	450 700	Н					
~	150 < d < 300	L					
111		н			1600	1600	
IAME	300 < d < 400	L	2450 4530				
		Н			1650	1650	
PIPE	450	L			2900	5330	
-		Н	1000	1350	1800	1800	
	500	L	1250	1950	3050	5650	





MINISTRY OF WATER AND ENVIRONMENT





PROJECT CONSULTANCY SERVICES FOR FEASIBILITY STUDY, DETAILED ENGINEERING DESIGN AND CONSTRUCTION SUPERVISION OF SOLAR POWERED PIPED WATER SUPPLY SYSTEMS AND SANITATION FACILITIES IN REFUGEE SETTLEMENTS AND HOST DISTRICTS IN WEST NILE AND NORTHERN UGANDA IN KIRYANDONGO DISTRICT

MUTUNDA WATER SUPPLY SYSTEM






CONTRACTOR

DETAILED ENGINEERING DESIGN

SCALE	As Shown	DRAWING No.	SD118B
SURVEYED)	DESIGNED	Otwane Dan.
DRAWN	Joshua Nyarwanda	CHECKED	Rodney Barugahare
DATE	OCT 2021	APPROVED	Rodney Barugahare.

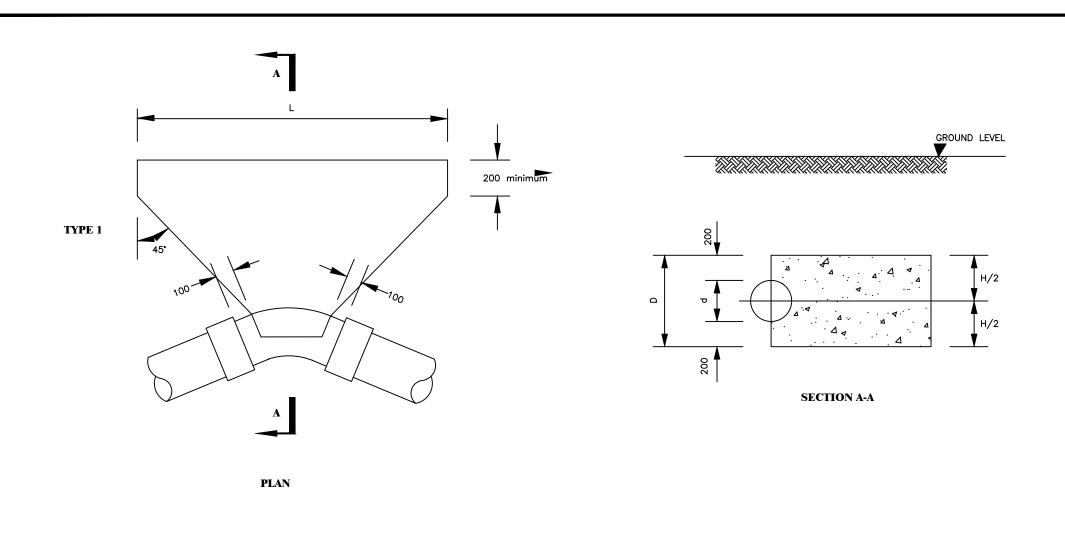

GR	GROUND CONDITION		DRY				
TES	TEST PRESSURE(Bar)			15			
BEI	ND ANGLE		11¼*	22½*	45*	90°	
		Н	480	460	480	460	
	80	L	200	300	350	700	
		Н	550	550	550	550	
	80 < d < 150	L	300	750	900	1700	
		Н	700	700	700		
Ē	150 < d < 3QQ	L	650	1250	2500		
DIAMETER (mm)		Н	800	800			
ÆTEF	300 < d < 4QQ	L	900	1800			
DIA		Н	900	900			
PIPE	450	L	2500	5000			
	500			SEE	SD 118A		





MINISTRY OF WATER AND ENVIRONMENT



CONSULTANCY SERVICES FOR FEASIBILITY STUDY, DETAILED ENGINEERING DESIGN AND CONSTRUCTION SUPERVISION OF SOLAR POWERED PIPED WATER SUPPLY SYSTEMS AND SANITATION FACILITIES IN REFUGEE SETTLEMENTS AND HOST DISTRICTS IN WEST NILE AND NORTHERN UGANDA IN KIRYANDONGO DISTRICT


MUTUNDA WATER SUPPLY SYSTEM





DETAILED ENGINEERING DESIGN

SCALE	As Shown	DRAWING No.	SD118C
SURVEYED		DESIGNED	Otwane Dan.
DRAWN	Joshua Nyarwanda	CHECKED	Rodney Barugahare
DATE	OCT 2021	APPROVED	Rodney Barugahare.

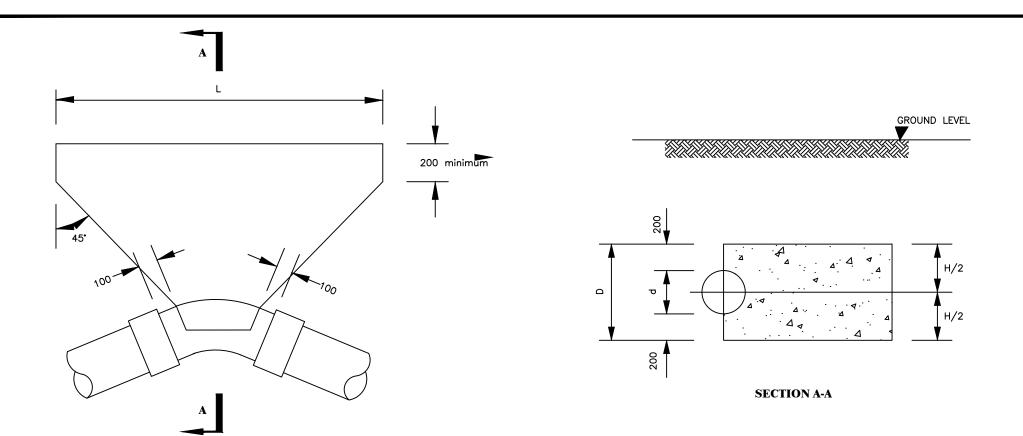

PLAN

GROUND	CONDITION			SUBMER	GED	
TEST PRE	ESSURE (Bar)			1	15	
BEI	ND ANGLE		11¼°	22½*	45*	90°
		Н	450	480	480	480
	80	L	250	300	600	1100
	80 < d < 150	н	550	550	550	
		L	400	750	1500	
	150 < d < 3QQ	Н	700	700		•
(mm)		L	1050	2050		
		Н	800	800		
DIAMETER	300 < d < 4QQ	L	1500	1500		
DIAN		н	900		-	
PIPE	450	L	4200			
		Н		SEE SD	118E	
	500	L				

NOTE:

Two layers of water proof paper to be placed between concrete fitting

GOVERNMENT OF UGANDA

MINISTRY OF WATER AND ENVIRONMENT





CONSULTANCY SERVICES FOR FEASIBILITY STUDY, DETAILED ENGINEERING DESIGN AND CONSTRUCTION SUPERVISION OF SOLAR POWERED PIPED WATER SUPPLY SYSTEMS AND SANITATION FACILITIES IN REFUGEE SETTLEMENTS AND HOST DISTRICTS IN WEST NILE AND NORTHERN UGANDA IN KIRYANDONGO DISTRICT

MUTUNDA WATER SUPPLY SYSTEM







CONTRACTOR

DETAILED ENGINEERING DESIGN

SCALE	As Shown	DRAWING No.	SD118D
SURVEYED)	DESIGNED	Otwane Dan.
DRAWN	Joshua Nyarwanda	CHECKED	Rodney Barugahare
DATE	OCT 2021	APPROVED	Rodney Barugahare.

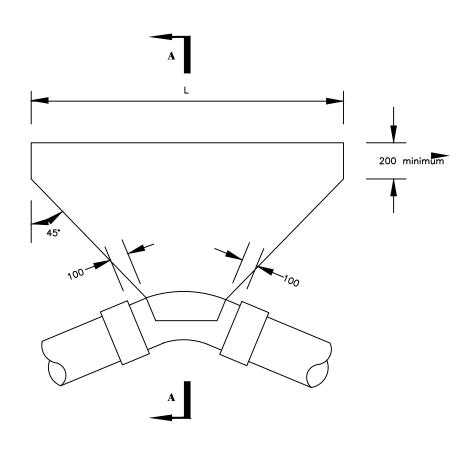

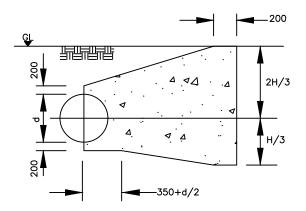

SECTION A-A

PLAN

Ground C	ondition			SUBMER	RGED	
Test Pres	ssure (Bar)			1	5	
Ben	nd Angle		111/4*	22%*	45*	90°
		н			l	l
	80	L				
		Н		SEE SD 11	18D	1350
	80 < d < 150	L				1650
		Н			1500	1500
Œ	150 < d < 3QQ	L			2650	4900
DIAMETER (mm)		Н			1600	1700
ETER	300 < d < 4QQ	L			4050	6650
DIAN		Н		1650	1650	1800
PIPE	450	L		2450	4750	6650
		Н	1400	1800	1800	1800
	500	L	1650	2850	5450	10150

NOTE:

Two layers of water proof paper to be placed between concrete fitting



GOVERNMENT OF UGANDA

MINISTRY OF WATER AND ENVIRONMENT

CO-FINANCED E



ND D

CONSULTANCY SERVICES FOR FEASIBILITY STUDY,
DETAILED ENGINEERING DESIGN AND CONSTRUCTION
SUPERVISION OF SOLAR POWERED PIPED WATER SUPPLY

SYSTEMS AND SANITATION FACILITIES IN REFUGEE
SETTLEMENTS AND HOST DISTRICTS IN WEST NILE AND
NORTHERN UGANDA IN KIRYANDONGO DISTRICT

MUTUNDA WATER SUPPLY SYSTEM

CONSULTANT



In Joint Venture with





CONTRACTOR


DETAILED ENGINEERING DESIGN

A NIC

SCALE	As Shown	DRAWING No.	SD118E
SURVEYED		DESIGNED	Otwane Dan.
DRAWN	Joshua Nyarwanda	CHECKED	Rodney Barugahare
DATE	OCT 2021	APPROVED	Rodney Barugahare.

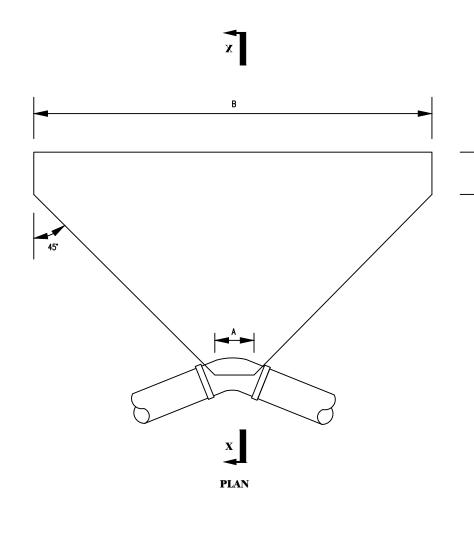

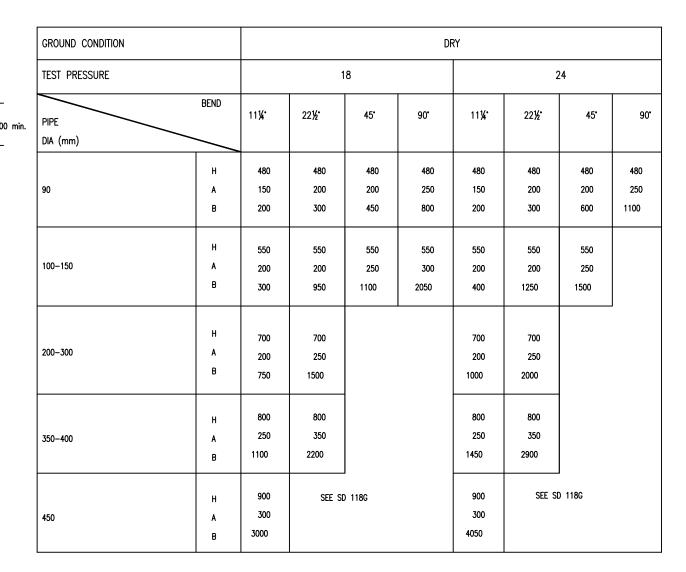

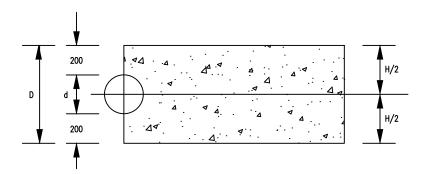

NOTE:

Two layers of water proof paper to be placed between concrete fitting



GOVERNMENT OF UGANDA

MINISTRY OF WATER AND ENVIRONMENT





CONSULTANCY SERVICES FOR FEASIBILITY STUDY, DETAILED ENGINEERING DESIGN AND CONSTRUCTION SUPERVISION OF SOLAR POWERED PIPED WATER SUPPLY SYSTEMS AND SANITATION FACILITIES IN REFUGEE SETTLEMENTS AND HOST DISTRICTS IN WEST NILE AND NORTHERN UGANDA IN KIRYANDONGO DISTRICT


MUTUNDA WATER SUPPLY SYSTEM





DETAILED ENGINEERING DESIGN

SCALE	As Shown	DRAWING No.	SD118F		
SURVEYE	:D	DESIGNED	Otwane Dan.		
DRAWN	Joshua Nyarwanda	CHECKED	Rodney Barugahare		
DATE	OCT 2021	APPROVED	Rodney Barugahare.		

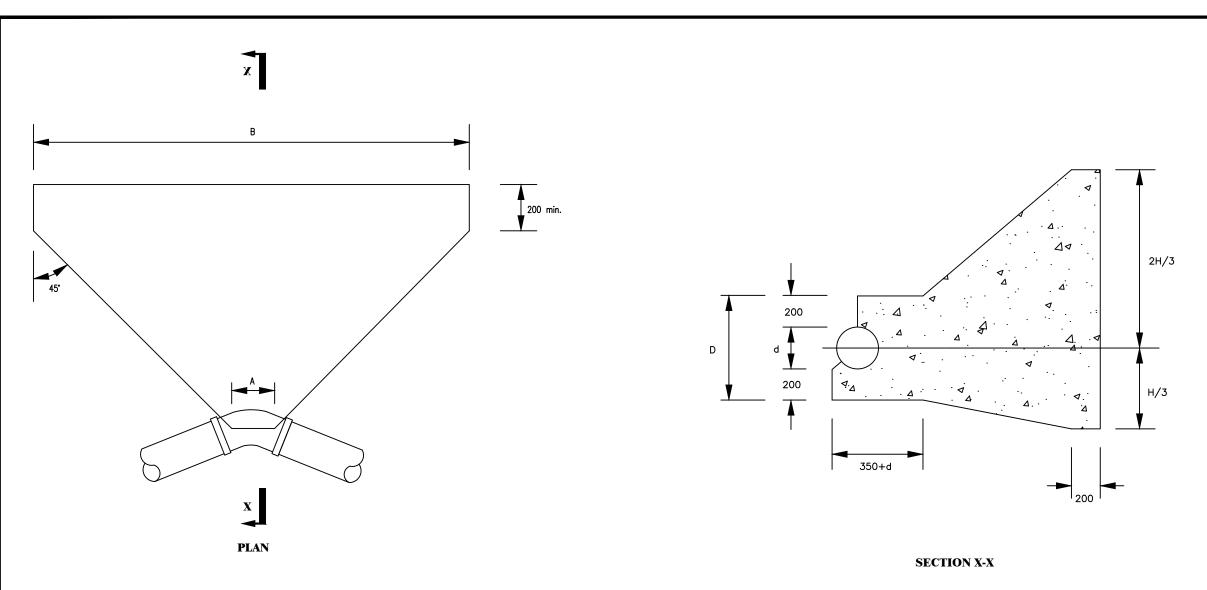

Ground Condition					D	RY				
Test Pressure			18				24			
Pipe Dia (mm)	Bend	111/4*	22½*	45°	90°	11¼*	22½*	45*	90°	
100 - 150	H A B		SEE SD	118C			SEE SD	118C	1350 300 1600	
200-300	H A B			1500 350 1930	1500 500 3560			1500 350 3520	1500 500 4760	
350 - 400	H A B			1600 550 2950	1600 850 5440			1600 550 3920	1800 850 5700	
450	H A B		1650 400 1760	1650 650 346	1650 1050 6400		1650 400 2350	1650 650 4600	1900 1050 6450	



MINISTRY OF WATER AND ENVIRONMENT





CONSULTANCY SERVICES FOR FEASIBILITY STUDY, DETAILED ENGINEERING DESIGN AND CONSTRUCTION SUPERVISION OF SOLAR POWERED PIPED WATER SUPPLY SYSTEMS AND SANITATION FACILITIES IN REFUGEE SETTLEMENTS AND HOST DISTRICTS IN WEST NILE AND NORTHERN UGANDA IN KIRYANDONGO DISTRICT

MUTUNDA WATER SUPPLY SYSTEM








DETAILED ENGINEERING DESIGN

ANCHOR BLOCKS FOR BENDS - 6

DRAWING No. SD118G SURVEYED DESIGNED **DRAWN** Joshua Nyarwanda CHECKED Rodney Barugahare DATE

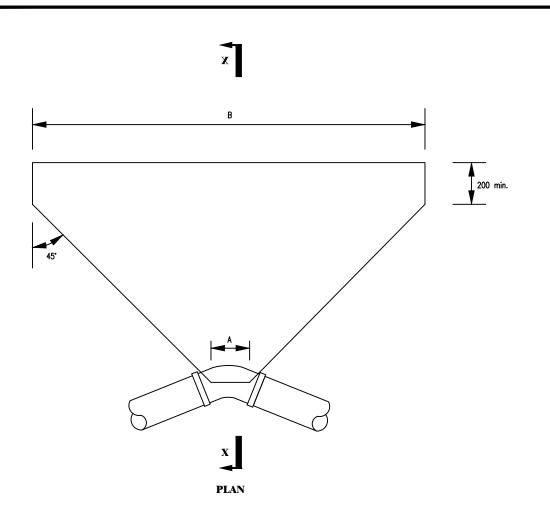

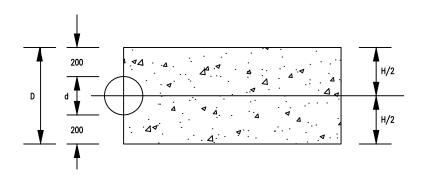

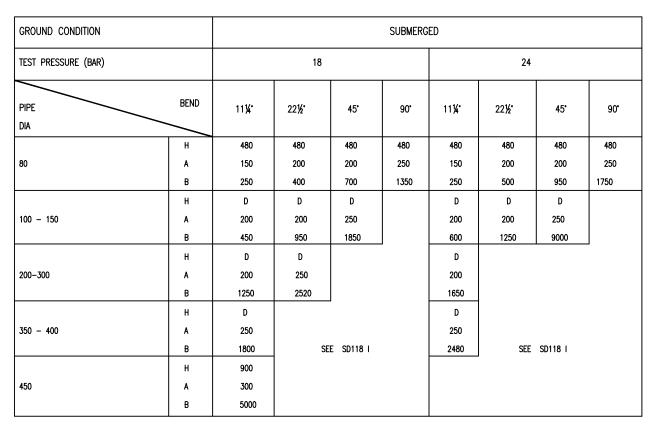





GOVERNMENT OF UGANDA

MINISTRY OF WATER AND ENVIRONMENT





CONSULTANCY SERVICES FOR FEASIBILITY STUDY, DETAILED ENGINEERING DESIGN AND CONSTRUCTION SUPERVISION OF SOLAR POWERED PIPED WATER SUPPLY SYSTEMS AND SANITATION FACILITIES IN REFUGEE SETTLEMENTS AND HOST DISTRICTS IN WEST NILE AND NORTHERN UGANDA IN KIRYANDONGO DISTRICT


MUTUNDA WATER SUPPLY SYSTEM






DETAILED ENGINEERING DESIGN

SCALE	As Shown	DRAWING No.	SD118H
SURVEYED		DESIGNED	Otwane Dan.
DRAWN	Joshua Nyarwanda	CHECKED	Rodney Barugahare
DATE	OCT 2021	APPROVED	Rodney Barugahare.

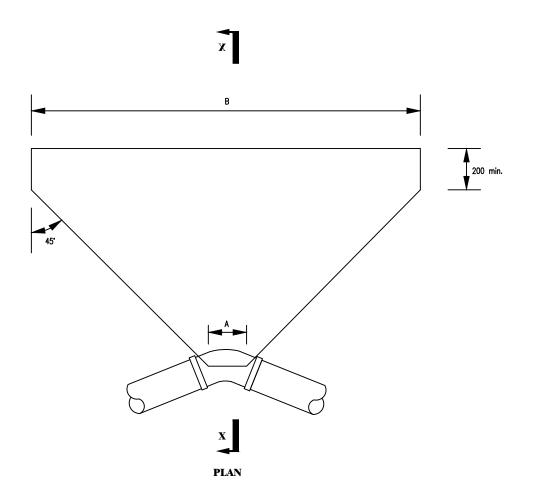

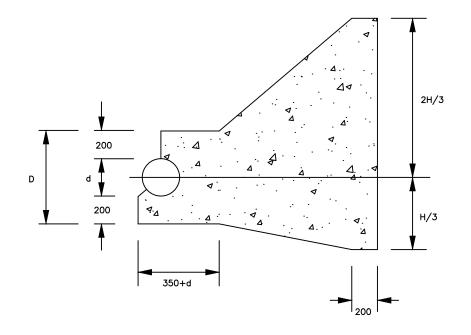

Ground Condition	SUBMERGED								
Test Pressure			18			24			
Pipe Dia (mm)	Bend	111/4*	22½*	45°	90*	11¼*	22½*	45°	90°
	Н				1350		<u> </u>		1350
100 - 150	A				300				300
	В		SEE SD	118D	2000		SEE SD	118D	2650
	Н	-		1500	1500	-	1500	1500	1500
200-300	A			350	500		250	350	500
	В			3200	5900		2150	4250	7850
	Н		1600	1600	1800	1	1600	1600	2000
350 - 400	"		350	550	850		350	550	850
330 - 400	B		2500	4850	7100		3300	6500	7650
		4							
	н		1650	1650	2000	1650	1650	1650	2200
450	A		400	650	1050	250	400	650	1050
	В		2900	5700	7200	1950	3900	7600	7900



GOVERNMENT OF UGANDA

MINISTRY OF WATER AND ENVIRONMENT



CONSULTANCY SERVICES FOR FEASIBILITY STUDY, DETAILED ENGINEERING DESIGN AND CONSTRUCTION SUPERVISION OF SOLAR POWERED PIPED WATER SUPPLY SYSTEMS AND SANITATION FACILITIES IN REFUGEE SETTLEMENTS AND HOST DISTRICTS IN WEST NILE AND NORTHERN UGANDA IN KIRYANDONGO DISTRICT


MUTUNDA WATER SUPPLY SYSTEM






DETAILED ENGINEERING DESIGN

-				
	SCALE	As Shown	DRAWING No.	SD118I
	SURVEYED		DESIGNED	Otwane Dan.
	DRAWN	Joshua Nyarwanda	CHECKED	Rodney Barugahare
	DATE	OCT 2021	APPROVED	Rodney Barugahare.

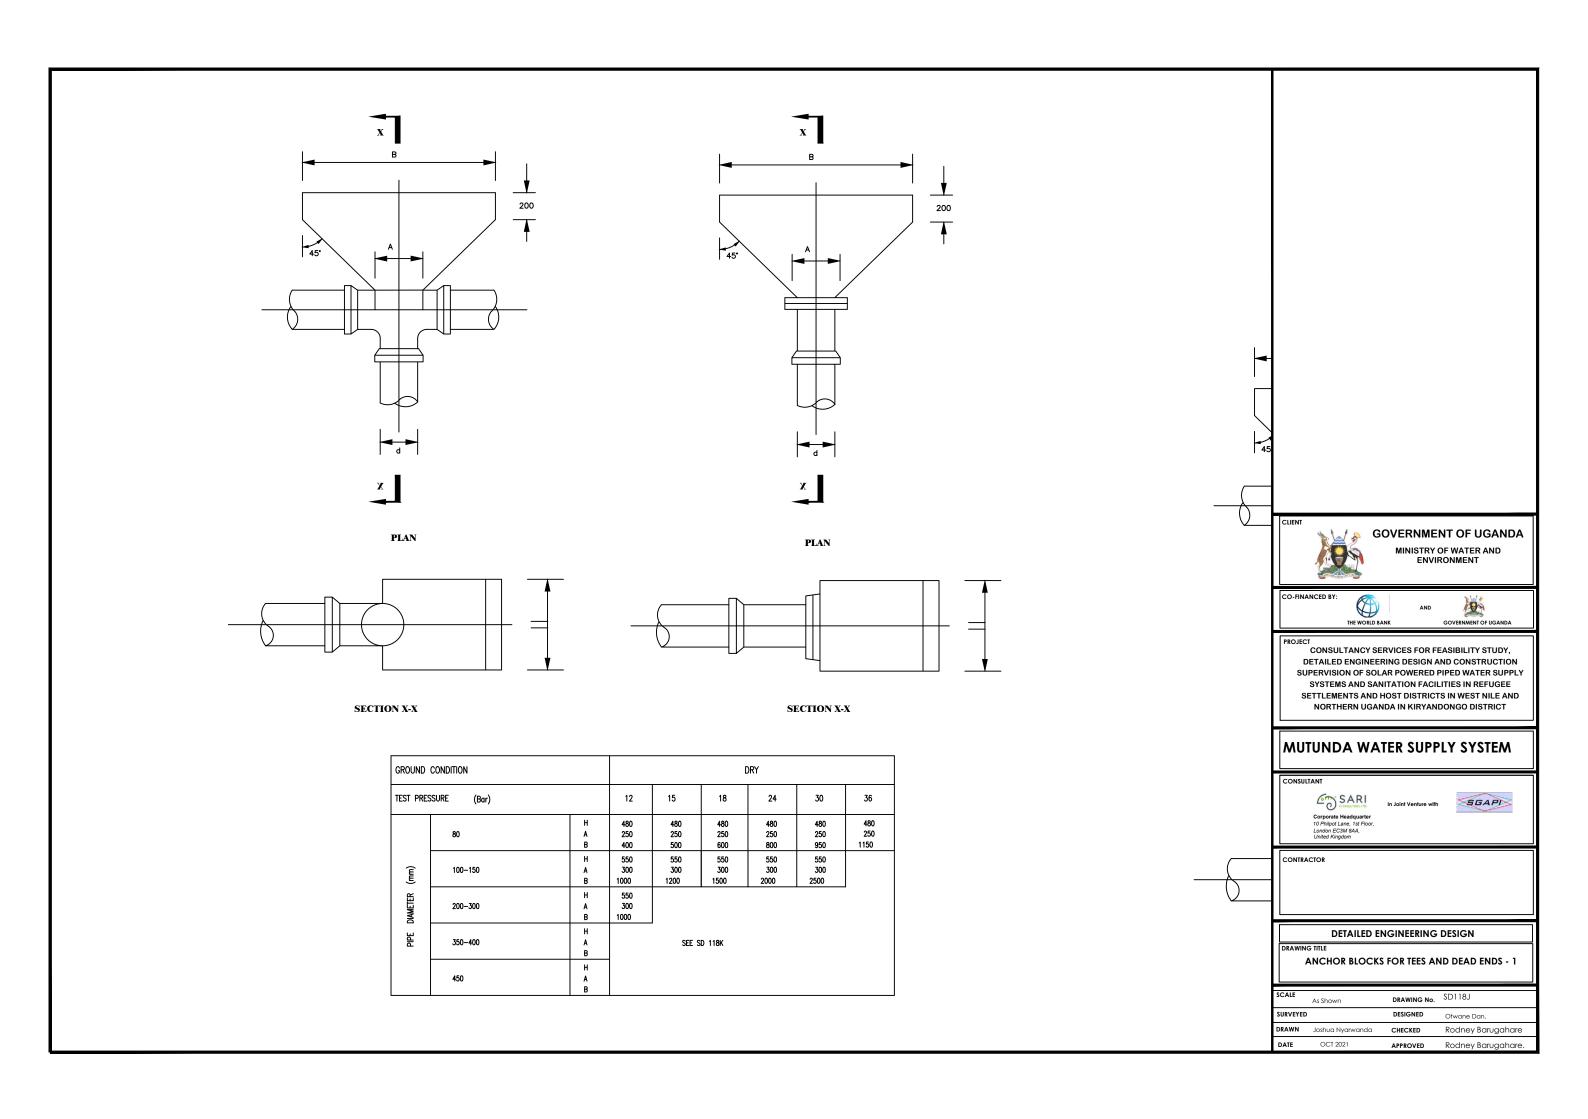

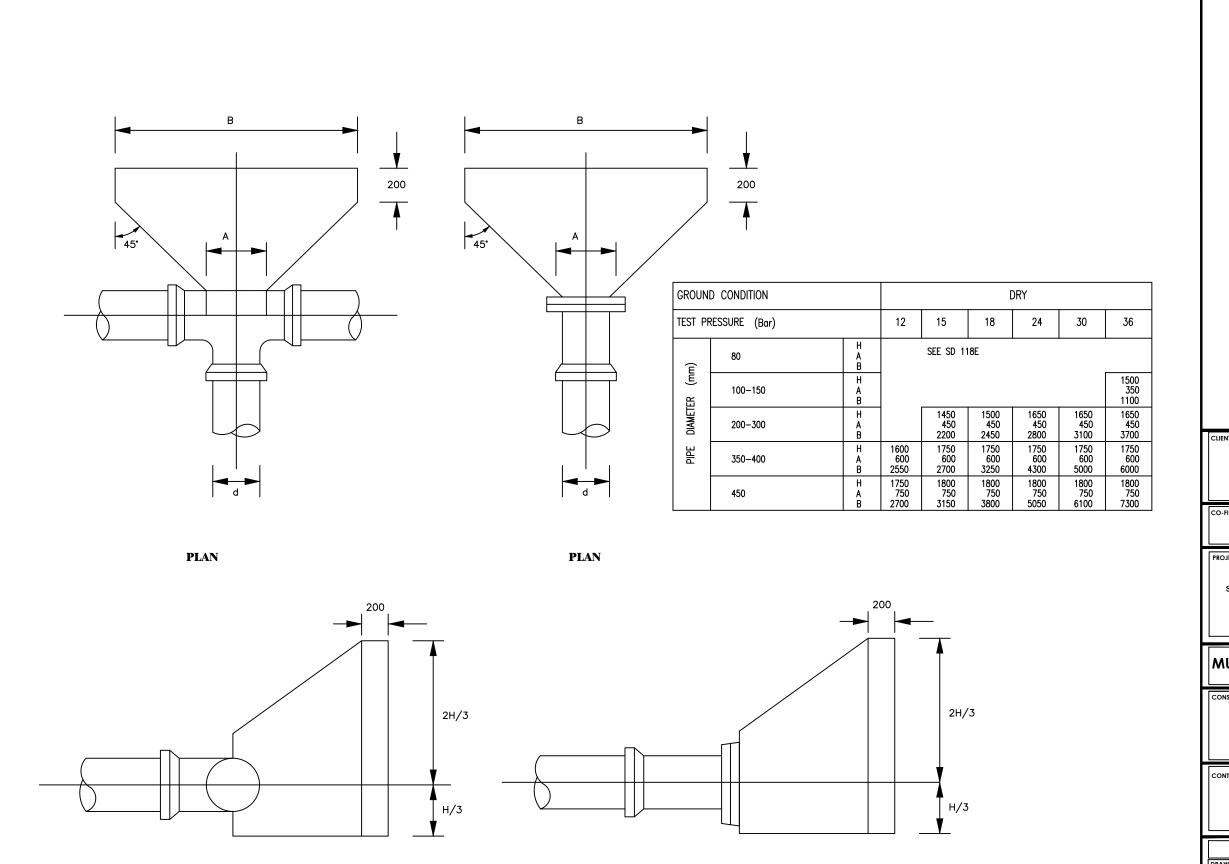

SECTION X-X



GOVERNMENT OF UGANDA

MINISTRY OF WATER AND ENVIRONMENT





CONSULTANCY SERVICES FOR FEASIBILITY STUDY, DETAILED ENGINEERING DESIGN AND CONSTRUCTION SUPERVISION OF SOLAR POWERED PIPED WATER SUPPLY SYSTEMS AND SANITATION FACILITIES IN REFUGEE SETTLEMENTS AND HOST DISTRICTS IN WEST NILE AND NORTHERN UGANDA IN KIRYANDONGO DISTRICT

MUTUNDA WATER SUPPLY SYSTEM








DETAILED ENGINEERING DESIGN


ANCHOR BLOCKS FOR TEES AND DEAD ENDS - 2


SCALE	As Shown	DRAWING No.	SD118K
SURVEYE	D	DESIGNED	Otwane Dan.
DRAWN	Joshua Nyarwanda	CHECKED	Rodney Barugahare
DATE	OCT 2021	APPROVED	Rodney Barugahare.

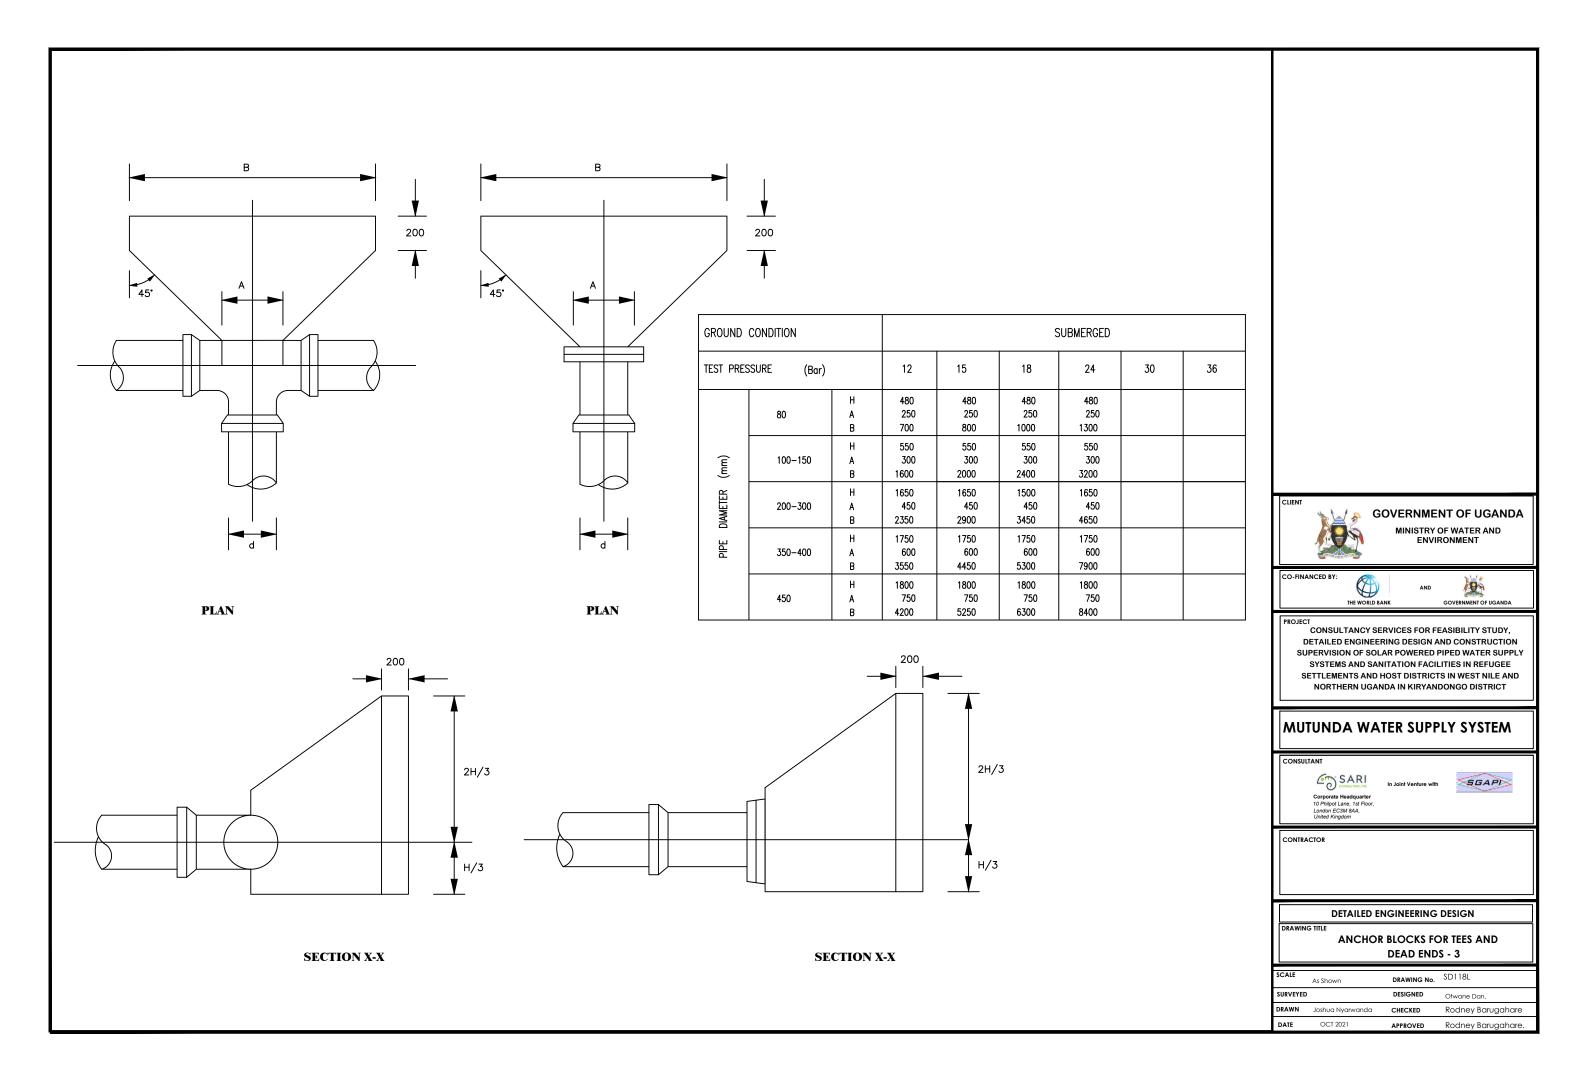


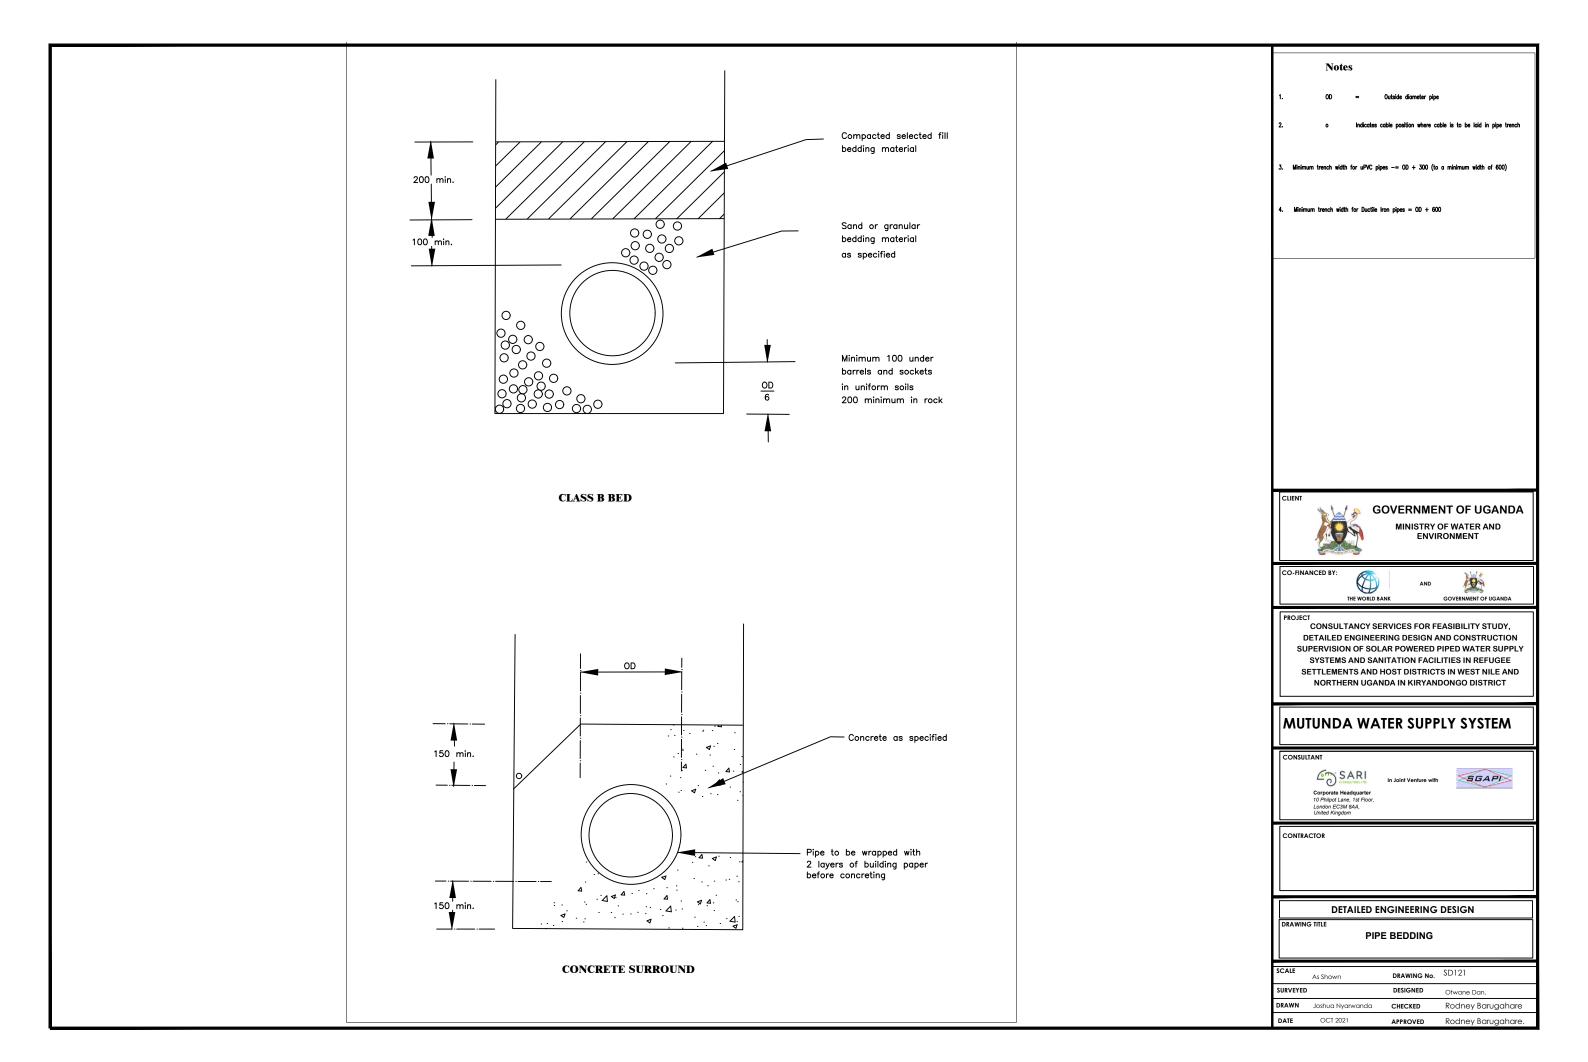


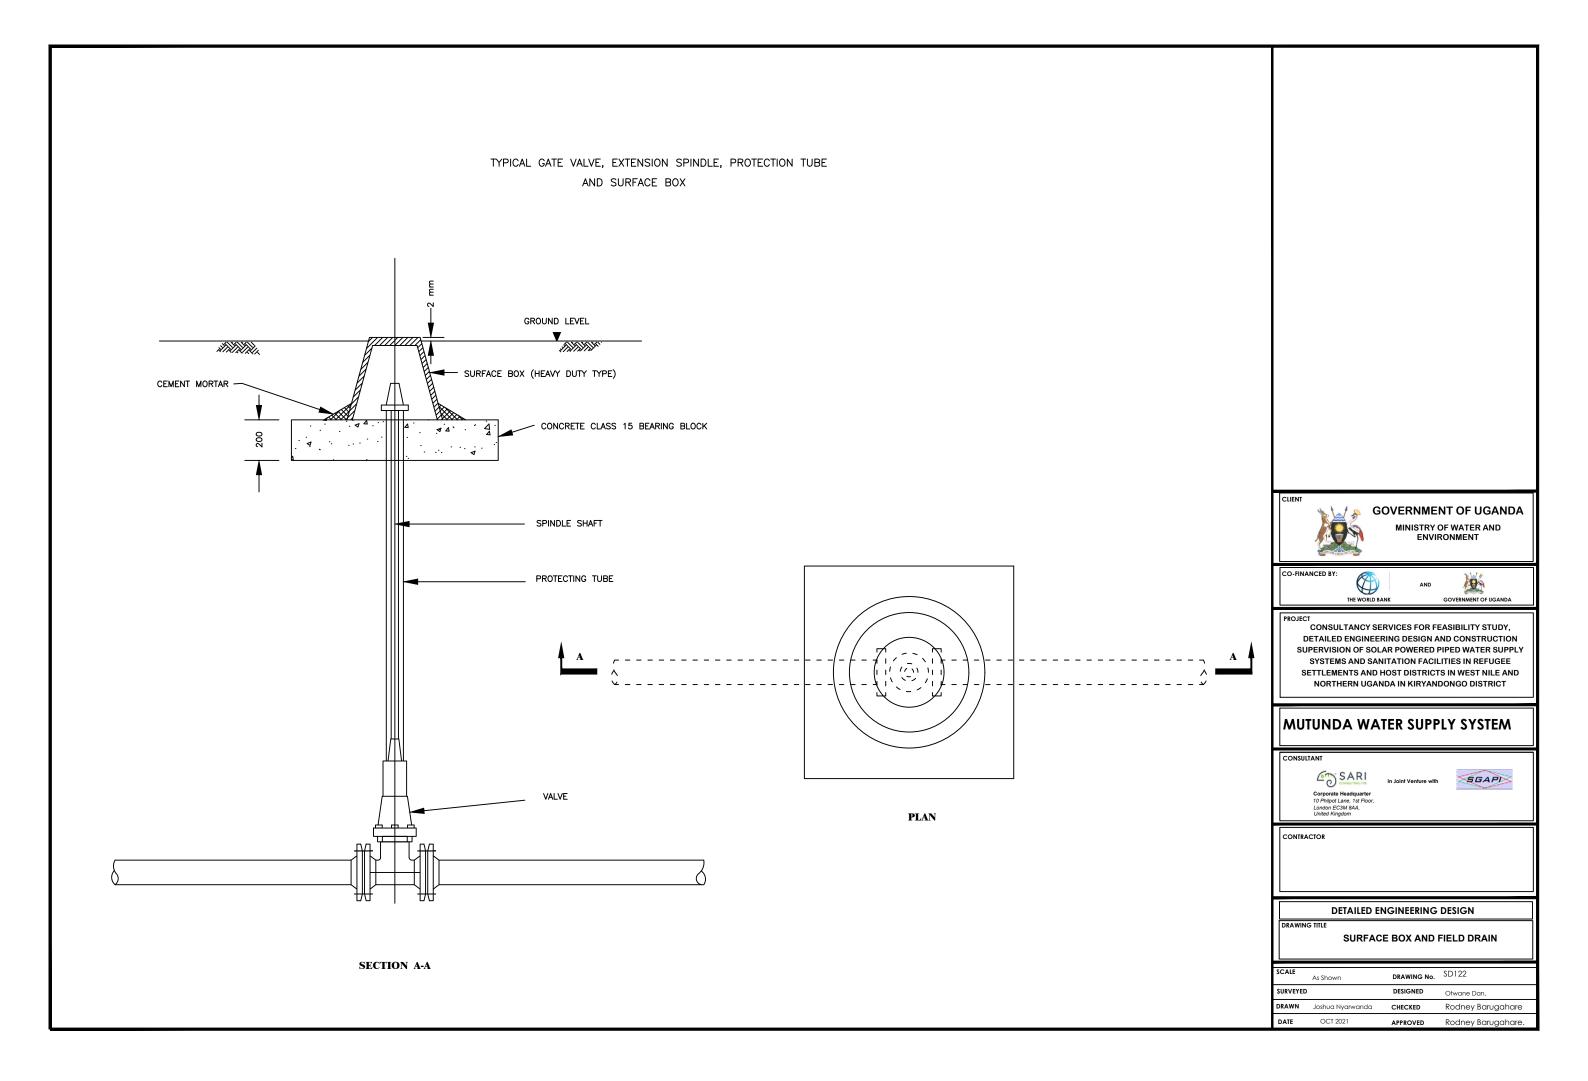


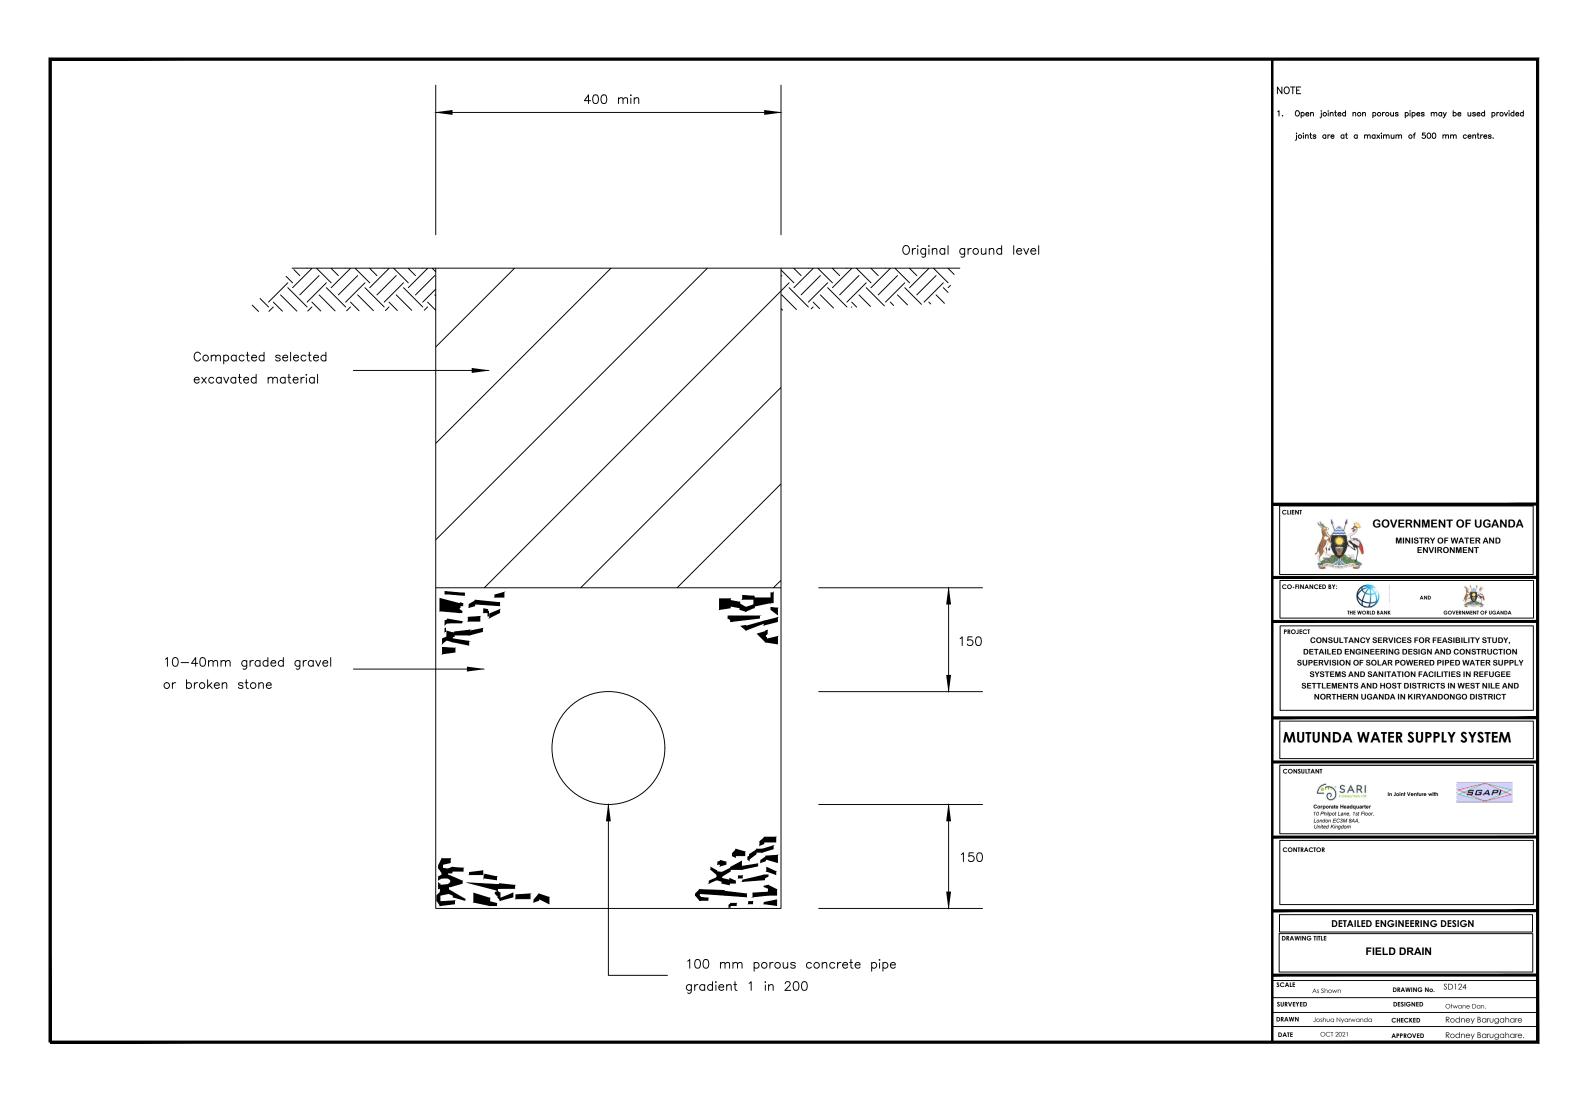

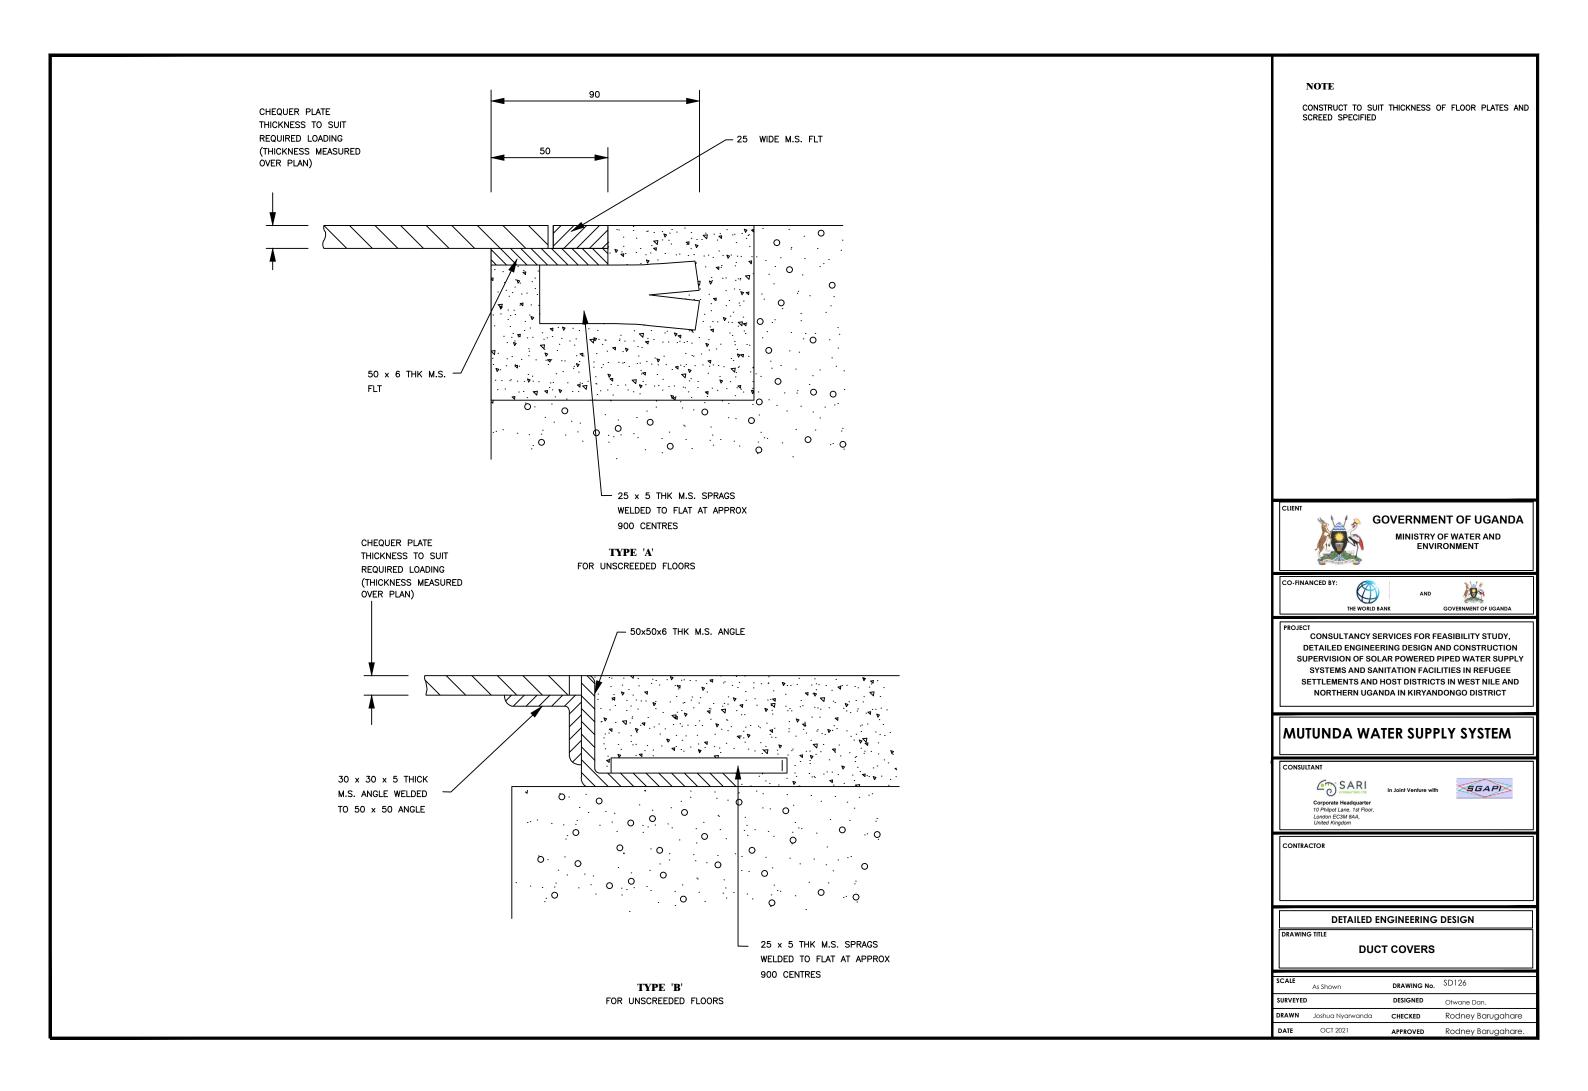

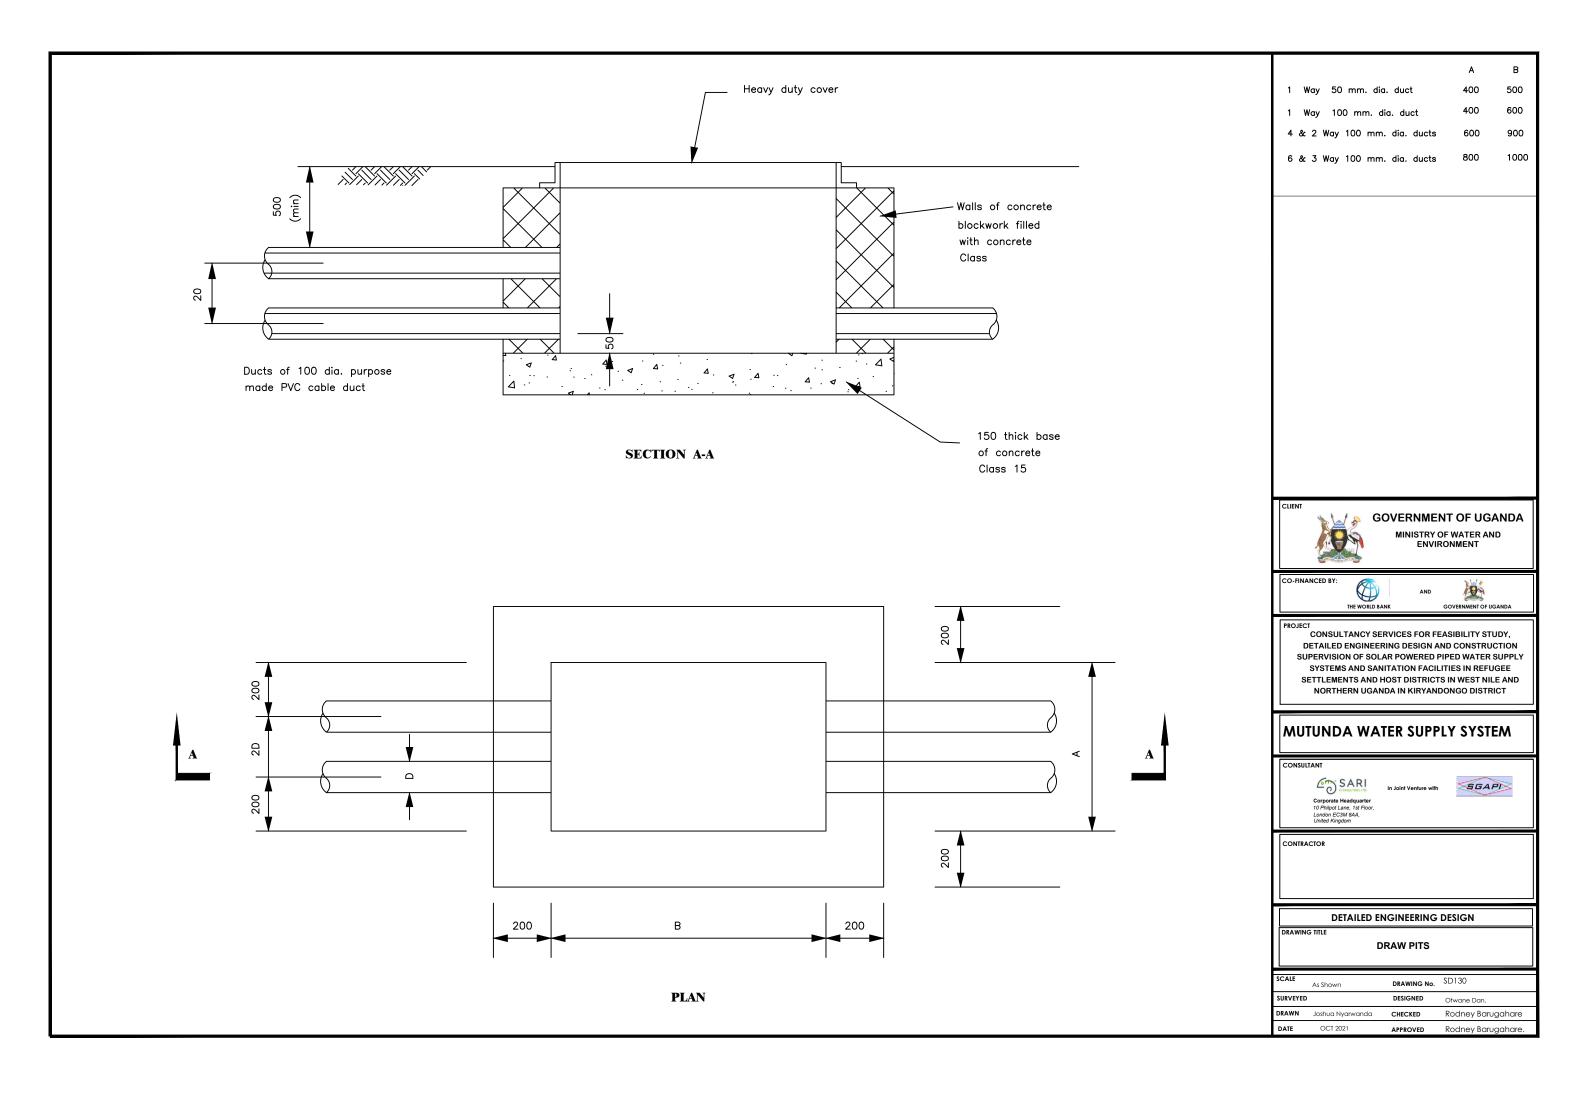

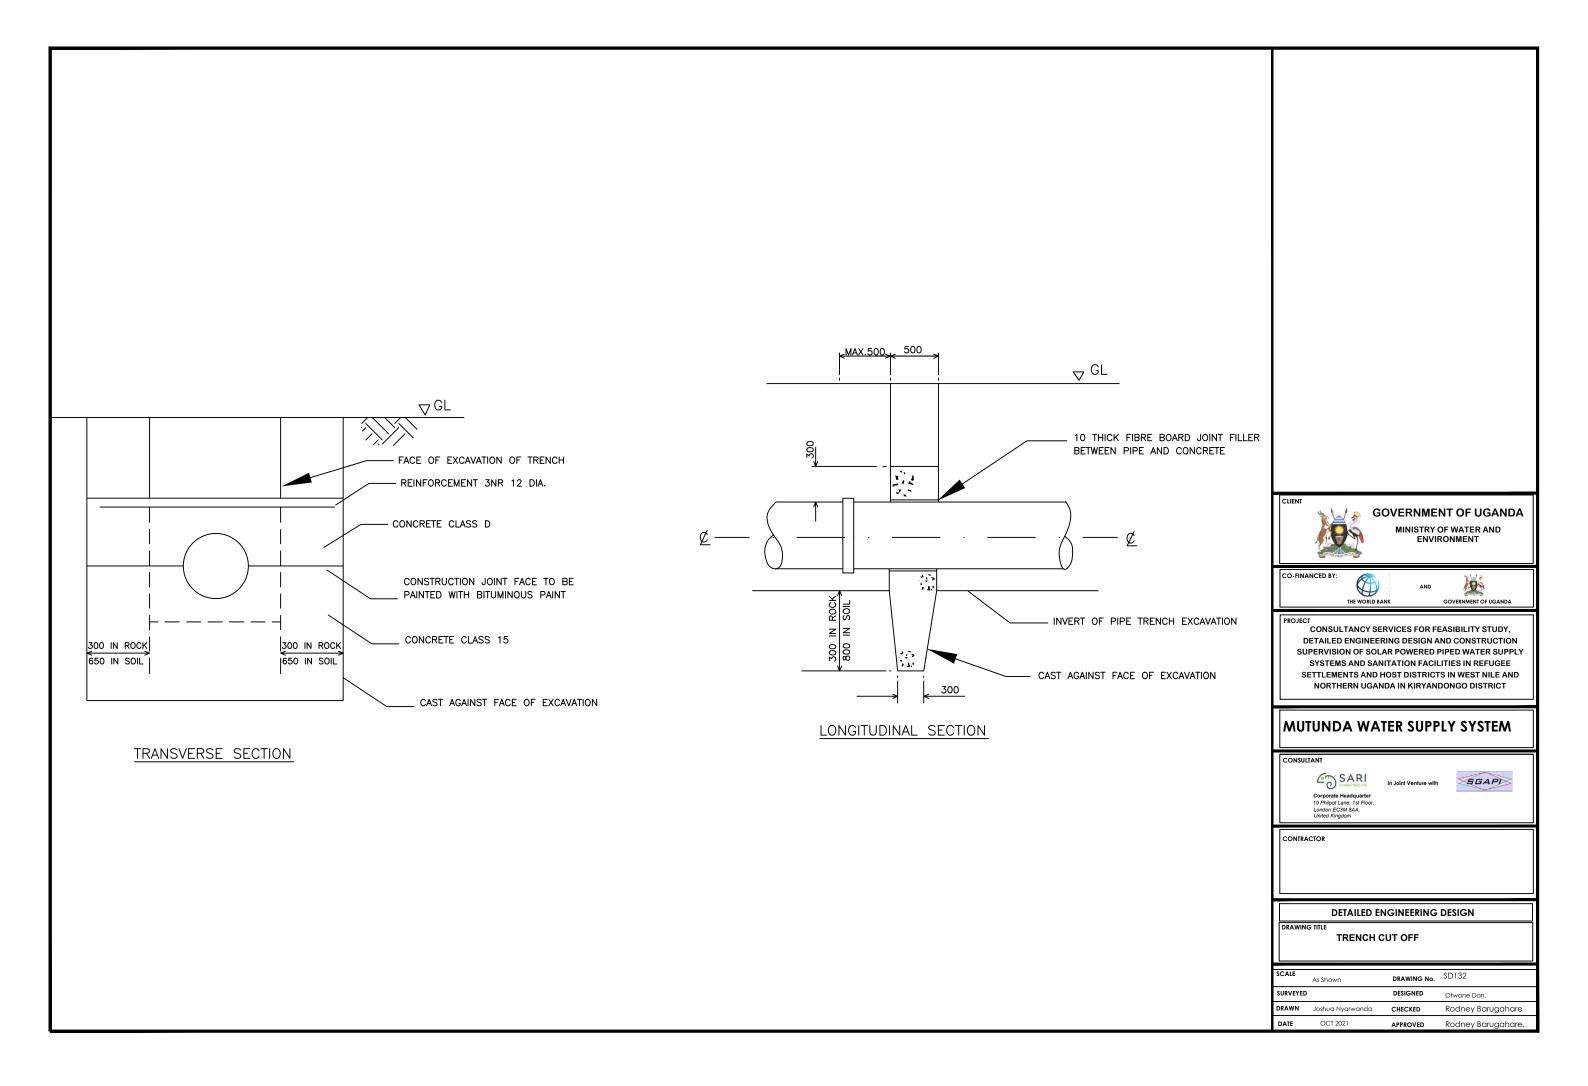

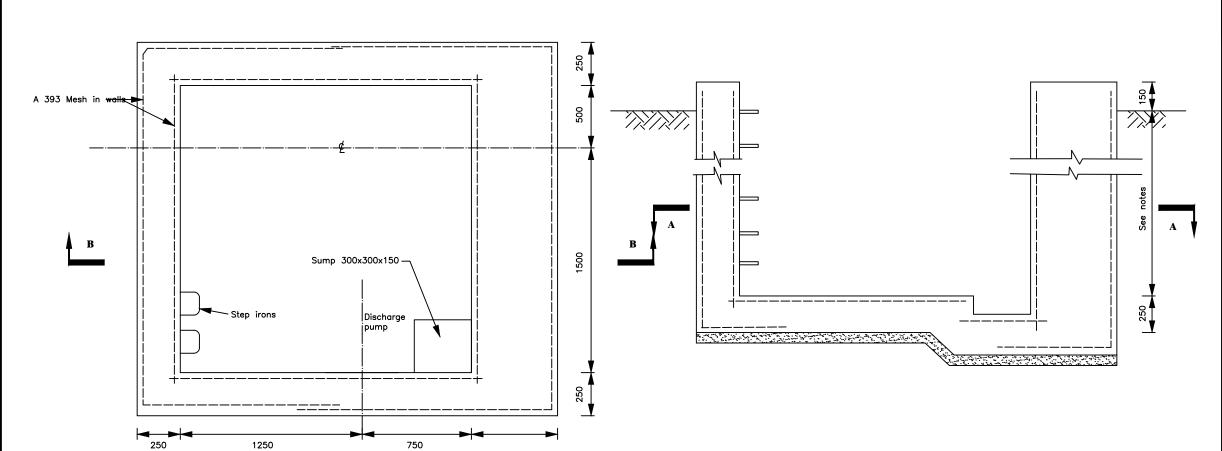

SECTION B-B

SECTION A-A

- 1. Floor of chamber to be 250 below pipe IL ? min depth 1700 below

- 4. Use SD 135b if additional thrust block is required



GOVERNMENT OF UGANDA

MINISTRY OF WATER AND ENVIRONMENT



CONSULTANCY SERVICES FOR FEASIBILITY STUDY, DETAILED ENGINEERING DESIGN AND CONSTRUCTION SUPERVISION OF SOLAR POWERED PIPED WATER SUPPLY SYSTEMS AND SANITATION FACILITIES IN REFUGEE SETTLEMENTS AND HOST DISTRICTS IN WEST NILE AND NORTHERN UGANDA IN KIRYANDONGO DISTRICT

MUTUNDA WATER SUPPLY SYSTEM







DETAILED ENGINEERING DESIGN

WASHOUT/GATE VALVE CHAMBER-R.C. DETAILS

SCALE	As Shown	DRAWING No.	SD135A
SURVEYED		DESIGNED	Otwane Dan.
DRAWN	Joshua Nyarwanda	CHECKED	Rodney Barugahare
DATE	OCT 2021	APPROVED	Rodney Barugahare.

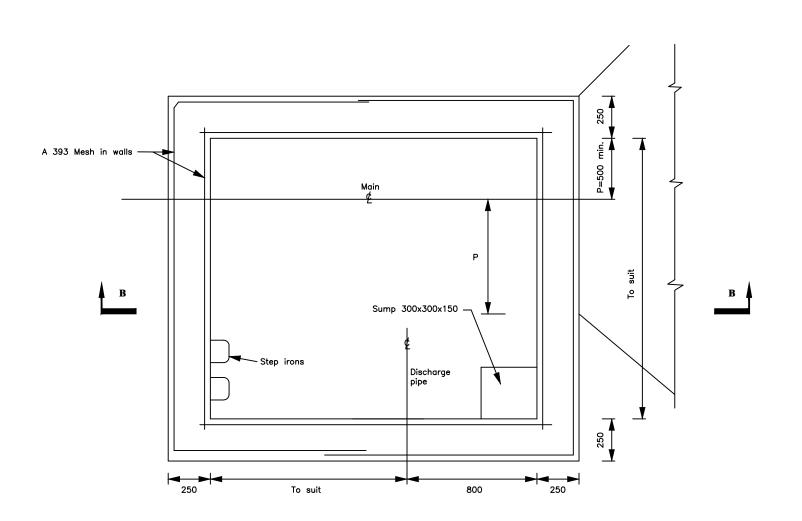

SECTION A-A

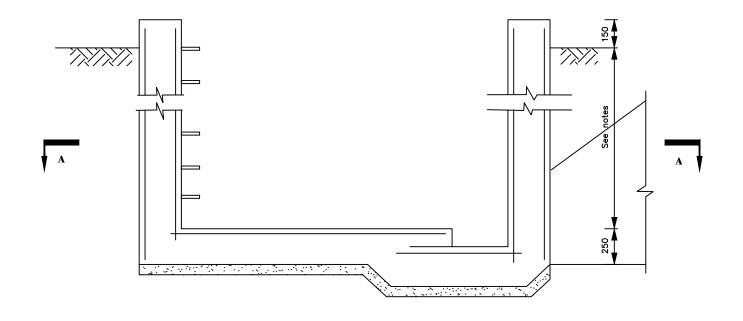

SECTION B-B

- 1. Floor of chamber to be 250 below pipe IL ? min depth 1700 below



GOVERNMENT OF UGANDA

MINISTRY OF WATER AND ENVIRONMENT



CONSULTANCY SERVICES FOR FEASIBILITY STUDY, DETAILED ENGINEERING DESIGN AND CONSTRUCTION SUPERVISION OF SOLAR POWERED PIPED WATER SUPPLY SYSTEMS AND SANITATION FACILITIES IN REFUGEE SETTLEMENTS AND HOST DISTRICTS IN WEST NILE AND NORTHERN UGANDA IN KIRYANDONGO DISTRICT

MUTUNDA WATER SUPPLY SYSTEM








DETAILED ENGINEERING DESIGN

DRAWING TITLE
WASHOUT/GATE VALVE CHAMBER WITH THRUST BLOCK - R.C. DETAILS

-				
	SCALE	As Shown	DRAWING No.	SD135B
	SURVEYED		DESIGNED	Otwane Dan.
	DRAWN	Joshua Nyarwanda	CHECKED	Rodney Barugahare
	DATE	OCT 2021	APPROVED	Rodney Barugahare.

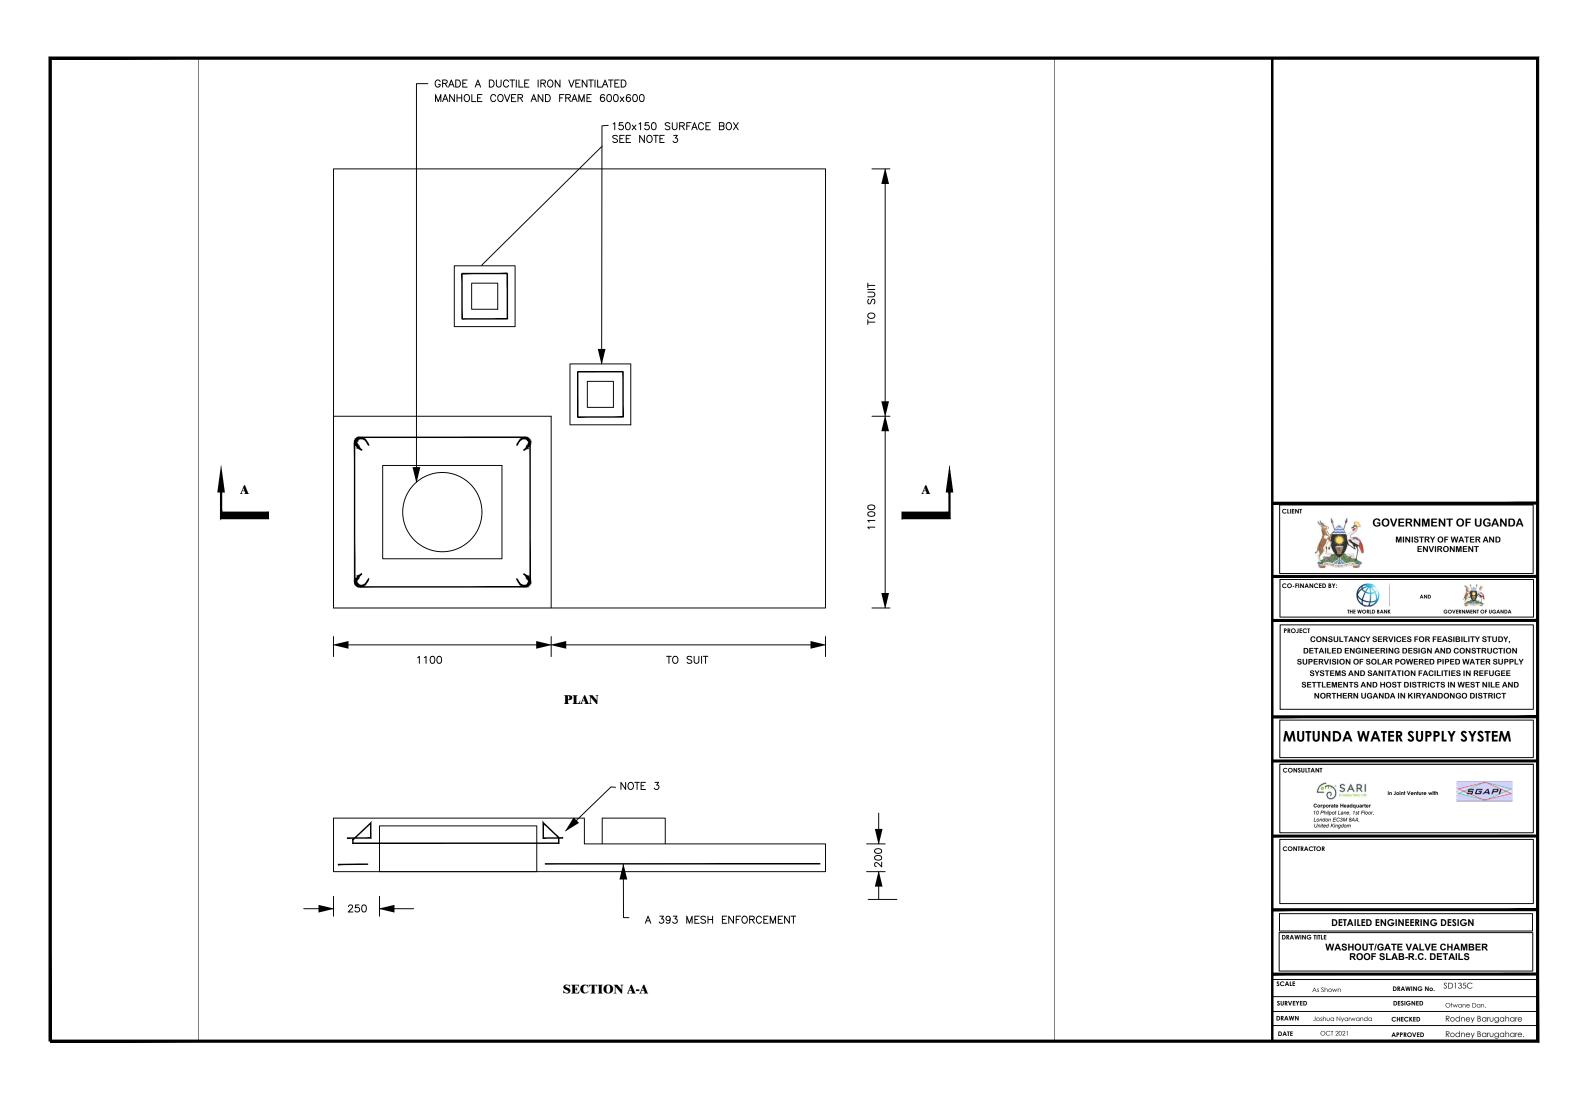

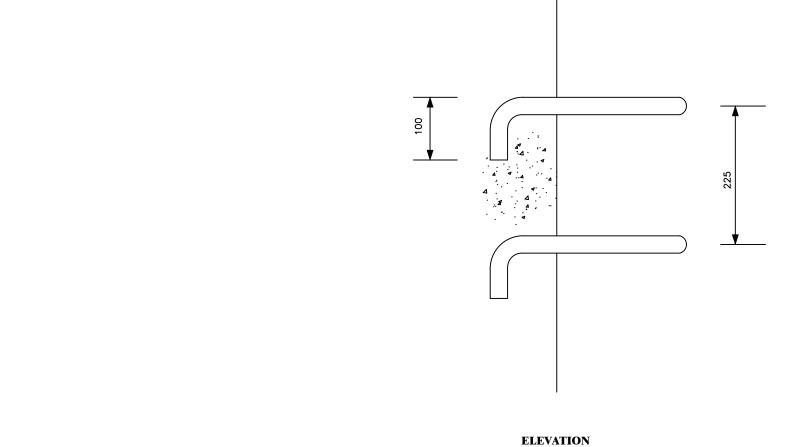

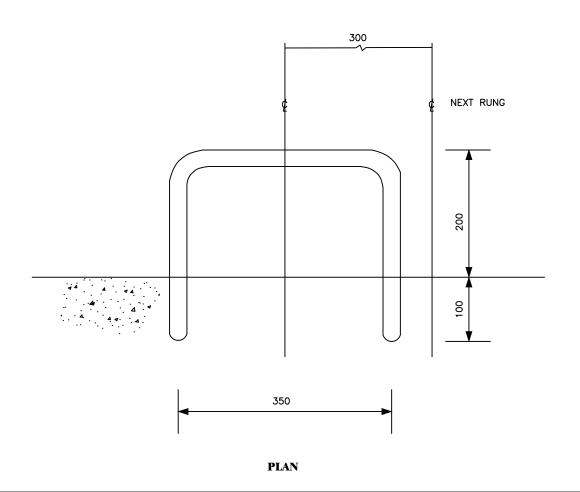

Step irons are to be to B1247, or made from 25 dia. reinforcing bars bent as sh

Bars should be placed at 225 centres vertically and at alternate centres 300 vertically



GOVERNMENT OF UGANDA

MINISTRY OF WATER AND ENVIRONMENT



CONSULTANCY SERVICES FOR FEASIBILITY STUDY, DETAILED ENGINEERING DESIGN AND CONSTRUCTION SUPERVISION OF SOLAR POWERED PIPED WATER SUPPLY SYSTEMS AND SANITATION FACILITIES IN REFUGEE SETTLEMENTS AND HOST DISTRICTS IN WEST NILE AND NORTHERN UGANDA IN KIRYANDONGO DISTRICT

MUTUNDA WATER SUPPLY SYSTEM







DETAILED ENGINEERING DESIGN

STEP IRON DETAIL


SCALE	As Shown	DRAWING No.	SD136
SURVEYED		DESIGNED	Otwane Dan.
DRAWN	Joshua Nyarwanda	CHECKED	Rodney Barugahare
DATE	OCT 2021	APPROVED	Rodney Barugahare.

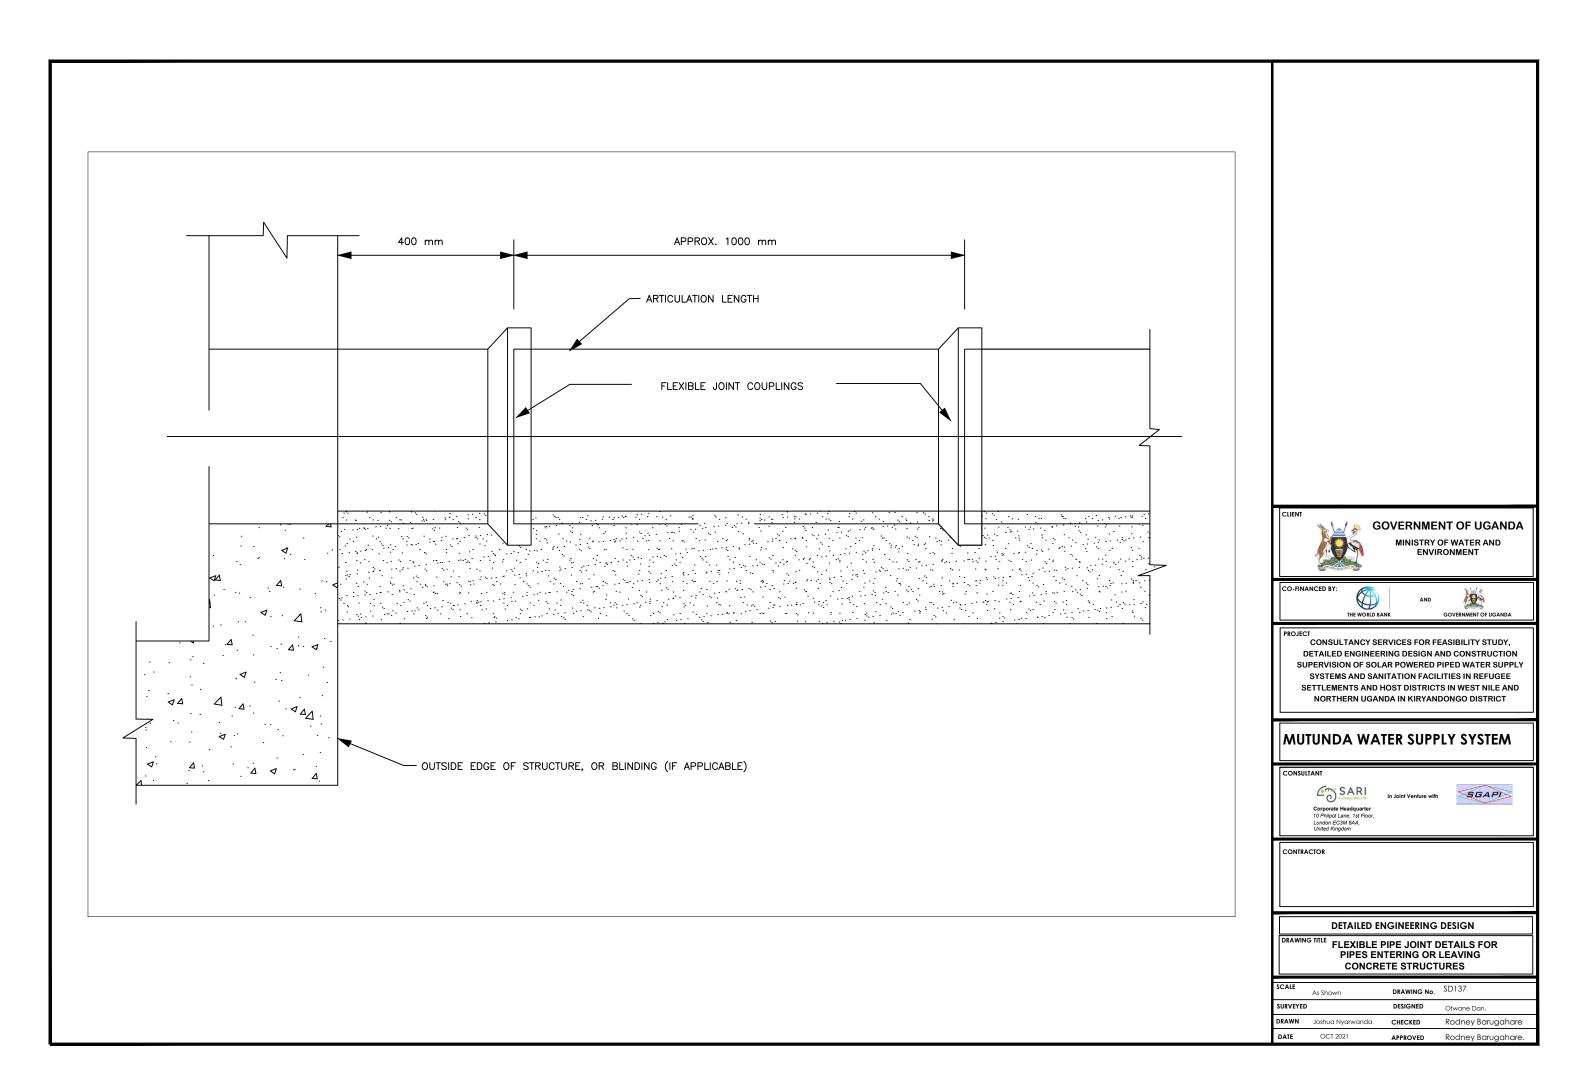

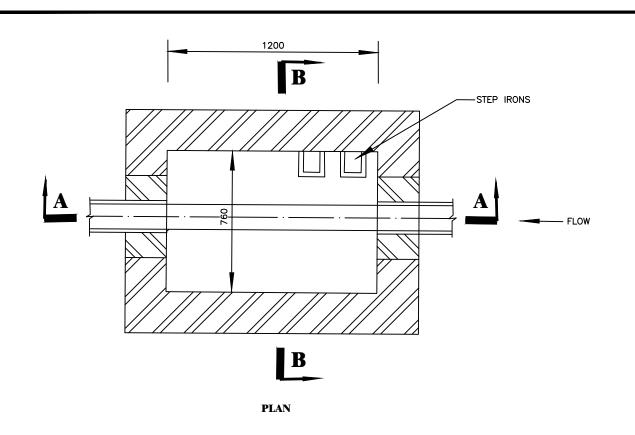


NOTES:

- 1. MANHOLES FOR SEWER SIZES UP TO AND INCLUDING900 DIA DEPTH TOSOFFIT EXCEEDING 1000 BUT NOT EXCEEDING 1350
- 2. MANHOLE FRAMES AND MULTIPLE COVERS WITH A MINIMUM CLEAR OPENING OF 1200x675 SHALL OTHERWISE COMPLY BWITH BS497 PART 1 GRADE A.
- 3. CHAMBERS WITH OUTGOING PIPES GREATER THAN 700 DIA. SHALL BE FITTED WITH REMOVABLE SAFETY CHAIN AT DOWD STREAM END.
- 4. PIPES ENTERING MANHOLES SHALL HAVE A FLEXIBLE JOINT WITHIN 600 OF THE INSIDE FACE OF THE MANHOLE FOR PIPES UP TO 450 AND WITHIN 1000 OF THE INSIDEFACE OF THE MANHOLE FOR PIPES UPTO 1000. THIS SHALL BE FOLLOWED BY A SHORT ROCKER PIPE.
- 5. INTERNAL DIMENSIONS OF CHAMBER NORMALLY 1200x675 (AS CLEAR OPENING IN FRAME) BUT CHAMBER WIDTH SHOULD BE INCREASED FOR PIPES LARGER THAN 225 DIA. TO GIVE 225 BENCHING EACH SIDE WITH THE BRICKWORK CRBELLED DOWN TO 675.
- 6. ALL DIMENSIONS ARE IN MILLIMETRES.

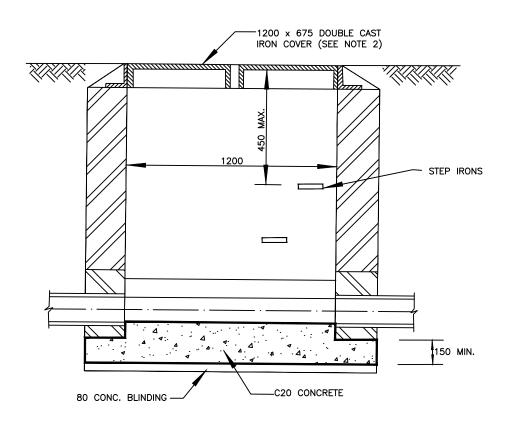

SECTION A-A

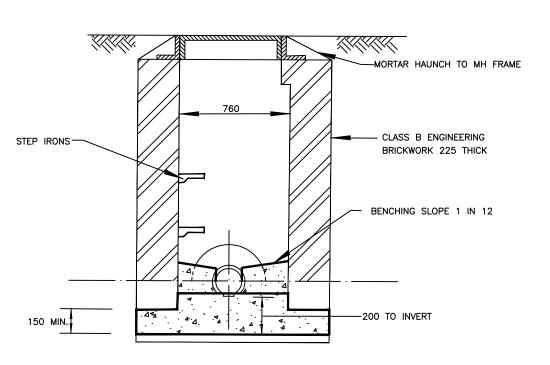

SECTION B-B

GOVERNMENT OF UGANDA

MINISTRY OF WATER AND ENVIRONMENT





CONSULTANCY SERVICES FOR FEASIBILITY STUDY, DETAILED ENGINEERING DESIGN AND CONSTRUCTION SUPERVISION OF SOLAR POWERED PIPED WATER SUPPLY SYSTEMS AND SANITATION FACILITIES IN REFUGEE SETTLEMENTS AND HOST DISTRICTS IN WEST NILE AND NORTHERN UGANDA IN KIRYANDONGO DISTRICT

MUTUNDA WATER SUPPLY SYSTEM






CONTRACTOR


DETAILED ENGINEERING DESIGN

MANHOLE - TYPE C


SCALE	As Shown	DRAWING No.	SD202
SURVEYED		DESIGNED	Otwane Dan.
DRAWN	Joshua Nyarwanda	CHECKED	Rodney Barugahare
DATE	OCT 2021	APPROVED	Rodney Barugahare.

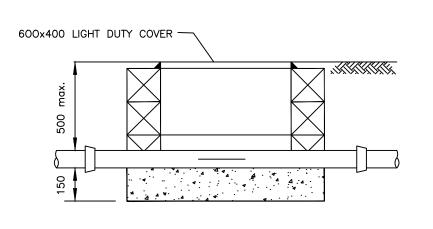


SECTION (TYPE 1)

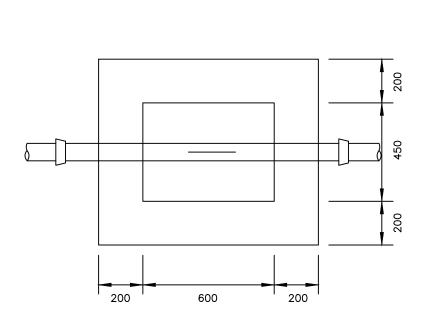

PLAN (TYPE 1)

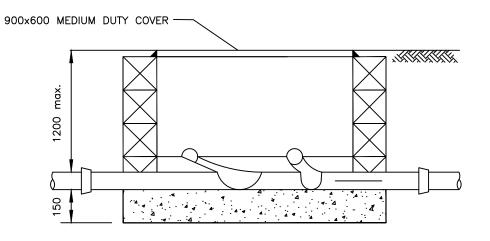

SECTION (TYPE 2)

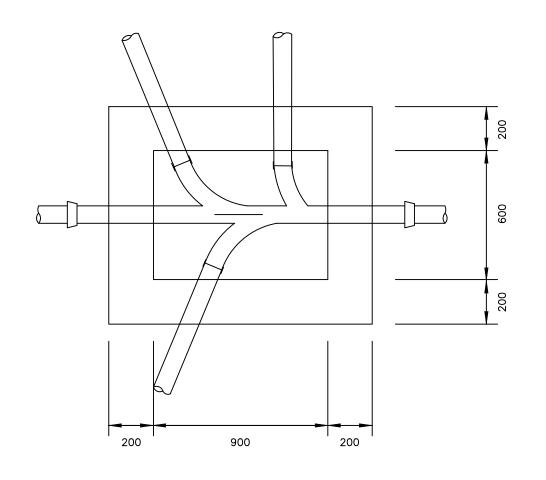

PLAN (TYPE 2)

NOTES

- 1. ALL DIMENSIONS ARE IN MILLIMETRES
- 2. CONSTRUCTION OF BASE SLAB TO BE CLASS 30/40S CONCRETE AND WALLS TO BE EITHER CLASS 30/40S CONCRETE OR CONCRETE BLOCKWORK WITH 20 THICK CEMENT MORTAR RENDER TO BOTH INTERNAL AND EXTERNAL FACES.
- 3. BENCHING TO BE CLASS 30/20S CONCRETE WITH 20 THICK CEMENT MORTAR TO SURFACE.



GOVERNMENT OF UGANDA

MINISTRY OF WATER AND ENVIRONMENT



CONSULTANCY SERVICES FOR FEASIBILITY STUDY, DETAILED ENGINEERING DESIGN AND CONSTRUCTION SUPERVISION OF SOLAR POWERED PIPED WATER SUPPLY SYSTEMS AND SANITATION FACILITIES IN REFUGEE SETTLEMENTS AND HOST DISTRICTS IN WEST NILE AND NORTHERN UGANDA IN KIRYANDONGO DISTRICT

MUTUNDA WATER SUPPLY SYSTEM







DETAILED ENGINEERING DESIGN

INSPECTION CHAMBERS- TYPES 1 AND 2

SCALE	As Shown	DRAWING No.	SD206
SURVEYED		DESIGNED	Otwane Dan.
DRAWN	Joshua Nyarwanda	CHECKED	Rodney Barugahare
DATE	OCT 2021	APPROVED	Rodney Barugahare.

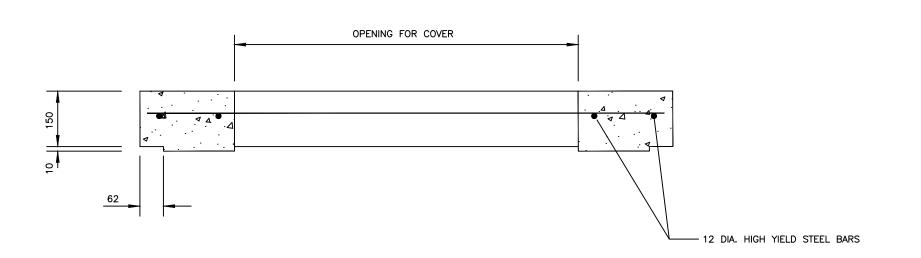

SECTION A-A

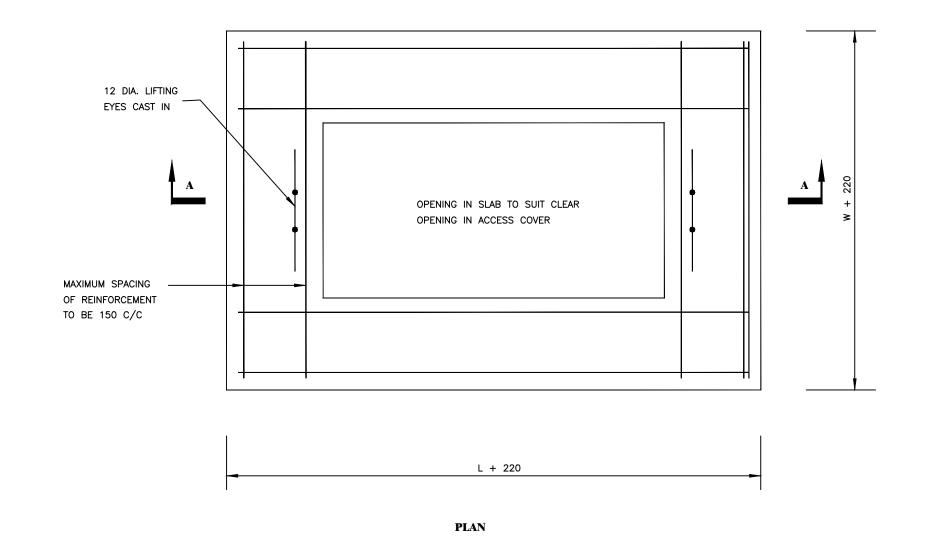

NOTES

- 1. ALL DIMENSIONS ARE IN MILLIMETRES
- 2. FOR GENERAL NOTES SEE STANDARD DETAIL No. V/G/NOTE/01.
- 3. FRAME TO BE SET IN CONCRETE UPSTAND MINIMUM DEPTH 150 DOWELLED TO SLAB WITH 6 No. T18 BARS 200 LONG.
- 4. L AND W ARE INTERNAL CHAMBER DIMENSIONS. SEE STANDARD DETAIL No. SD 214.

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GOVERNMENT OF UGANDA

MINISTRY OF WATER AND ENVIRONMENT

CO-FINANCED BY:



100

ROJECT

CONSULTANCY SERVICES FOR FEASIBILITY STUDY,
DETAILED ENGINEERING DESIGN AND CONSTRUCTION
SUPERVISION OF SOLAR POWERED PIPED WATER SUPPLY
SYSTEMS AND SANITATION FACILITIES IN REFUGEE
SETTLEMENTS AND HOST DISTRICTS IN WEST NILE AND
NORTHERN UGANDA IN KIRYANDONGO DISTRICT

MUTUNDA WATER SUPPLY SYSTEM

CONSULTANT



In Joint Venture with




CONTRACTOR

DETAILED ENGINEERING DESIGN

DRAWING TIT

PRECAST CONCRETE COVER SLAB OPEN AREAS

SCALE	As Shown	DRAWING No.	SD211
SURVEYED		DESIGNED	Otwane Dan.
DRAWN	Joshua Nyarwanda	CHECKED	Rodney Barugahare
DATE	OCT 2021	APPROVED	Rodney Barugahare.

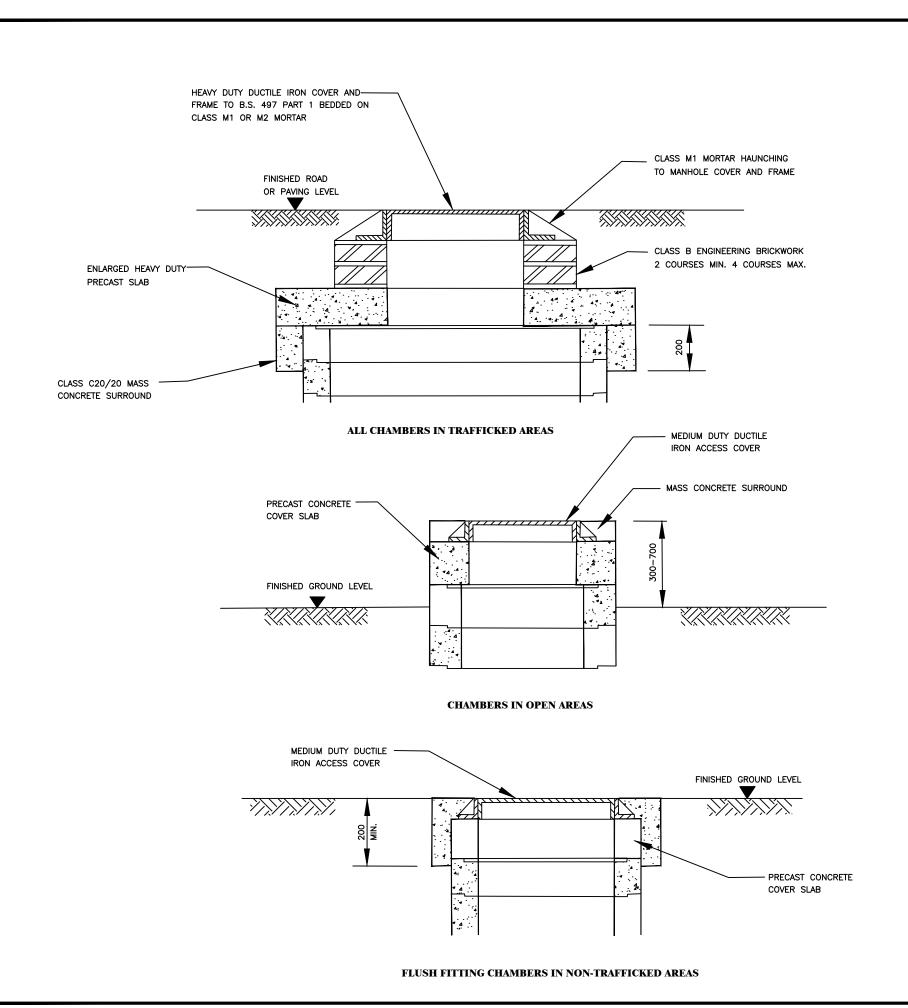

NOTES:

1. ALL DIMENSIONS ARE IN MILLIMETRES.



GOVERNMENT OF UGANDA

MINISTRY OF WATER AND ENVIRONMENT



CONSULTANCY SERVICES FOR FEASIBILITY STUDY, DETAILED ENGINEERING DESIGN AND CONSTRUCTION SUPERVISION OF SOLAR POWERED PIPED WATER SUPPLY SYSTEMS AND SANITATION FACILITIES IN REFUGEE SETTLEMENTS AND HOST DISTRICTS IN WEST NILE AND NORTHERN UGANDA IN KIRYANDONGO DISTRICT

MUTUNDA WATER SUPPLY SYSTEM






CONTRACTOR


DETAILED ENGINEERING DESIGN

PRECAST CHAMBER COVER SLAB INSTALLATION

SCALE	As Shown	DRAWING No.	SD213
SURVEYED)	DESIGNED	Otwane Dan.
DRAWN	Joshua Nyarwanda	CHECKED	Rodney Barugahare
DATE	OCT 2021	APPROVED	Rodney Barugahare.

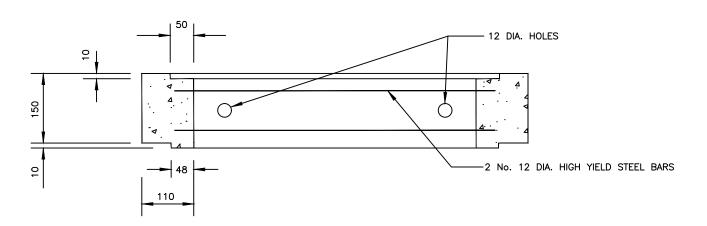

SECTION A-A

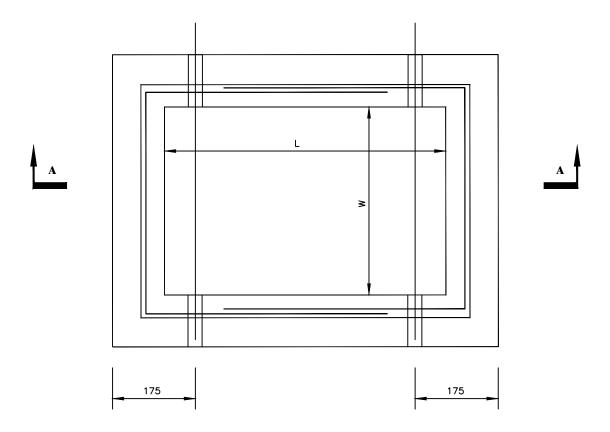

PLAN

TYPE	L	W
A B C D E F	430 600 750 900 1200	280 450 600 600 600 900

NOTES

- 1. ALL DIMENSIONS ARE IN MILLIMETRES
- 2. CONCRETE TO BE CLASS 30/20.
- 3. COVER TO REINFORCEMENT TO BE 40mm.
- 4. DIMENSIONS L AND W FROM TABLE SHOWN.
- 5. FOR GENERAL NOTES SEE STANDARD DRAWING No. SD100.





GOVERNMENT OF UGANDA

MINISTRY OF WATER AND ENVIRONMENT



CONSULTANCY SERVICES FOR FEASIBILITY STUDY, DETAILED ENGINEERING DESIGN AND CONSTRUCTION SUPERVISION OF SOLAR POWERED PIPED WATER SUPPLY SYSTEMS AND SANITATION FACILITIES IN REFUGEE SETTLEMENTS AND HOST DISTRICTS IN WEST NILE AND NORTHERN UGANDA IN KIRYANDONGO DISTRICT

MUTUNDA WATER SUPPLY SYSTEM






DETAILED ENGINEERING DESIGN

PRECAST CONCRETE CHAMBER SECTIONS

SCALE	As Shown DRAWING No.		SD214
SURVEYED)	DESIGNED	Otwane Dan.
DRAWN	Joshua Nyarwanda	CHECKED	Rodney Barugahare
DATE	OCT 2021	APPROVED	Rodney Barugahare.

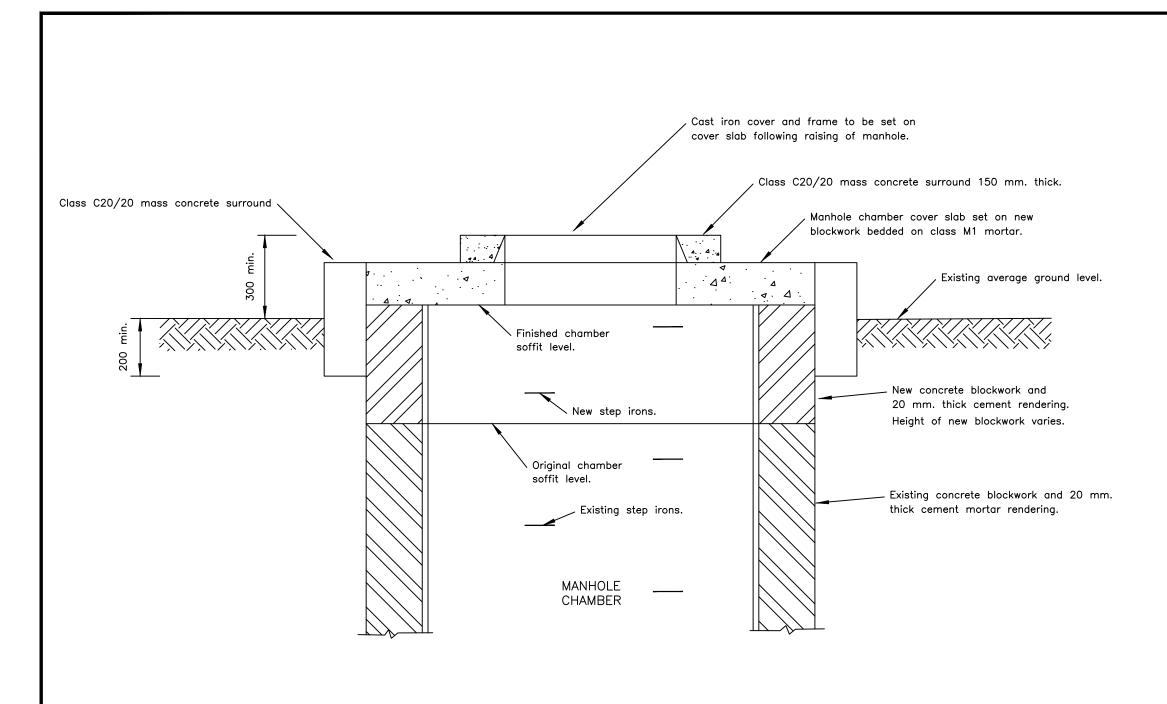

NOTES

- 1. The existing manhole chamber cover slab shall be re—used where possible. If existing slab is damaged it shall be replaced by a new slab as per standard detail SD 211.
- 2. Manhole chambers are generally square in plan with 1200×1200 internal dimensions. Dimensions to be confirmed by the contractor prior to casting new manhole chamber cover slab
- 3. The existing cast iron cover and frame shall be re—used where possible. If the cover or frame is damaged, it shall be replaced by a medium duty cover and frame supplied by the Employer.
- 4. Width of the new concrete blocks shall be the same as existing chamber walls.
- 5. The final cove level shall be agreed with the Engineer prior to placing mass concrete sorrounds.
- 6. New step irons as per SD 206.



GOVERNMENT OF UGANDA

MINISTRY OF WATER AND ENVIRONMENT

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CONSULTANCY SERVICES FOR FEASIBILITY STUDY,
DETAILED ENGINEERING DESIGN AND CONSTRUCTION
SUPERVISION OF SOLAR POWERED PIPED WATER SUPPLY
SYSTEMS AND SANITATION FACILITIES IN REFUGEE
SETTLEMENTS AND HOST DISTRICTS IN WEST NILE AND

MUTUNDA WATER SUPPLY SYSTEM

NORTHERN UGANDA IN KIRYANDONGO DISTRICT

CONSULTANT



In Joint Venture with




CONTRACTOR


DETAILED ENGINEERING DESIGN


WING TITLE


ALTERATIONS TO CHAMBERS IN OPEN AREAS

-				
	SCALE As Shown		DRAWING No.	SD215
	SURVEYED		DESIGNED	Otwane Dan.
	DRAWN	Joshua Nyarwanda	CHECKED	Rodney Barugahare
	DATE	OCT 2021	APPROVED	Rodney Barugahare.

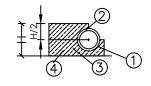

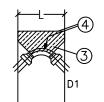


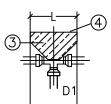


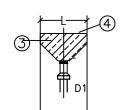

T 1 D	
1 4 🖂	-

	С	В	A1	A2	A3	A4	A5	A6
D1	(—————————————————————————————————————	F -) (-		D1	D1			, ,
	→ 101 101		190*	160*	45*	30°	22*	11°
mm	mm ²	mm ²	mm ²	mm ²	mm ²	mm ²	mm ²	mm ²
65	0.05	0.05	0.07	0.05	0.04	0.03	0.02	0.01
80	0.08	0.08	0.11	0.08	0.06	0.04	0.03	0.02
1.00	0.11	0.11	0.16	0.11	0.08	0.06	0.04	0.02
1.50	0.25	0.25	0.35	0.25	0.19	0.13	0.10	0.05
2.00	0.40	0.40	0.56	0.40	0.31	0.21	0.16	0.08
2.50	0.66	0.66	0.93	0.66	0.51	0.34	0.25	0.13
3.00	0.94	0.94	1.33	0.94	0.72	0.49	0.37	0.19
4.00	1.66	1.66	2.34	1.66	1.29	0.36	0.65	0.33
5.00	2.50	2.50	3.53	2.5	1.93	1.30	0.98	0.50
6.00	3.61	3.61	5.09	3.51	2.78	1.88	1.41	0.72
7.00	4.90	4.90	5.91	4.9	3.77	2.55	1.91	0.98
8.00	6.39	6.39	9.01	6.39	4.92	3.32	2.49	1.29
9.00	8.10	8.10	11.42	8.10	6.24	4.21	3.16	1.62

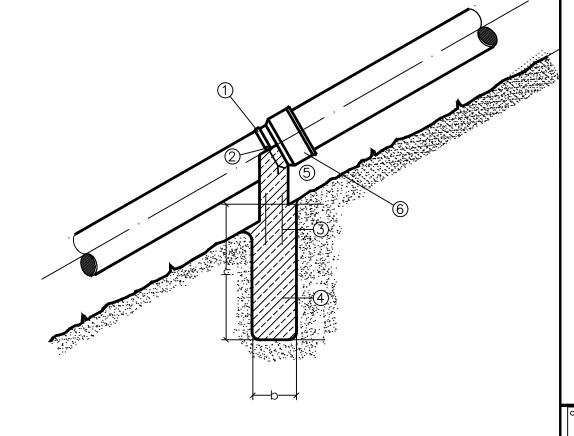

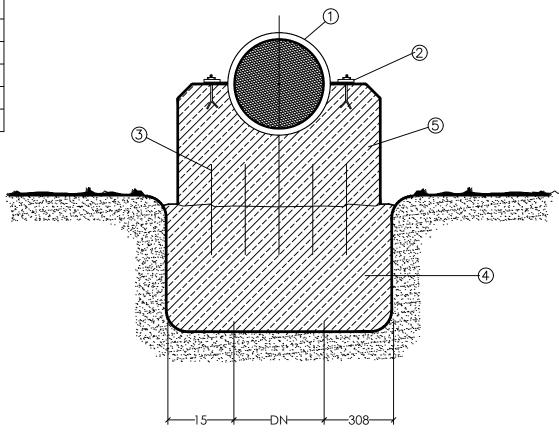



MINISTRY OF WATER AND ENVIRONMENT

CO-FINANCED BY:



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PROJECT

CONSULTANCY SERVICES FOR FEASIBILITY STUDY,
DETAILED ENGINEERING DESIGN AND CONSTRUCTION
SUPERVISION OF SOLAR POWERED PIPED WATER SUPPLY
SYSTEMS AND SANITATION FACILITIES IN REFUGEE
SETTLEMENTS AND HOST DISTRICTS IN WEST NILE AND
NORTHERN UGANDA IN KIRYANDONGO DISTRICT

MUTUNDA WATER SUPPLY SYSTEM

CONSULTA



In Joint Venture with



CONTRACTOR


DETAILED ENGINEERING DESIGN

DRAWING TITL

THRUST BLOCK

SCALE	As Shown	DRAWING No.	SD216	
SURVEYED		DESIGNED	Otwane Dan.	
DRAWN	Joshua Nyarwanda	CHECKED	Rodney Barugahare	
DATE	OCT 2021	APPROVED	Rodney Barugahare.	

TABLE II						
P1(bar)	10	15	20	25	30	
2.0	0.5	0.75	10	1.25	1.5	
1.5	0.67	1.0	1.33	1.57	2.0	
1.0	1.0	1.5	2.0	2.5	3.0	
0.5	2.0	3.0	4.0	5.0	6.0	

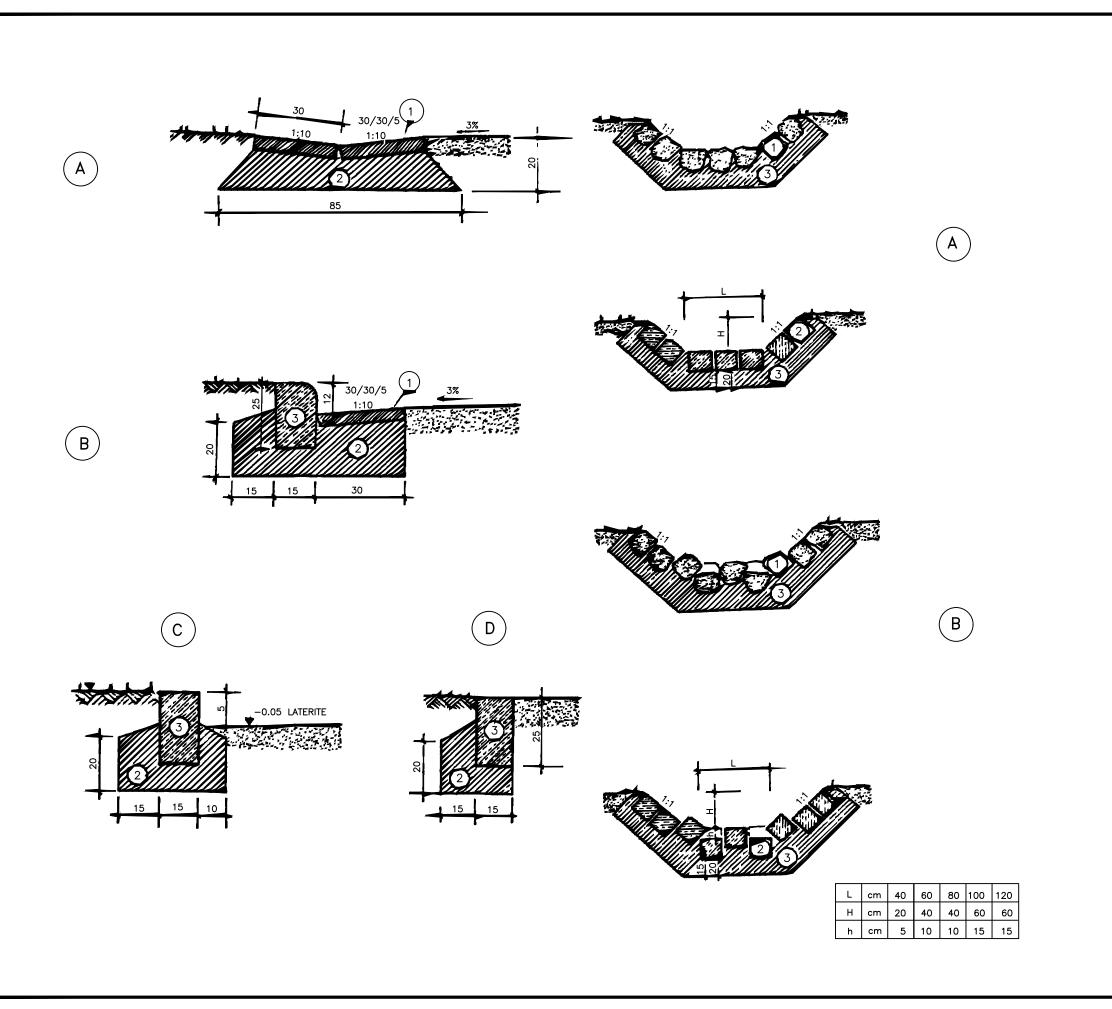

KERB & DRAIN

- A. Open drain
- B. Concrete slab half drain
- C. Kerb
- D. Embedded Kerb
- 1. Prefabricated concrete slabs of class as specified
- 2. Concrete foundation class as specified
- 3. Prefabricated concrete kerbs class as specified The excavation and other works are specified Kerbs at road junctions and bends with R < 10 m have to be rounded off. In that case the length of the kerbstone depth must be doubled.

OPEN DRAINAGE CHANNEL

- Open drain channel
- B. Open drain channel with obstacles
- 1. Stones
- Cement blocks
- Concrete class as specified
- The lining & works include
 - -excavation class as specified
 - -concrete class as specified
 - Rock or cement blocks
 Planting of a 50 cm ~ grass a strip on either side of the channel





GOVERNMENT OF UGANDA

MINISTRY OF WATER AND ENVIRONMENT





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MUTUNDA WATER SUPPLY SYSTEM







CONTRACTOR

DETAILED ENGINEERING DESIGN

OPEN DRAINAGE CHANNEL AND KERB

SCALE	As Shown	DRAWING No.	SD218
SURVEYED		DESIGNED	Otwane Dan.
DRAWN	Joshua Nyarwanda	CHECKED	Rodney Barugahare
DATE	OCT 2021	APPROVED	Rodney Barugahare.

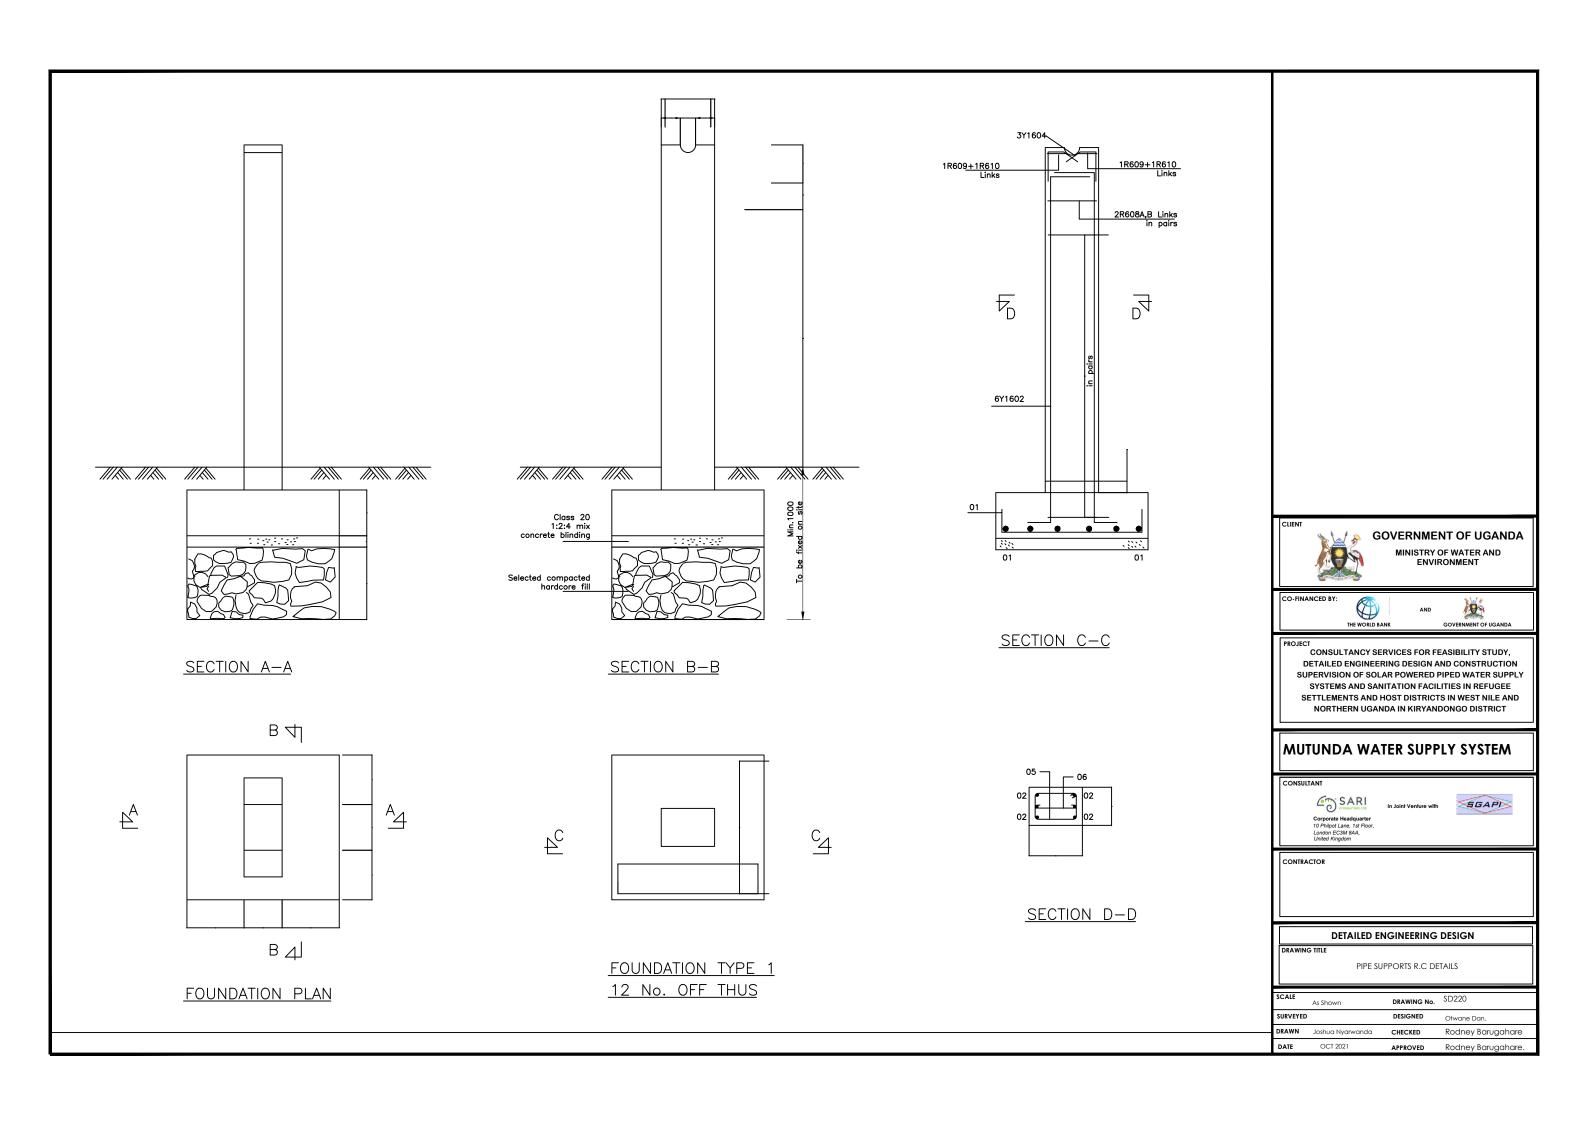


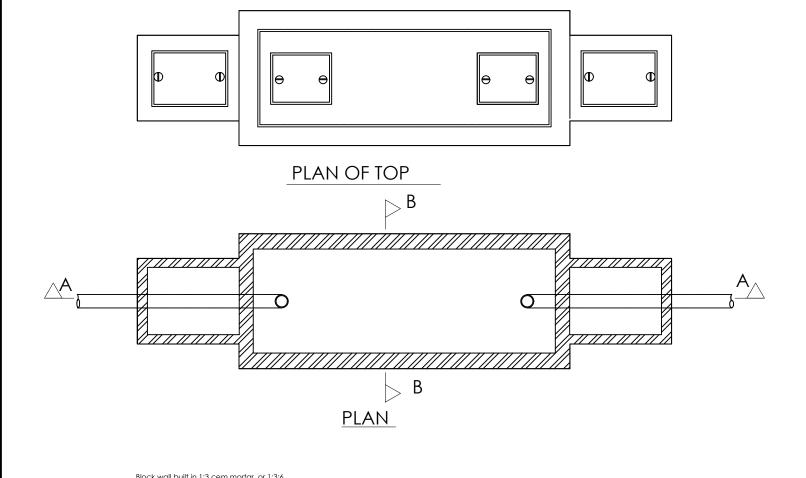

	SIZES OF INSPECTION CHAMBER							
DEPTH TO INVERTS		INTERNAL DIMENSIONS	WALL THICKNESS	FOUNDATION THICKNESS				
UP TO 450		450x450	100	150				
475	900	450x600	100	150				
925	1500	750x1050	225	225				
OVER	1500	750x1050	225	225				

BRICKWORK TO BE BUILT IN CEMENT MORTAR 1:6 AND RENDERED INTERNALLY IN 1:3 CEMENT PLASTER 13mm THICK FOUNDATION TO BE 1:3:6 CONCRETE MIX OF CEMENT

DIMENSIONS OF SEPTIC TANK							
No. of Users	L	В	D	Capacity Liters			
6	1800	625	900	1137			
10	2250	625	900	1435			
15	2475	625	900	1707			
20	2860	625	900	1820			
25	3300	625	900	2117			
30	2400	900	1050	2388			
35	2550	900	1050	2530			
40	3000	900	1050	2980			
45	3300	900	1050	3276			
50	3750	900	1050	3727			
60	3150	925	1200	4460			
70	3750	925	1200	5312			
80	4200	925	1200	5890			
90	4850	925	1200	6597			
100	4950	1125	1200	7462			
150	5250	1350	1500	10533			
200	6450	1350	1500	12697			
250	7050	1350	1650	16513			
300	7500	1350	1800	18155			

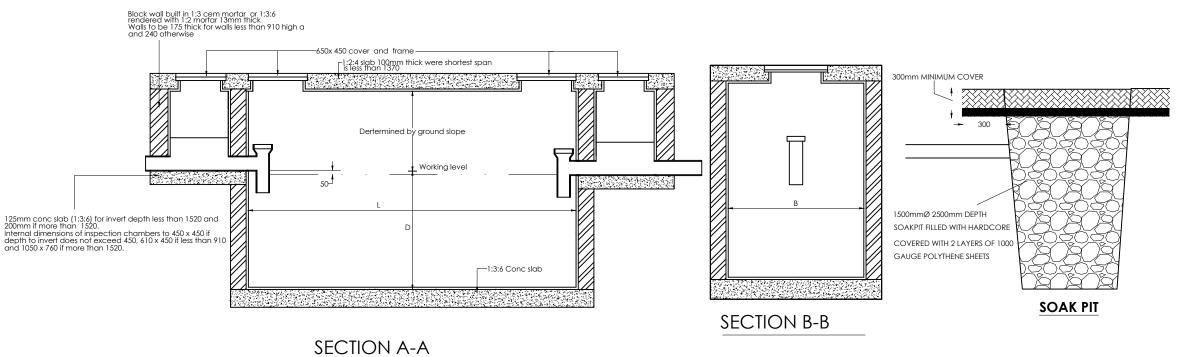



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MUTUNDA WATER SUPPLY SYSTEM





DETAILED ENGINEERING DESIGN

SEPTIC TANK DETAIL

SCALE As Shown		DRAWING No.	SD221	
SURVEYED		DESIGNED	Otwane Dan.	
DRAWN Joshua Nyarwanda		CHECKED	Rodney Barugahare	
DATE	OCT 2021	APPROVED	Rodney Barugahare.	