

THE REPUBLIC OF UGANDA

MINISTRY OF WATER AND ENVIRONMENT

INTEGRATED WATER MANAGEMENT AND DEVELOPMENT PROJECT (PROJECT ID NO: P163782)

FINANCED BY THE WORLD BANK & GOVERNMENT OF UGANDA

CO-FINANCED BY



AND



CONSTRUCTION OF NYAKABAALE RGC SOLAR POWERED PIPED WATER SUPPLY AND SANITATION SYSTEM

REFERENCE NO.: MWE/WRKS/22-23/00005

BIDDING DOCUMENT

VOLUME IV


DRAWINGS


OCTOBER 2022


TABLE OF CONTENT


		DRAWING No	DRAWING TITLE
DRAWING No	DRAWING TITLE	NYA/WS/2.2.5	TRANSMISSION LINE 02 (2+400.00 – 3+000.00)
NYA/WS/0.0.0	GENERAL LAYOUT (TRANSMISSION AND DISTIRBUTION)	NYA/WS/2.2.6	TRANSMISSION LINE 02 (3+000.00 – 3+600.00)
NYA/WS/0.0.1	GENERAL LAYOUT (SHEET 01 OF 02)	NYA/WS/2.2.7	TRANSMISSION LINE 02 (3+600.00 – 4+200.00)
NYA/WS/0.0.2	GENERAL LAYOUT (SHEET 02 0F 02)	NYA/W\$/2.2.8	TRANSMISSION LINE 02 (4+200.00 – 4+800.00)
		NYA/WS/2.2.9	TRANSMISSION LINE 02 (4+800.00 - 5+400.00)
NYA/WS/1.1.0	BOREHOLE DWD-77382 PUMP HOUSE AND SOLAR ARRAY (SITE PLAN LAYOUT)	NYA/WS/2.2.10	TRANSMISSION LINE 02 (5+400.00 - 6+000.00)
NYA/WS/1.1.1	TYPICAL BOREHOLE PUMP HOUSE (PLAN AND SECTION)	NYA/WS/2.2.11	TRANSMISSION LINE 02 (6+000.00 - 6+600.00)
NYA/WS/1.1.2	DWD-77382 BOREHOLE PUMP HOUSE (DETAILS)	NYA/WS/2.2.12	TRANSMISSION LINE 02 (6+600.00 - 7+200.00)
NYA/WS/1.1.3	DWD-77382 SOLAR ARRAY (ELECTRICAL LAYOUT)	NYA/WS/2.2.13	TRANSMISSION LINE 02 (7+200.00 - 7+643.70)
NYA/WS/1.1.4	DWD-77382 SOLAR ARRAY (SOLAR PANEL LAYOUT, ELEVATION & DETAILS)		
NYA/WS/1.1.5	DWD-77383 BOREHOLE PUMP HOUSE (DETAILS)	NYA/WS/3.1.1	300M3 NYAKABAALE RESERVOIR – PLAN LAYOUT
NYA/WS/1.1.6	TYPICAL BOREHOLE PUMP HOUSE (ELECTRICAL INSTALLATION)	NYA/WS/3.1.2	300M3 NYAKABAALE RESERVOIR – SECTION A-A & SECTION B-B
NYA/WS/1.1.7	BOREHOLE DWD-77383 PUMP HOUSE AND SOLAR ARRAY (SITE PLAN LAYOUT)	NYA/WS/3.1.3	300M3 NYAKABAALE RESERVOIR – FOUNDATION LAYOUT AND DETAILS
NYA/WS/1.1.8	DWD-77383 SOLAR ARRAY (ELECTRICAL LAYOUT)	NYA/WS/3.1.4	300M3 NYAKABAALE RESERVOIR – STRUCTURAL DETAILS
NYA/WS/1.1.9	DWD-77383 SOLAR ARRAY (SOLAR PANEL LAYOUT, ELEVATION & DETAILS)		
		NYA/WS/4.1.1	CHLORINE HOUSE – PLAN AND ELEVATIONS
		NYA/WS/4.1.2	CHLORINE HOUSE – SECTIONS
NVA (NVC (1 O 1		NVA /\A/\$ /F O O	CENEDAL LAVOLIT (DISTIDULITION) NETWORK)
NYA/WS/1.2.1	BOREHOLE PUMP ATTENDANT, GUARD HOUSE & ECOSAN (PLAN & SECTION)	NYA/W\$/5.0.0	GENERAL LAYOUT (DISTIRBUTION NETWORK)
NYA/WS/1.2.2	BOREHOLE PUMP ATTENDANT, GUARD HOUSE & ECOSAN (ELEVATION)	NYA/WS/5.1.1	DISTRIBUTION LINE 01 (0+000.00 – 0+600.00)
N.V.A. /\A\C /O.O.O.	CENTED AT LANCOUT TO ANICA (ICCION) NIETIMODIC	NYA/WS/5.1.2	DISTRIBUTION LINE 01 (0+600.00 – 0+800.00)
NYA/WS/2.0.0	GENERAL LAYOUT TRANSMISSION NETWORK	NYA/WS/5.1.3	DISTRIBUTION LINE 01 (0+800.00 – 1+800.00)
NIV A /\A/C /O 1 1	TRANSMISSION LINE 01 (0+000.00 – 0+600.00)	NYA/WS/5.1.4	DISTRIBUTION LINE 01 (1+800.00 – 2+400.00)
NYA/WS/2.1.1	· · · · · · · · · · · · · · · · · · ·	NYA/WS/5.1.5	DISTRIBUTION LINE 01 (2+400.00 – 3+000.00)
NYA/WS/2.1.2 NYA/WS/2.1.3	TRANSMISSION LINE 01 (0+600.00 – 1+200.00) TRANSMISSION LINE 01 (1+200.00 – 1+800.00)	NYA/WS/5.1.6	DISTRIBUTION LINE 01 (3+000.00 – 3+600.00)
NYA/WS/2.1.3 NYA/WS/2.1.4	TRANSMISSION LINE 01 (1+200.00 – 1+800.00) TRANSMISSION LINE 01 (1+800.00 – 2+400.00)	NYA/WS/5.1.7	DISTRIBUTION LINE 01 (3+600.00 – 4+183.50)
NYA/WS/2.1.5	TRANSMISSION LINE 01 (2+400.00 – 2+400.00) TRANSMISSION LINE 01 (2+400.00 – 3+000.00)	1417 (14075.1.7	DISTRIBUTION EINE 01 (0:000.00 4:100.00)
NYA/WS/2.1.6	TRANSMISSION LINE 01 (3+000.00 – 3+600.00)	NYA/WS/5.2.1	DISTRIBUTION LINE 02 (0+000.00 – 0+754.10)
NYA/WS/2.1.7	TRANSMISSION LINE 01 (3+600.00 – 4+200.00)	1417 (1107 0.2.1	DIGINIDO NOTA EN LO 2 (0.000.00 0.70 mo)
NYA/WS/2.1.8	TRANSMISSION LINE 01 (4+200.00 – 4+800.00)	NYA/WS/5.3.1	DISTRIBUTION LINE 03 (0+000.00 – 0+504.60)
NYA/WS/2.1.9	TRANSMISSION LINE 01 (4+800.00 – 5+448.90)	1417 (11070.0.1	DIGINIDO NOTA EN LE GO (O COGOLOG)
1117 y 110/ 2.1./	1.1.1.100.01.1.1.1.1.1.1.1.1.1.1.1.	NYA/WS/5.4.1	DISTRIBUTION LINE 04 (0+000.00 – 0+713.00)
NYA/WS/2.2.1	TRANSMISSION LINE 02 (0+000.00 – 0+600.00)	, ,	•
NYA/WS/2.2.2	TRANSMISSION LINE 02 (0+600.00 – 1+200.00)	NYA/WS/5.5.1	DISTRIBUTION LINE 05 (0+000.00 – 0+314.30)
NYA/WS/2.2.3	TRANSMISSION LINE 02 (1+200.00 – 1+800.00)	•	
NYA/WS/2.2.4	TRANSMISSION LINE 02 (1+800.00 – 2+400.00)		
, ,			:1


DRAWING No	DRAWING TITLE	DRAWING No	DRAWING TITLE
NYA/WS/7.1.1	WATER OFFICE – PLAN AND SECTION	SD113A	FIRE HYDRANT PIPE WORK
NYA/WS/7.1.2	WATER OFFICE – ELEVATIONS	SD113B	FIRE HYDRANT CHAMBER
		SD114A	WASHOUT – PIPE DETAILS
NYA/WS/8.1.1	PUBLIC STAND POST- CONNECTION AND SOAK PIT DETAILS	SD114B	WASHOUT – PIPEWORK WITH CHAMBER
NYA/WS/8.1.2	TYPICAL YARD CONNECTION- CONNECTION AND SOAK PIT DETAILS	SD116	OUTFALL
		SD117	MARKER POST
NYA/S/1.1.1	INSTITUTIONAL TOILET - INCENERATOR	SD118A	ANCHOR BLOCKS FOR TAPERS
		SD118B	ANCHOR BLOCKS FOR BENDS-1
NYA/S/1.1.2	INSTITUTIONAL TOILET - BOYS	SD118C	ANCHOR BLOCKS FOR BENDS-2
NYA/S/1.1.3	INSTITUTIONAL TOILET - GIRLS	SD118D	ANCHOR BLOCKS FOR BENDS-3
		SD118E	ANCHOR BLOCKS FOR BENDS -4
NYA/S/1.2.1	WATER BORNE TOILET – FLOOR PLAN	SD118F	ANCHOR BLOCKS FOR BENDS -5
NYA/S/1.2.2	WATER BORNE TOILET – SECTIONS	SD118G	ANCHOR BLOCKS FOR BENDS -6
NYA/S/1.2.3	WATER BORNE TOILET – ELEVATIONS, DOOR & WINDOW SCHEDULE	SD118H	ANCHOR BLOCKS FOR BENDS -7
NYA/S/1.2.4	WATER BORNE TOILET – ELEVATIONS	SD118I	ANCHOR BLOCKS FOR BENDS -8
		SD118J	ANCHOR BLOCKS FOR TEES AND DEAD ENDS — 1
STANDARD DR	<u>AWINGS</u>	SD118K	ANCHOR BLOCKS FOR TEES AND DEAD ENDS - 2
		SD118L	ANCHOR BLOCKS FOR TEES AND DEAD ENDS - 3
SD 100 `	GENERAL NOTES FOR STANDARD DRAWINGS	SD121	PIPE BEDDING
SD 101	SIGN BOARD	SD122	SURFACE BOX AND FIELD DRAIN
SD104	CHAIN LINK FENCE DETAILS	SD124	FIELD DRAIN
SD106A	FORGED STEEL STANCHIONS FOR STAIRWAYS	SD126	DUCT COVERS
SD106B	FORCED STEEL STANCHIONS FOR PLATFORMS AND WALKWAYS-1	SD130	DRAW PITS
SD106C	FORCED STEEL STANCHIONS FOR PLATFORMS AND WALKWAYS-2	SD132	TRENCH CUTOFF
SD106D	ARRANGEMENT OF HANDRAILING ON WALKWAYS AND TOP OF LADDERS	SD135A	WASHOUT/GATE VALVE CHAMBER – R.C DETAILS
SD107A	ARRANGEMENT OF HANDRAILING ON WALKWAYS AND TOP OF LADDERS	SD135C	WASHOUT/GATE VALVE CHAMBER ROOF SLAB – R.C DETAILS
SD107B	MILD STEEL SHIP TYPE LADDER - DETAIL	SD137	FLEXIBLE PIPE JOINT DETAILES FOR PIPES IN CONCRETE STRUCTURES
SD107C	MILD STEEL STAIRWAY SIDE ELEVATION	SD202	BEDDING DETAILS FOR GRAVITY LINE AND LATERALS
SD107D	mild steel stairway front elevation	SD206	INSPECTION CHAMBERS- TYPES 1 AND 2
SD107E`	MILD STEEL ACCESS LADDER – TYPE A (NOT EXCEEDING 2.3m RISE)	SD211	PRECAST CONCRETE COVER SLAB OPEN AREAS
SD107G	MILD STEEL ACCESS LADDERS - TYPE C	SD212	PRECAST CONCRETE COVER SLAB UNDER ROADS AND PAVINGS
SD107H	MILD STEEL ACCESS LADDER DETAILS	SD213	PRECAST CHAMBER COVER SLAB INSTALLATIONS
SD109	PRESSURE REDUCING VALVE - PIPEWORK	SD214	PRECAST CONCRETE CHAMBER SECTIONS
SD110	FLOW METER - PIPEWORK	SD215	ALTERATIONS TO CHAMBERS IN OPEN AREAS
SD111A	GATE VALVE – TYPE 1	SD216	THRUST BLOCK
SD111B	GATE VALVE - TYPE 2	SD218	OPEN DRAINAGE CHANNEL AND KERB
SD112A	AIR VALVE PIPE WORK	SD220	PIPE SUPPORTS – R.C DETAILS
SD112B	AIR VALVE CHAMBER	SD221	SEPTIC TANK DETAILS

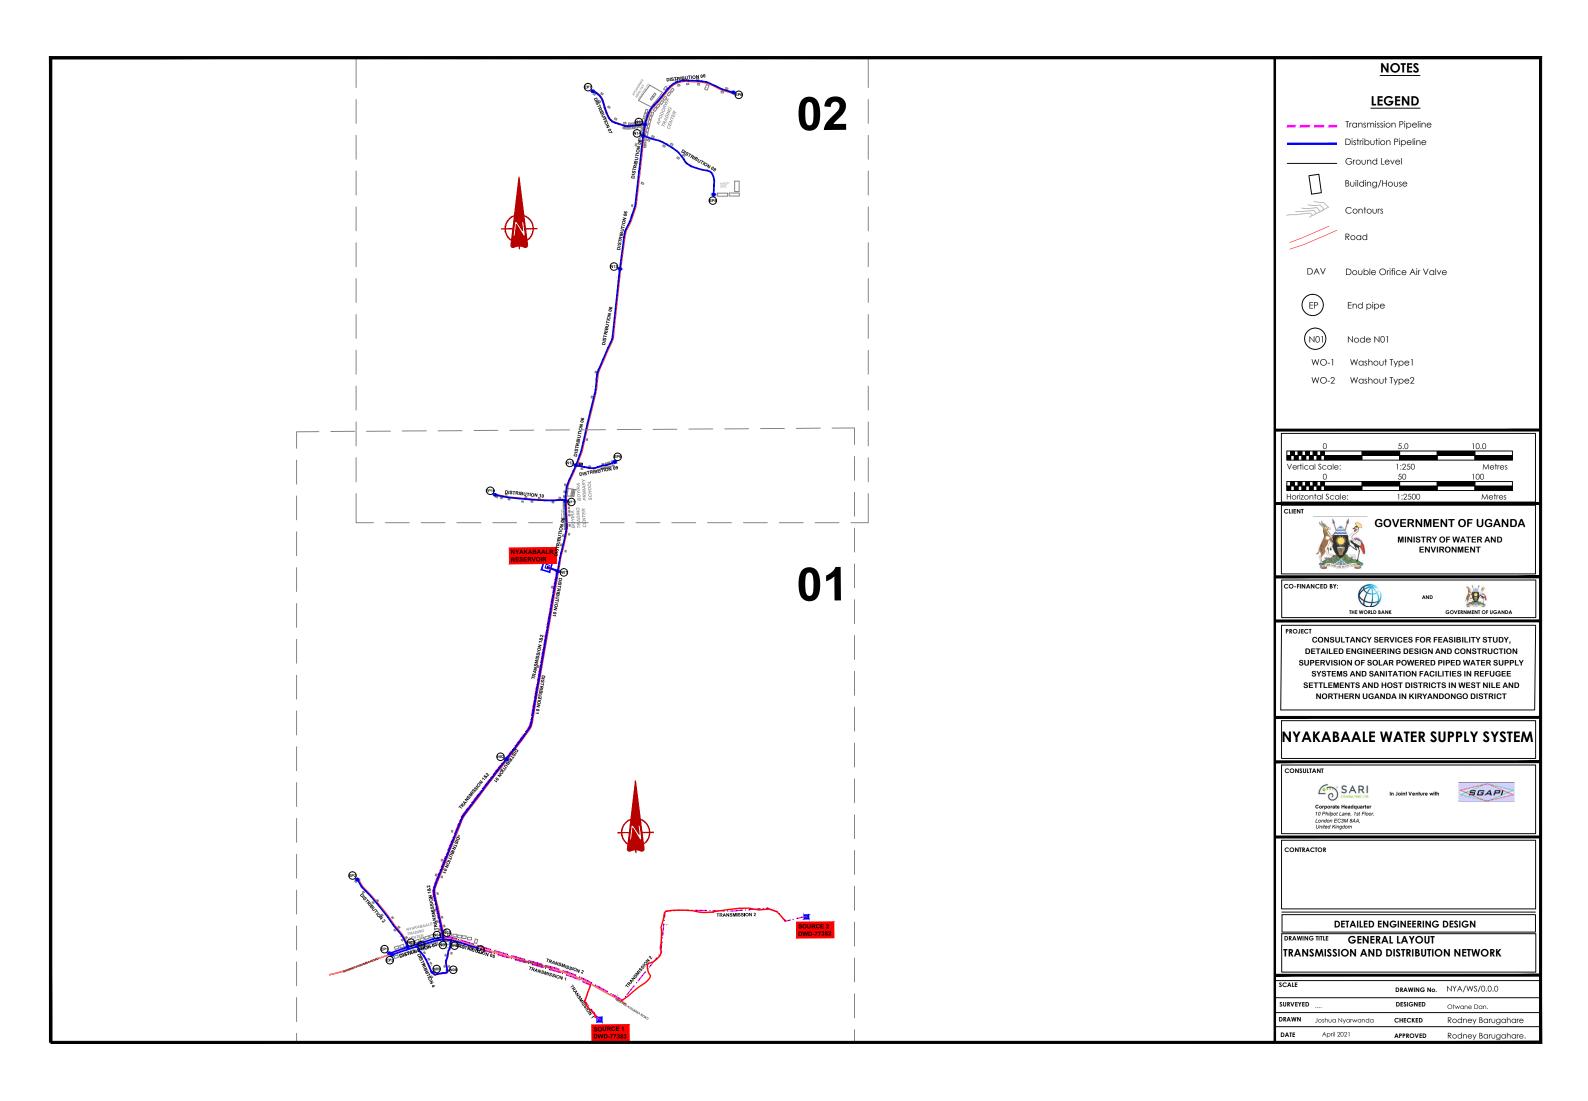


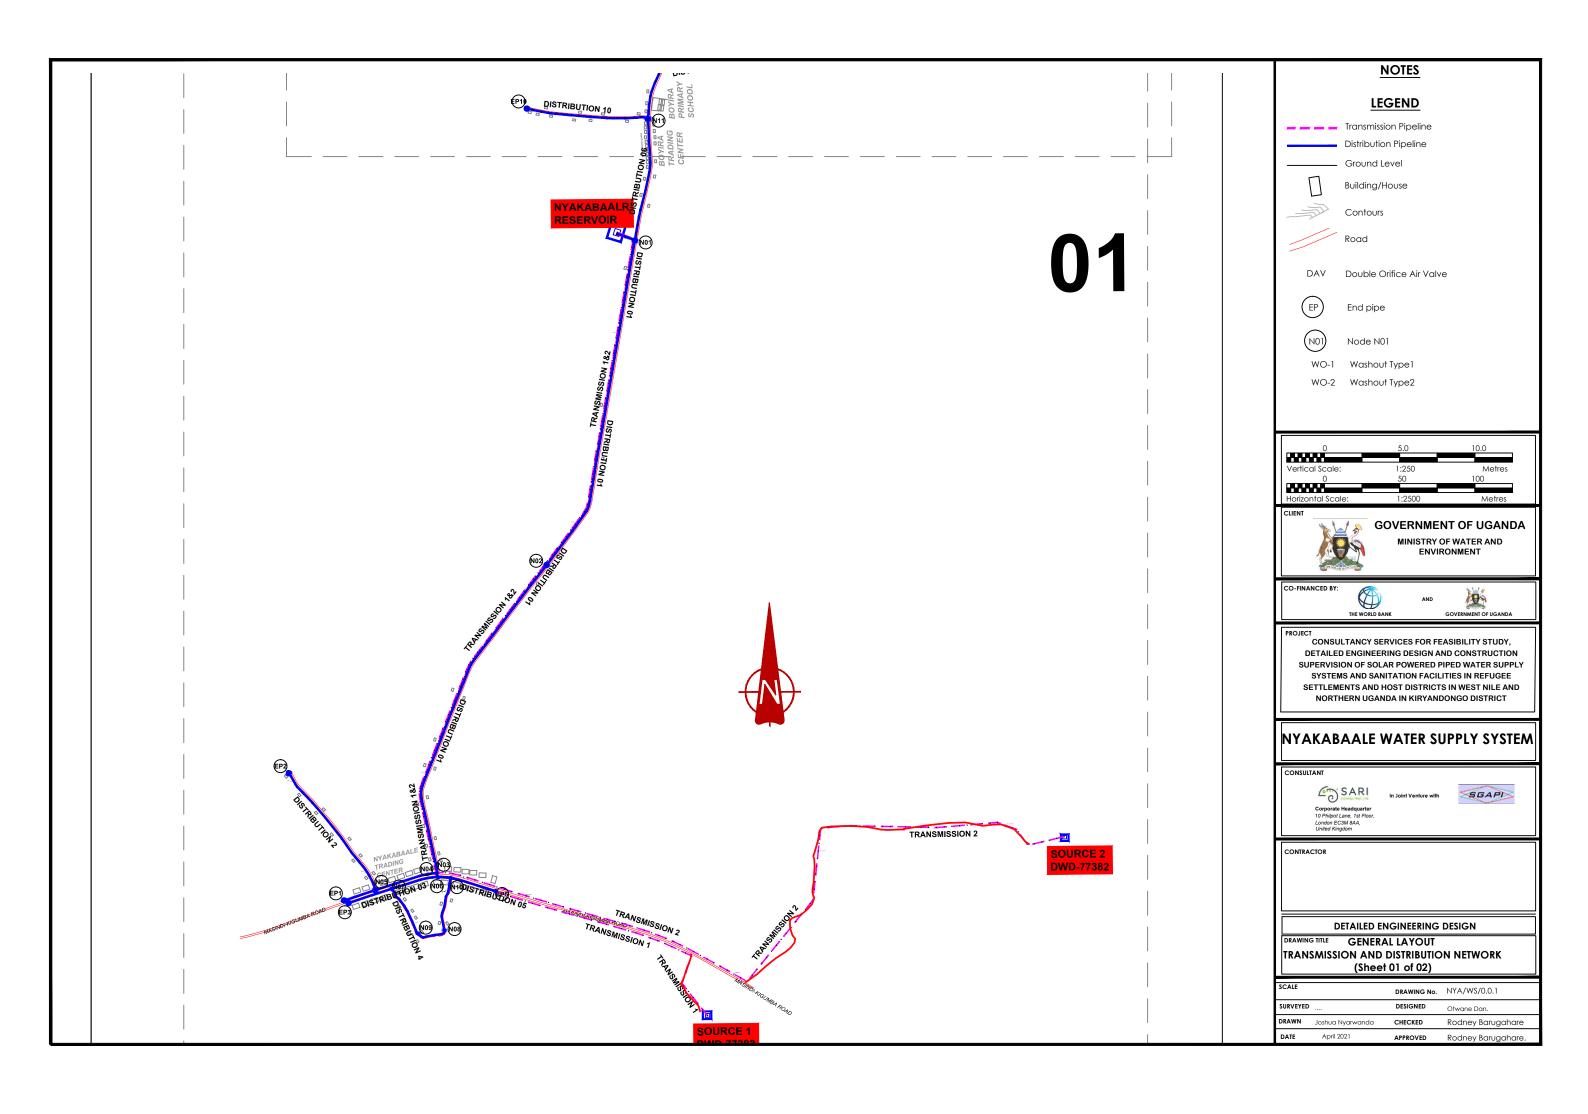


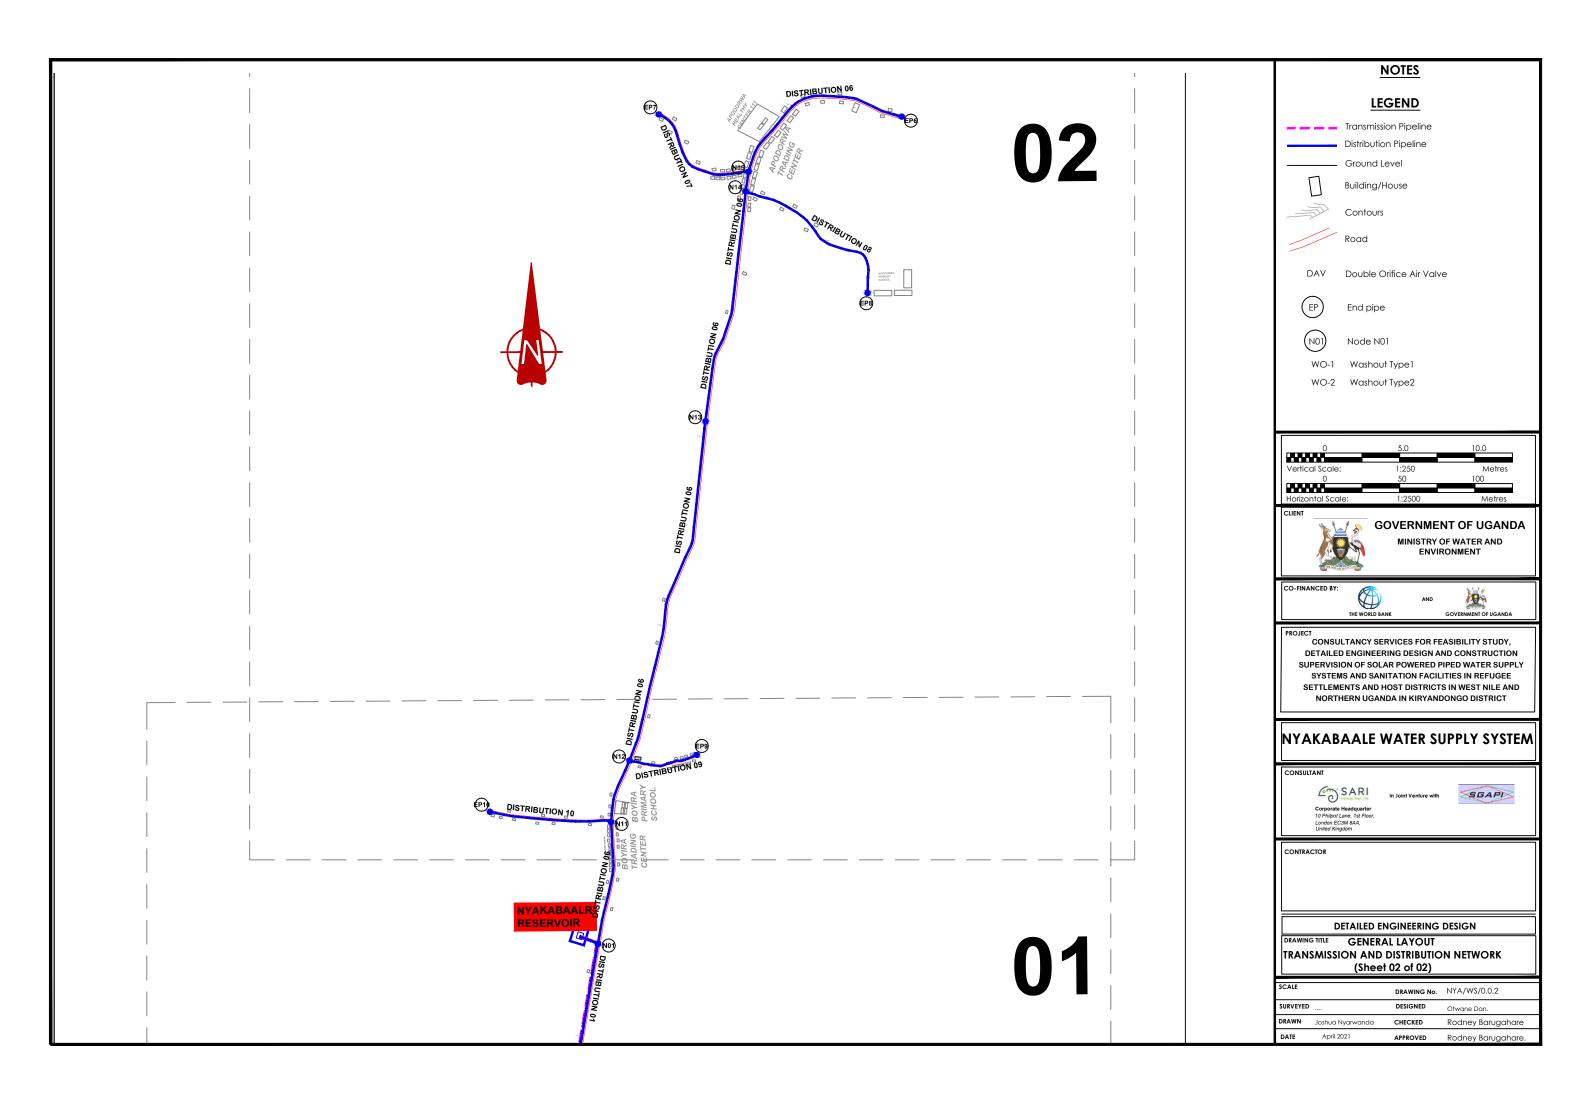


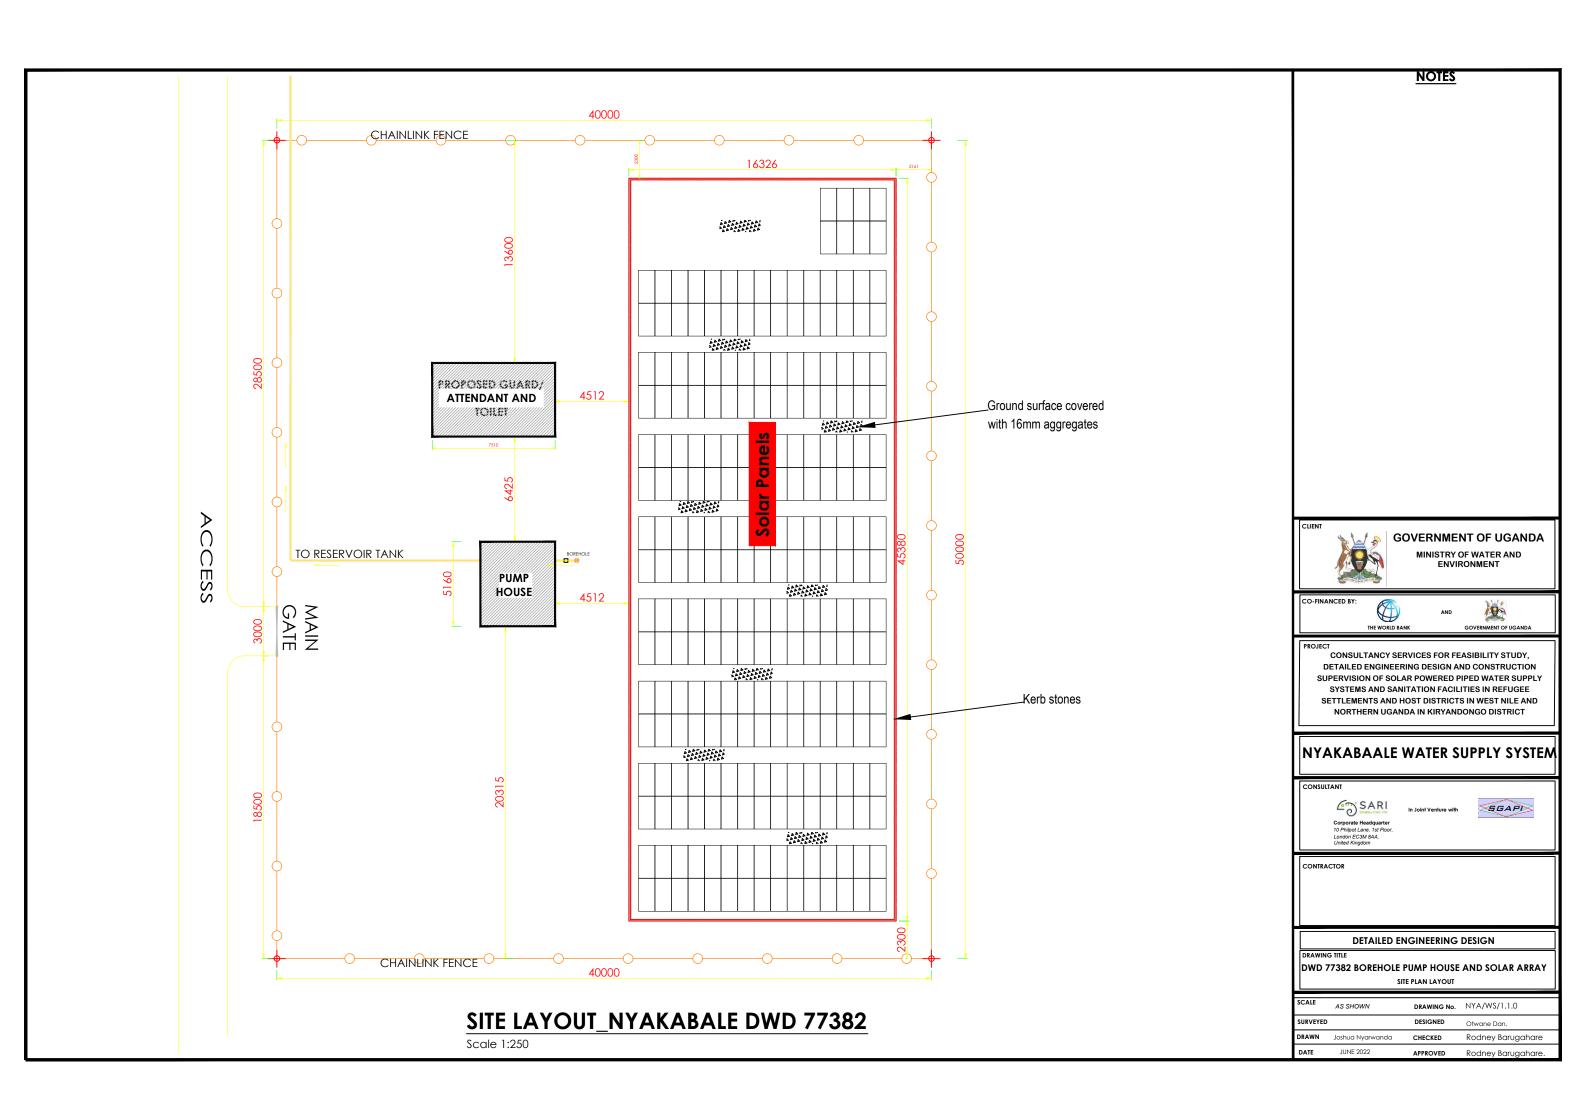


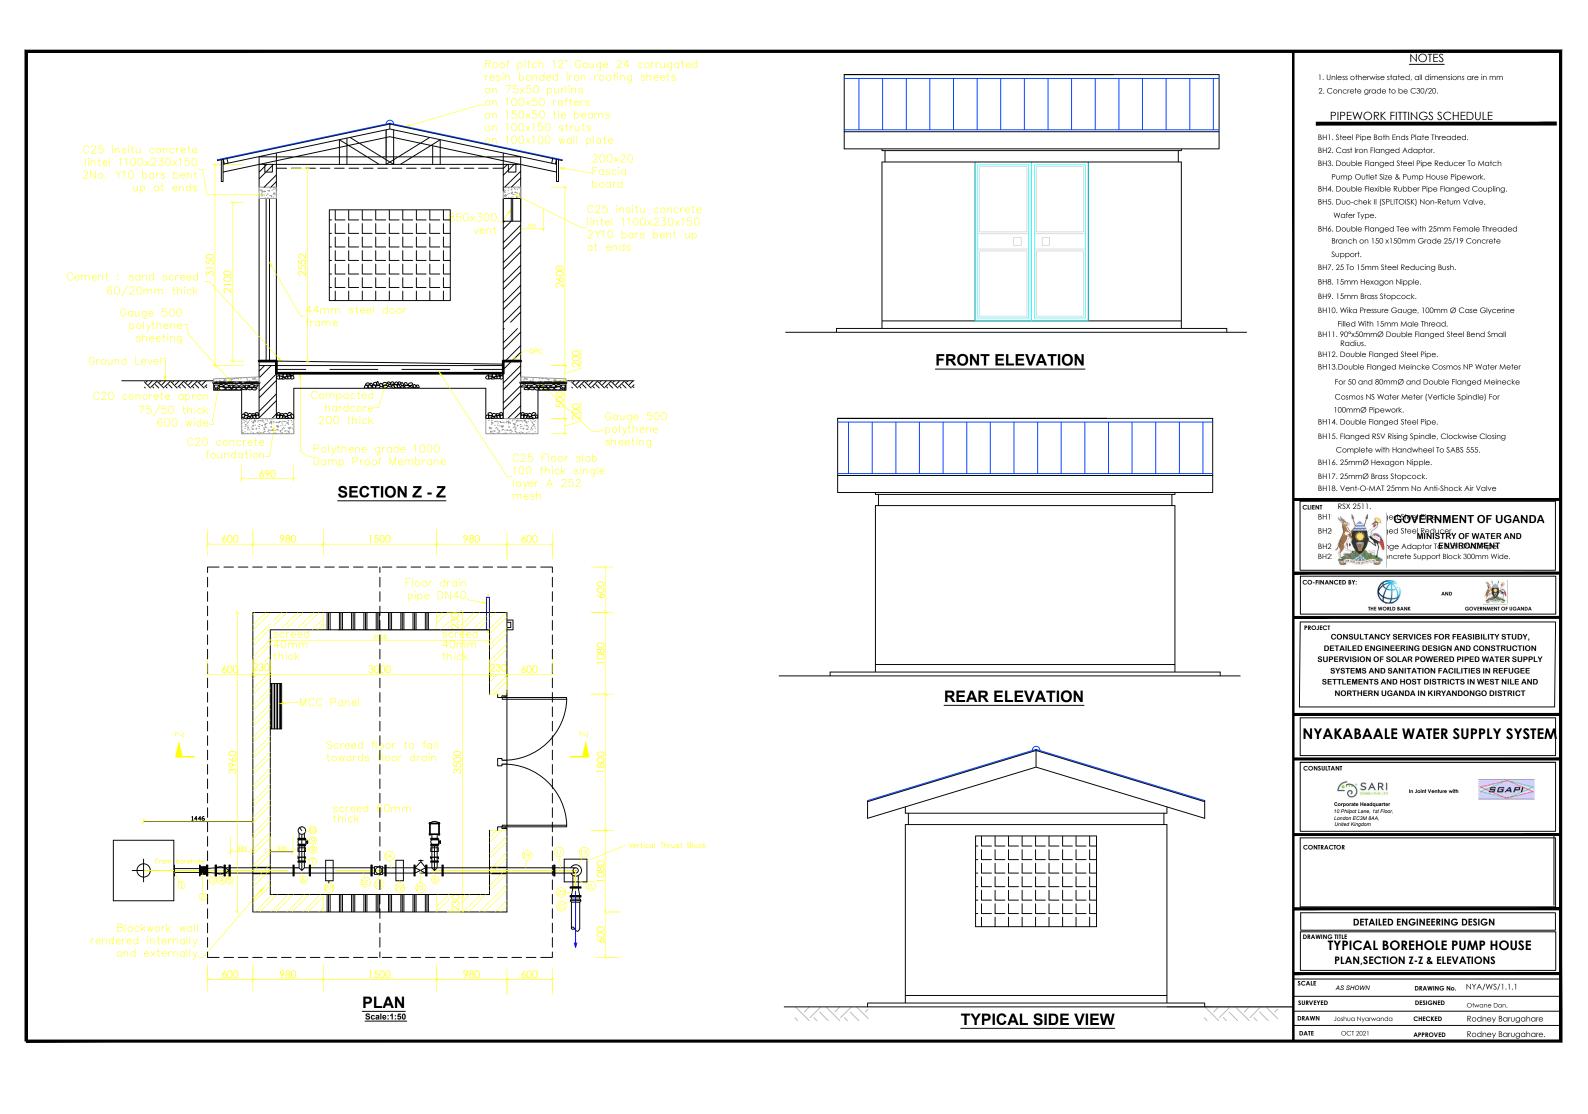


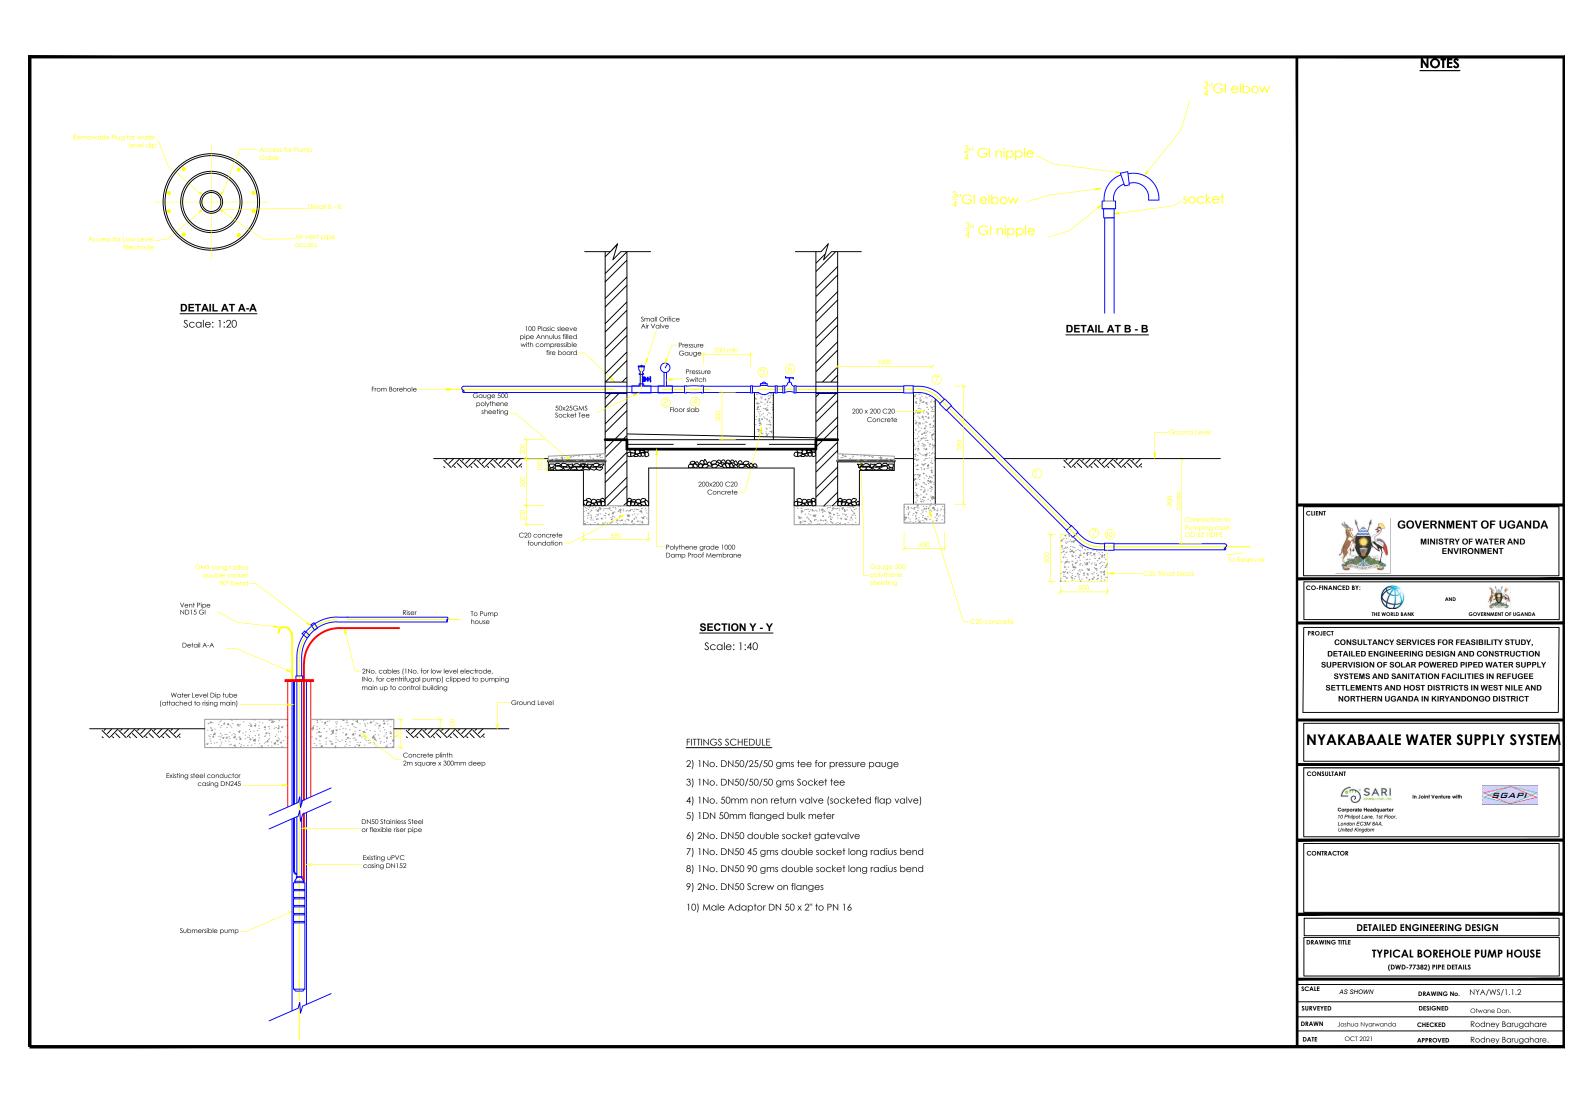


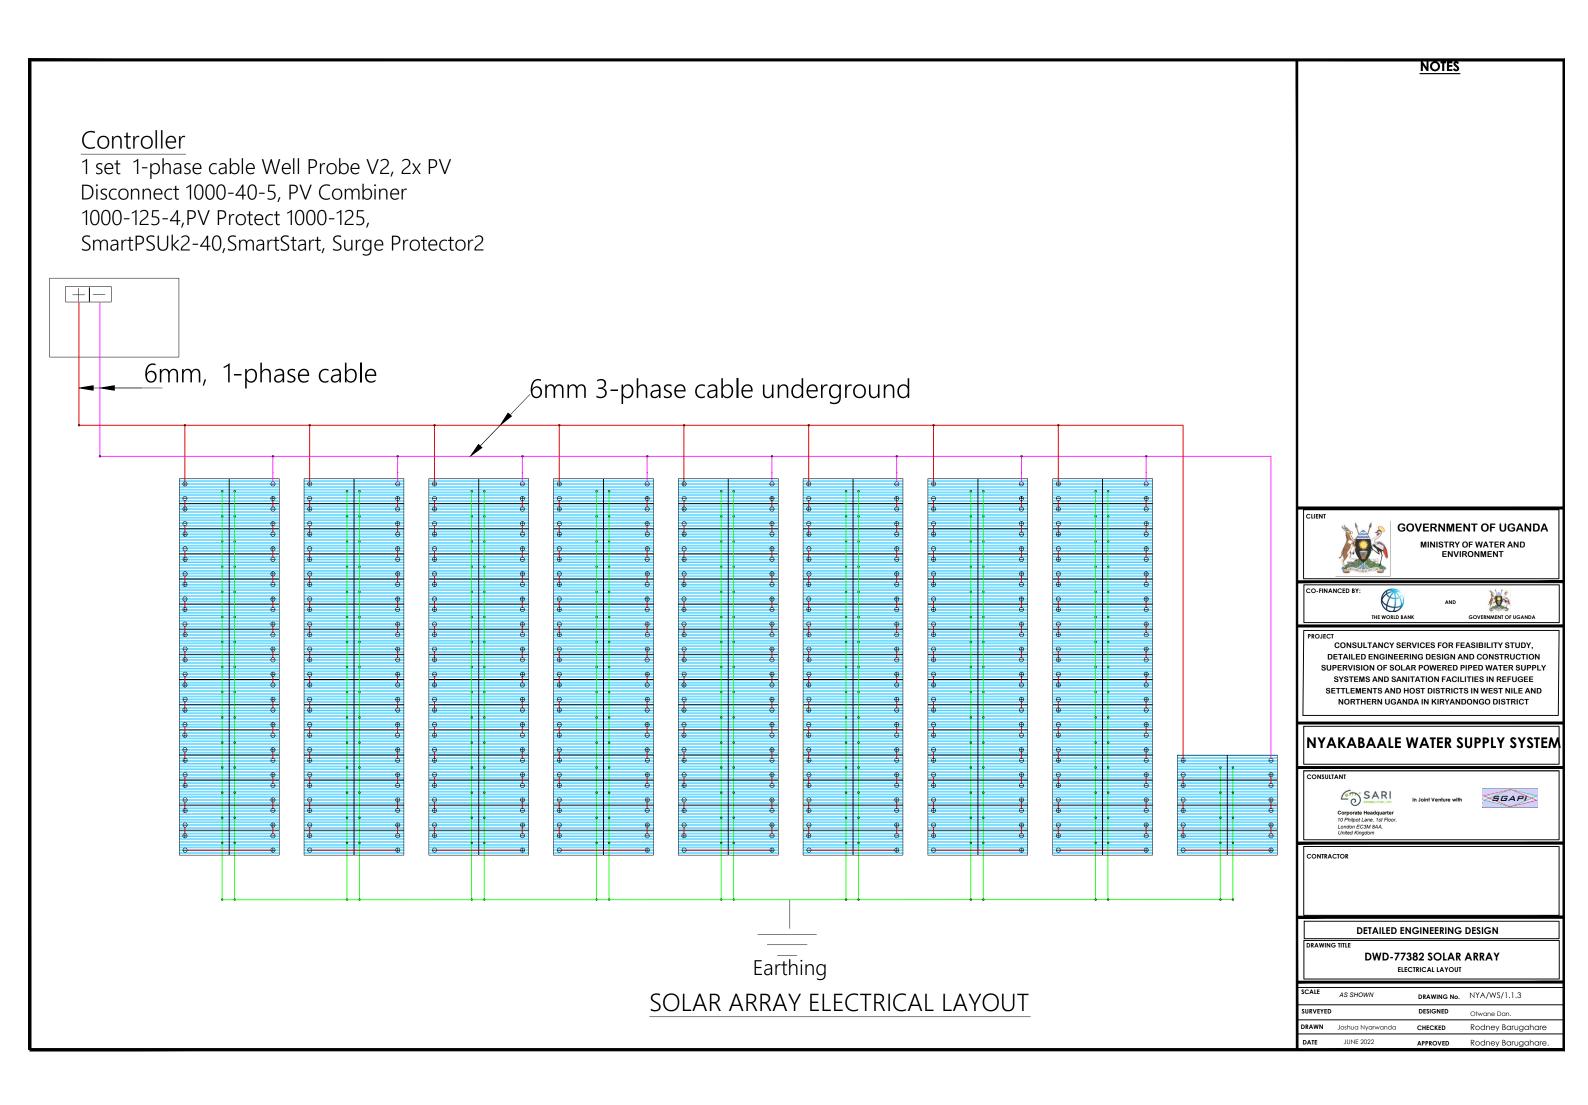


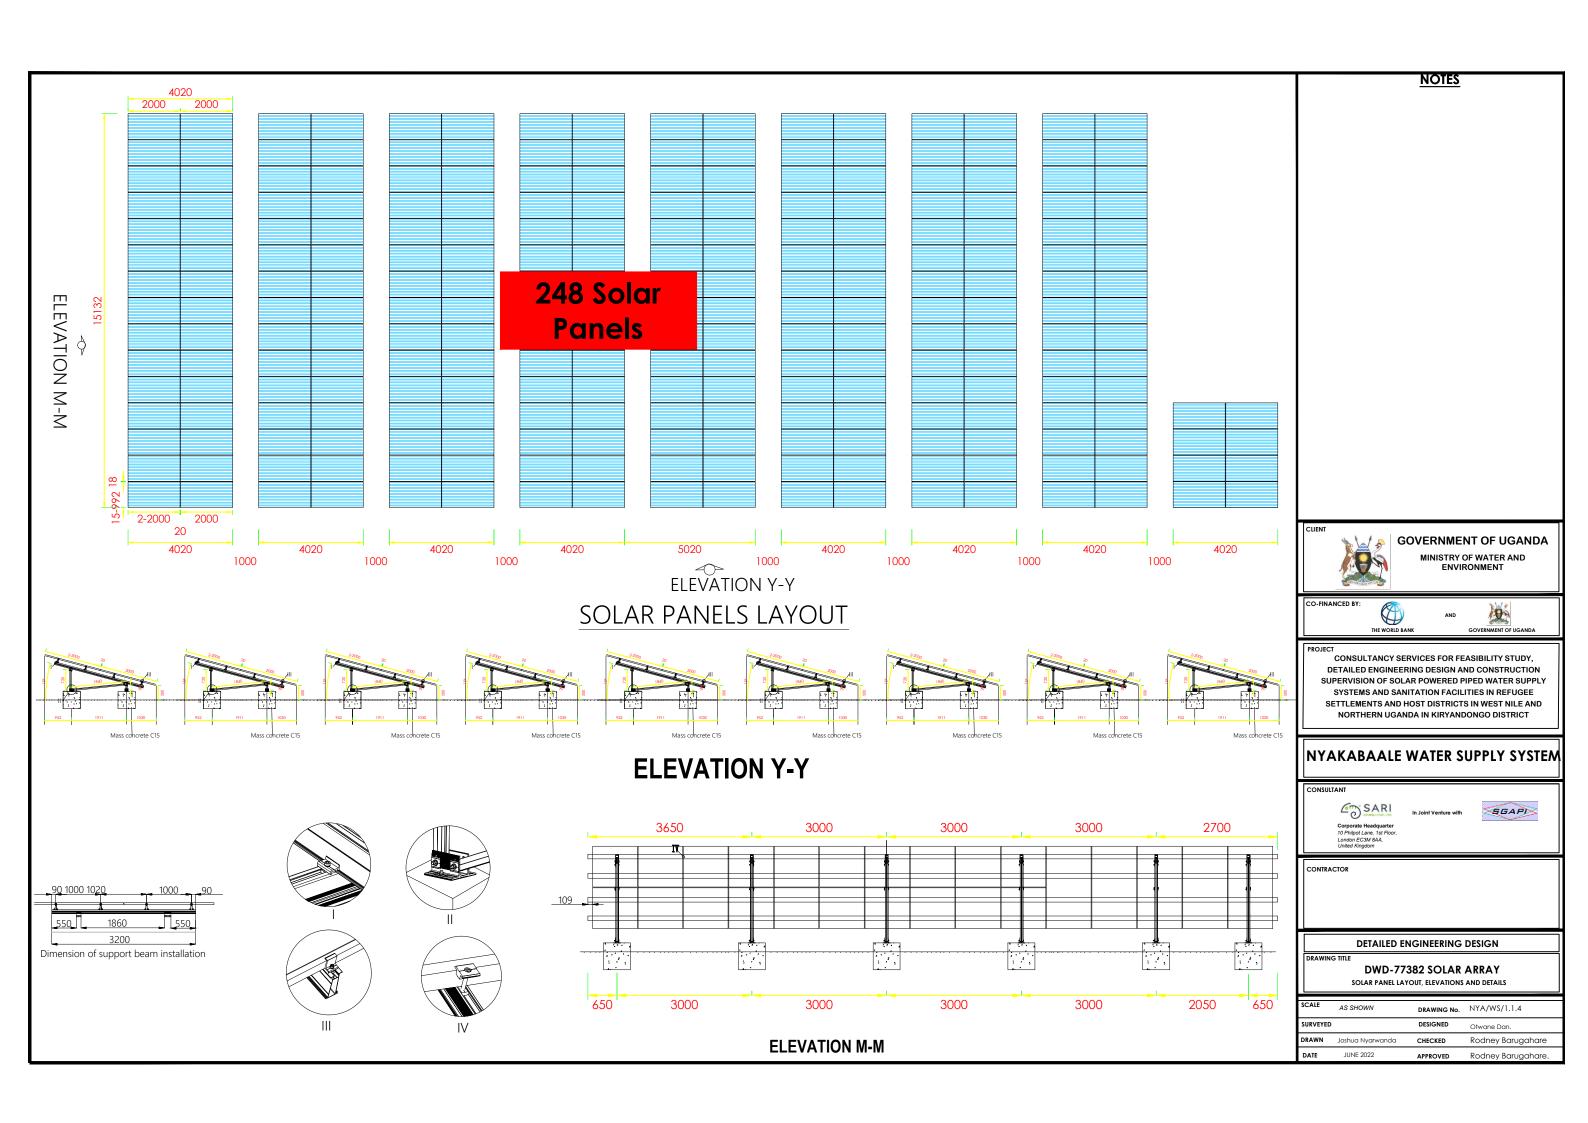


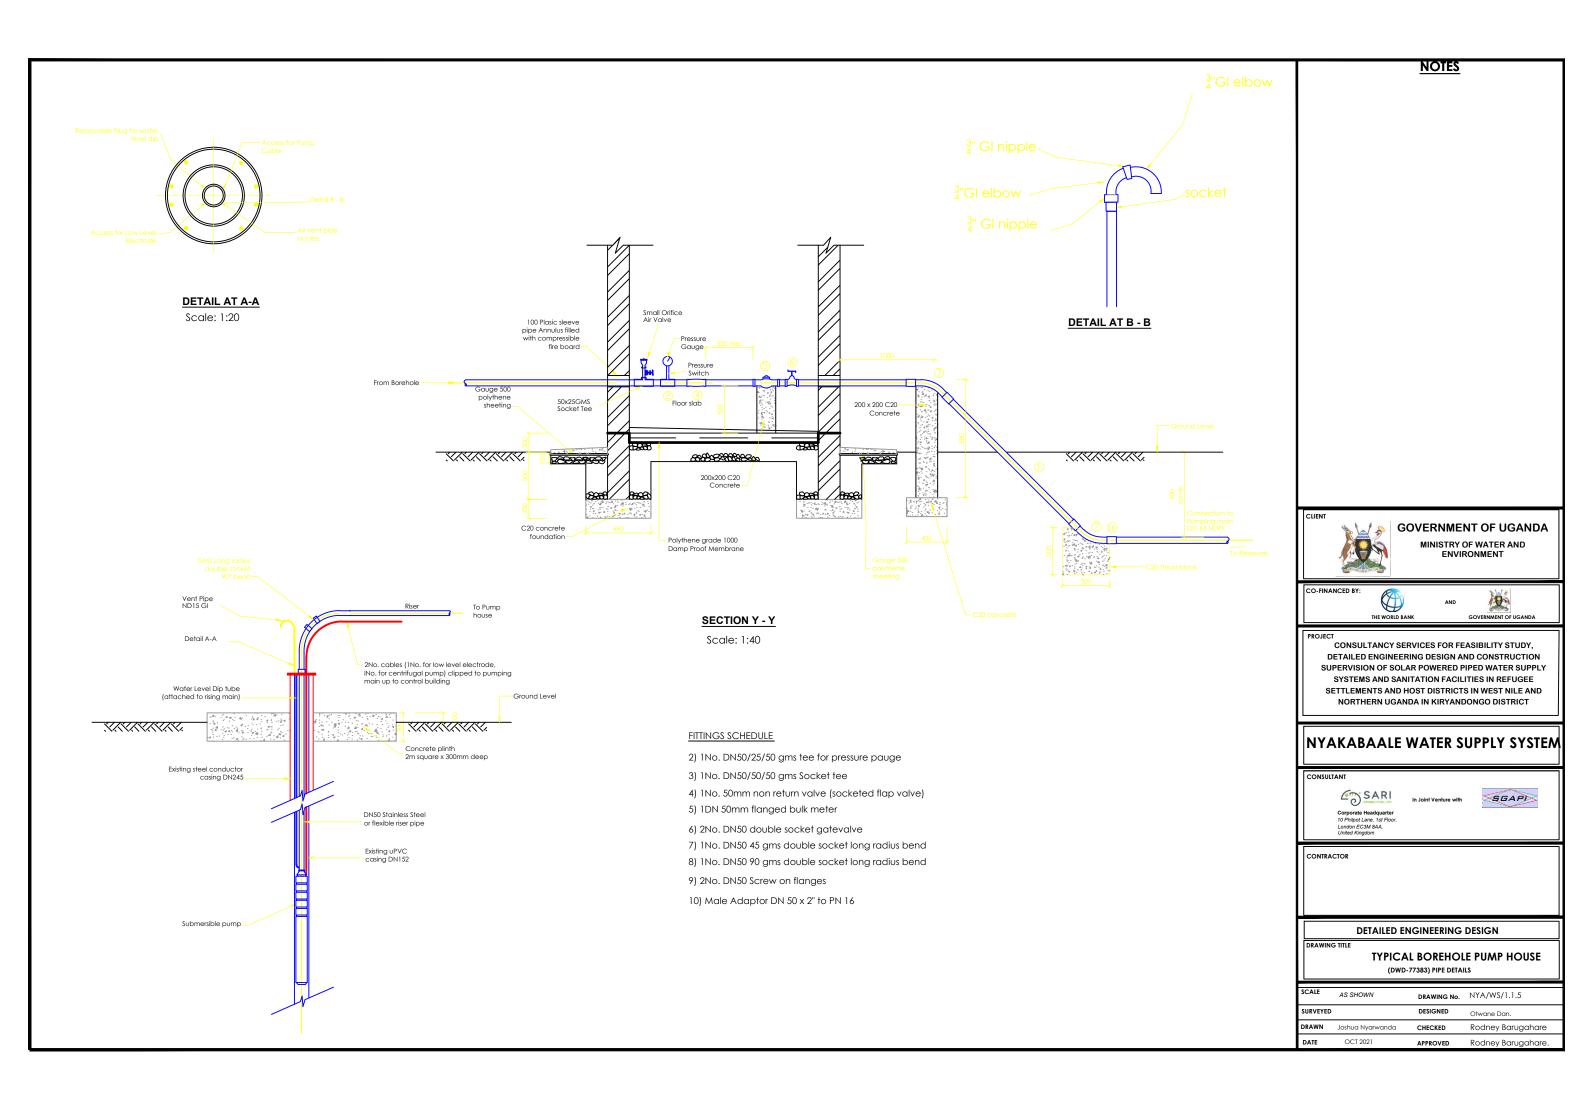


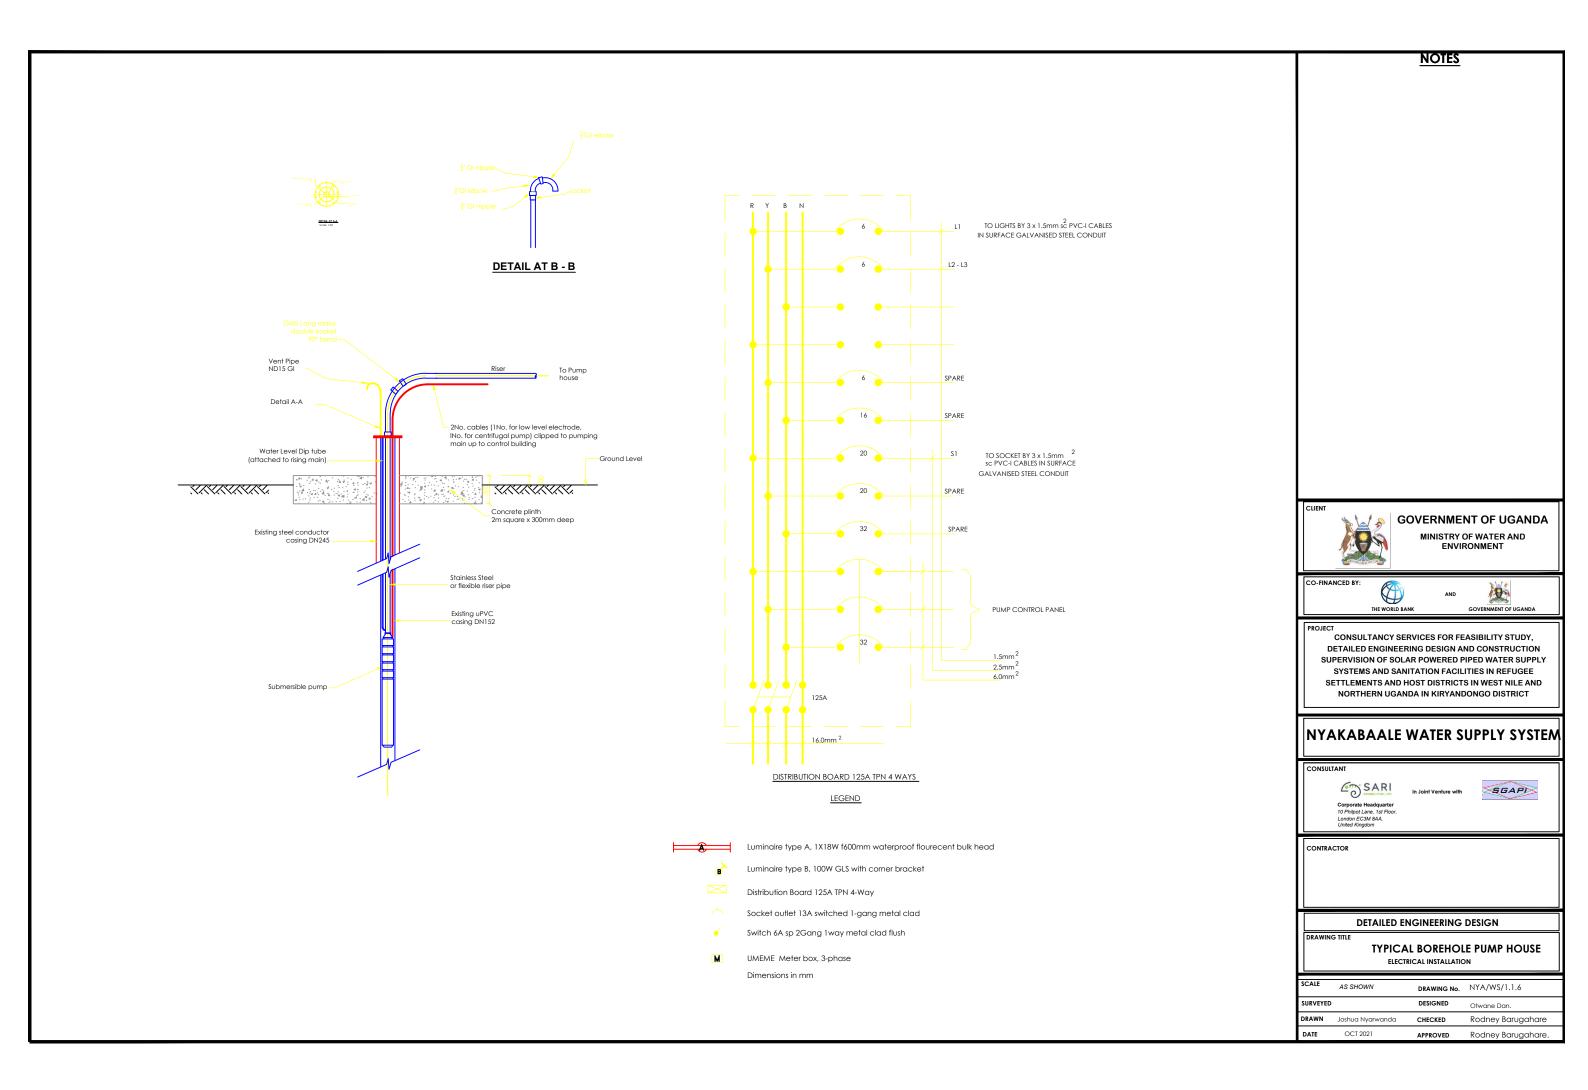


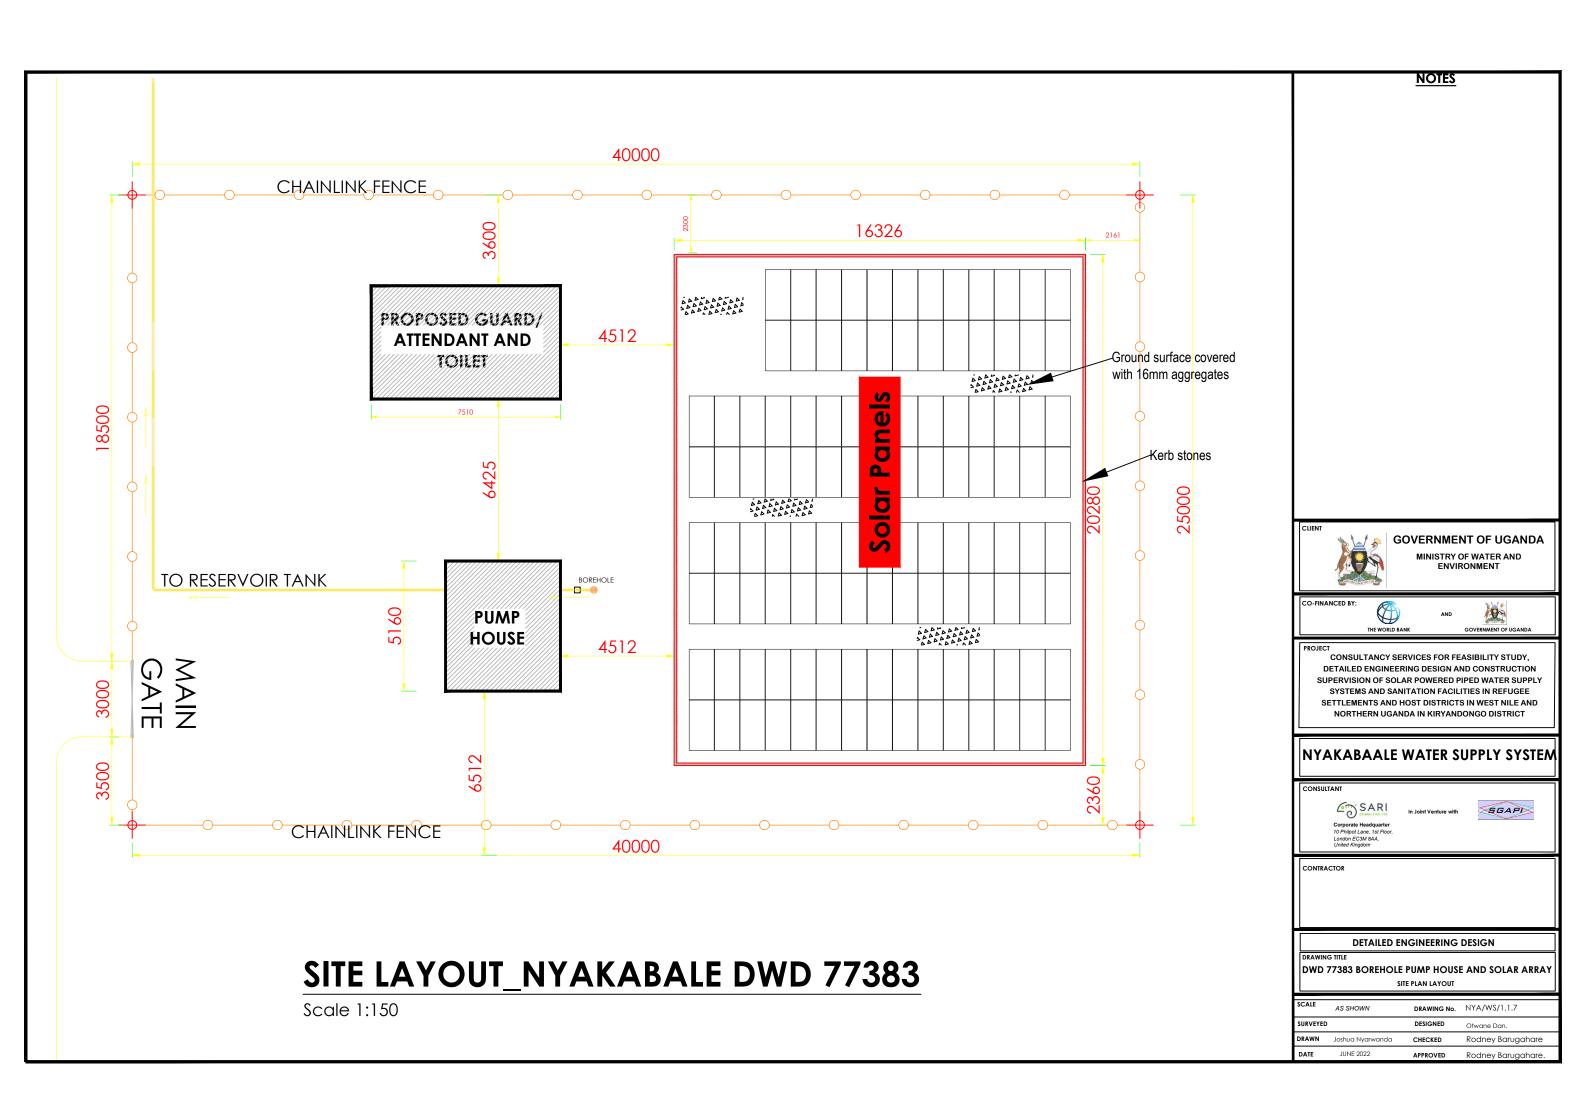


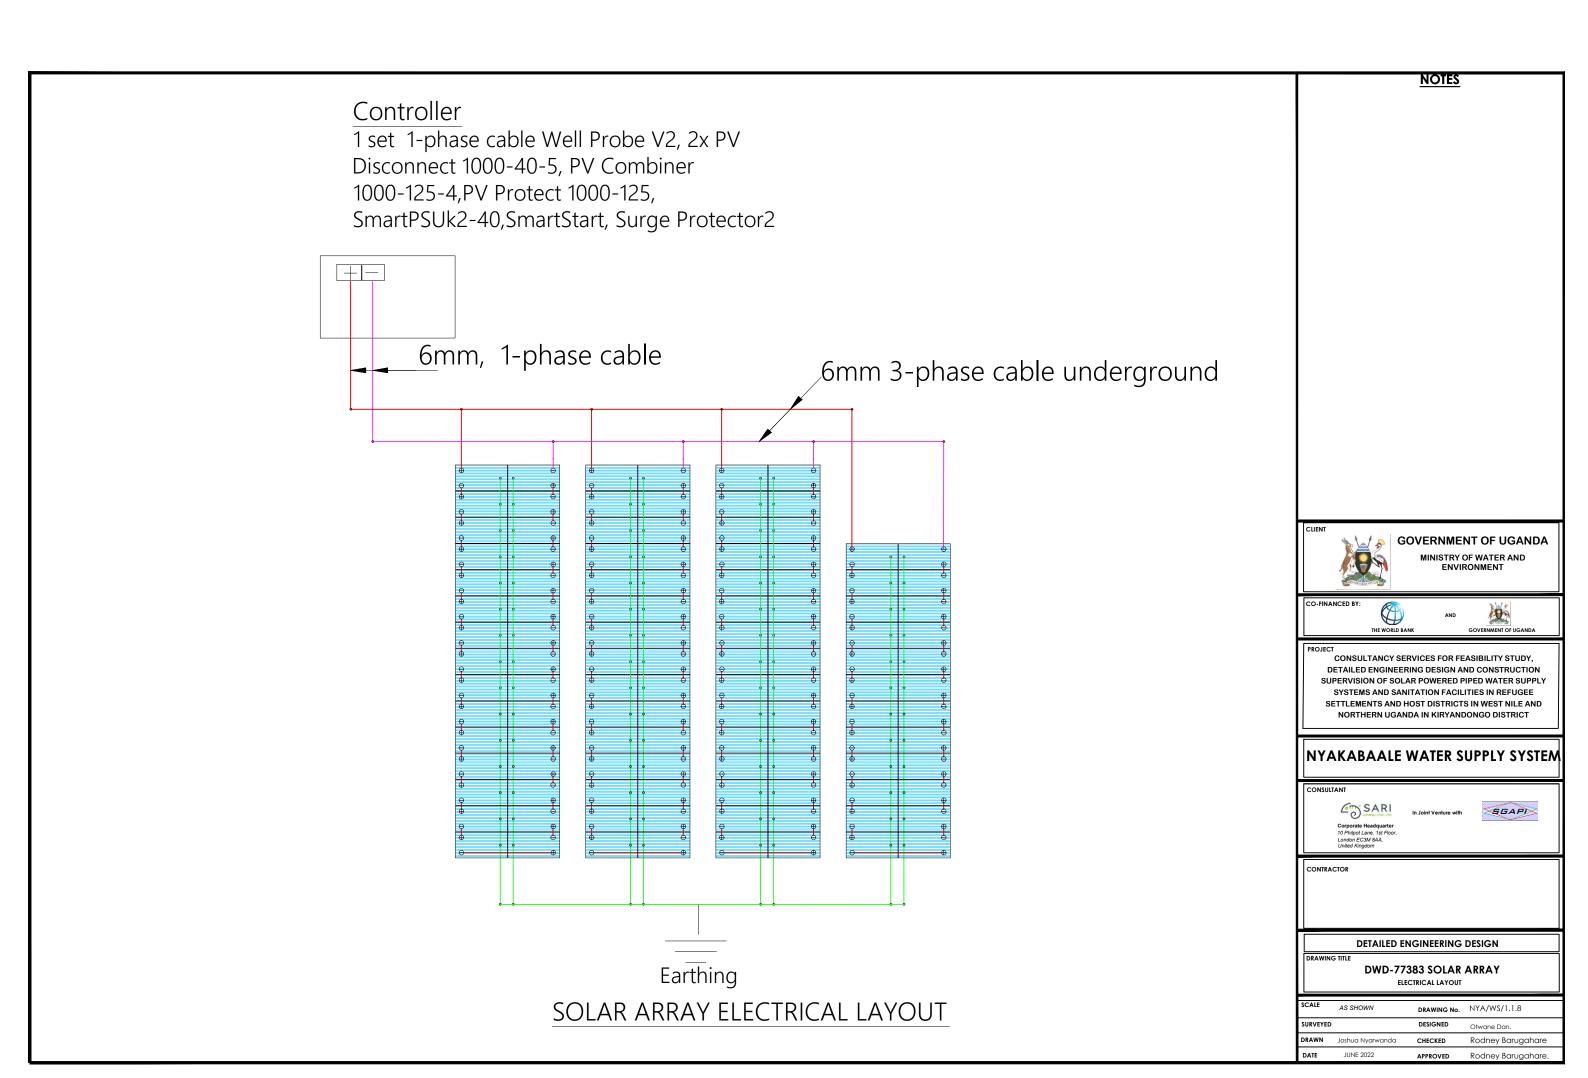


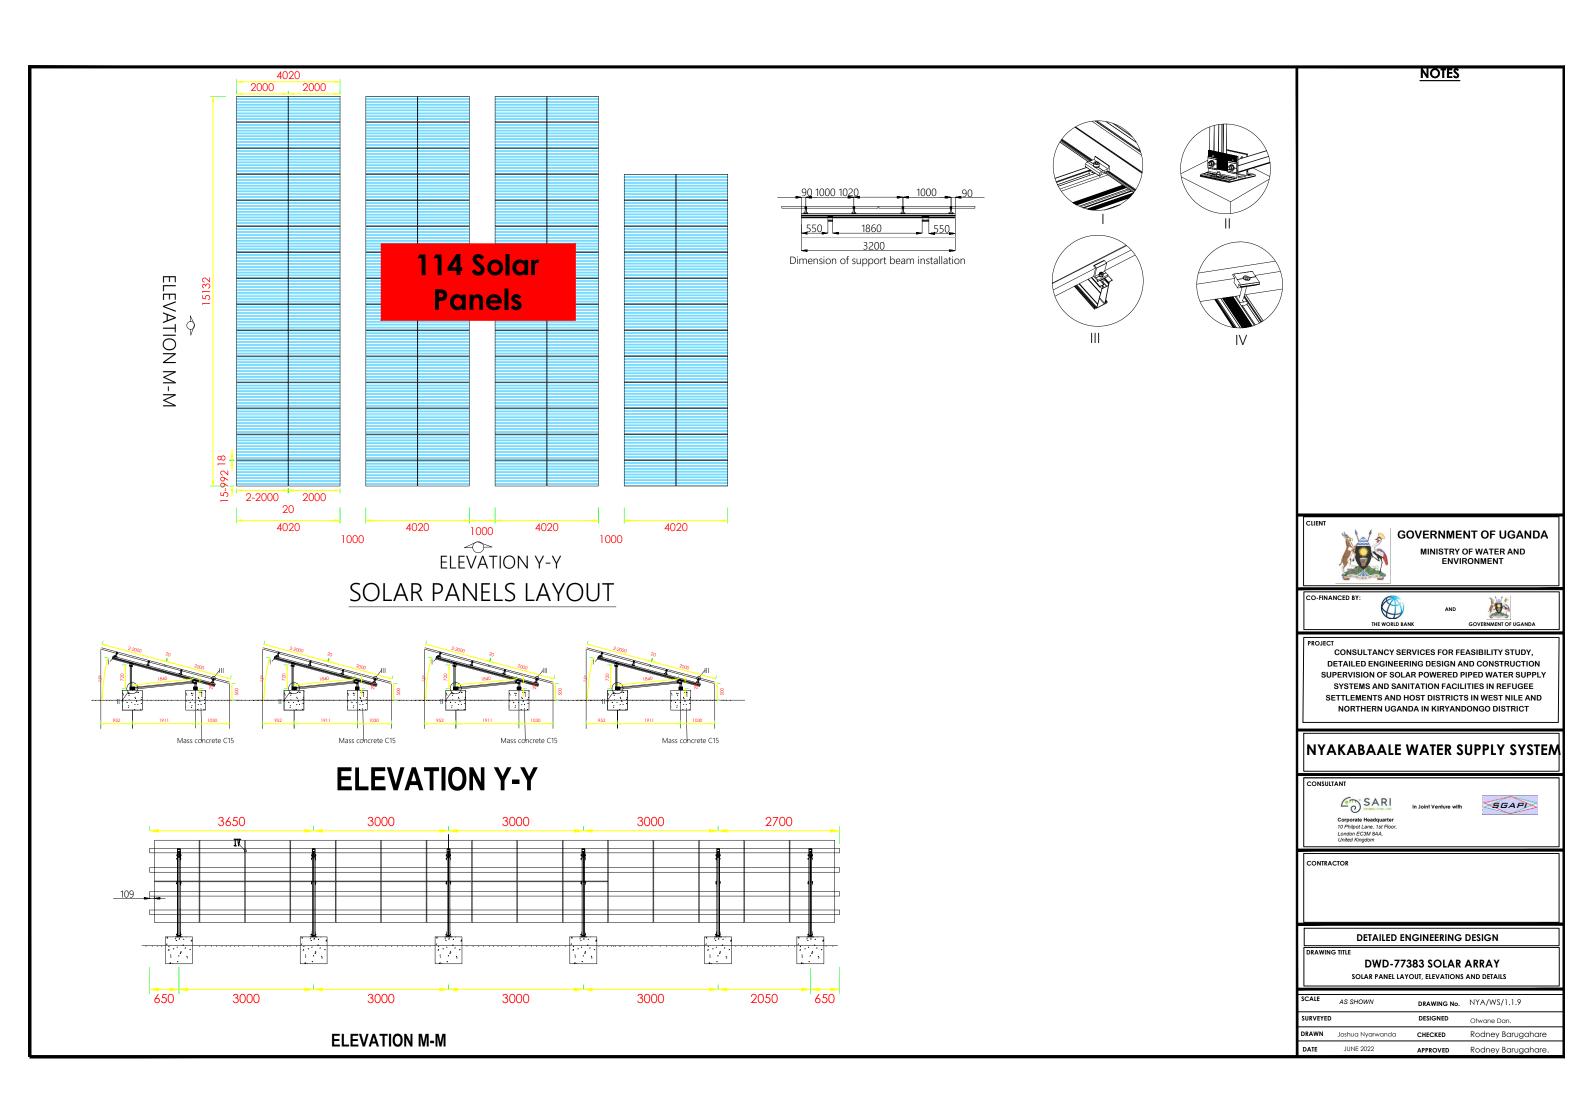


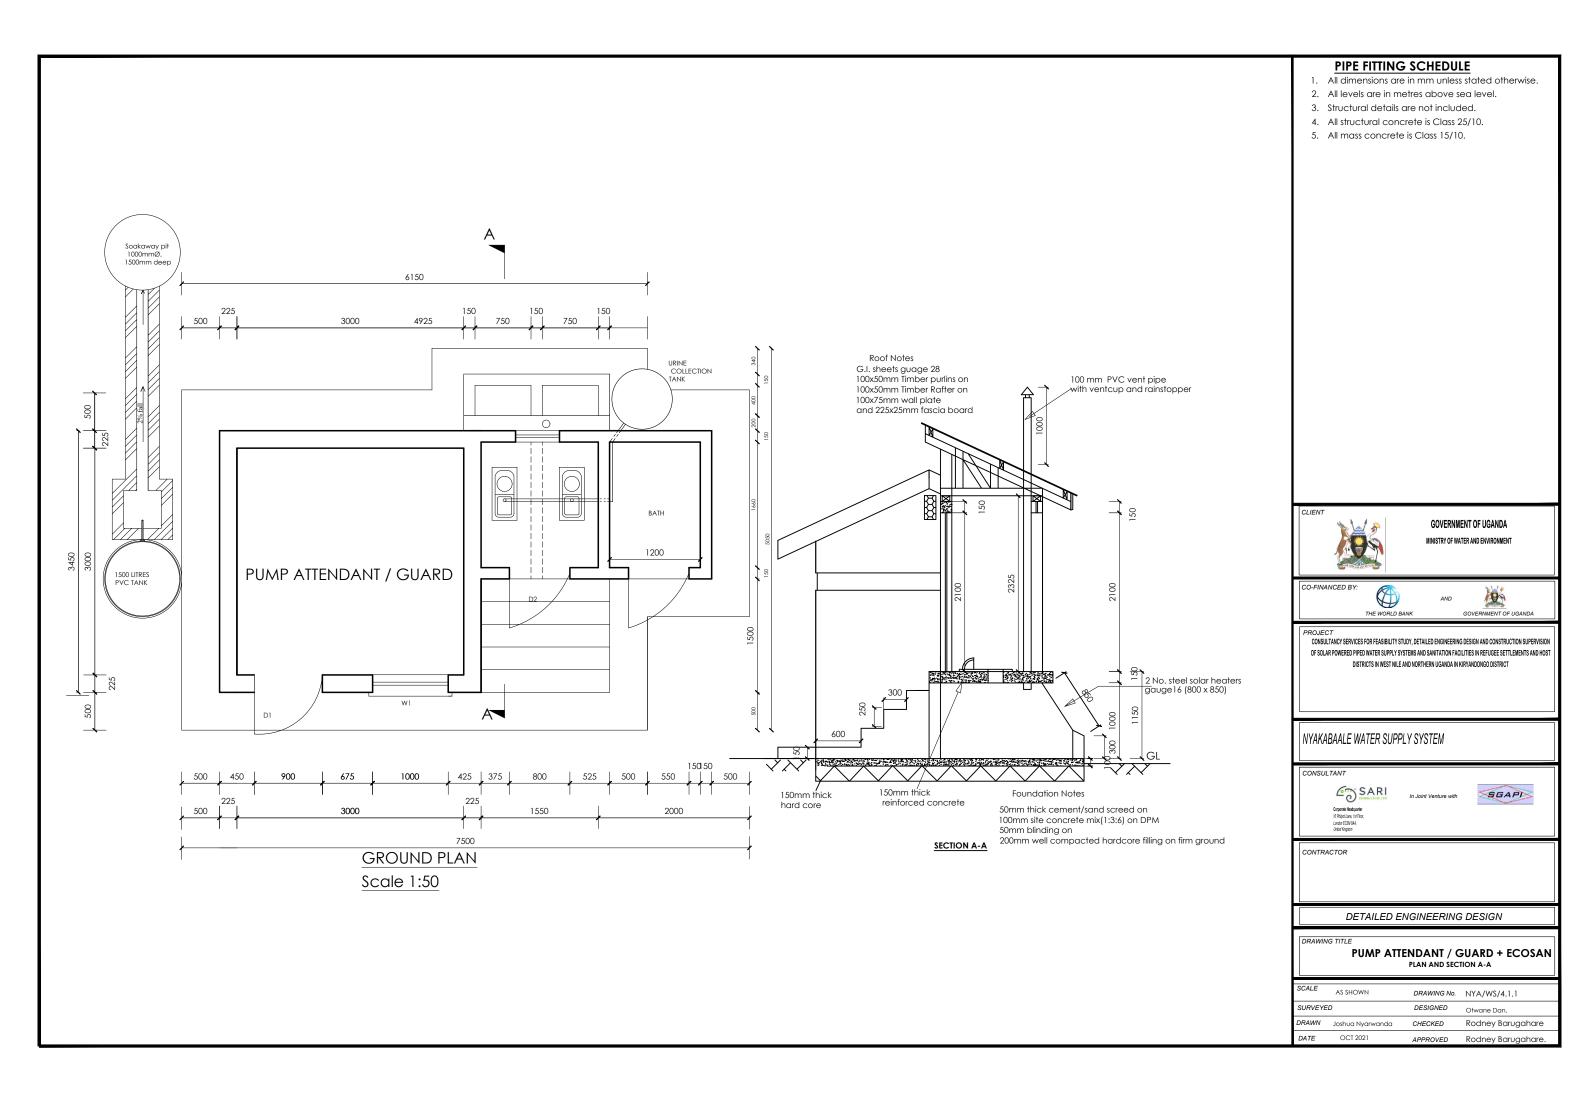

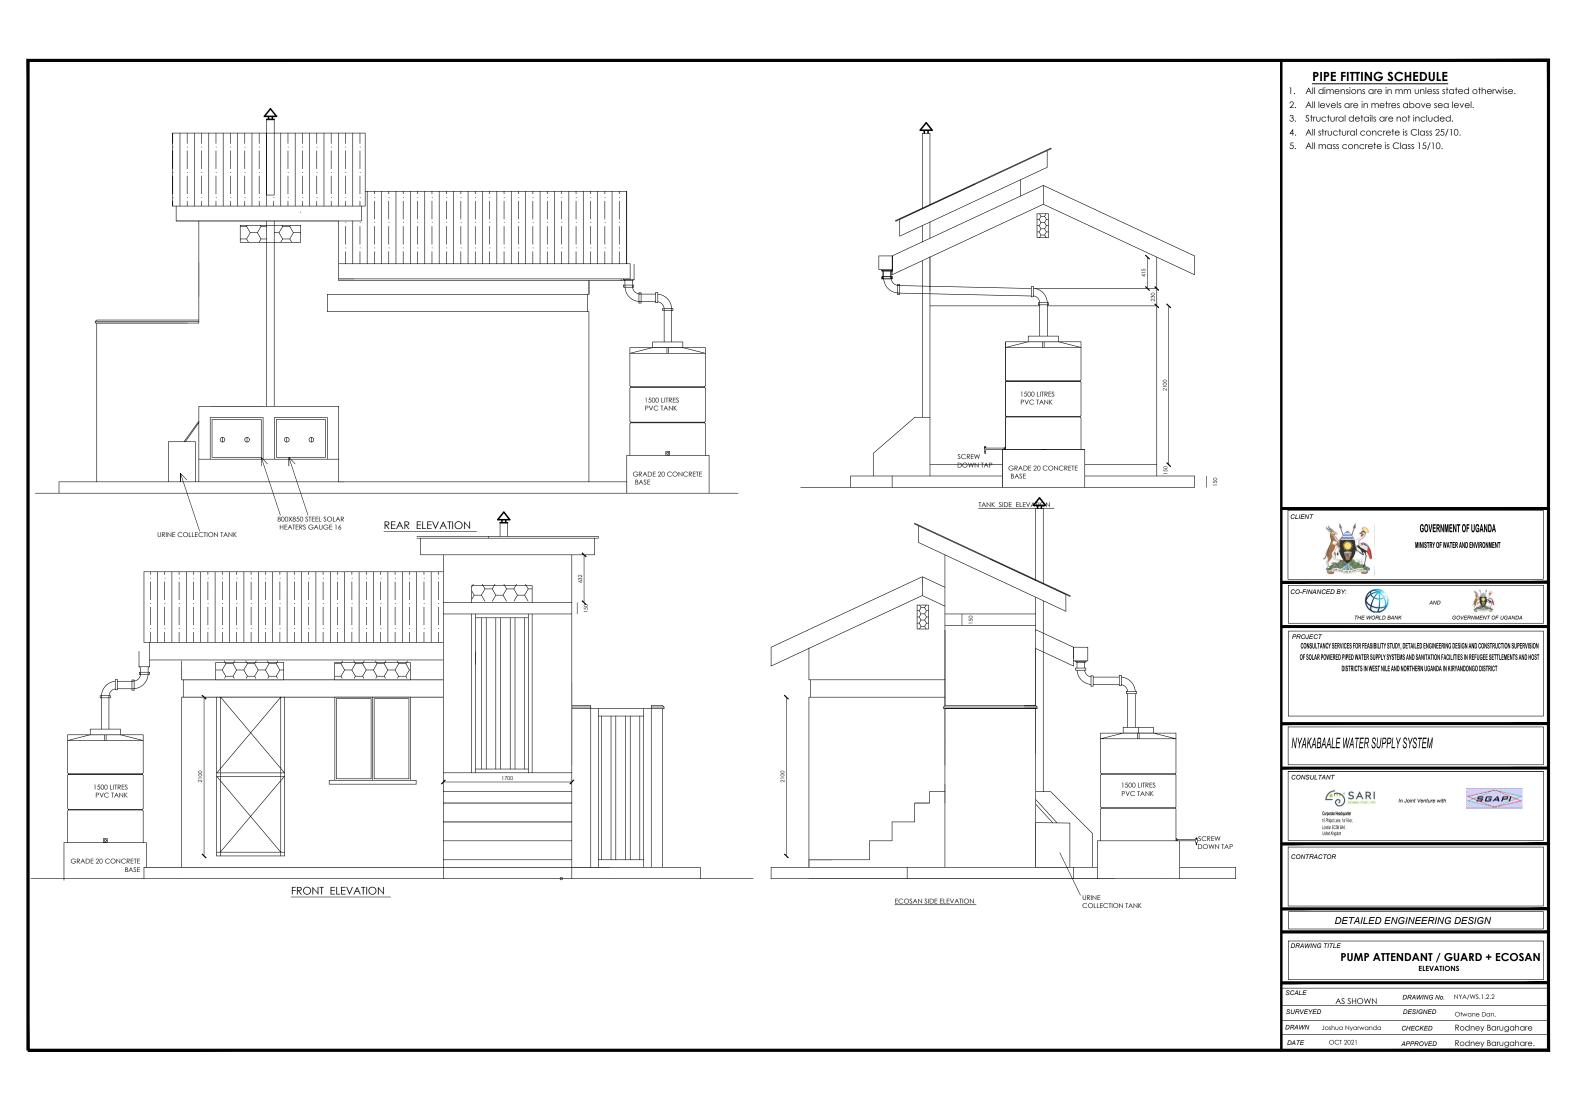


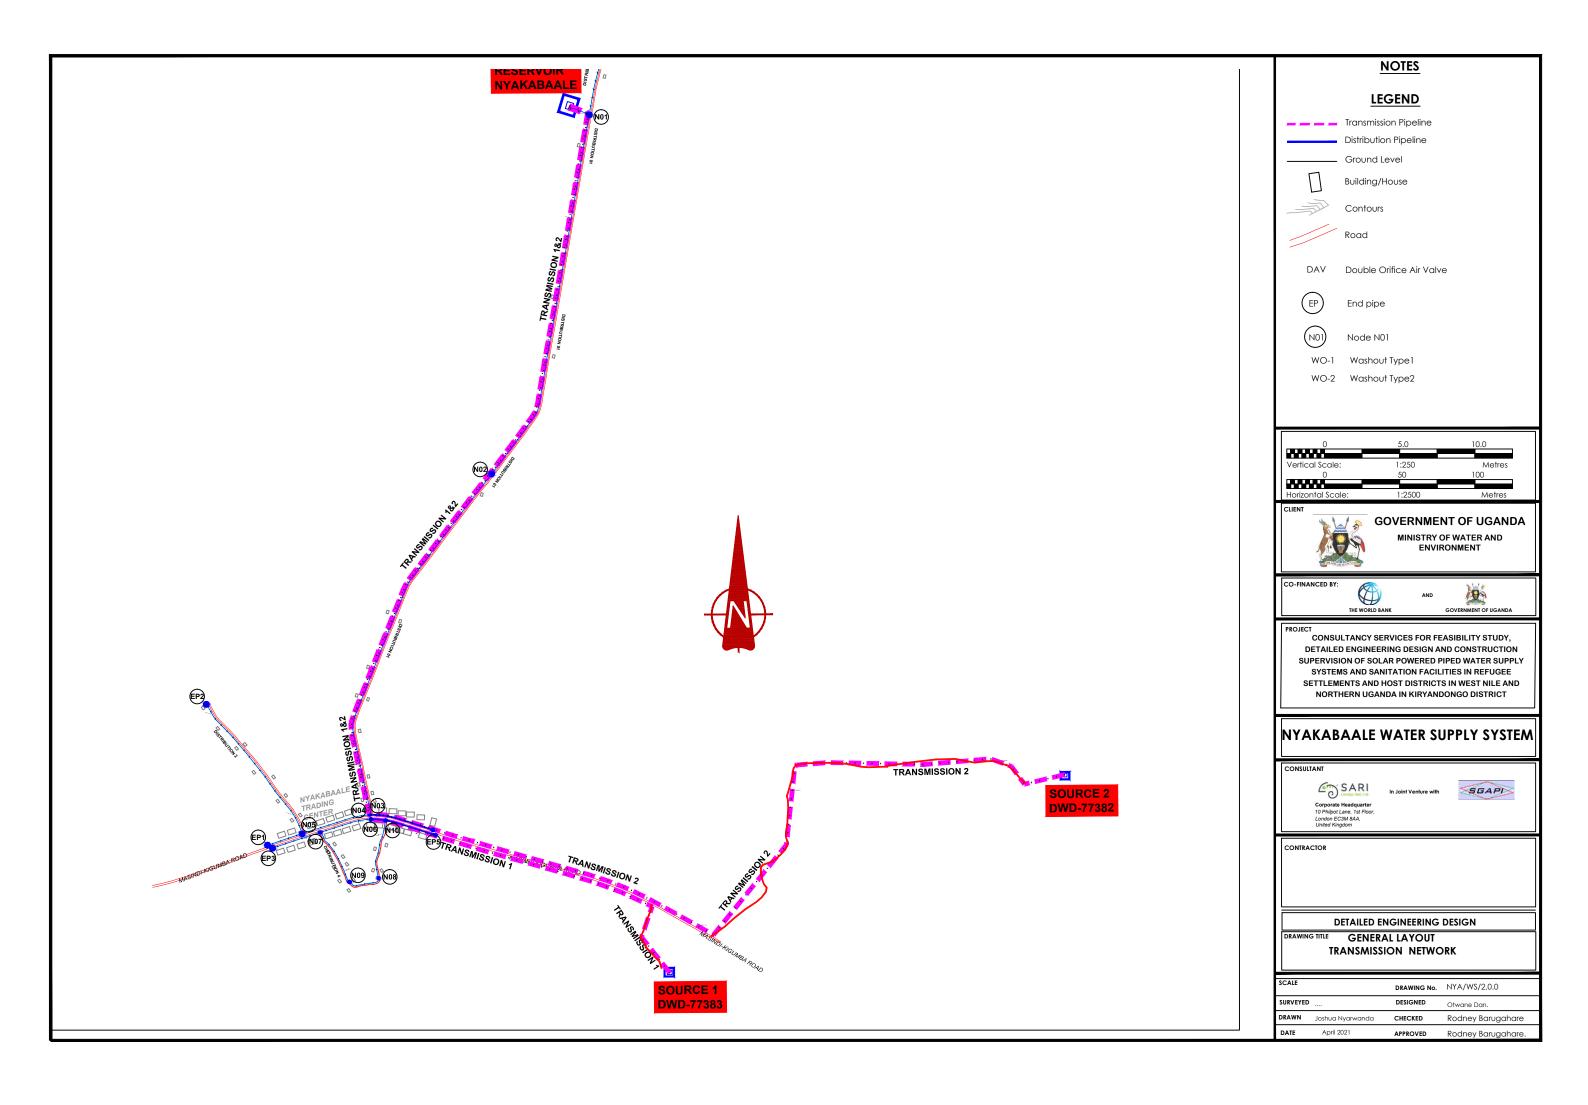


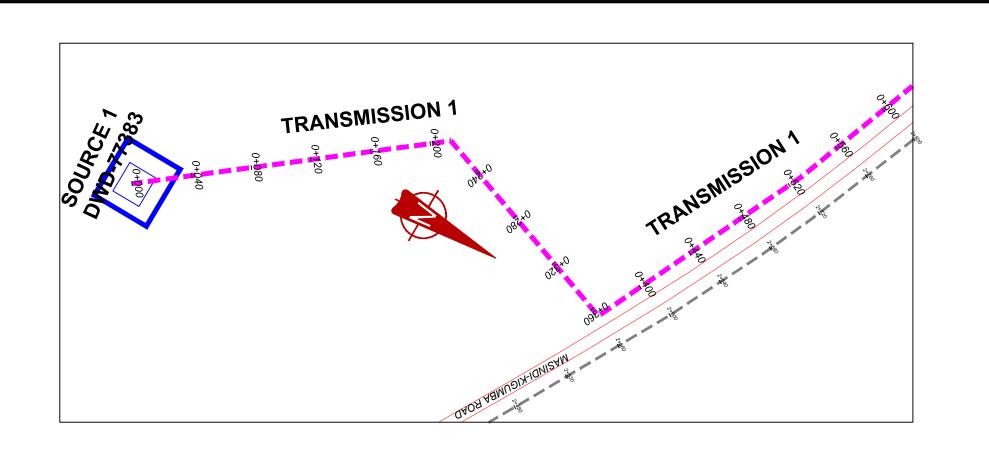


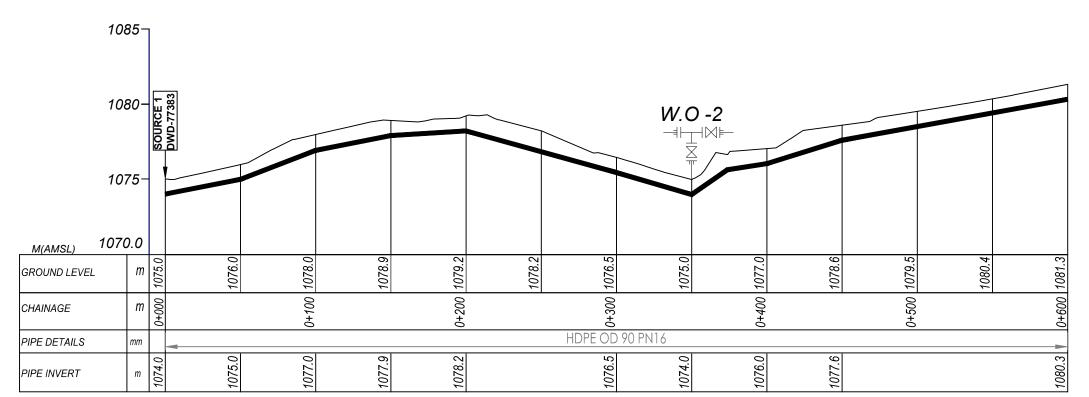

TRANSMISSION 1 (0+000.00 - 0+600.00)

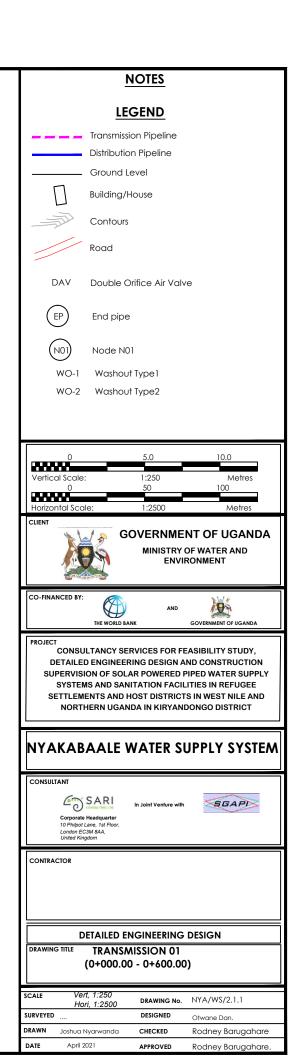


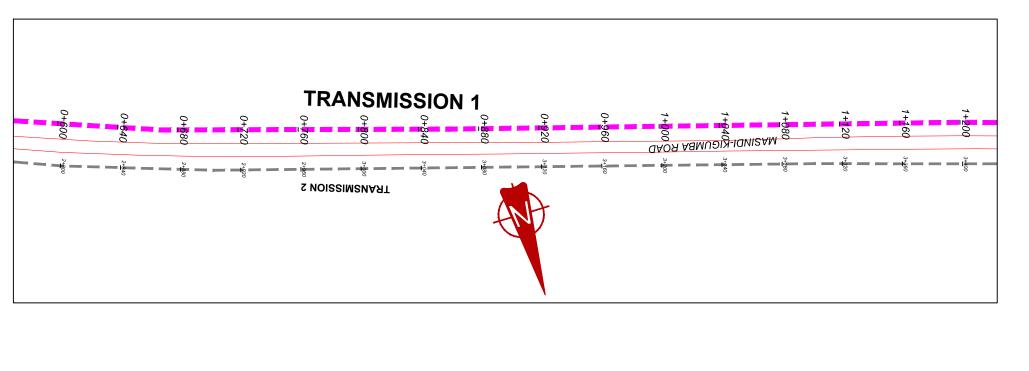

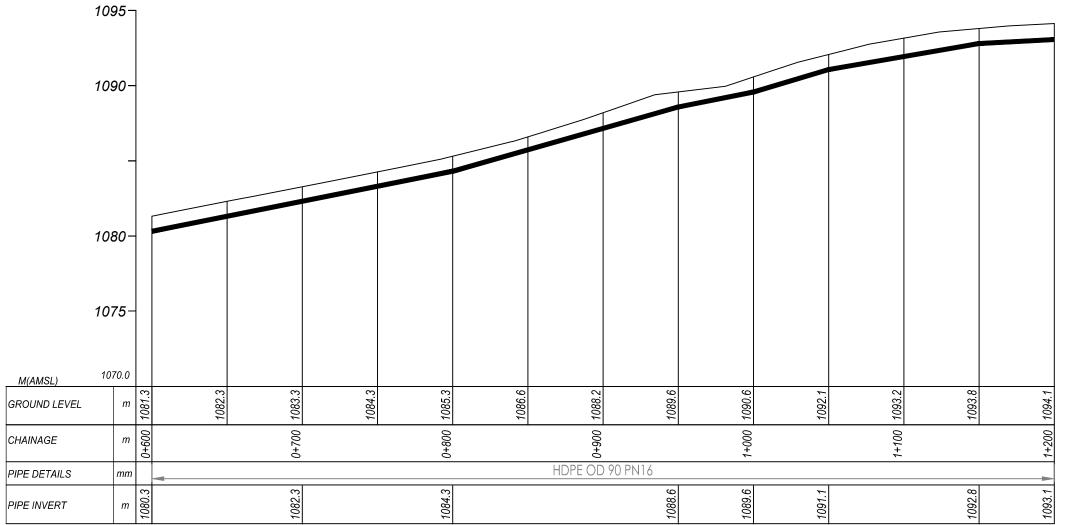

TRANSMISSION 1 (0+600.00 - 1+200.00)

NOTES LEGEND Transmission Pipeline Distribution Pipeline Ground Level Building/House Contours Road DAV Double Orifice Air Valve End pipe Node N01 WO-1 Washout Type 1 WO-2 Washout Type2

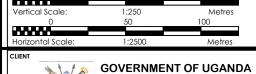





CONSULTANCY SERVICES FOR FEASIBILITY STUDY, DETAILED ENGINEERING DESIGN AND CONSTRUCTION SUPERVISION OF SOLAR POWERED PIPED WATER SUPPLY SYSTEMS AND SANITATION FACILITIES IN REFUGEE SETTLEMENTS AND HOST DISTRICTS IN WEST NILE AND NORTHERN UGANDA IN KIRYANDONGO DISTRICT


NYAKABAALE WATER SUPPLY SYSTEM

SARI CONSULTING LTD



DETAILED ENGINEERING DESIGN DRAWING TITLE TRANSMISSION 01 (0+600.00 - 1+200.00)

DRAWN Rodney Barugahare

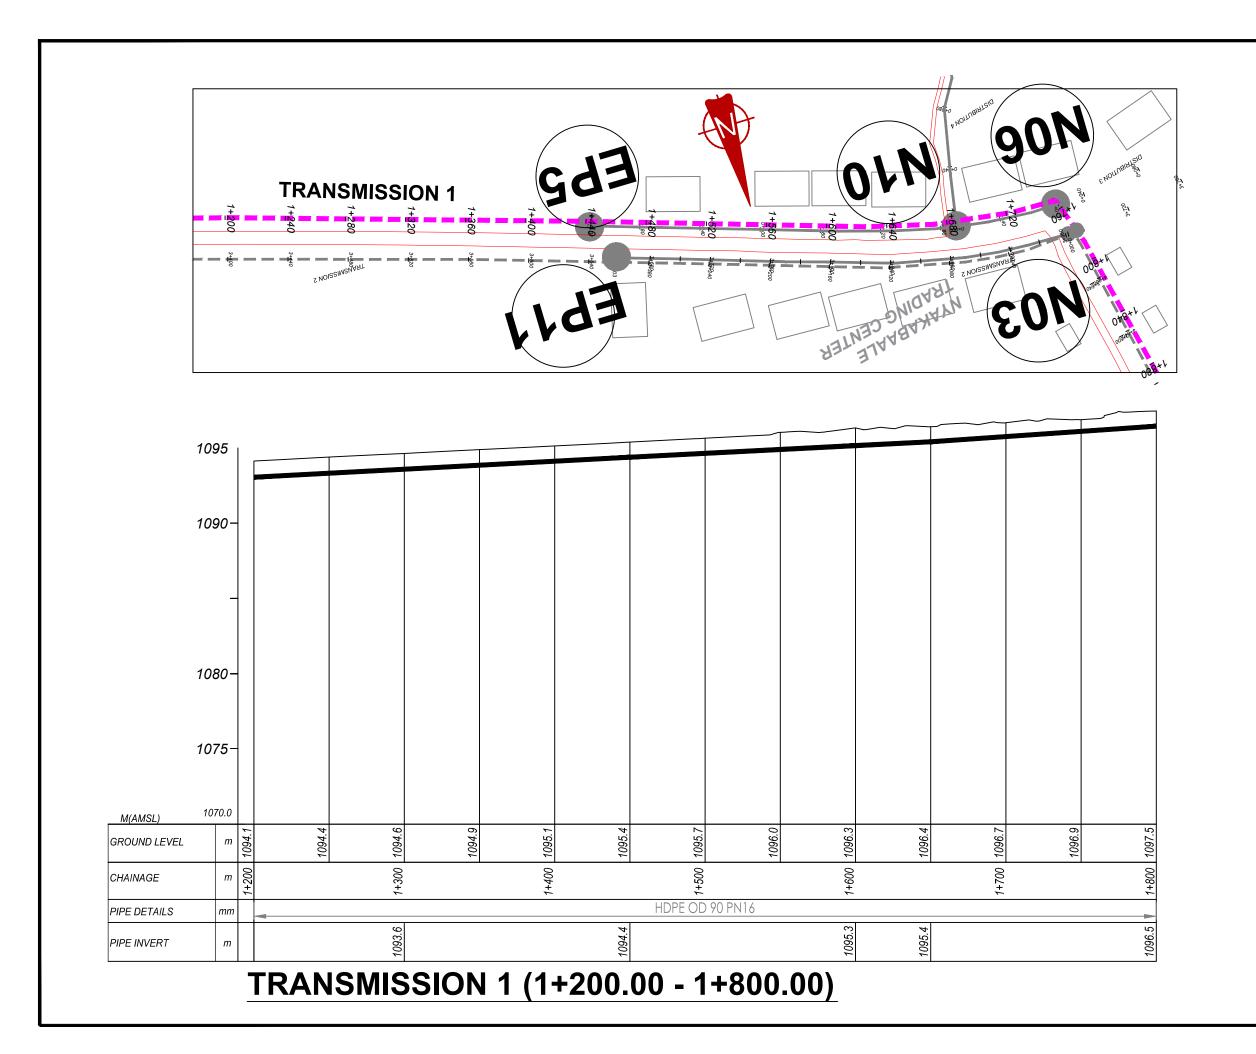

NOTES LEGEND Transmission Pipeline Distribution Pipeline Ground Level Building/House Contours Road DAV Double Orifice Air Valve End pipe Node N01 Washout Type1 WO-2 Washout Type2 **GOVERNMENT OF UGANDA** MINISTRY OF WATER AND CONSULTANCY SERVICES FOR FEASIBILITY STUDY, DETAILED ENGINEERING DESIGN AND CONSTRUCTION SUPERVISION OF SOLAR POWERED PIPED WATER SUPPLY SYSTEMS AND SANITATION FACILITIES IN REFUGEE SETTLEMENTS AND HOST DISTRICTS IN WEST NILE AND

NORTHERN UGANDA IN KIRYANDONGO DISTRICT


NYAKABAALE WATER SUPPLY SYSTEM


SARI CONSULTING LTD



DETAILED ENGINEERING DESIGN TRANSMISSION 01 (1+200.00 - 1+800.00)

DRAWING No. NYA/WS/2.1.3 DRAWN CHECKED Rodney Barugahare

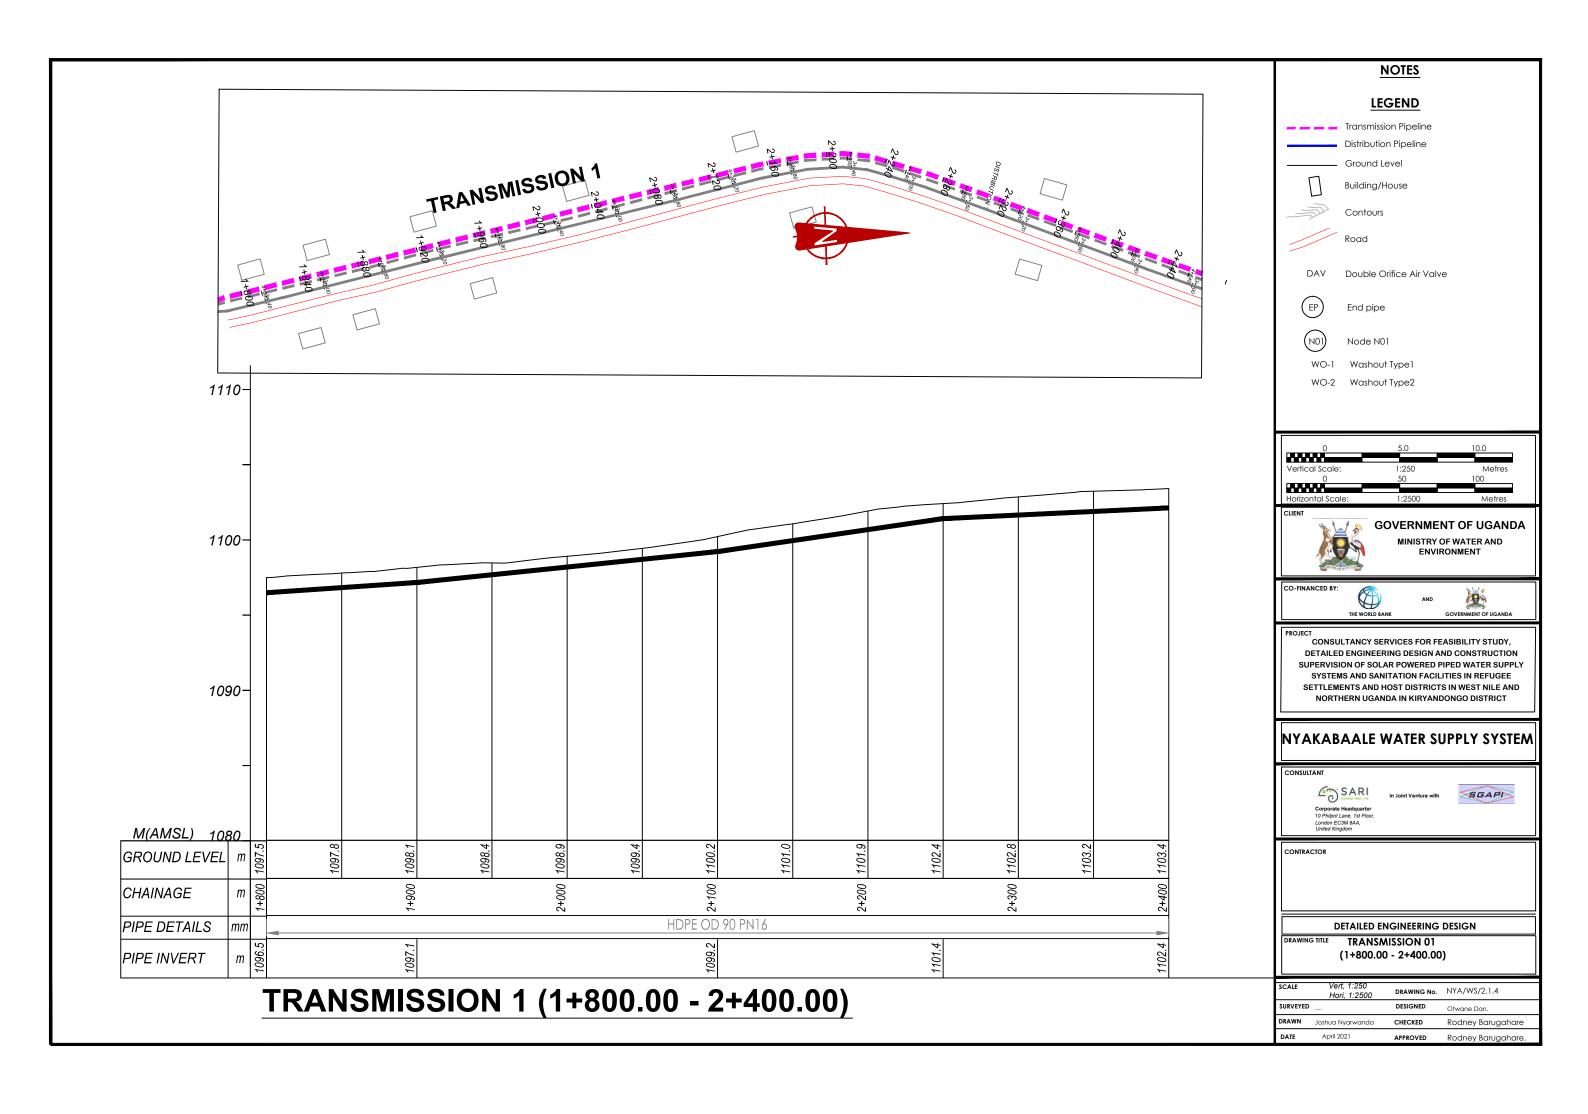

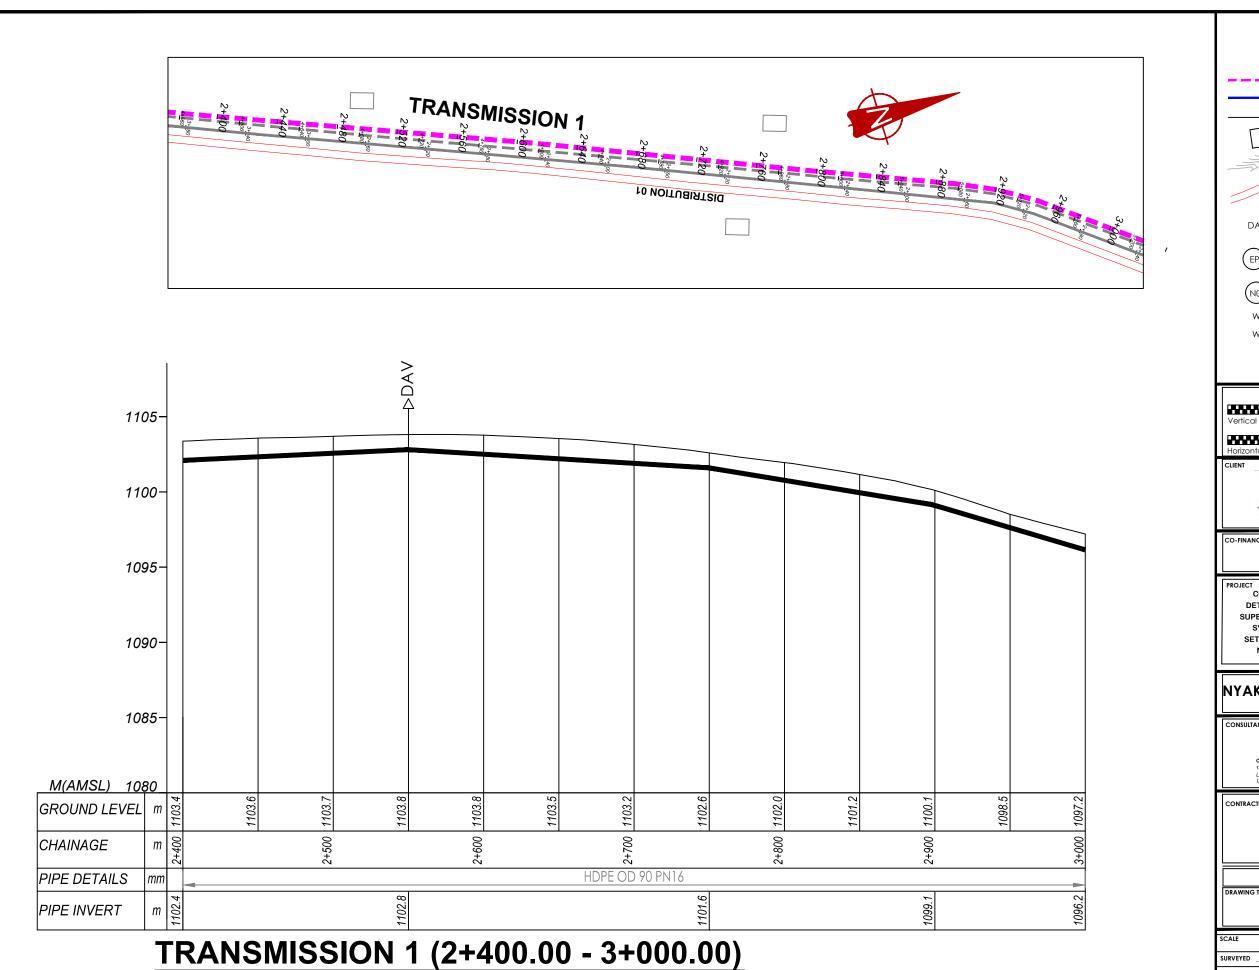


NOTES LEGEND Transmission Pipeline Distribution Pipeline Ground Level Building/House Contours Road DAV Double Orifice Air Valve End pipe Node N01 Washout Type1 WO-2 Washout Type2 **GOVERNMENT OF UGANDA** MINISTRY OF WATER AND ENVIRONMENT CONSULTANCY SERVICES FOR FEASIBILITY STUDY, DETAILED ENGINEERING DESIGN AND CONSTRUCTION SUPERVISION OF SOLAR POWERED PIPED WATER SUPPLY SYSTEMS AND SANITATION FACILITIES IN REFUGEE SETTLEMENTS AND HOST DISTRICTS IN WEST NILE AND NORTHERN UGANDA IN KIRYANDONGO DISTRICT NYAKABAALE WATER SUPPLY SYSTEM

SARI CONSULTING LTD

SGAPI

DETAILED ENGINEERING DESIGN DRAWING TITLE TRANSMISSION 01 (2+400.00 - 3+000.00)

SCALE	Vert, 1:250 Hori, 1:2500	DRAWING No.	NYA/WS/2.1.5
SURVEYED		DESIGNED	Otwane Dan.
DRAWN	Joshua Nyarwanda	CHECKED	Rodney Barugahare
DATE	April 2021	APPROVED	Rodney Barugahare.
DATE	April 2021	APPROVED	koaney Baruganare.

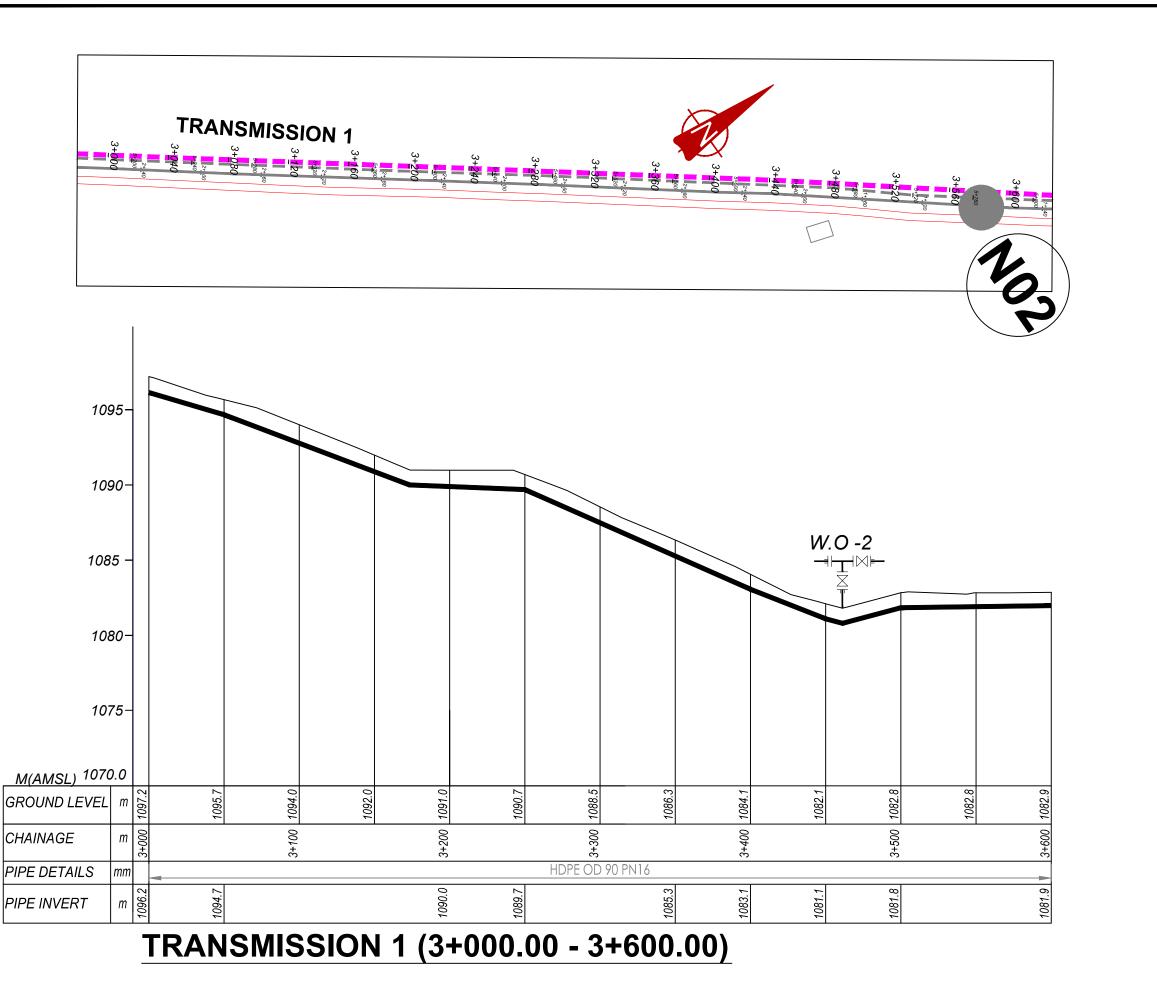

NOTES LEGEND Transmission Pipeline Distribution Pipeline Ground Level Building/House Contours Road DAV Double Orifice Air Valve End pipe Node N01 WO-1 Washout Type 1 WO-2 Washout Type2 **GOVERNMENT OF UGANDA** MINISTRY OF WATER AND ENVIRONMENT CONSULTANCY SERVICES FOR FEASIBILITY STUDY, DETAILED ENGINEERING DESIGN AND CONSTRUCTION

SUPERVISION OF SOLAR POWERED PIPED WATER SUPPLY SYSTEMS AND SANITATION FACILITIES IN REFUGEE SETTLEMENTS AND HOST DISTRICTS IN WEST NILE AND NORTHERN UGANDA IN KIRYANDONGO DISTRICT

NYAKABAALE WATER SUPPLY SYSTEM

Corporate Headquarter
10 Philipot Lane, 1st Floor,
London EC3M BAA,
United Kingdom

n Joint Venture with





CONTRACTO

DETAILED ENGINEERING DESIGN


TRANSMISSION 01
(3+000.00 - 3+600.00)

_			
SCALE	Vert, 1:250 Hori, 1:2500	DRAWING No.	NYA/WS/2.1.6
SURVEYED	·	DESIGNED	Otwane Dan.
DRAWN	Joshua Nyarwanda	CHECKED	Rodney Barugahare
DATE	April 2021	APPROVED	Rodney Barugahare.

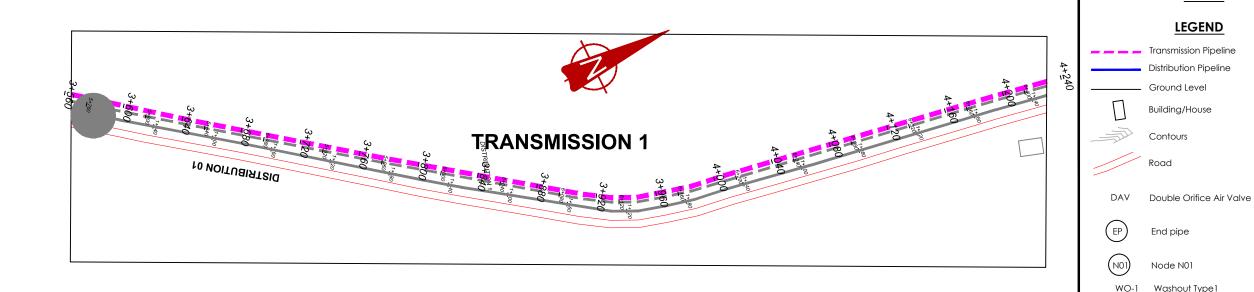

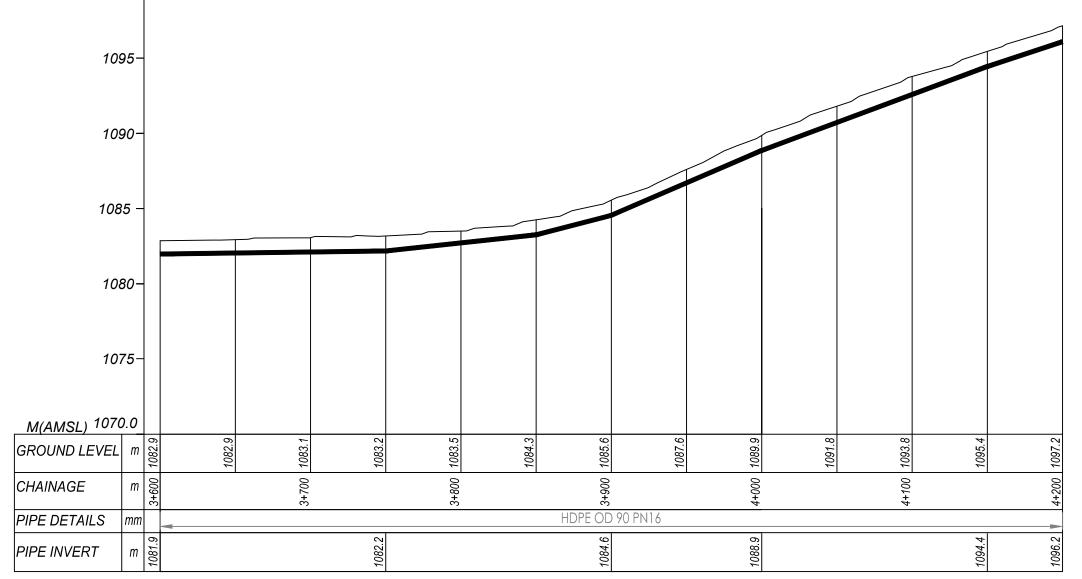

TRANSMISSION 1 (3+600.00 - 4+200.00)

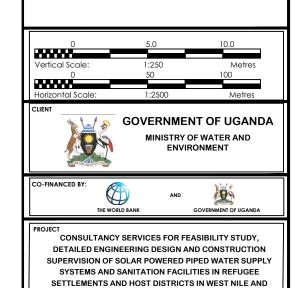

NOTES

LEGEND

Ground Level Building/House

Contours

End pipe

Node N01 Washout Type1 WO-2 Washout Type2





NORTHERN UGANDA IN KIRYANDONGO DISTRICT



DETAILED ENGINEERING DESIGN			
DRAWING TITLE	TRANSMISSION 01		
	(3+600.00 - 4+200.00)		

SCALE	Vert, 1:250 Hori, 1:2500	DRAWING No.	NYA/WS/2.1.7
SURVEYED		DESIGNED	Otwane Dan.
DRAWN	Joshua Nyarwanda	CHECKED	Rodney Barugahare
DATE	April 2021	APPROVED	Rodney Barugahare.

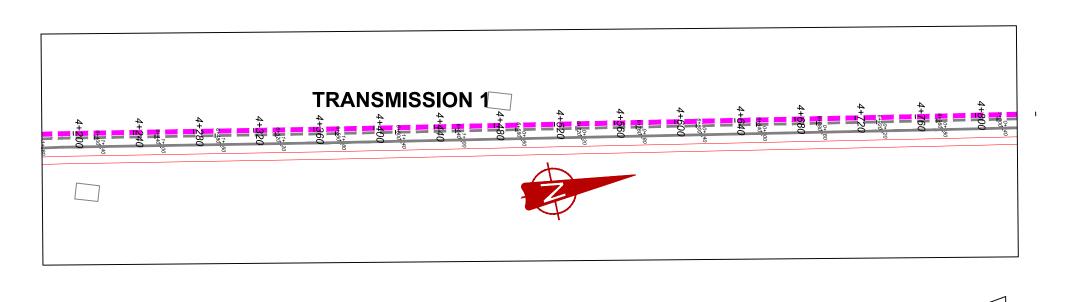

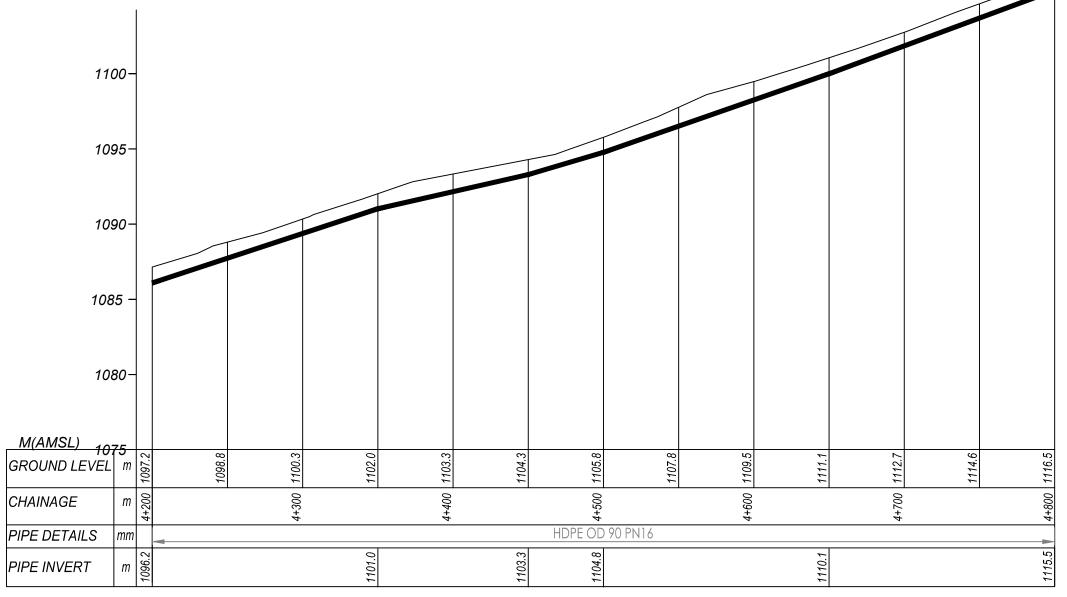

TRANSMISSION 1 (4+200.00 - 4+800.00)

NOTES LEGEND Transmission Pipeline Distribution Pipeline Ground Level Building/House Contours Road DAV Double Orifice Air Valve End pipe Node N01 WO-1 Washout Type 1 WO-2 Washout Type2 **GOVERNMENT OF UGANDA** MINISTRY OF WATER AND

-FINANCED BY:



CONSULTANCY SERVICES FOR FEASIBILITY STUDY,
DETAILED ENGINEERING DESIGN AND CONSTRUCTION
SUPERVISION OF SOLAR POWERED PIPED WATER SUPPLY
SYSTEMS AND SANITATION FACILITIES IN REFUGEE
SETTLEMENTS AND HOST DISTRICTS IN WEST NILE AND
NORTHERN UGANDA IN KIRYANDONGO DISTRICT

NYAKABAALE WATER SUPPLY SYSTEM

Corporate Headquarter
10 Philipot Lane, 1st Floor,

In Joint Venture with



DETAILED ENGINEERING DESIGN


TRANSMISSION 01
(4+200.00 - 4+800.00)


 SCALE
 Vert, 1:250 Hori, 1:2500
 DRAWING No.
 NYA/WS/2.1.8


 SURVEYED
 DESIGNED
 Otwane Dan.

 DRAWN
 Joshua Nyarwanda
 CHECKED
 Rodney Barugahare


 DATE
 April 2021
 Approved
 Rodney Barugahare.

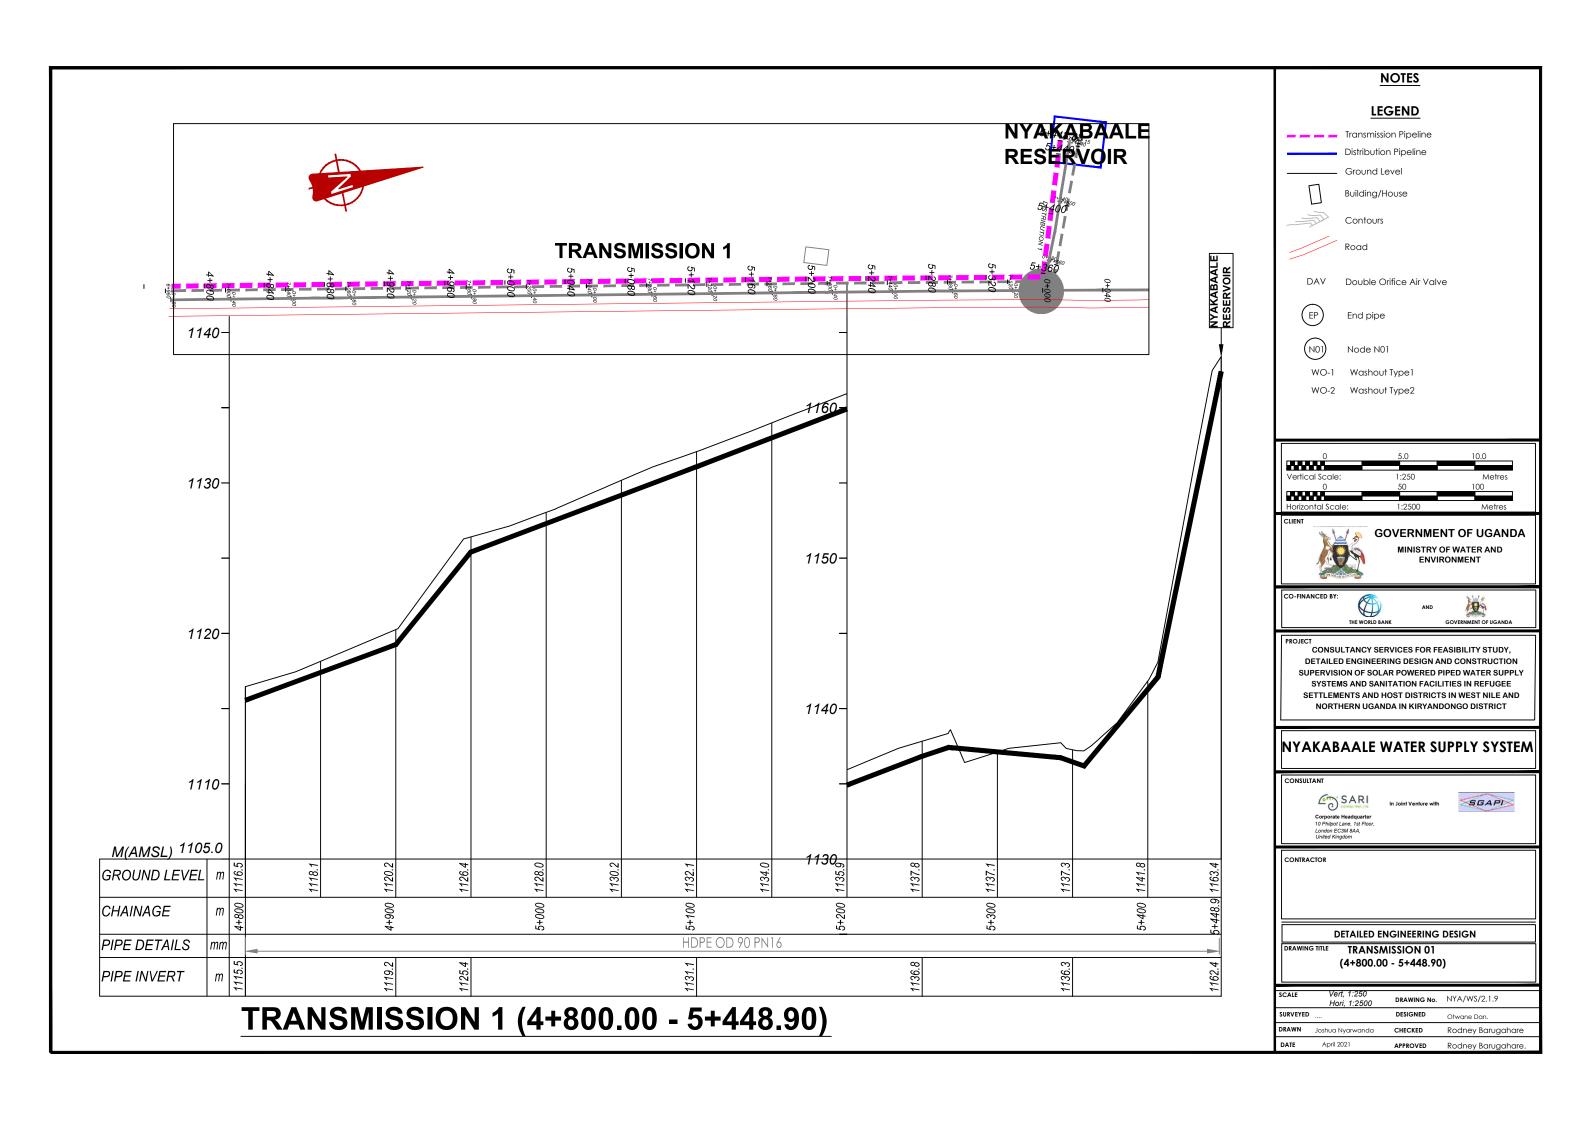

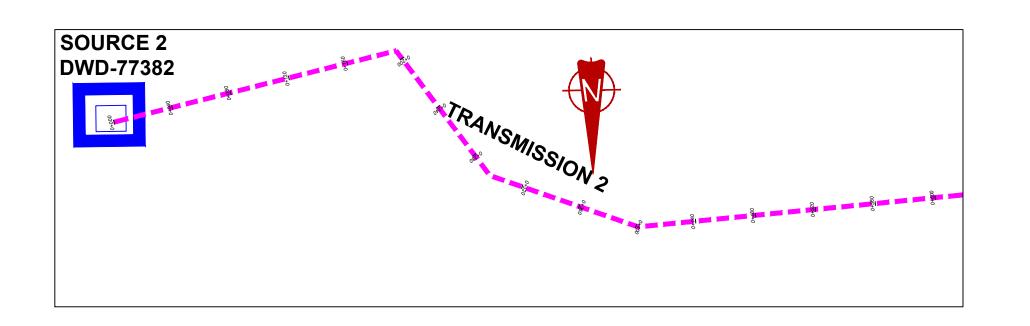

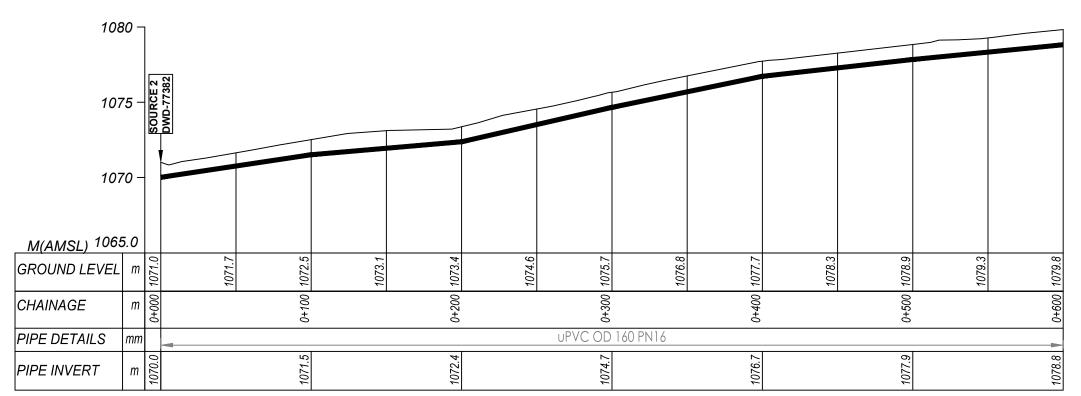



TRANSMISSION 2 (0+000.00 - 0+600.00)

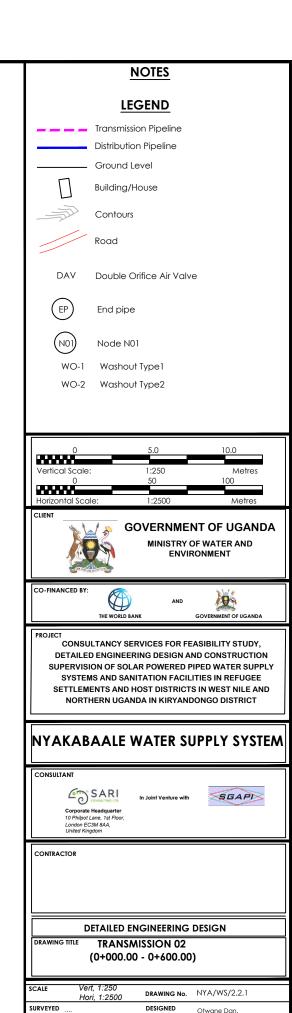



Rodney Barugahare

DRAWN

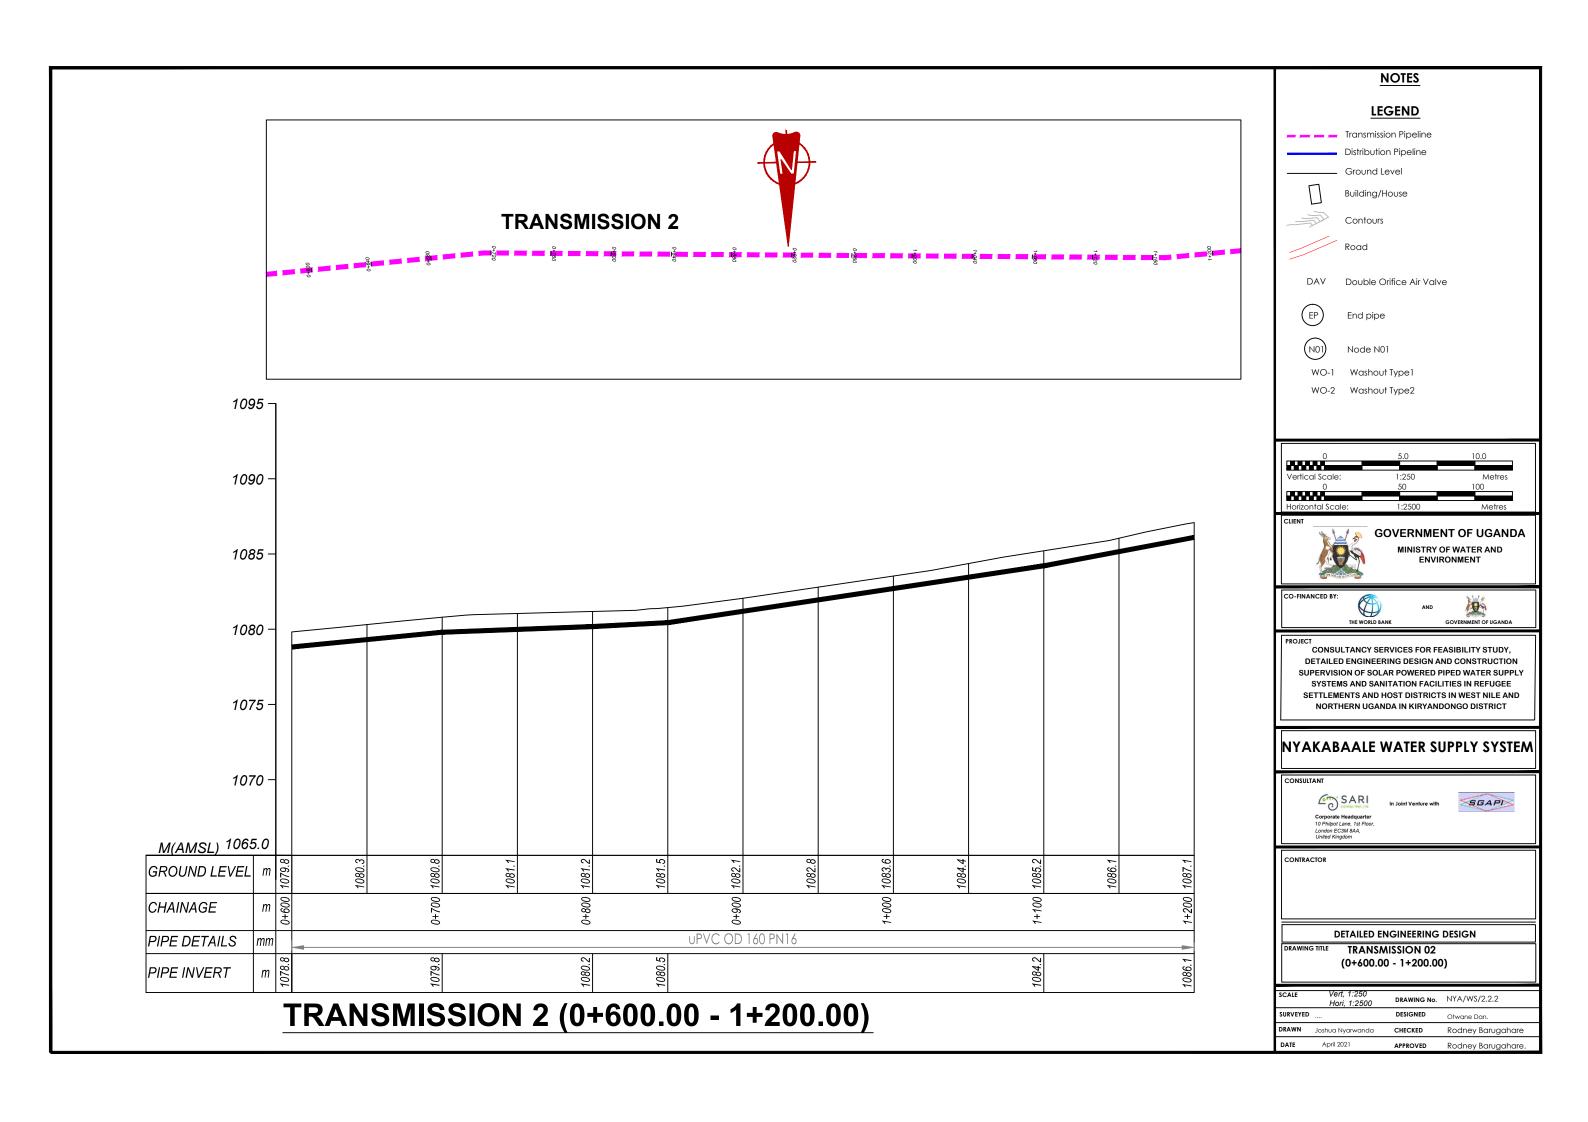

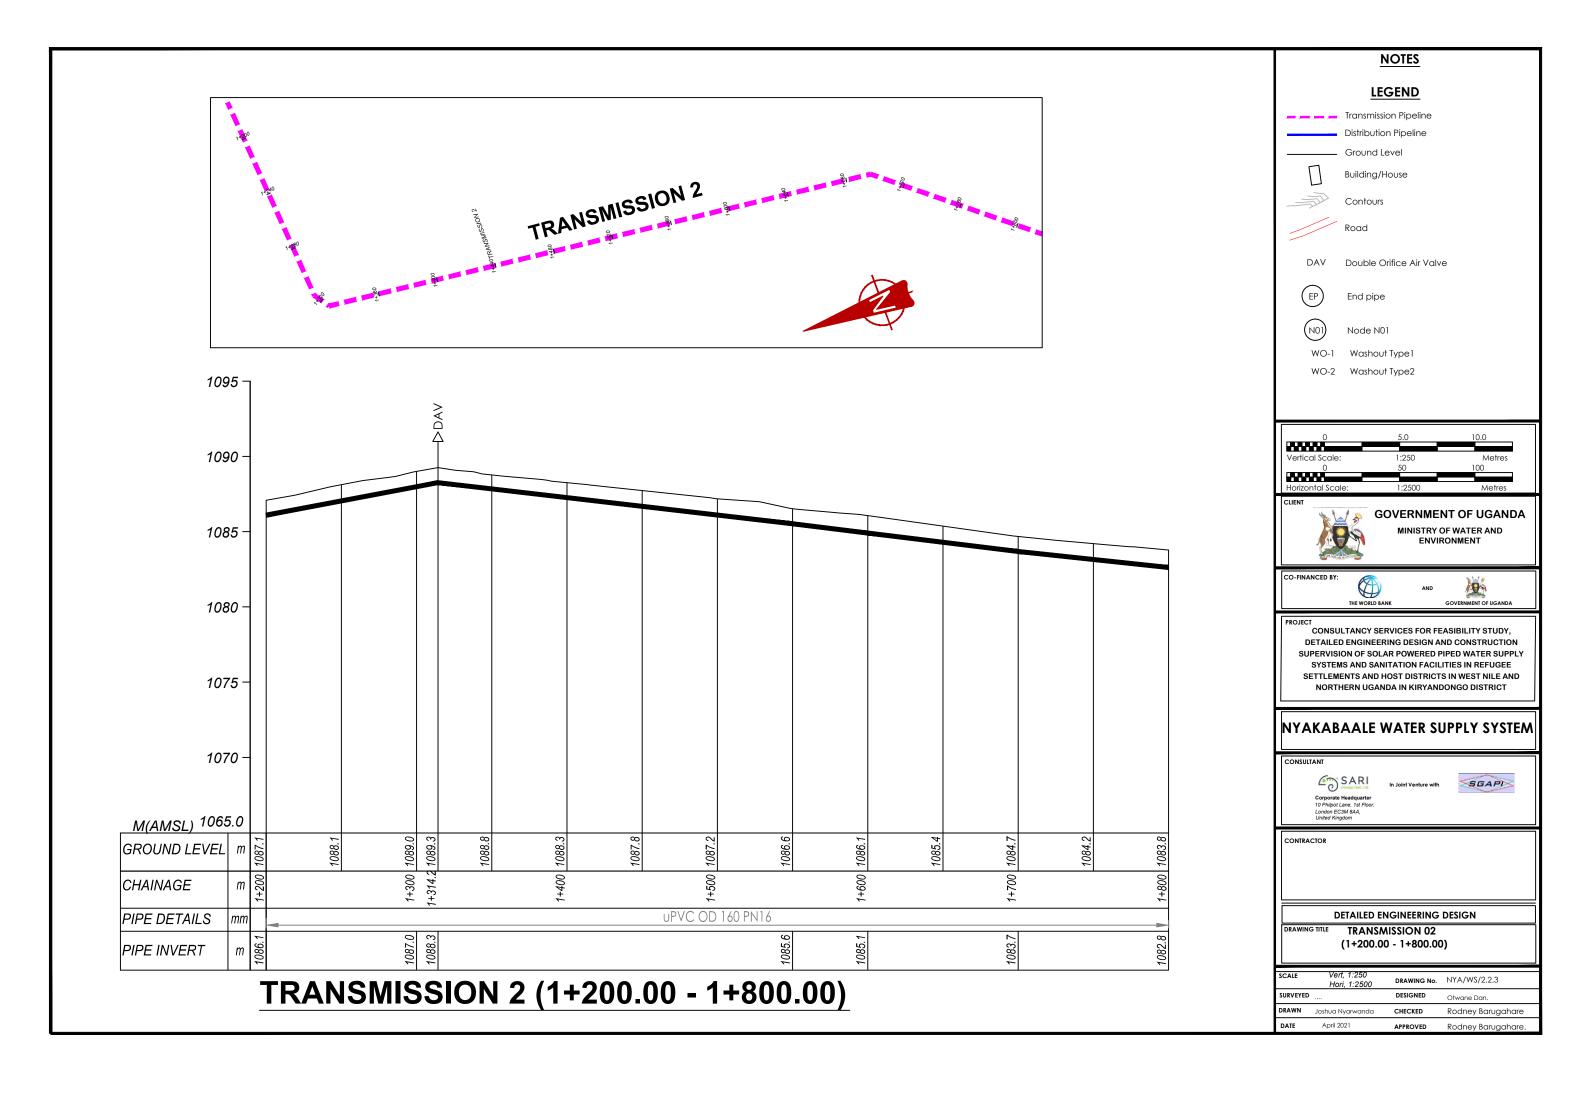

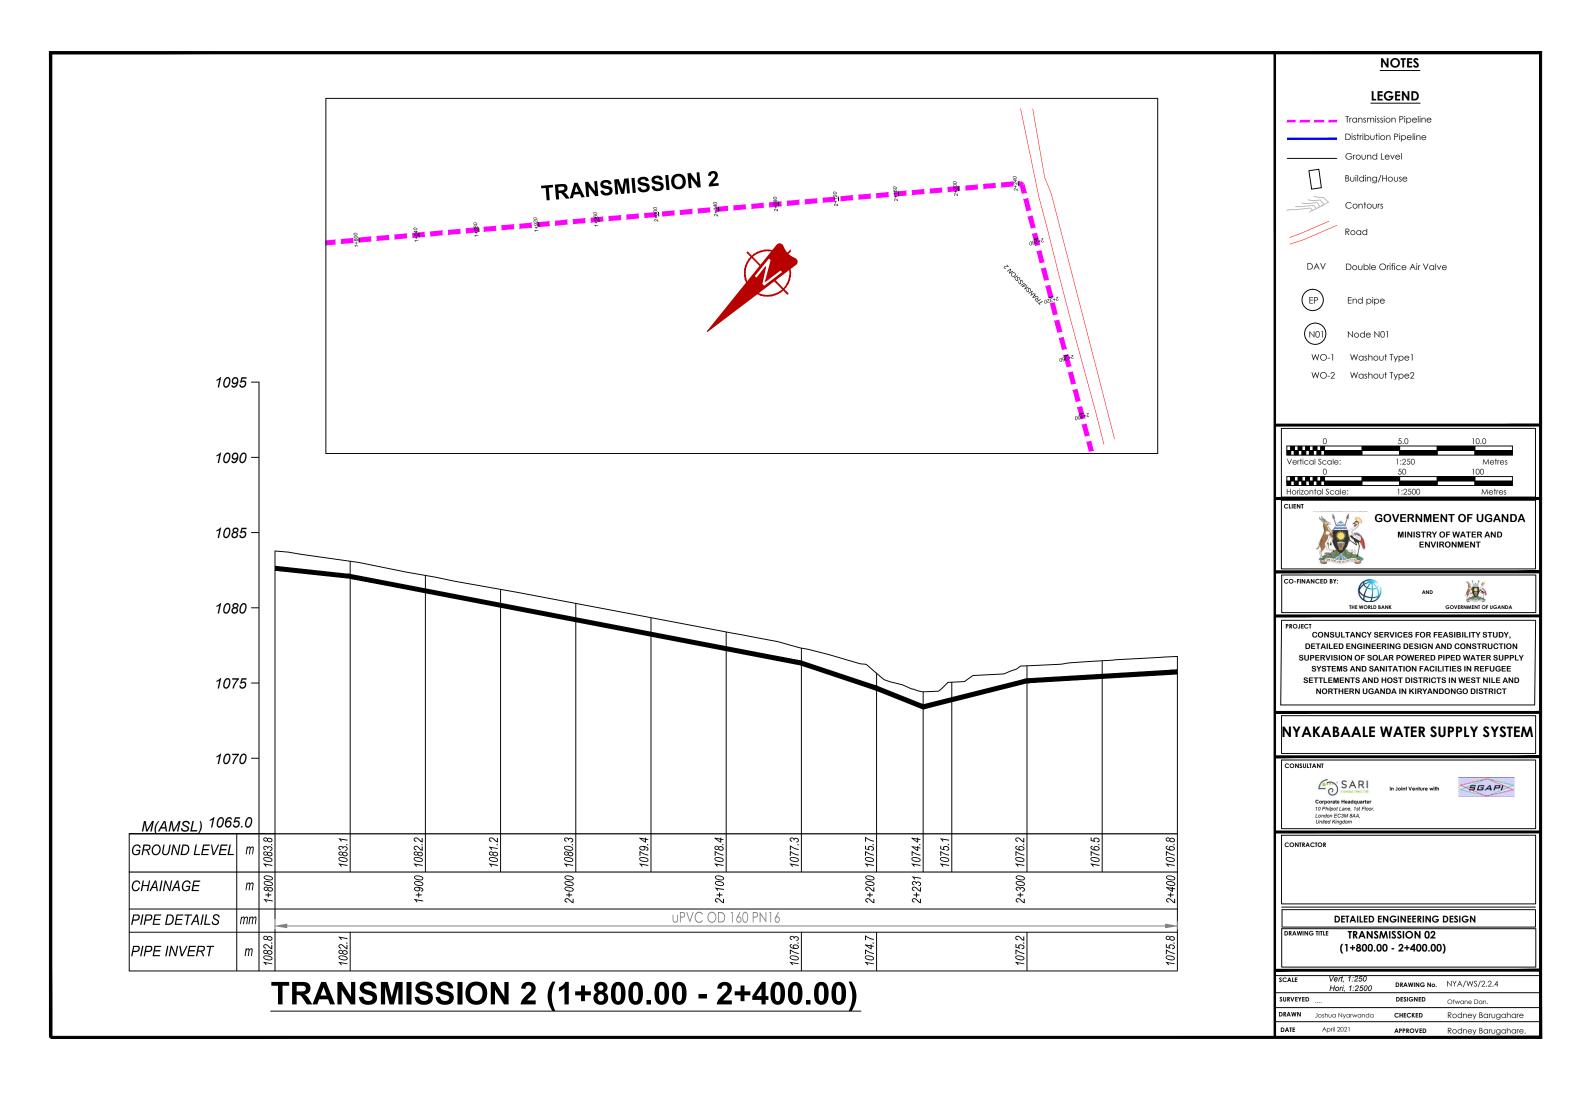


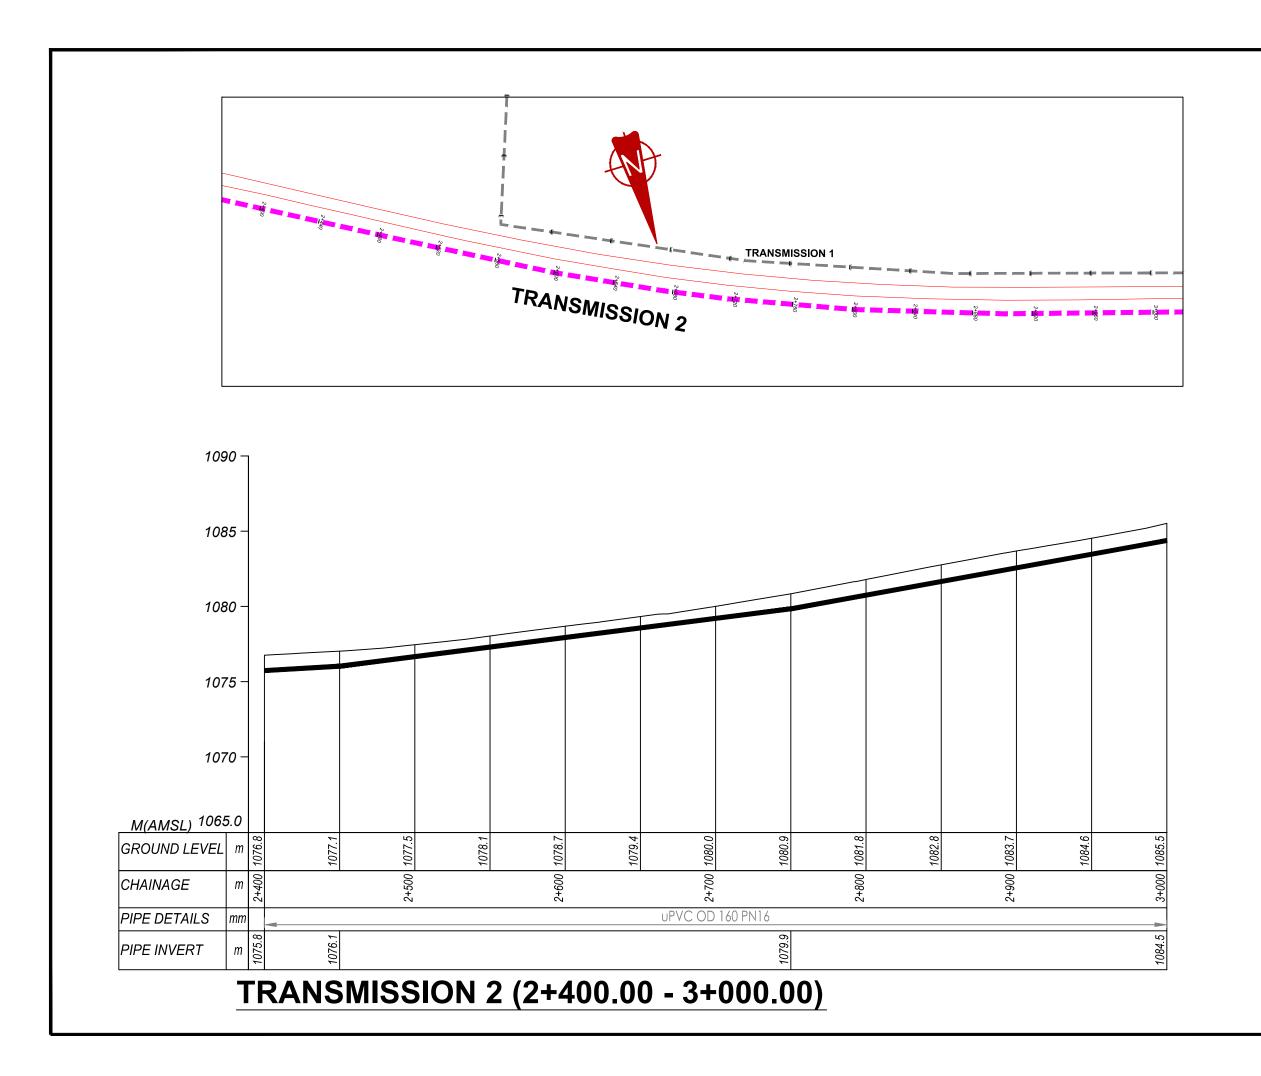


NOTES LEGEND Transmission Pipeline Ground Level Building/House Contours DAV Double Orifice Air Valve End pipe Node N01 WO-1 Washout Type 1 WO-2 Washout Type2 **GOVERNMENT OF UGANDA** MINISTRY OF WATER AND CONSULTANCY SERVICES FOR FEASIBILITY STUDY, DETAILED ENGINEERING DESIGN AND CONSTRUCTION SUPERVISION OF SOLAR POWERED PIPED WATER SUPPLY SETTLEMENTS AND HOST DISTRICTS IN WEST NILE AND NYAKABAALE WATER SUPPLY SYSTEM SARI CONSULTING LTD SGAPI

DETAILED ENGINEERING DESIGN DRAWING TITLE TRANSMISSION 02 (2+400.00 - 3+000.00)


SCALE	Vert, 1:250 Hori, 1:2500	DRAWING No.	NYA/WS/2.2.5
SURVEYED	·	DESIGNED	Otwane Dan.
DRAWN	Joshua Nyarwanda	CHECKED	Rodney Barugahare
DATE	April 2021	APPROVED	Rodney Barugahare.

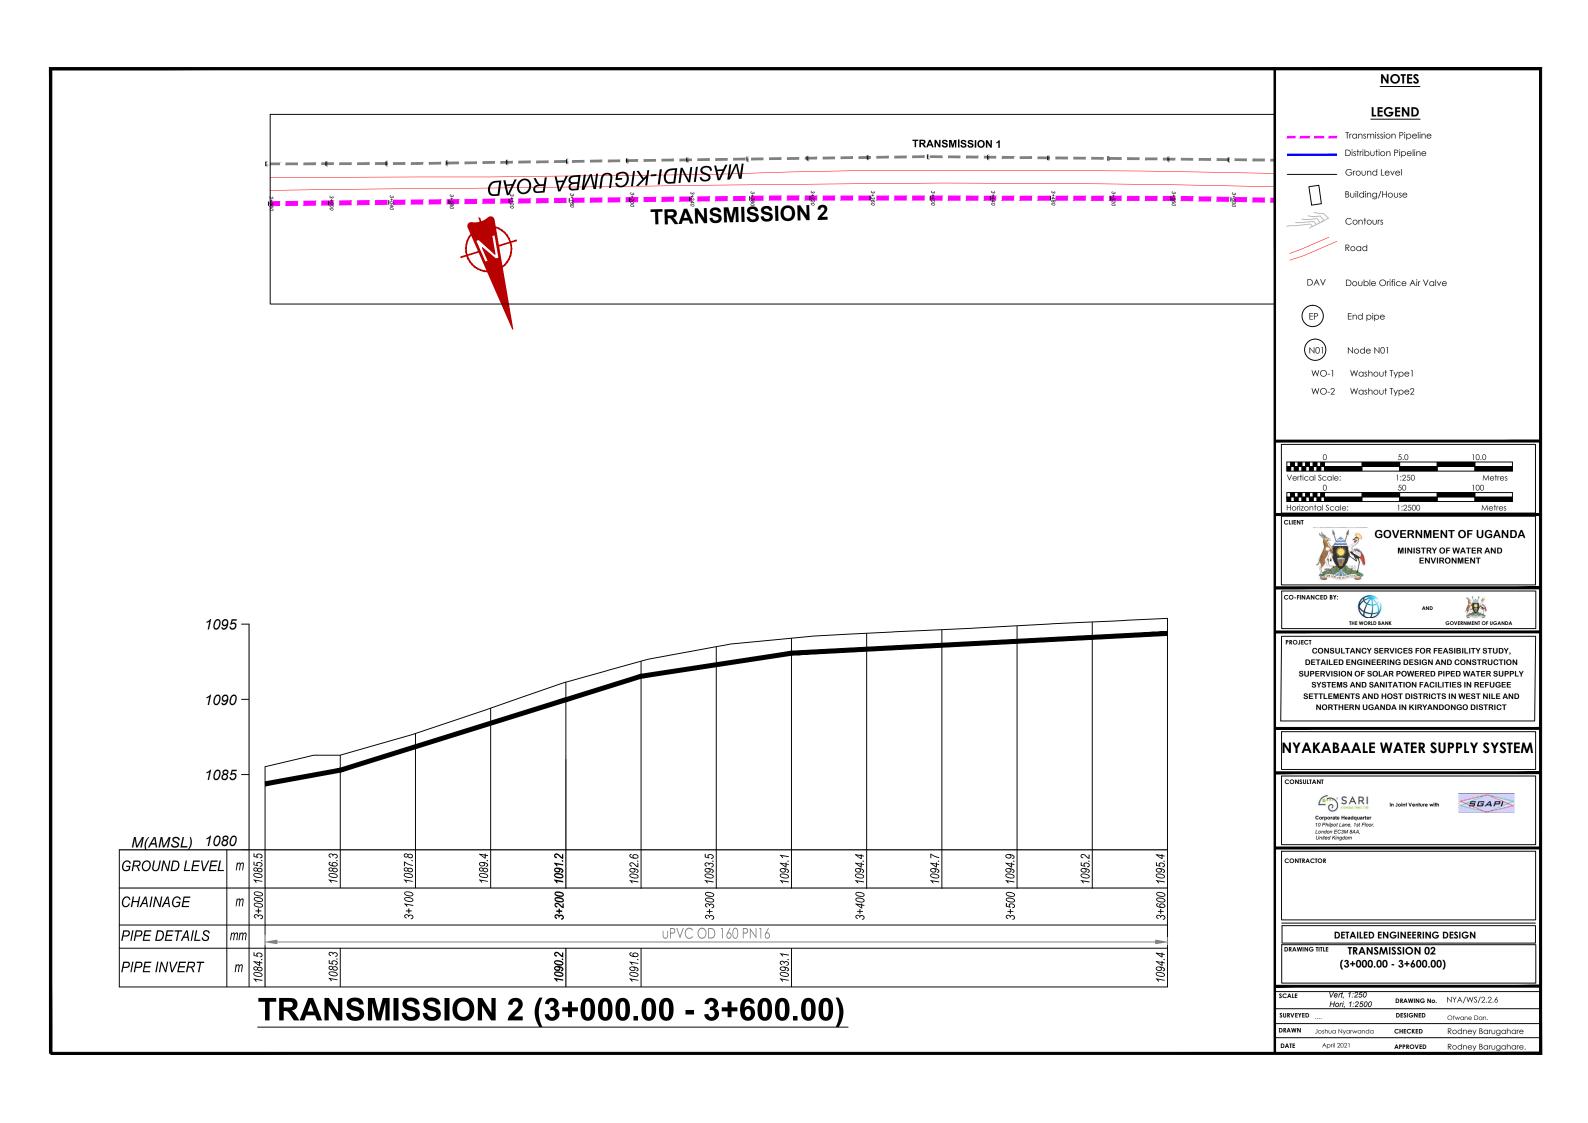


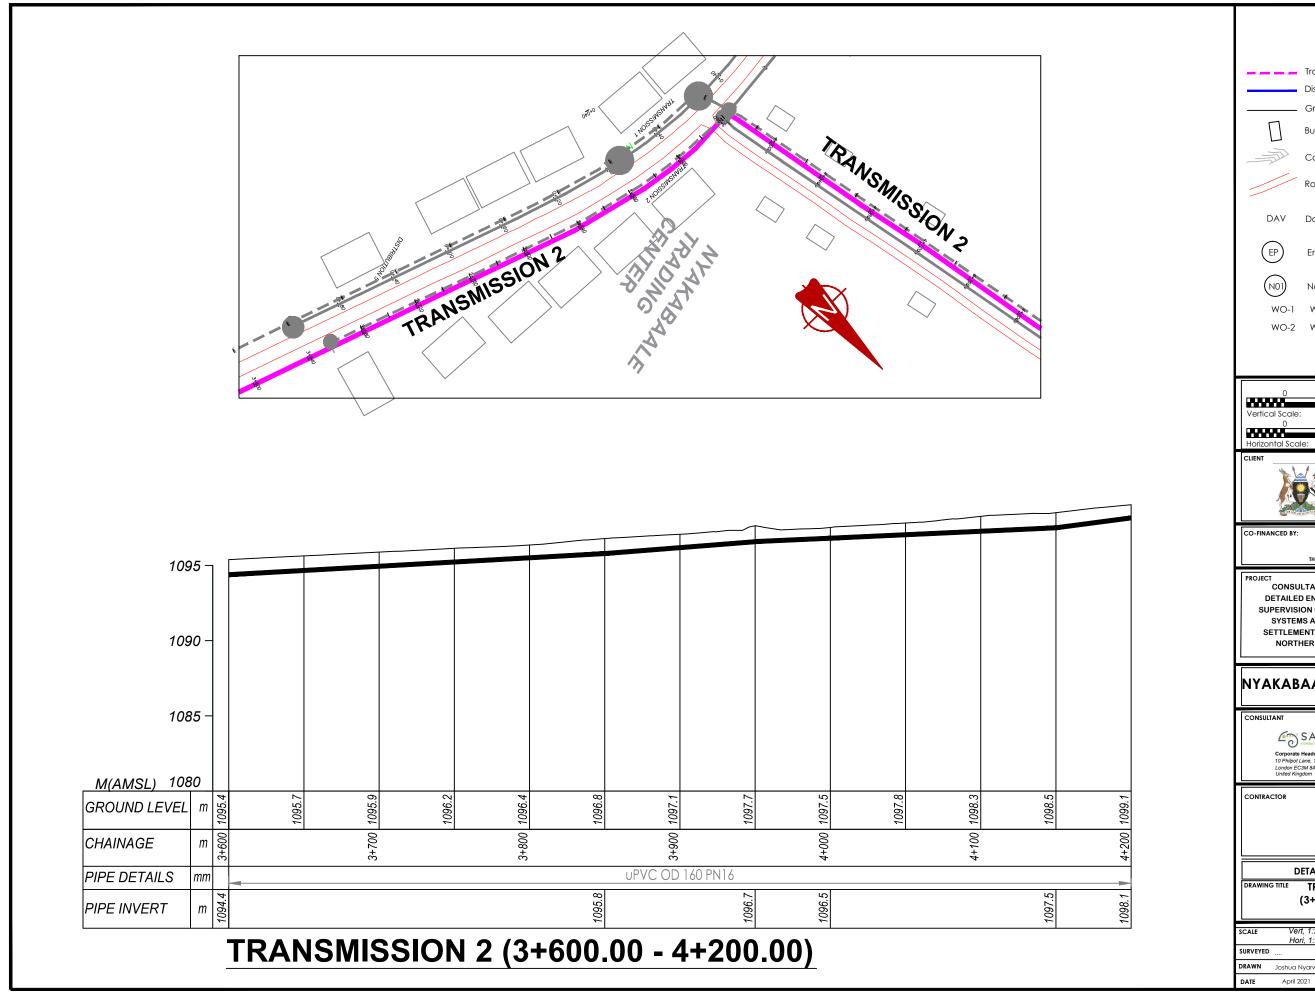


NOTES LEGEND 💶 💻 Transmission Pipeline Distribution Pipeline Ground Level Building/House Contours DAV Double Orifice Air Valve End pipe Node N01 WO-1 Washout Type 1 WO-2 Washout Type2 **GOVERNMENT OF UGANDA** MINISTRY OF WATER AND CONSULTANCY SERVICES FOR FEASIBILITY STUDY, DETAILED ENGINEERING DESIGN AND CONSTRUCTION SUPERVISION OF SOLAR POWERED PIPED WATER SUPPLY SYSTEMS AND SANITATION FACILITIES IN REFUGEE SETTLEMENTS AND HOST DISTRICTS IN WEST NILE AND NORTHERN UGANDA IN KIRYANDONGO DISTRICT NYAKABAALE WATER SUPPLY SYSTEM SARI CONSULTING LTD SGAPI DETAILED ENGINEERING DESIGN TRANSMISSION 02 (3+600.00 - 4+200.00)

Rodney Barugahare

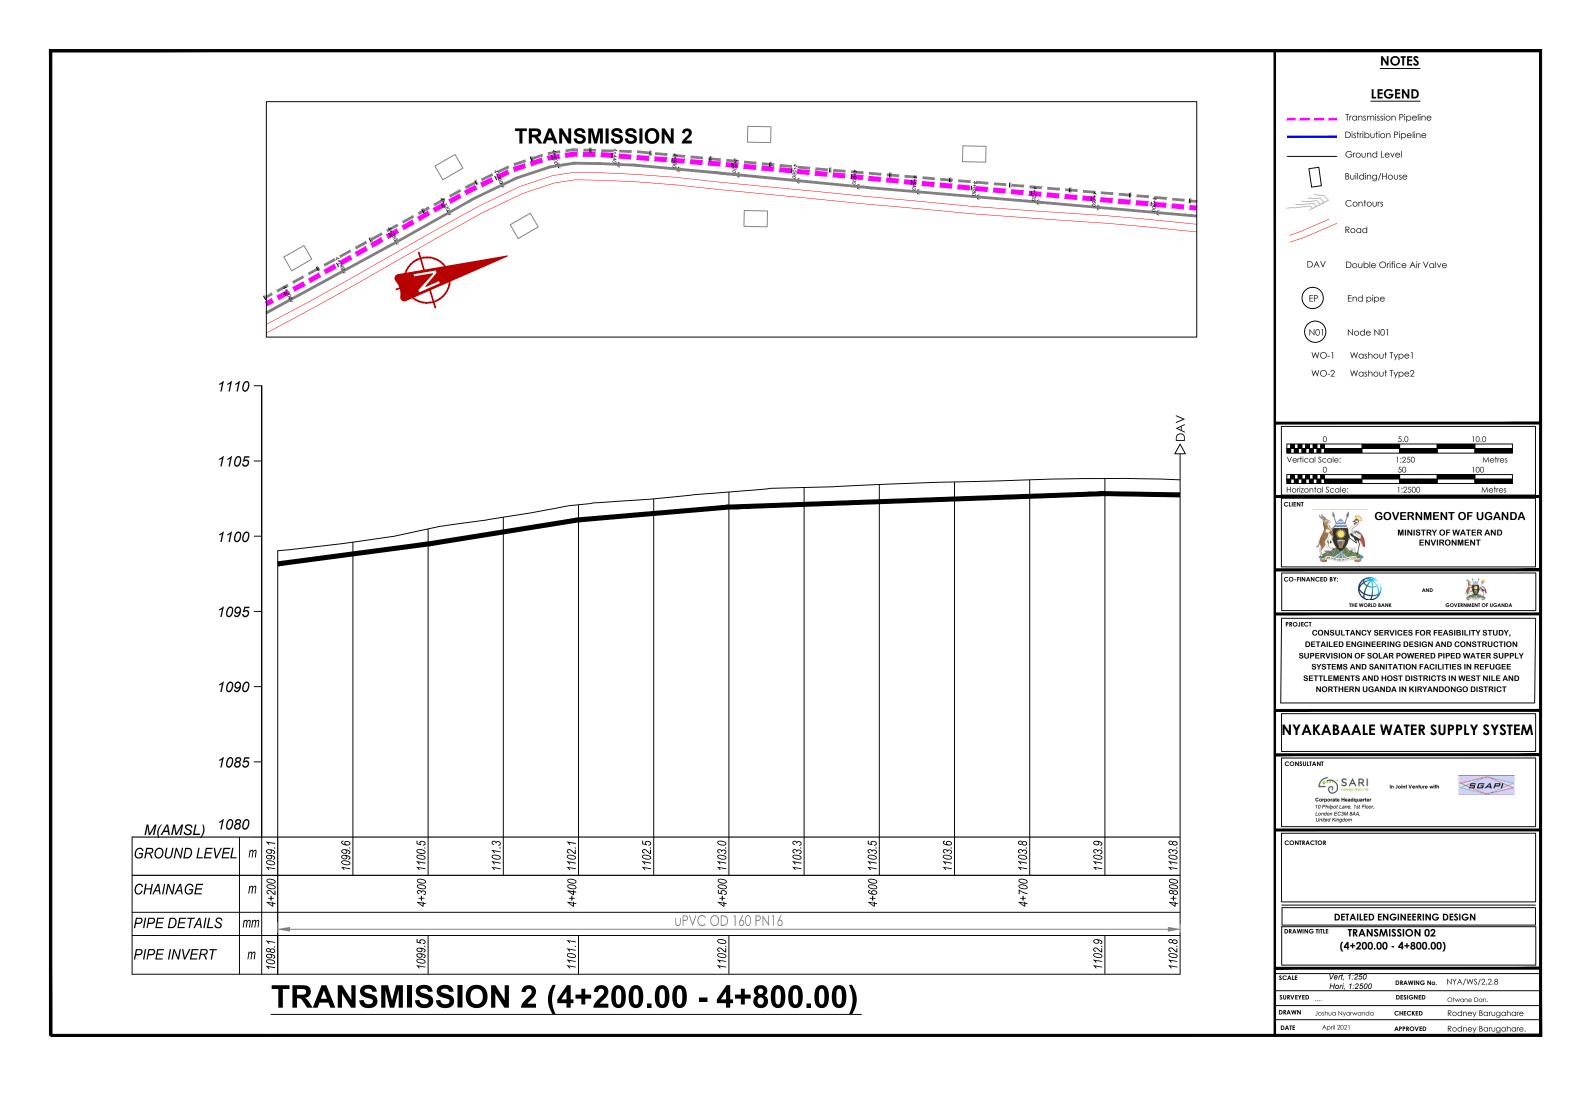

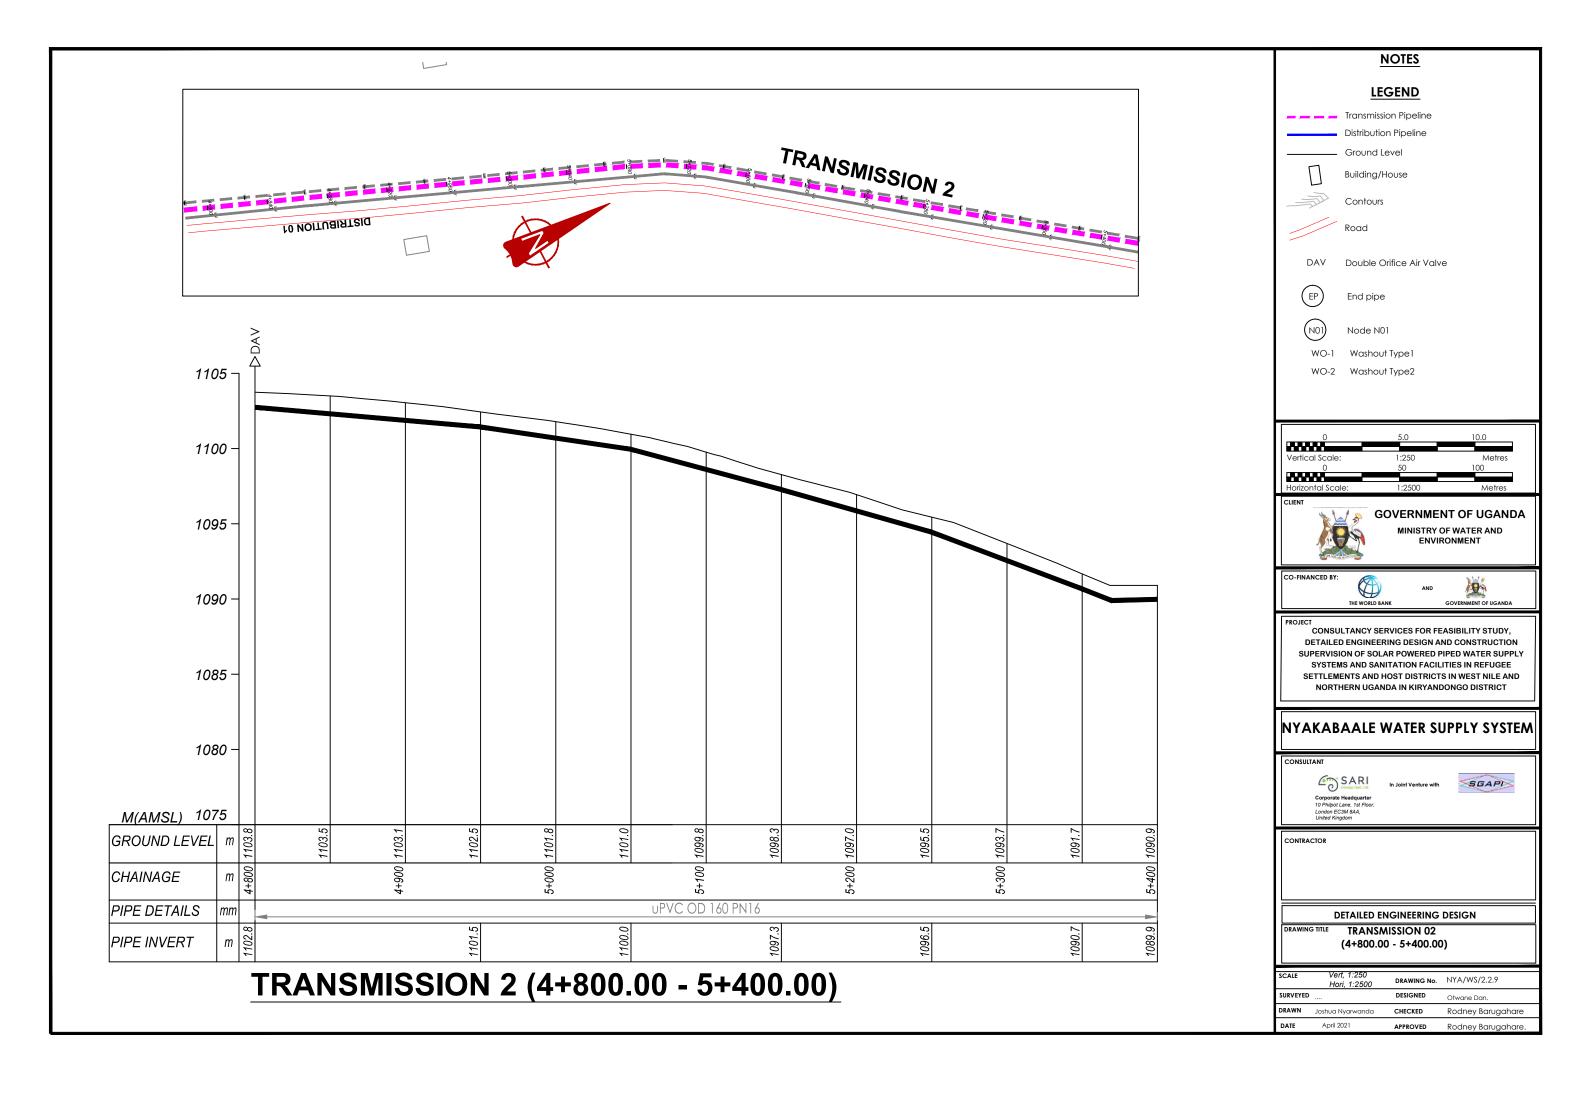

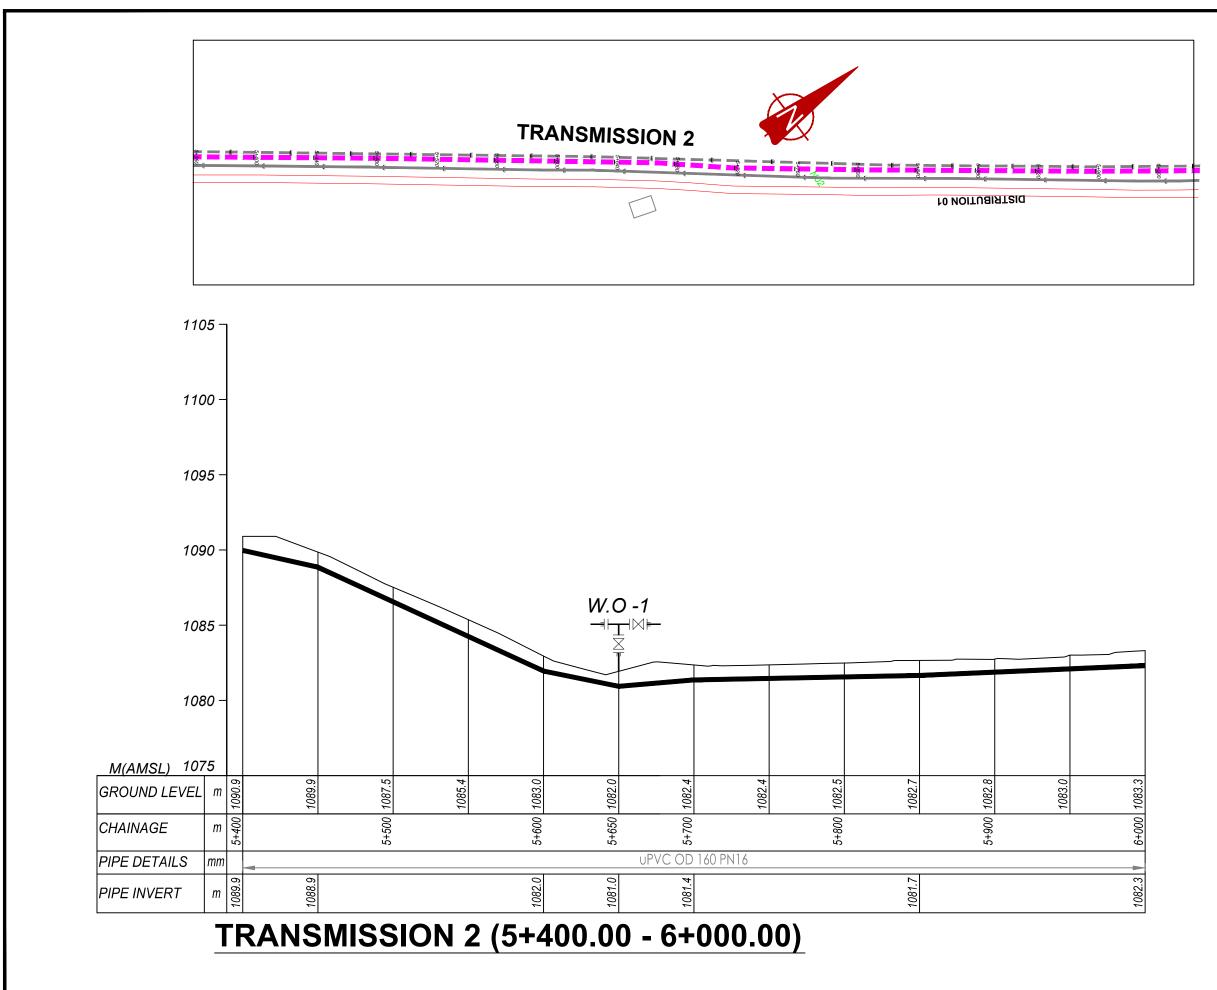

NOTES LEGEND Transmission Pipeline Distribution Pipeline Ground Level Building/House Contours Road DAV Double Orifice Air Valve End pipe Node N01 WO-1 Washout Type 1 WO-2 Washout Type2 **GOVERNMENT OF UGANDA** MINISTRY OF WATER AND ENVIRONMENT CONSULTANCY SERVICES FOR FEASIBILITY STUDY, DETAILED ENGINEERING DESIGN AND CONSTRUCTION SUPERVISION OF SOLAR POWERED PIPED WATER SUPPLY SYSTEMS AND SANITATION FACILITIES IN REFUGEE SETTLEMENTS AND HOST DISTRICTS IN WEST NILE AND NORTHERN UGANDA IN KIRYANDONGO DISTRICT

NYAKABAALE WATER SUPPLY SYSTEM



In Joint Venture with





CONTRACTO


DETAILED ENGINEERING DESIGN


TRANSMISSION 02 (5+400.00 - 6+000.00)


SCALE	Vert, 1:250 Hori, 1:2500	DRAWING No.	NYA/WS/2.2.10
SURVEYED		DESIGNED	Otwane Dan.
DRAWN	Joshua Nyarwanda	CHECKED	Rodney Barugahare
DATE	April 2021	APPROVED	Rodney Barugahare.

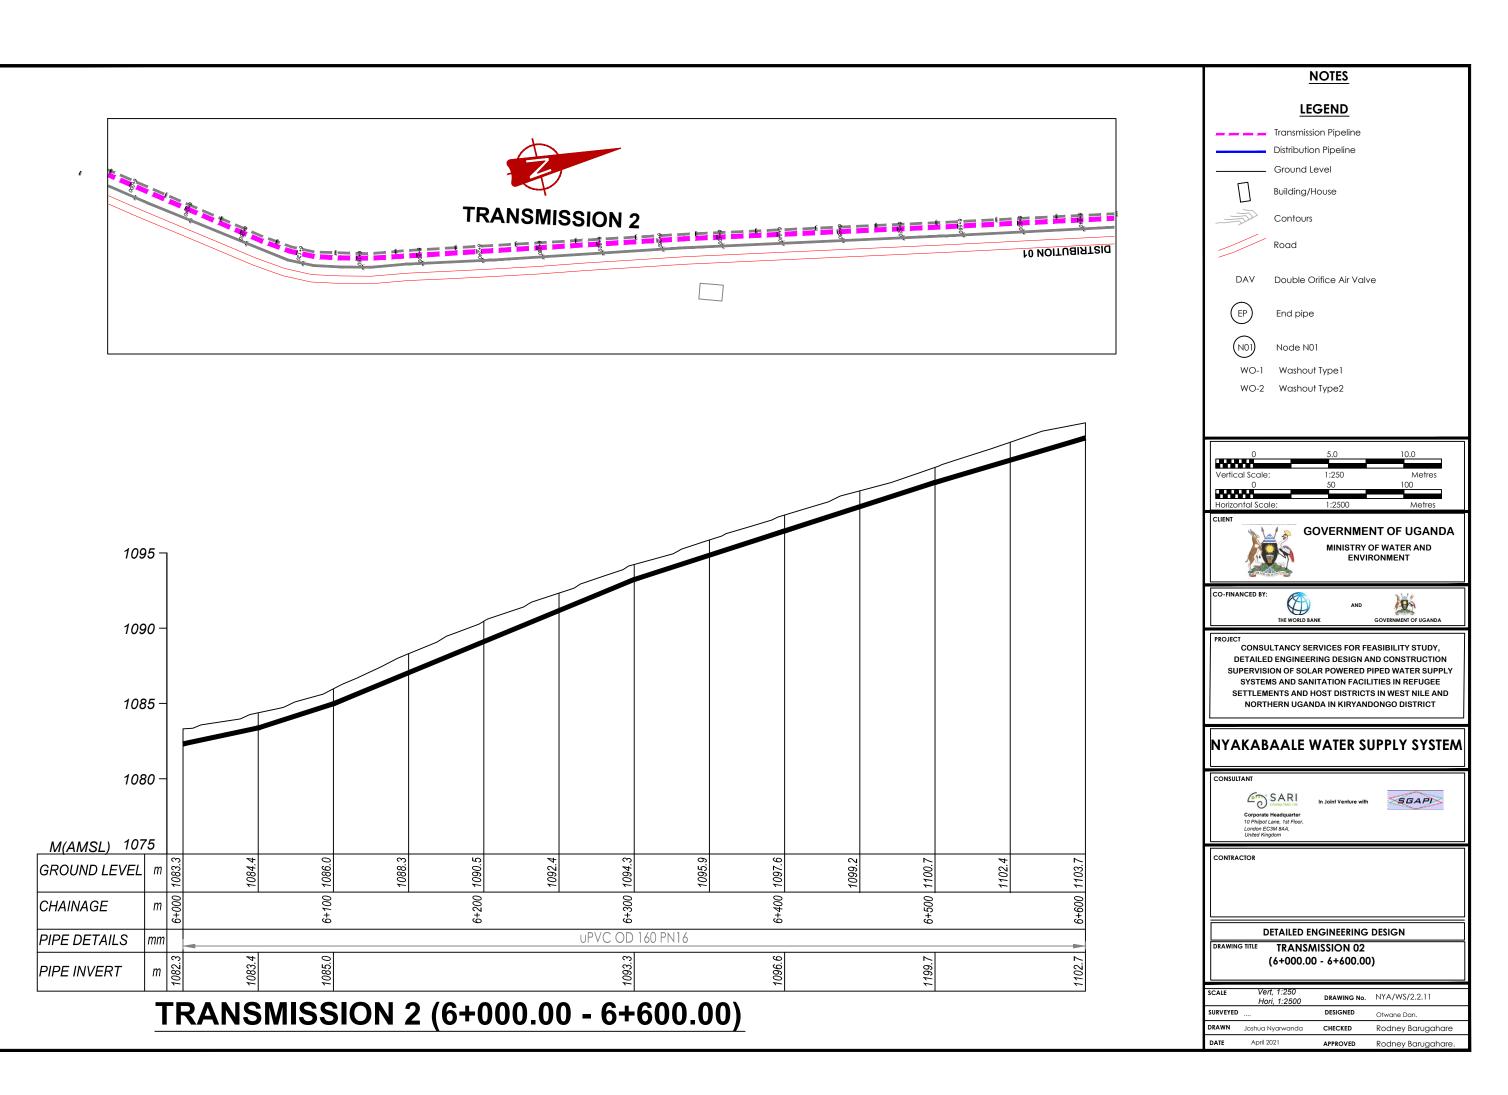


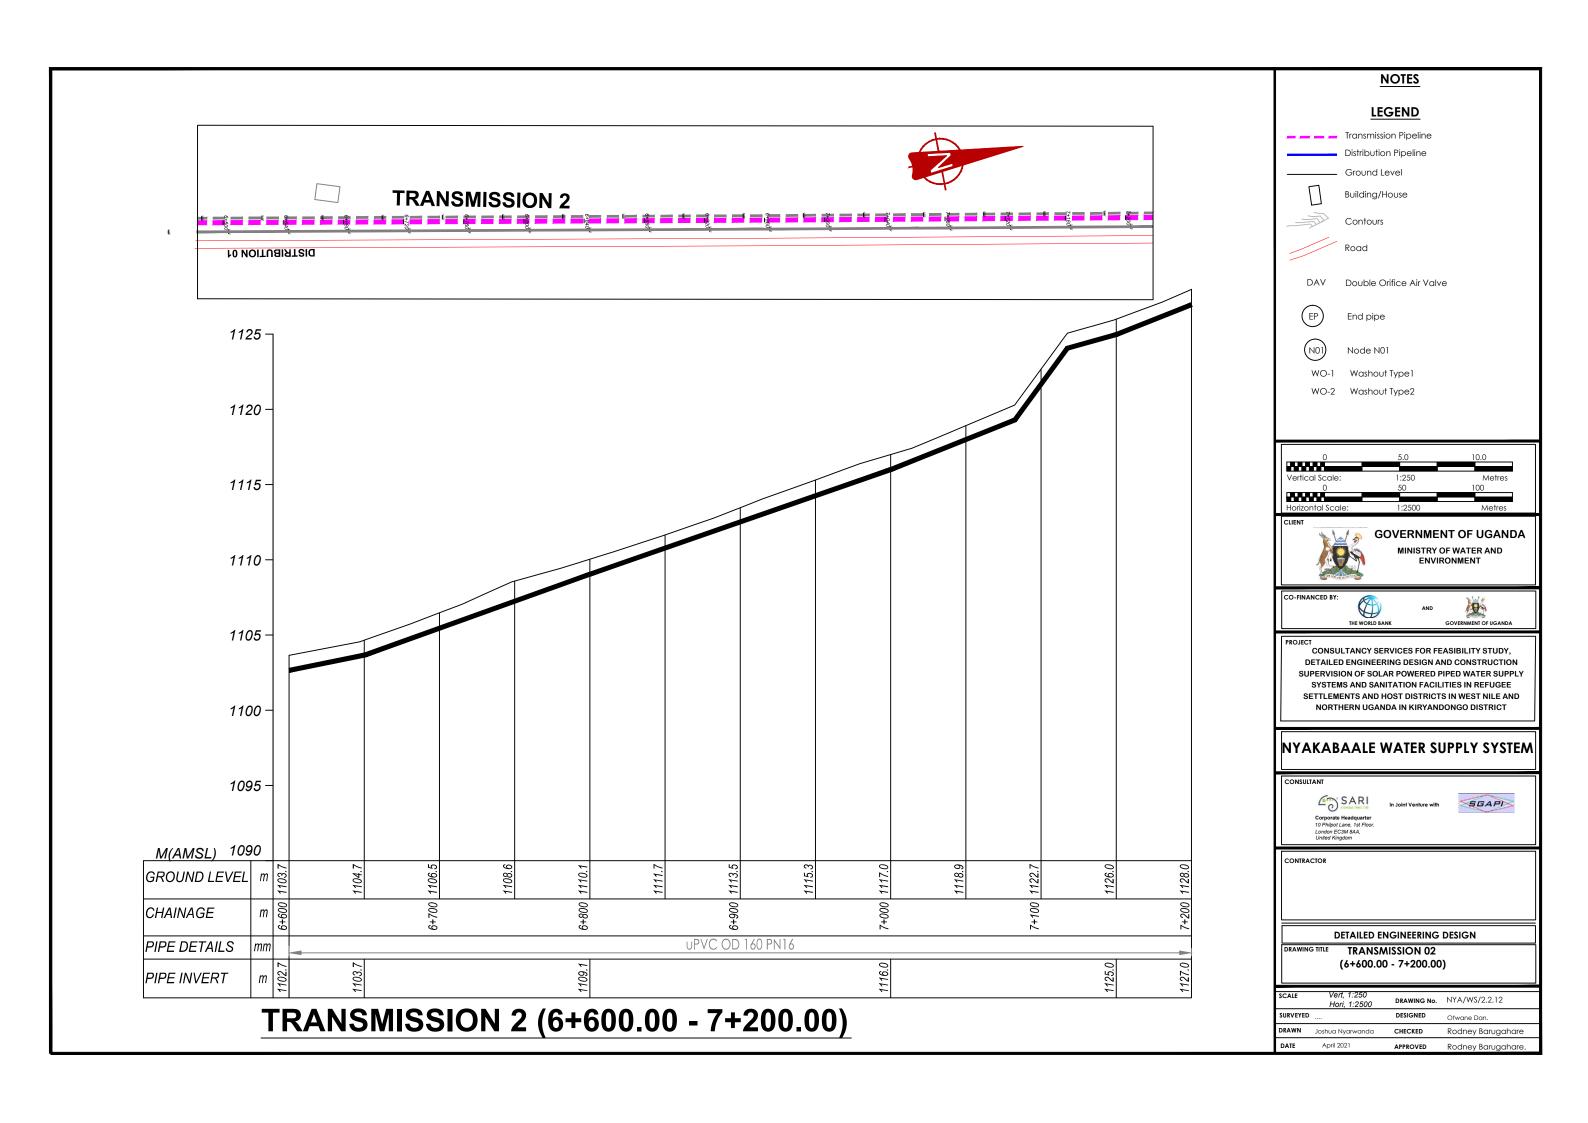


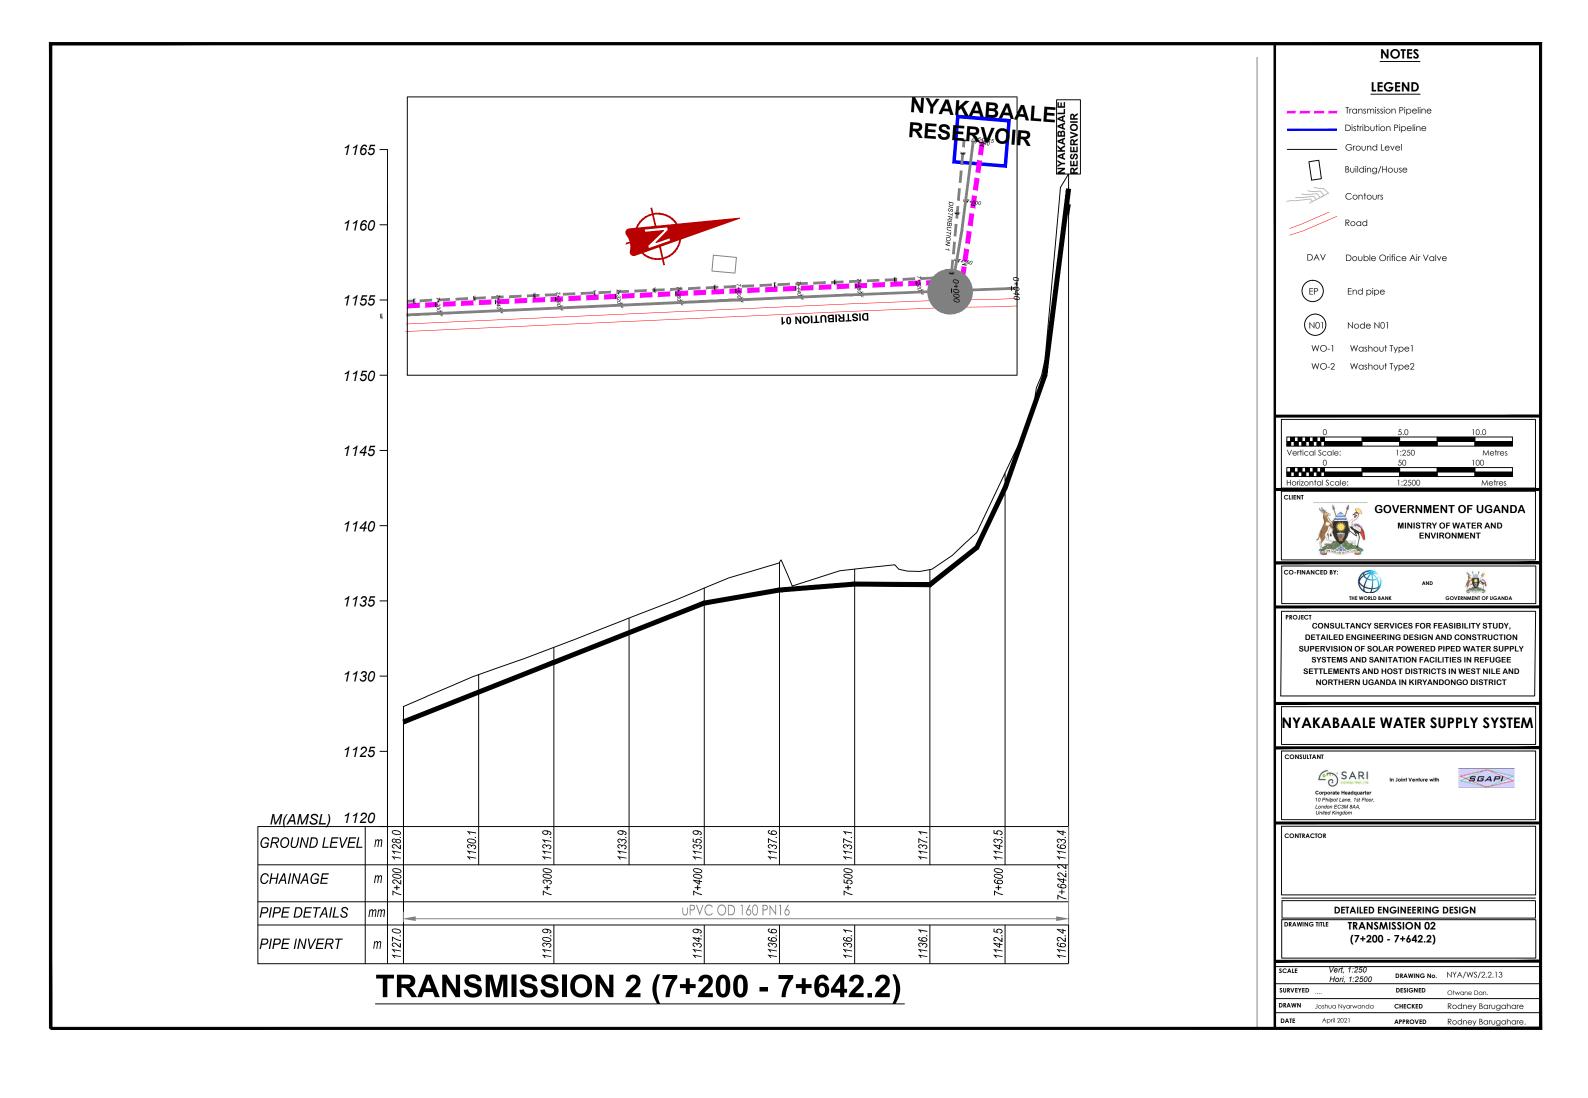


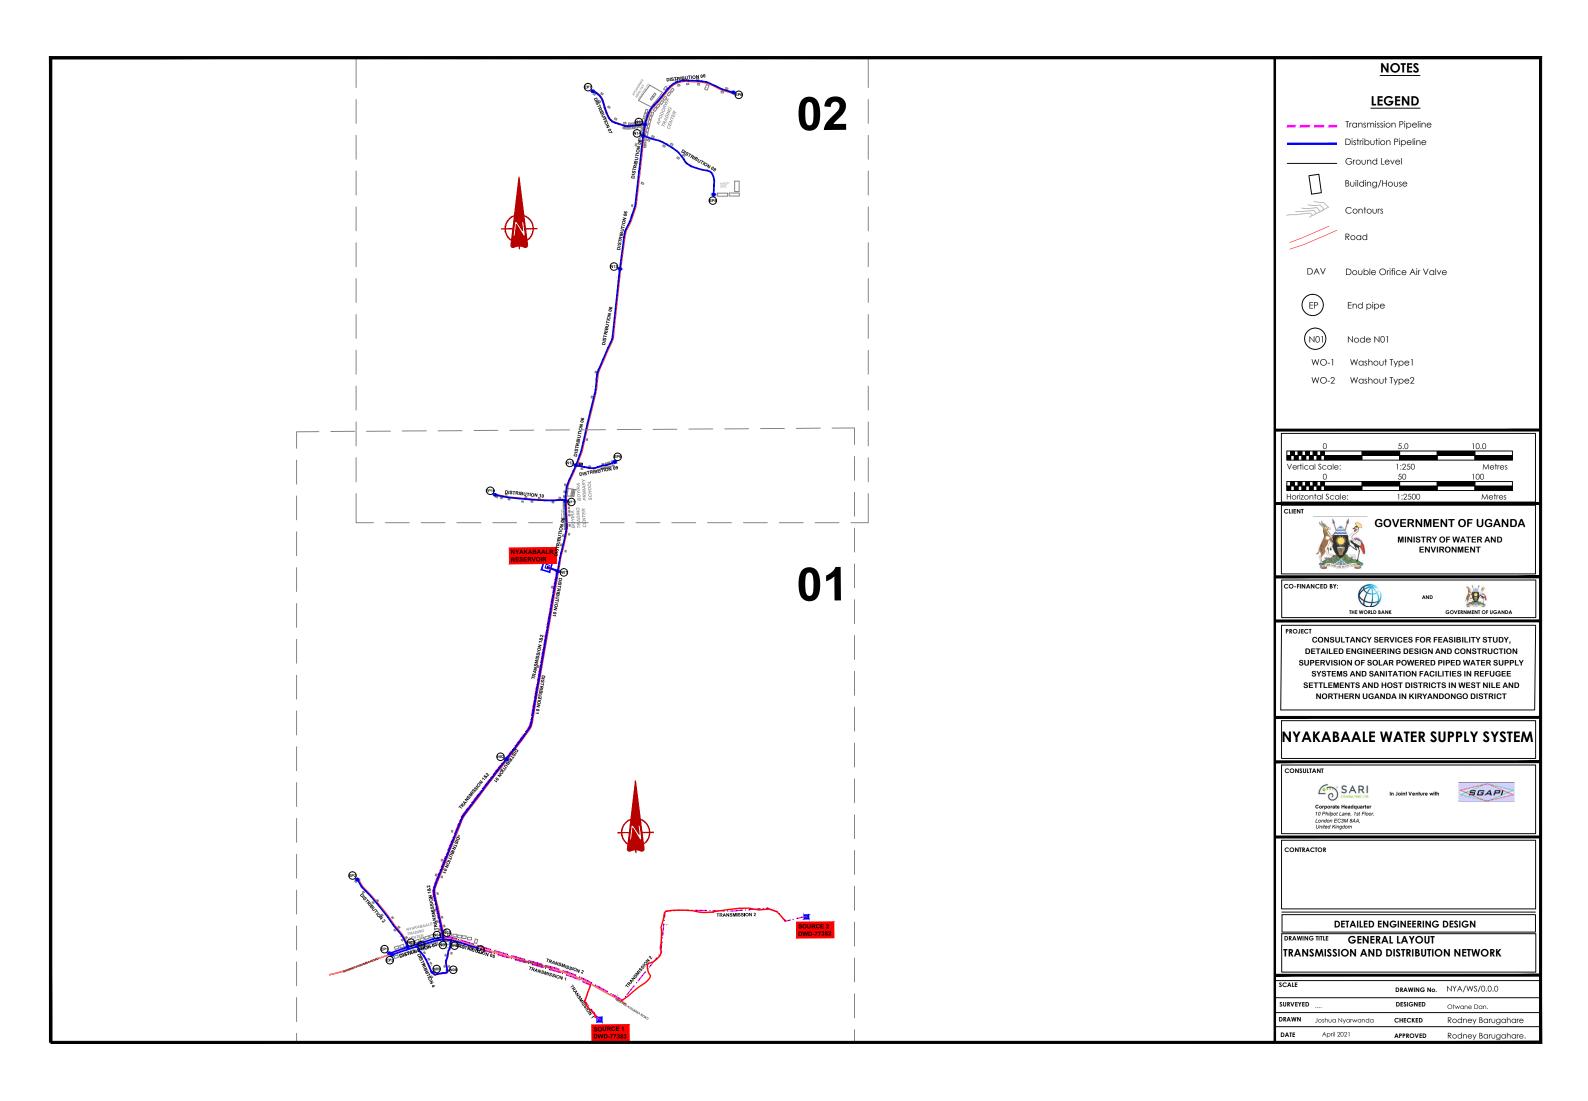

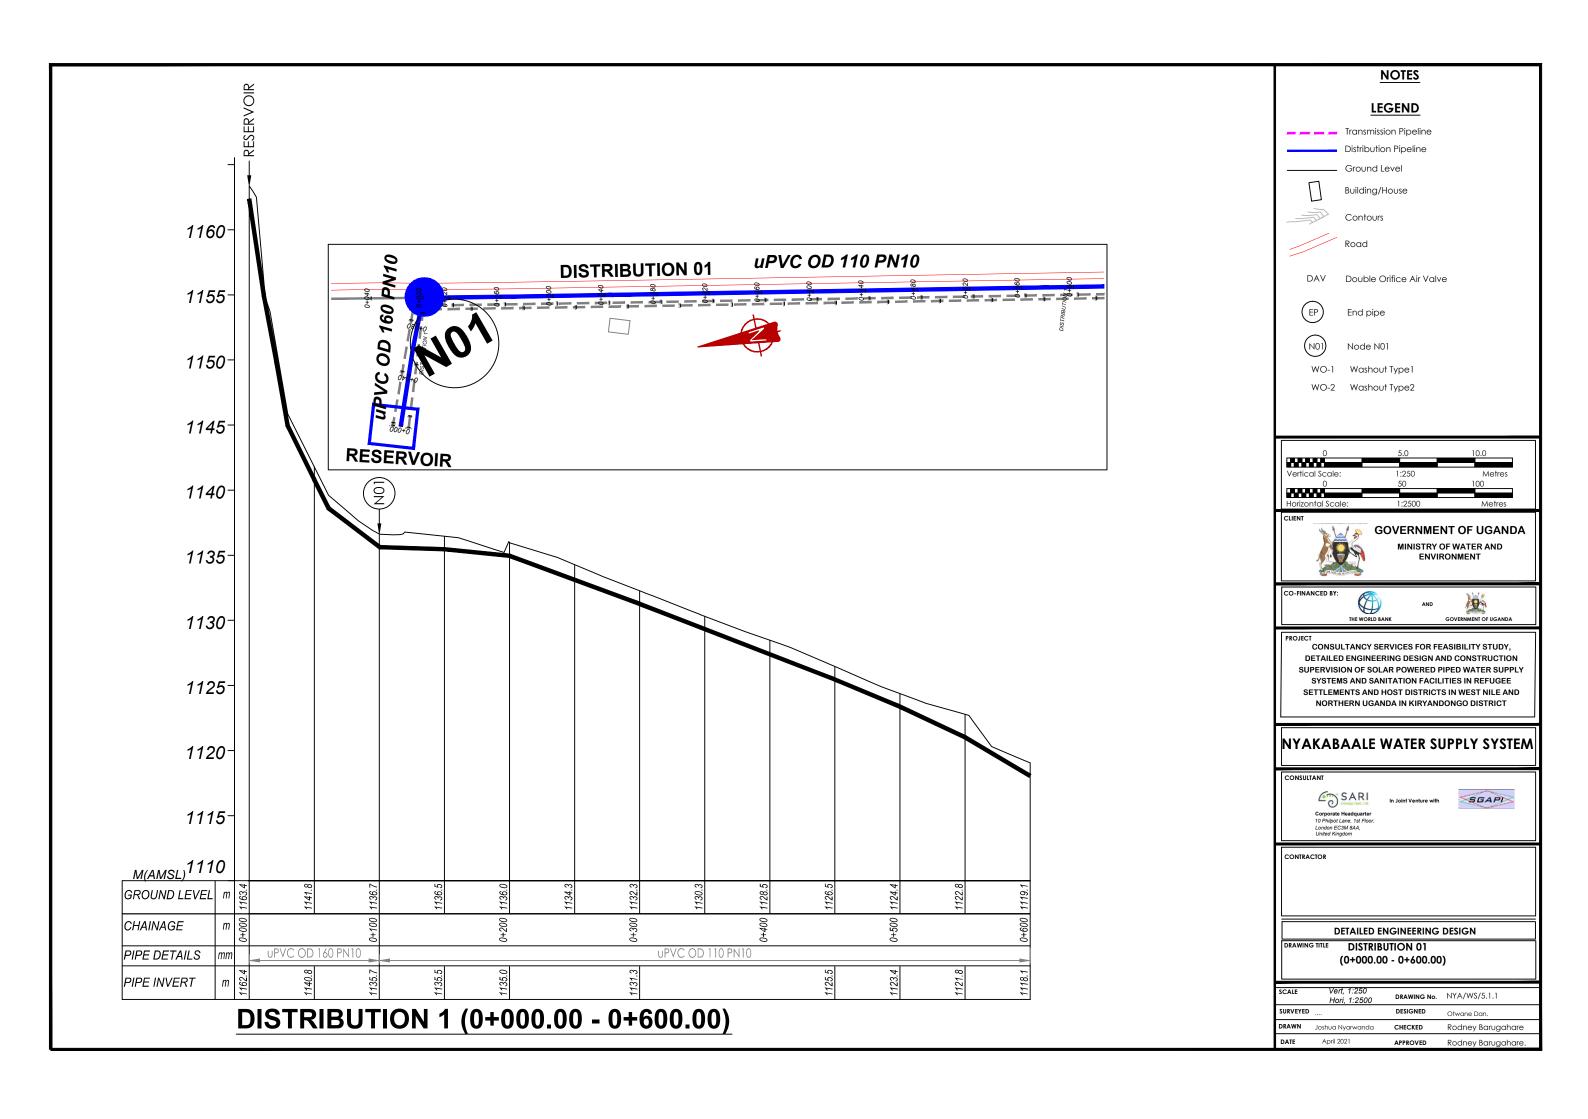

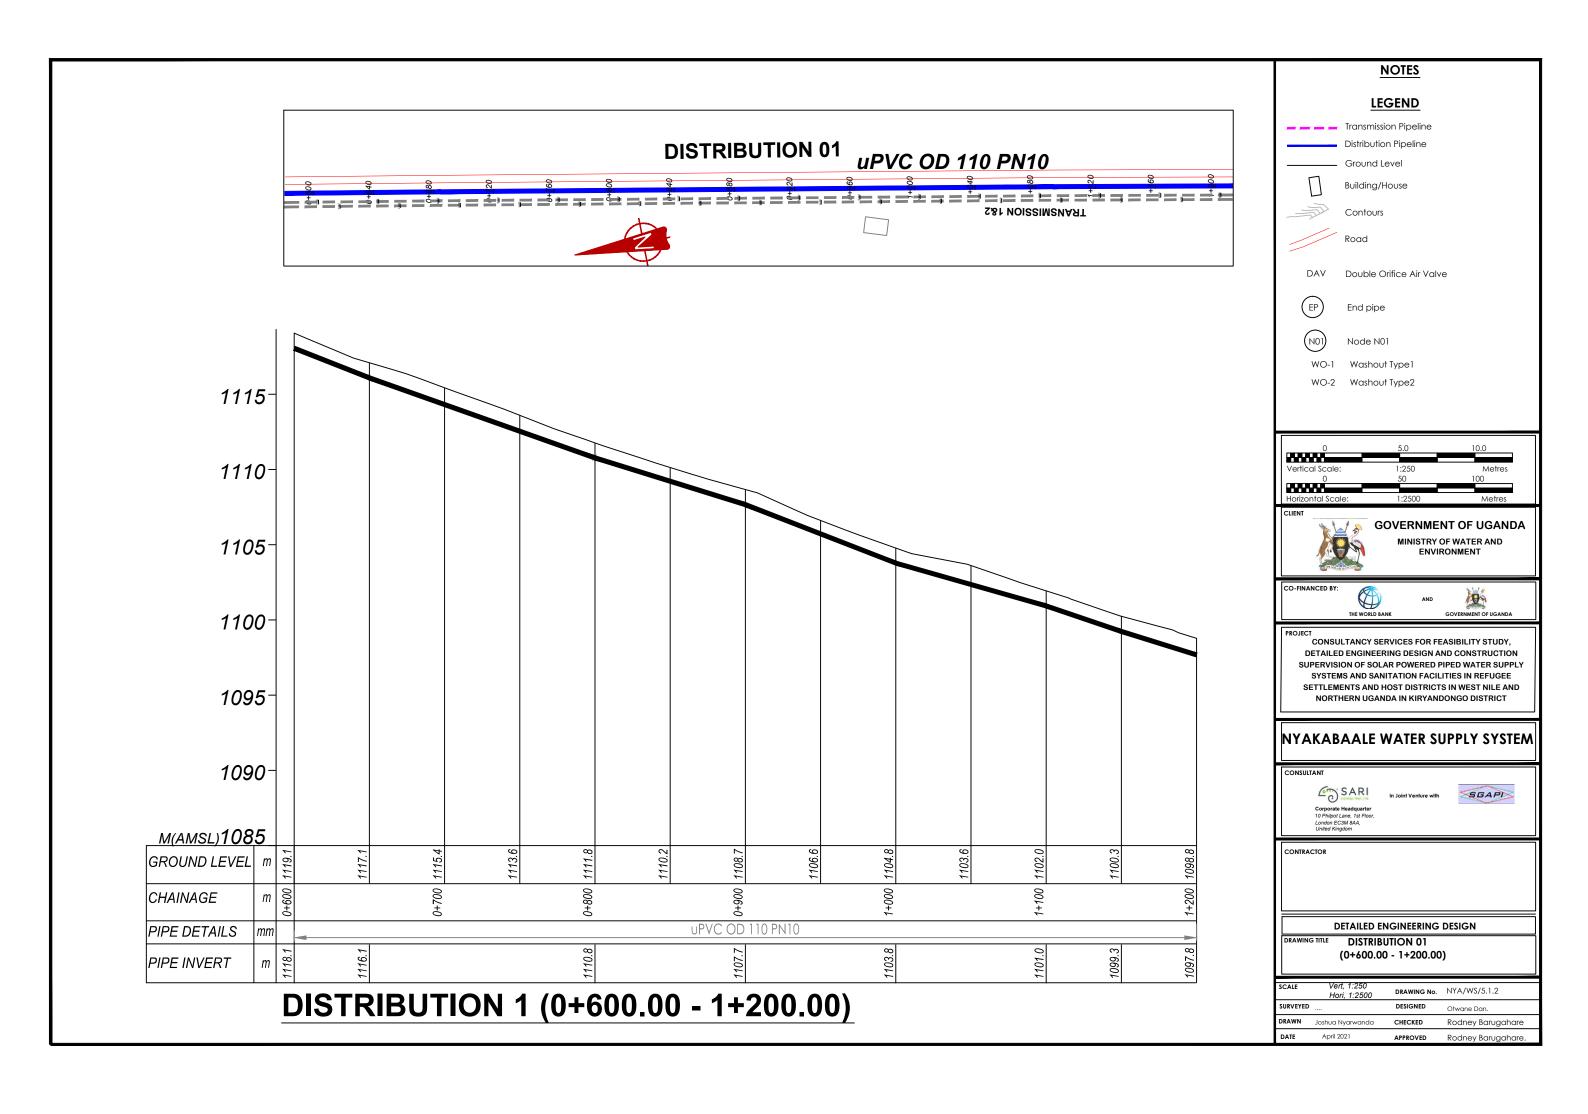


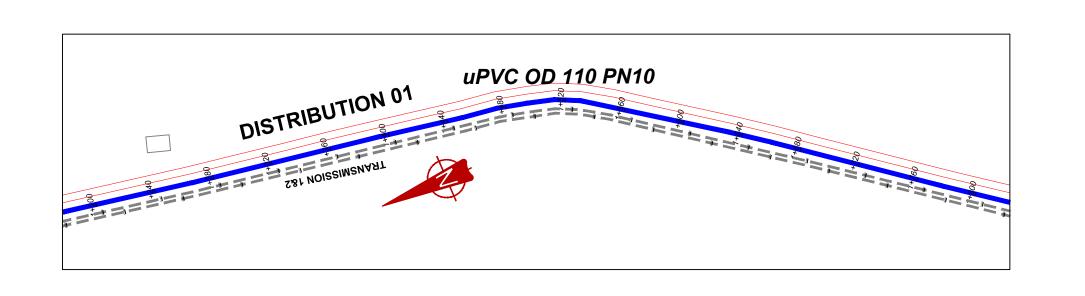

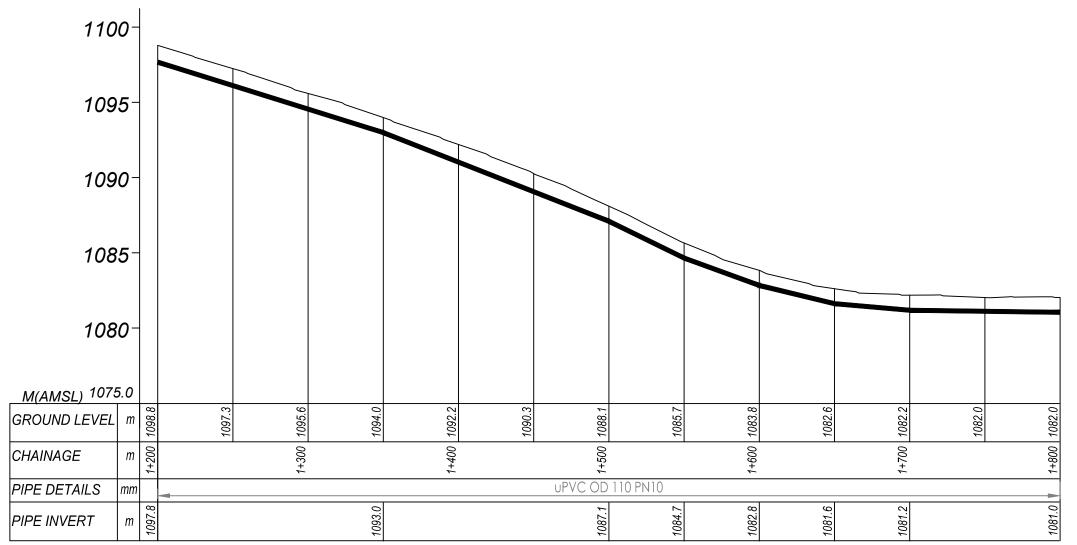

DISTRIBUTION 1 (1+200.00 - 1+800.00)

NOTES LEGEND Transmission Pipeline Distribution Pipeline Ground Level Building/House Contours Road DAV Double Orifice Air Valve

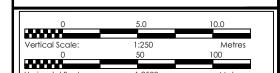

GOVERN

End pipe

NO1) Node N01

WO-1 Washout Type 1

WO-2 Washout Type 2

GOVERNMENT OF UGANDA MINISTRY OF WATER AND ENVIRONMENT

-FINANCED BY:



PPO IECT

CONSULTANCY SERVICES FOR FEASIBILITY STUDY,
DETAILED ENGINEERING DESIGN AND CONSTRUCTION
SUPERVISION OF SOLAR POWERED PIPED WATER SUPPLY
SYSTEMS AND SANITATION FACILITIES IN REFUGEE
SETTLEMENTS AND HOST DISTRICTS IN WEST NILE AND
NORTHERN UGANDA IN KIRYANDONGO DISTRICT

NYAKABAALE WATER SUPPLY SYSTEM

Corporate Headquarter
10 Philpot Lane, 1st Floor

n Joint Venture with




CONTRACTO


DETAILED ENGINEERING DESIGN

DISTRIBUTION 01

1+200.00 - 1+800.00)


SCALE	Vert, 1:250 Hori, 1:2500	DRAWING No.	NYA/WS/5.1.3
SURVEYED	·	DESIGNED	Otwane Dan.
DRAWN	Joshua Nyarwanda	CHECKED	Rodney Barugahare
DATE	April 2021	APPROVED	Rodney Barugahare.

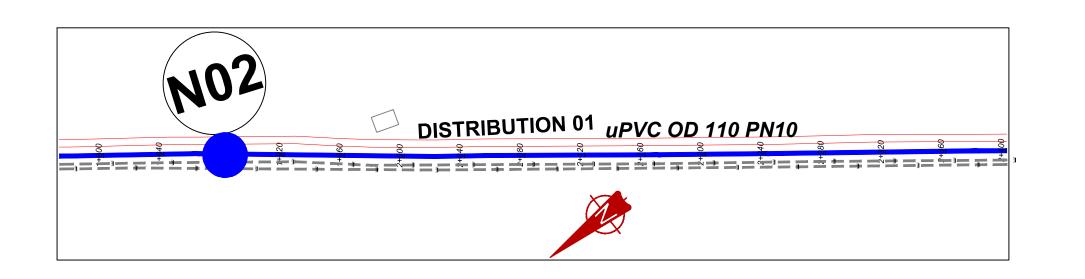

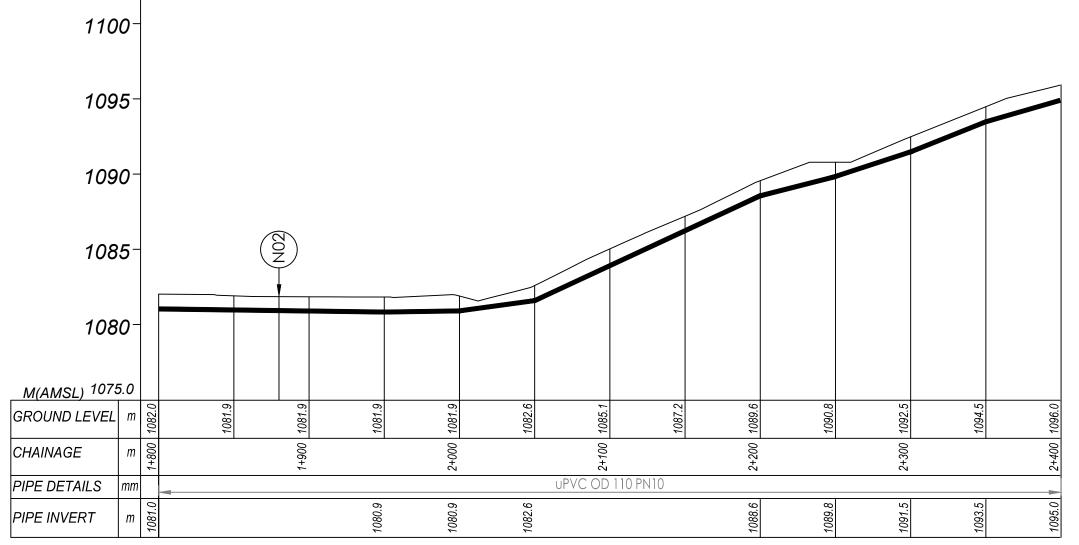

DISTRIBUTION 1 (1+800.00 - 2+400.00)

NOTES LEGEND Transmission Pipeline Distribution Pipeline Ground Level Building/House Contours Road DAV Double Orifice Air Valve EP End pipe NO) Node NO1 WO-1 Washout Type1 WO-2 Washout Type2

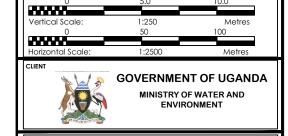

D-FINANCED BY:

THE WORLD BAN



CONSULTANCY SERVICES FOR FEASIBILITY STUDY,
DETAILED ENGINEERING DESIGN AND CONSTRUCTION
SUPERVISION OF SOLAR POWERED PIPED WATER SUPPLY
SYSTEMS AND SANITATION FACILITIES IN REFUGEE
SETTLEMENTS AND HOST DISTRICTS IN WEST NILE AND
NORTHERN UGANDA IN KIRYANDONGO DISTRICT

NYAKABAALE WATER SUPPLY SYSTEM

Corporate Headquarter
10 Philpot Lane, 1st Floor,
London EC3M BAA,

In Joint Venture with





CONTRACTO

DETAILED ENGINEERING DESIGN

DISTRIBUTION 01
(1+800.00 - 2+400.00)


Į			
SCALE	Vert, 1:250 Hori, 1:2500	DRAWING No.	NYA/WS/5.1.4
SURVEYED	·	DESIGNED	Otwane Dan.
DRAWN	Joshua Nyarwanda	CHECKED	Rodney Barugahare
DATE	April 2021	APPROVED	Rodney Barugahare.

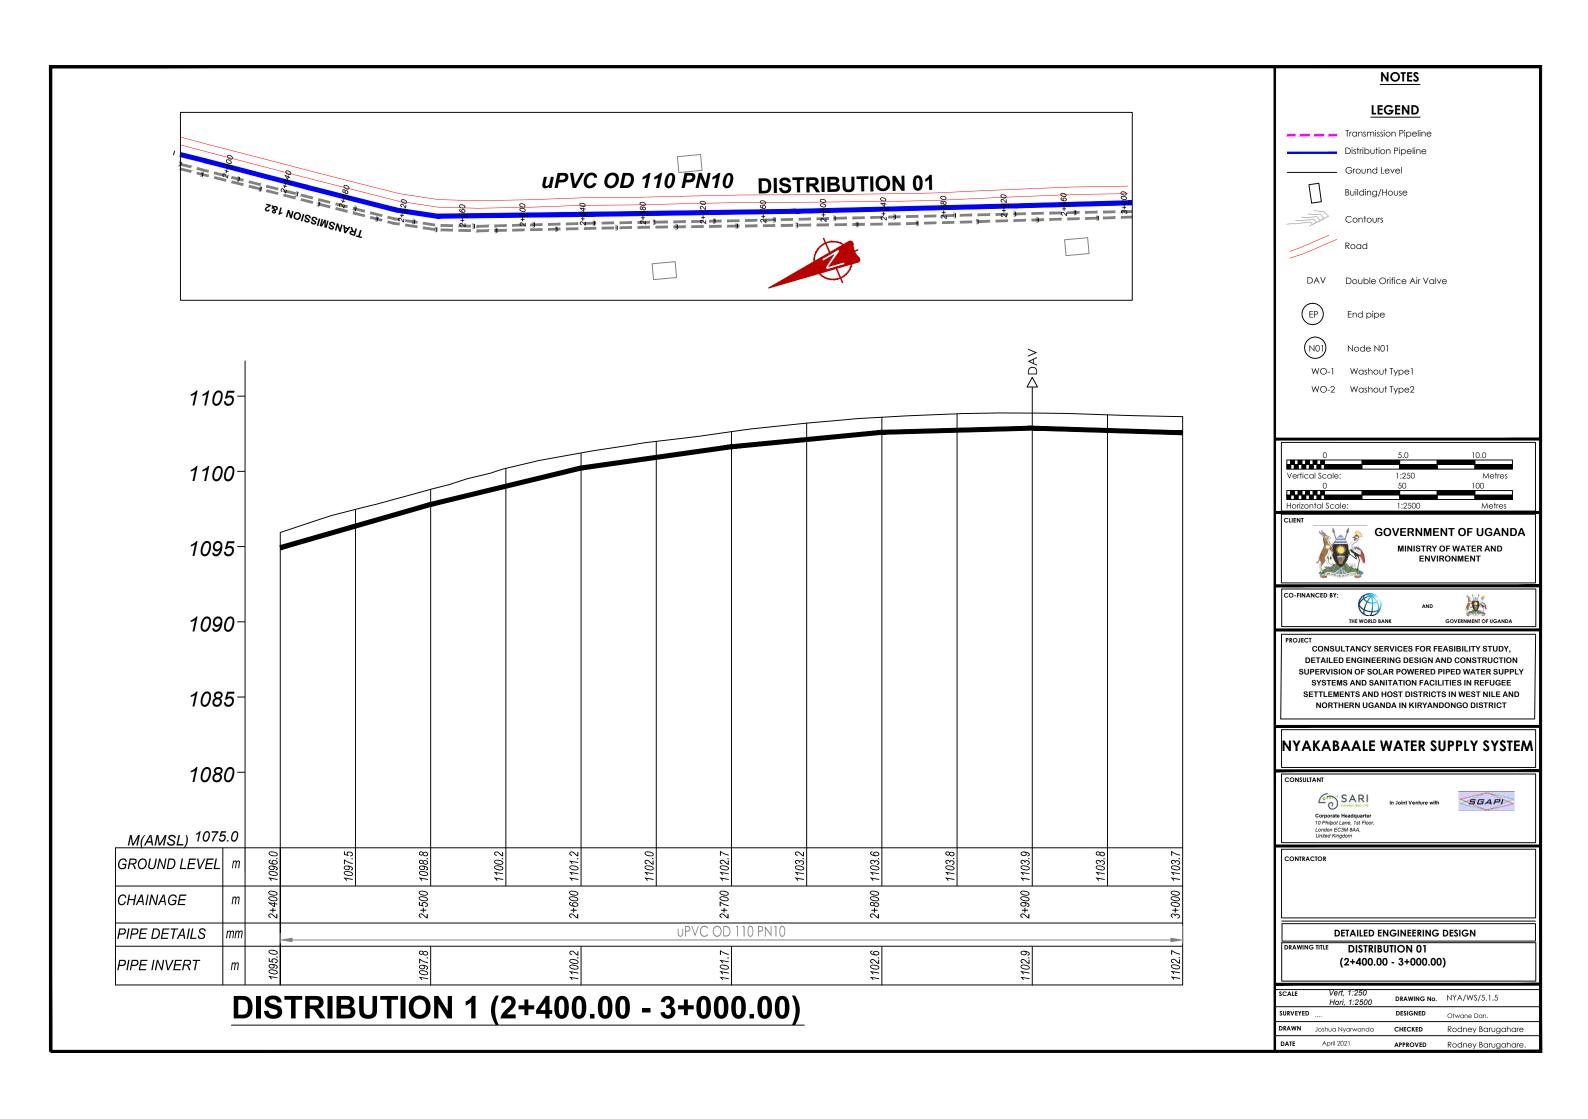


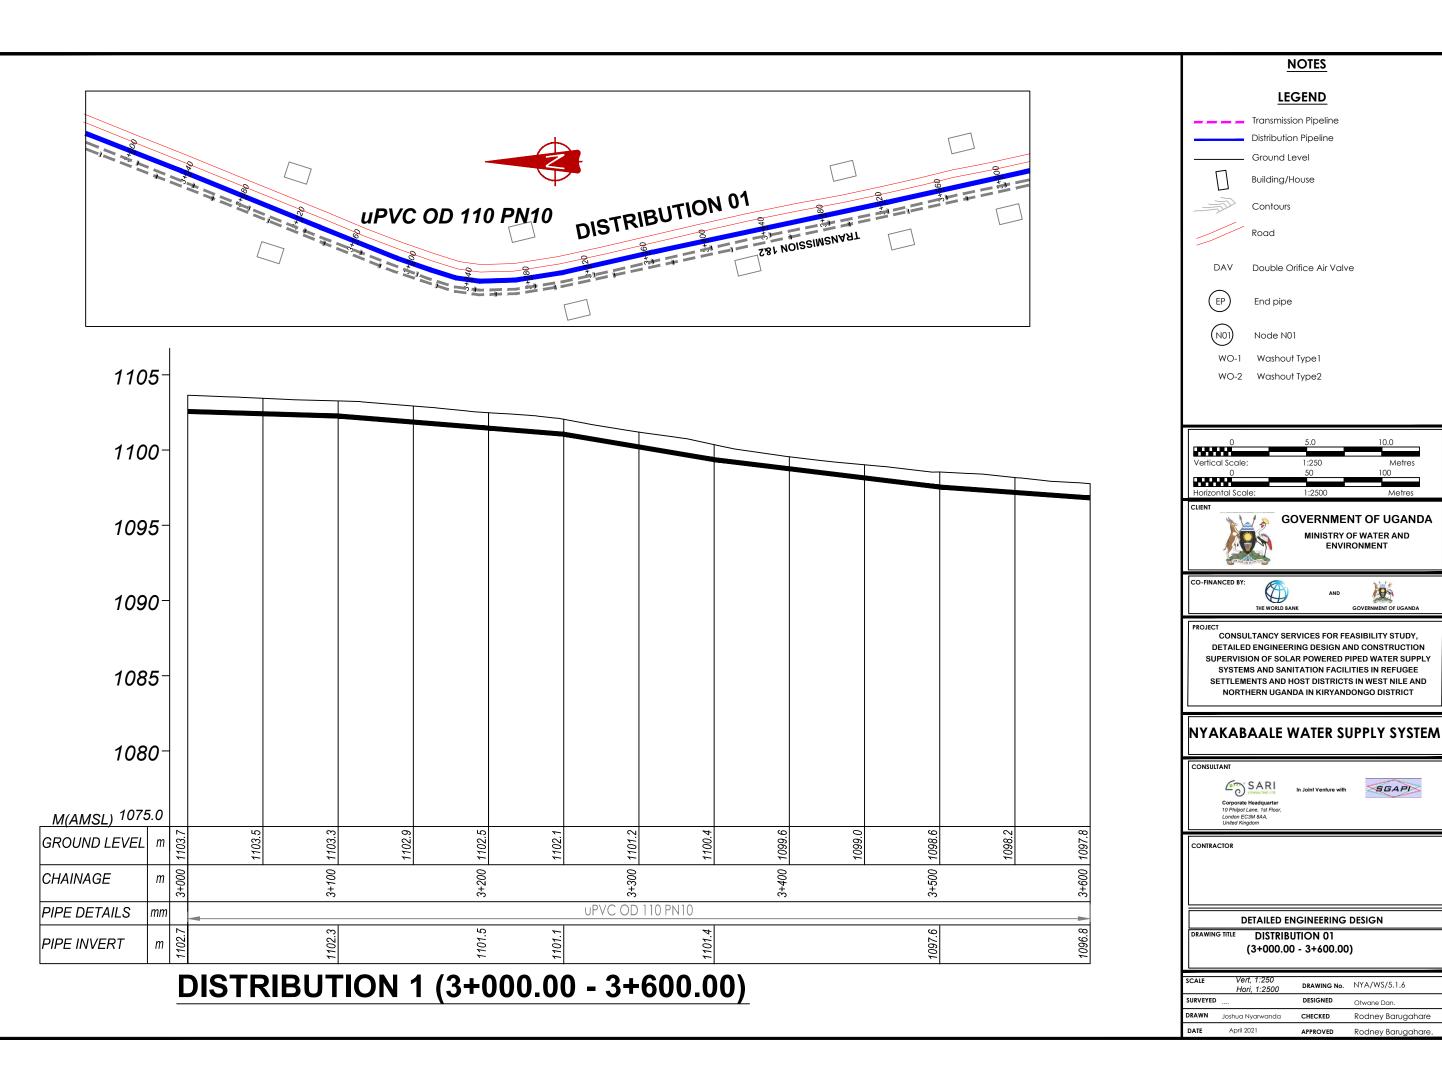



SGAPI

Rodney Barugahare

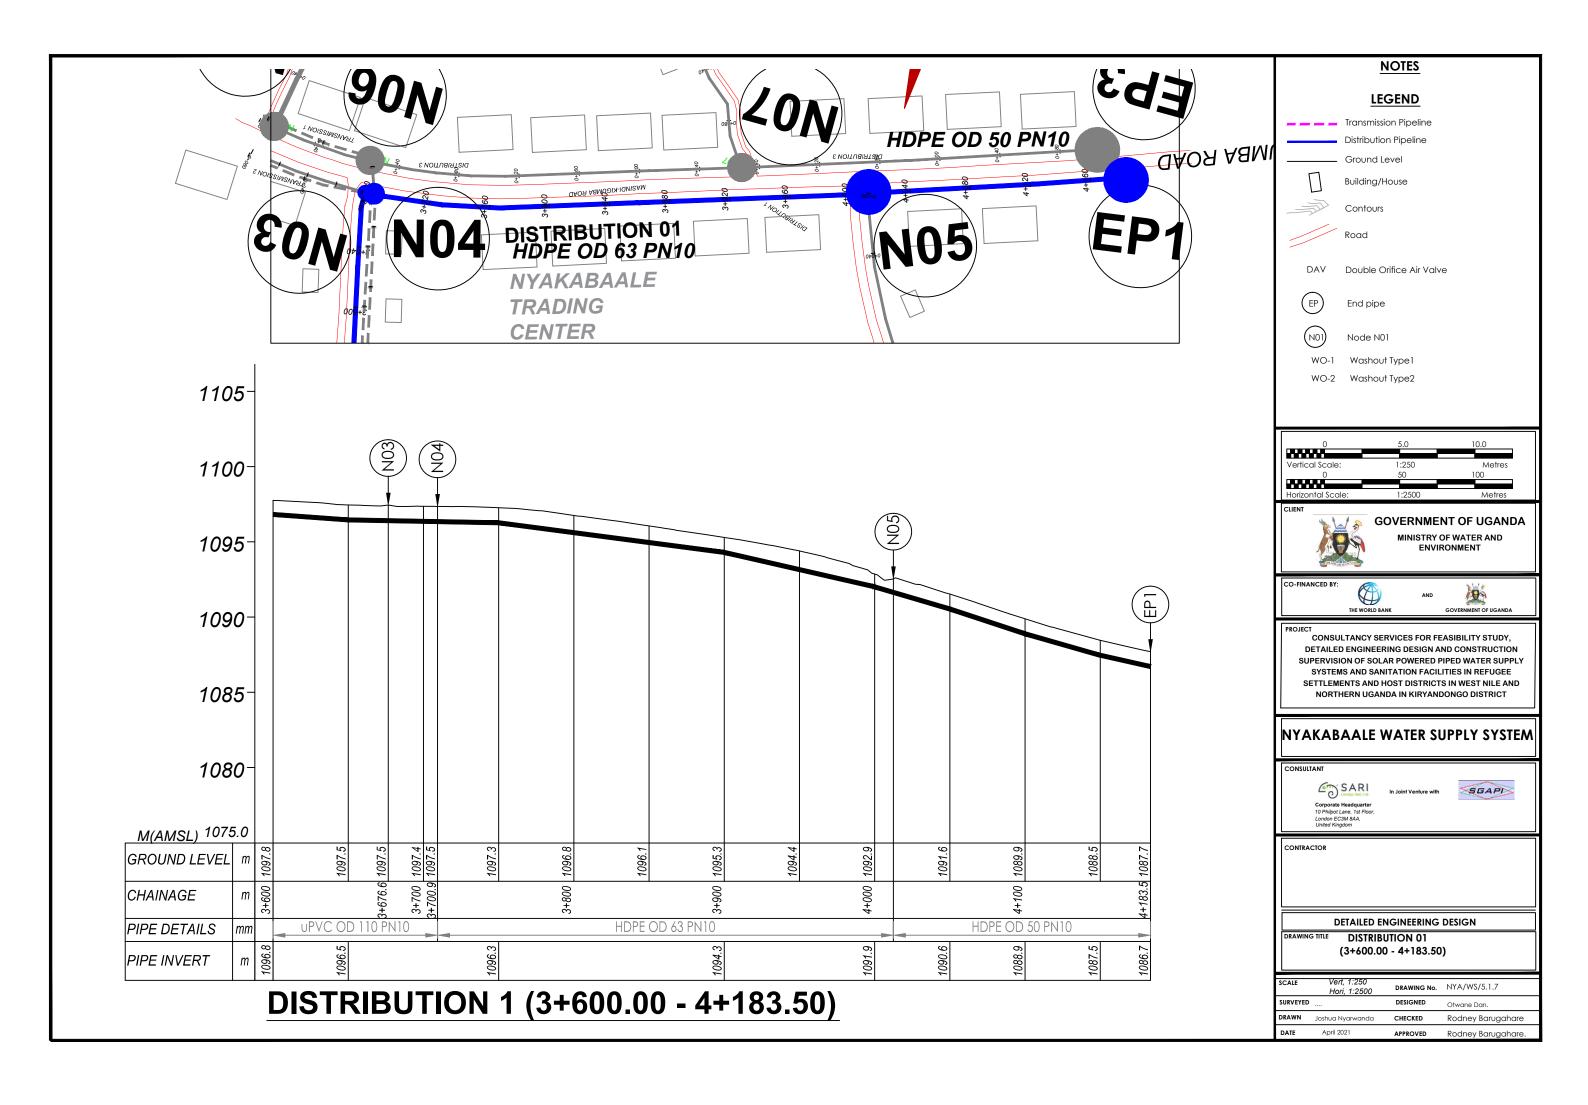

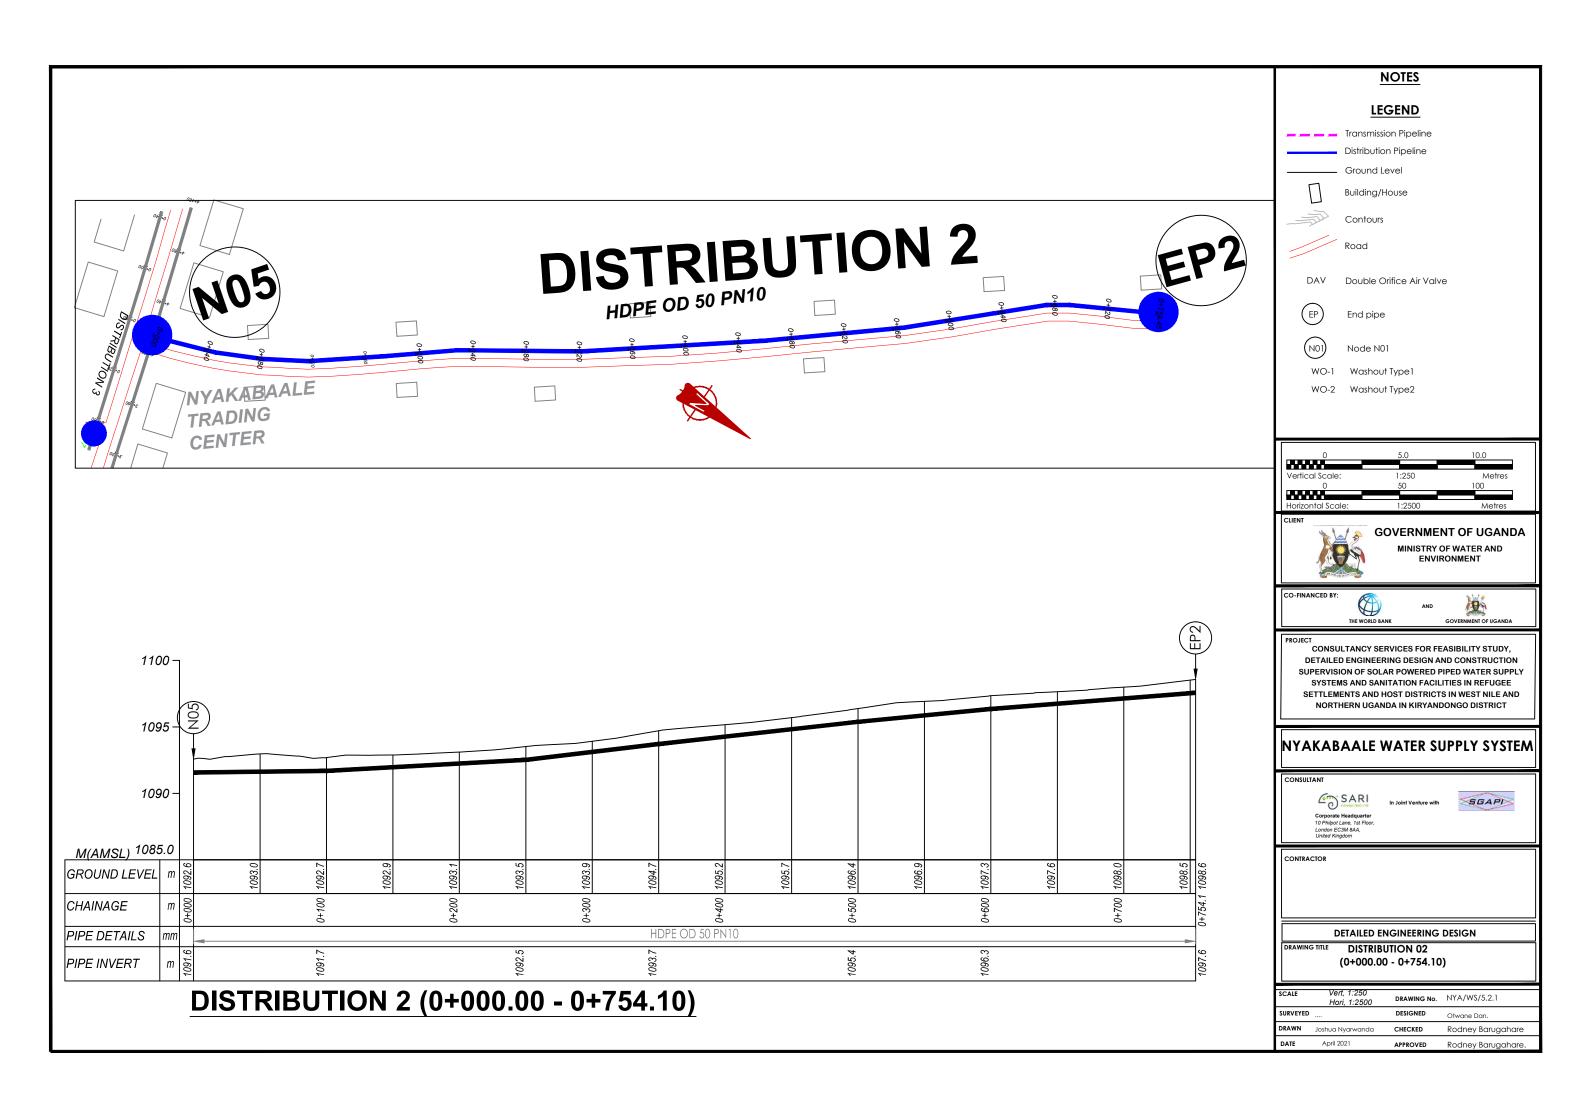

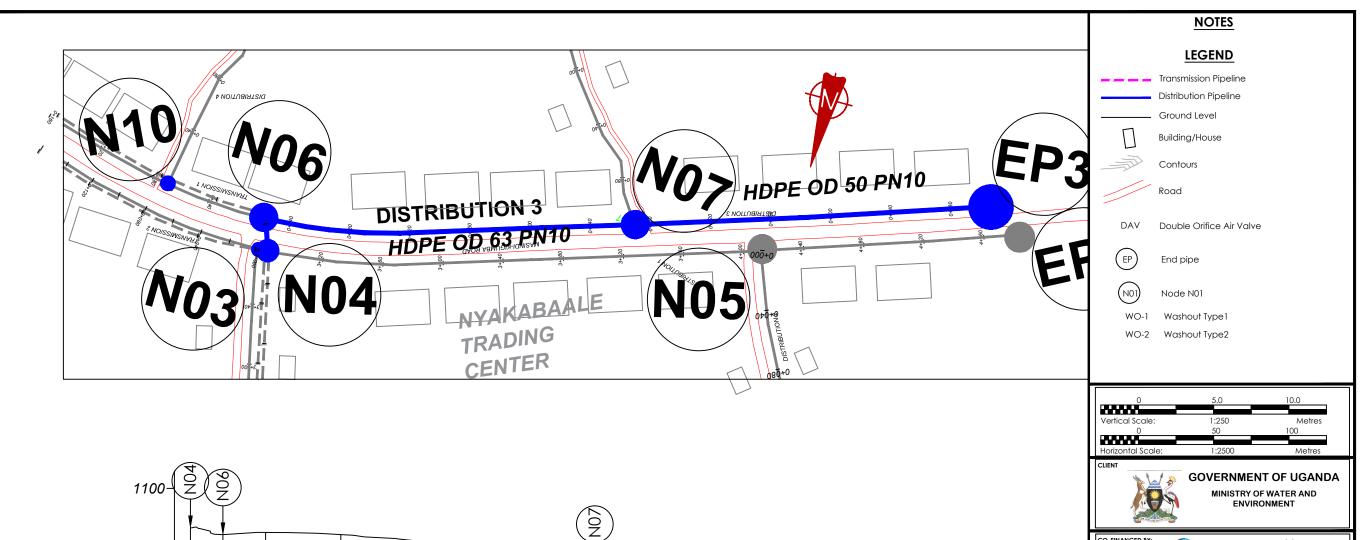

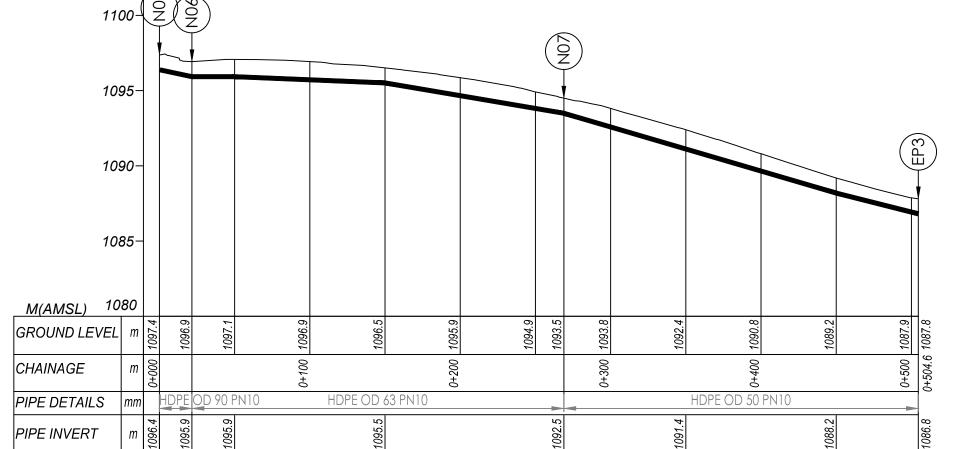

DISTRIBUTION 3 (0+000.00 - 0+504.60)

NYAKABAALE WATER SUPPLY SYSTEM

CONSULTANCY SERVICES FOR FEASIBILITY STUDY,
DETAILED ENGINEERING DESIGN AND CONSTRUCTION
SUPERVISION OF SOLAR POWERED PIPED WATER SUPPLY
SYSTEMS AND SANITATION FACILITIES IN REFUGEE

SETTLEMENTS AND HOST DISTRICTS IN WEST NILE AND NORTHERN UGANDA IN KIRYANDONGO DISTRICT

Corporate 19
Corporate 19
Corporate 19
Philipot Lane, 1st Floor
London EC3M 8AA,

In Joint Venture with





CONTRACTO


DETAILED ENGINEERING DESIGN

DISTRIBUTION 03
(0+000.00 - 0+504.60)

SURVEYED DESIGNED Otwane Dan. DRAWN Joshua Nyarwanda CHECKED Rodney Barugahare DATE April 2021 APPROVED Rodney Barugahare.	SCALE	Vert, 1:250 Hori, 1:2500	DRAWING No.	NYA/WS/5.3.1
	SURVEYED		DESIGNED	Otwane Dan.
DATE April 2021 APPROVED Rodney Barugahare.	DRAWN	Joshua Nyarwanda	CHECKED	Rodney Barugahare
	DATE	April 2021	APPROVED	Rodney Barugahare.

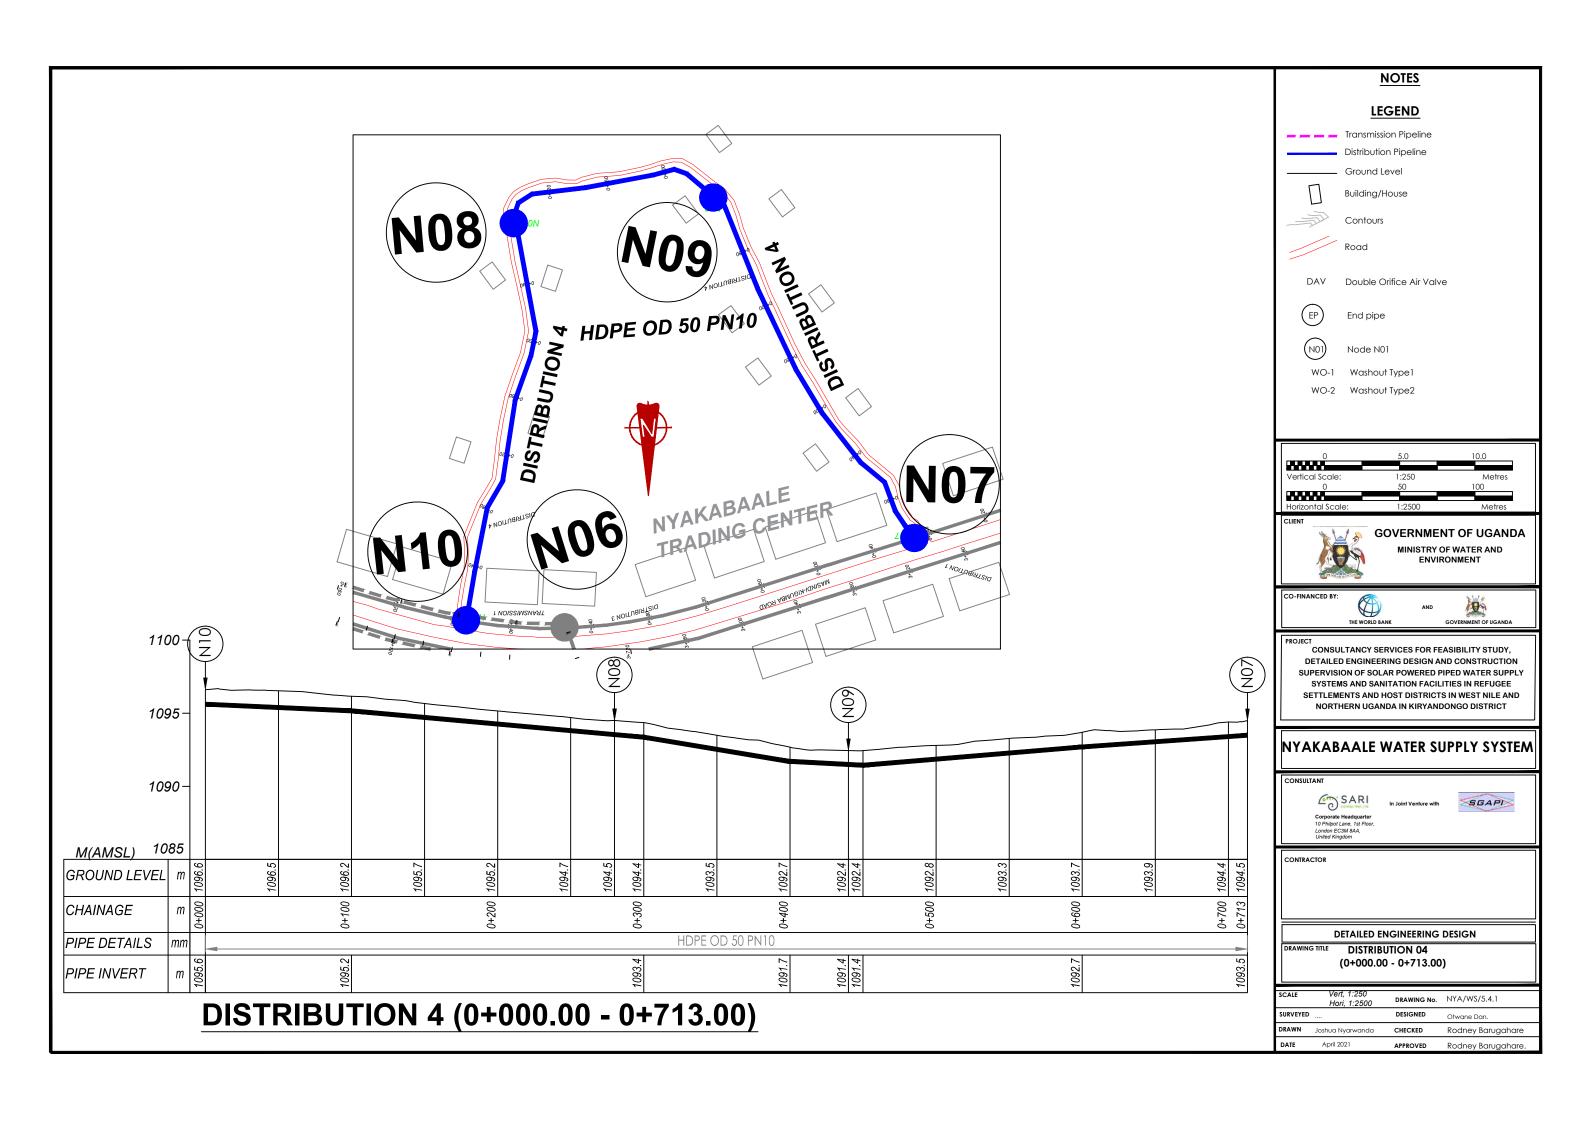

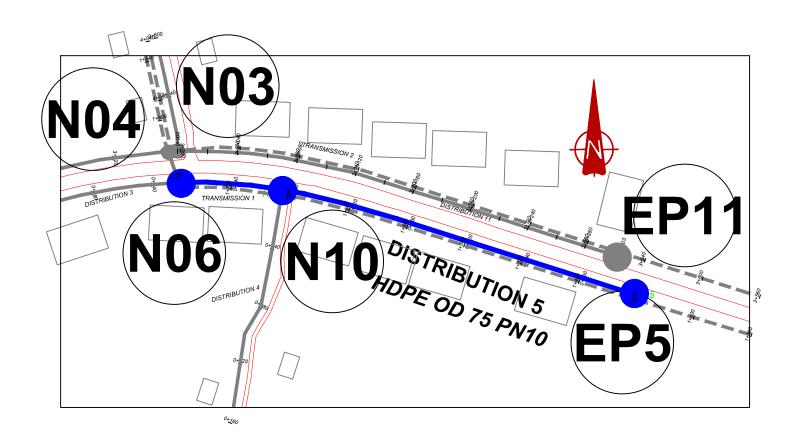

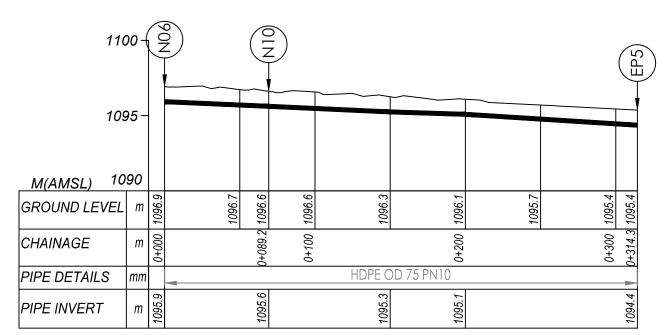

DISTRIBUTION 5 (0+000.00 - 0+314.3.00)

NOTES LEGEND 🗕 💻 Transmission Pipeline Distribution Pipeline Ground Level Building/House Contours Road DAV Double Orifice Air Valve End pipe Node N01 WO-1 Washout Type 1 WO-2 Washout Type2 **GOVERNMENT OF UGANDA** MINISTRY OF WATER AND ENVIRONMENT CONSULTANCY SERVICES FOR FEASIBILITY STUDY, DETAILED ENGINEERING DESIGN AND CONSTRUCTION SUPERVISION OF SOLAR POWERED PIPED WATER SUPPLY SYSTEMS AND SANITATION FACILITIES IN REFUGEE SETTLEMENTS AND HOST DISTRICTS IN WEST NILE AND NORTHERN UGANDA IN KIRYANDONGO DISTRICT NYAKABAALE WATER SUPPLY SYSTEM SARI CONSULTING LTD

SGAPI


Rodney Barugahare


DETAILED ENGINEERING DESIGN

DISTRIBUTION 05

DRAWN

(0+000.00 - 0+314.3.00)

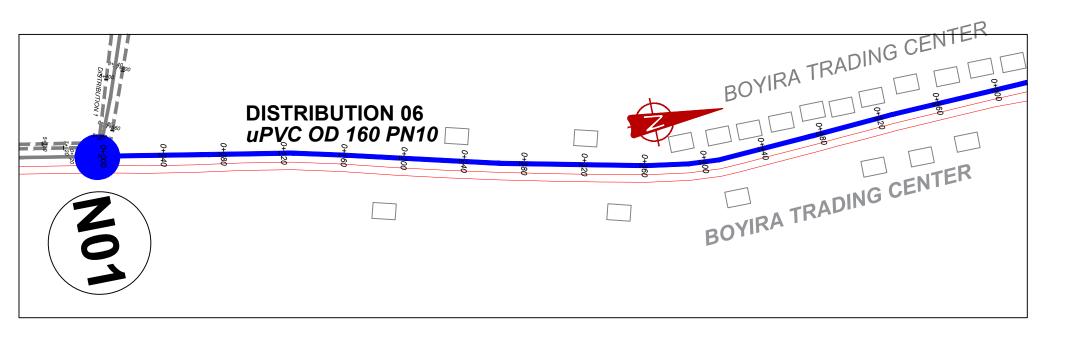

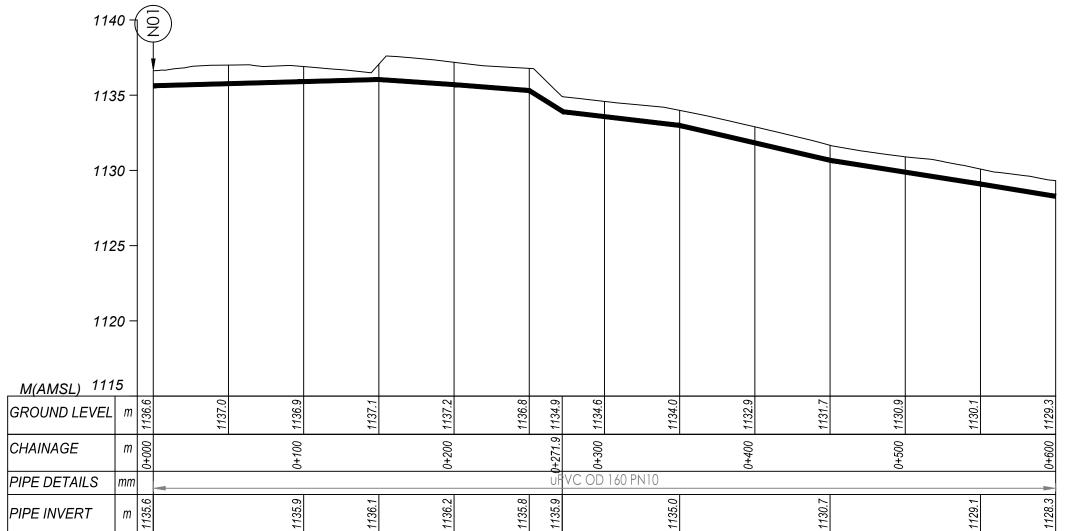

DISTRIBUTION 6 (0+000.00 - 0+600.00)

NOTES LEGEND

___ Transmission Pipeline

Distribution Pipel

Ground Level

Building/House

Contours

Road

DAV Double Orifice Air Valve

(EP) End pipe

101) Node N01

WO-1 Washout Type 1

WO-2 Washout Type2

0 5.0 10.0

Vertical Scale: 1:250 Metres
0 50 100

GOVERNMENT OF UGANDA MINISTRY OF WATER AND ENVIRONMENT

CO-FINANCED I



199

PROJEC

CONSULTANCY SERVICES FOR FEASIBILITY STUDY,
DETAILED ENGINEERING DESIGN AND CONSTRUCTION
SUPERVISION OF SOLAR POWERED PIPED WATER SUPPLY
SYSTEMS AND SANITATION FACILITIES IN REFUGEE
SETTLEMENTS AND HOST DISTRICTS IN WEST NILE AND
NORTHERN UGANDA IN KIRYANDONGO DISTRICT

NYAKABAALE WATER SUPPLY SYSTEM

E SA

Corporate Headquarter
10 Philipot Lane, 1st Floor,



CONTRACTO

DETAILED ENGINEERING DESIGN

AWING TITLE


DISTRIBUTION 06
(0+000.00 - 0+600.00)


 SCALE
 Vert, 1:250 Hori, 1:2500
 DRAWING No.
 NYA/WS/5.6.1

 SURVEYED

 DESIGNED
 Otwane Dan.

 DRAWN
 Joshua Nyarwanda
 CHECKED
 Rodney Barugahare

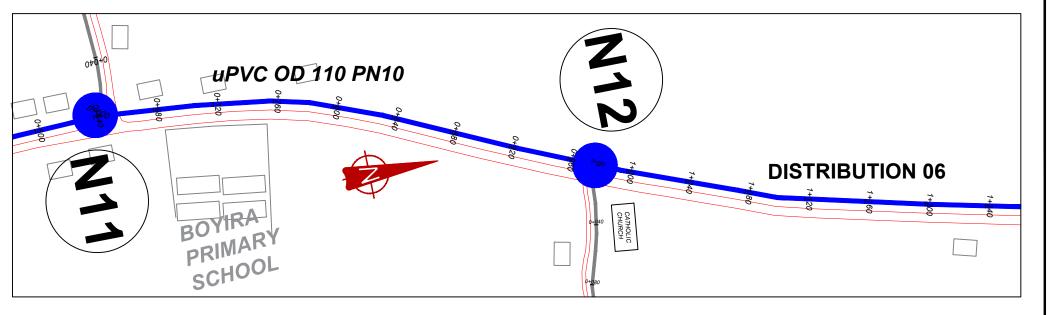

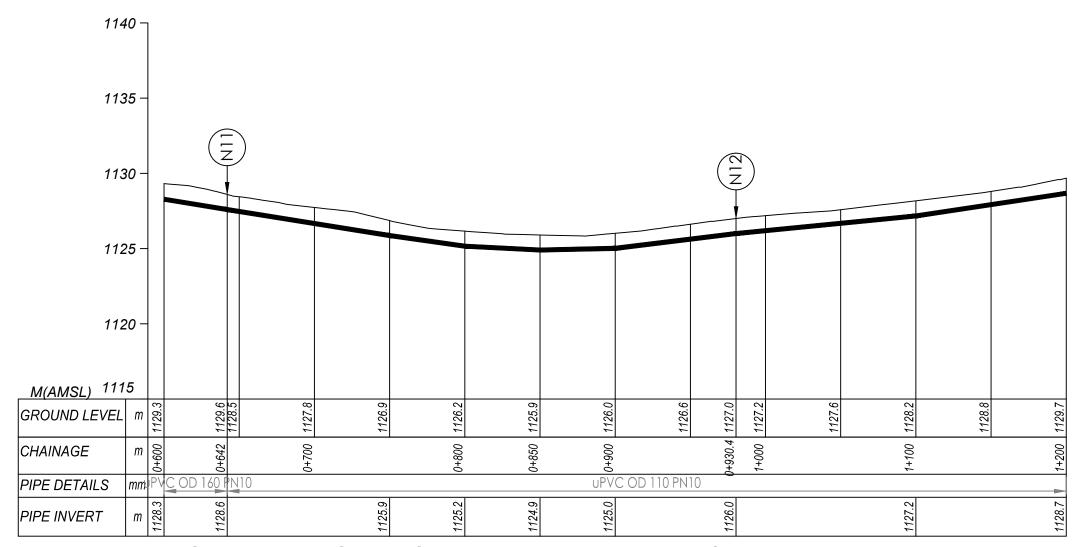

DISTRIBUTION 6 (0+600.00 - 1+200.00)


LEGEND Transmission Pipeline Distribution Pipeline Ground Level Building/House Contours Road DAV Double Orifice Air Valve End pipe Node N01 WO-1 Washout Type 1 WO-2 Washout Type2 **GOVERNMENT OF UGANDA** MINISTRY OF WATER AND ENVIRONMENT CONSULTANCY SERVICES FOR FEASIBILITY STUDY, DETAILED ENGINEERING DESIGN AND CONSTRUCTION SUPERVISION OF SOLAR POWERED PIPED WATER SUPPLY SYSTEMS AND SANITATION FACILITIES IN REFUGEE SETTLEMENTS AND HOST DISTRICTS IN WEST NILE AND NORTHERN UGANDA IN KIRYANDONGO DISTRICT **NYAKABAALE WATER SUPPLY SYSTEM** SARI CONSULTING LTD SGAPI DETAILED ENGINEERING DESIGN DISTRIBUTION 06 (0+600.00 - 1+200.00)


Rodney Barugahare


CHECKED


DRAWN


NOTES

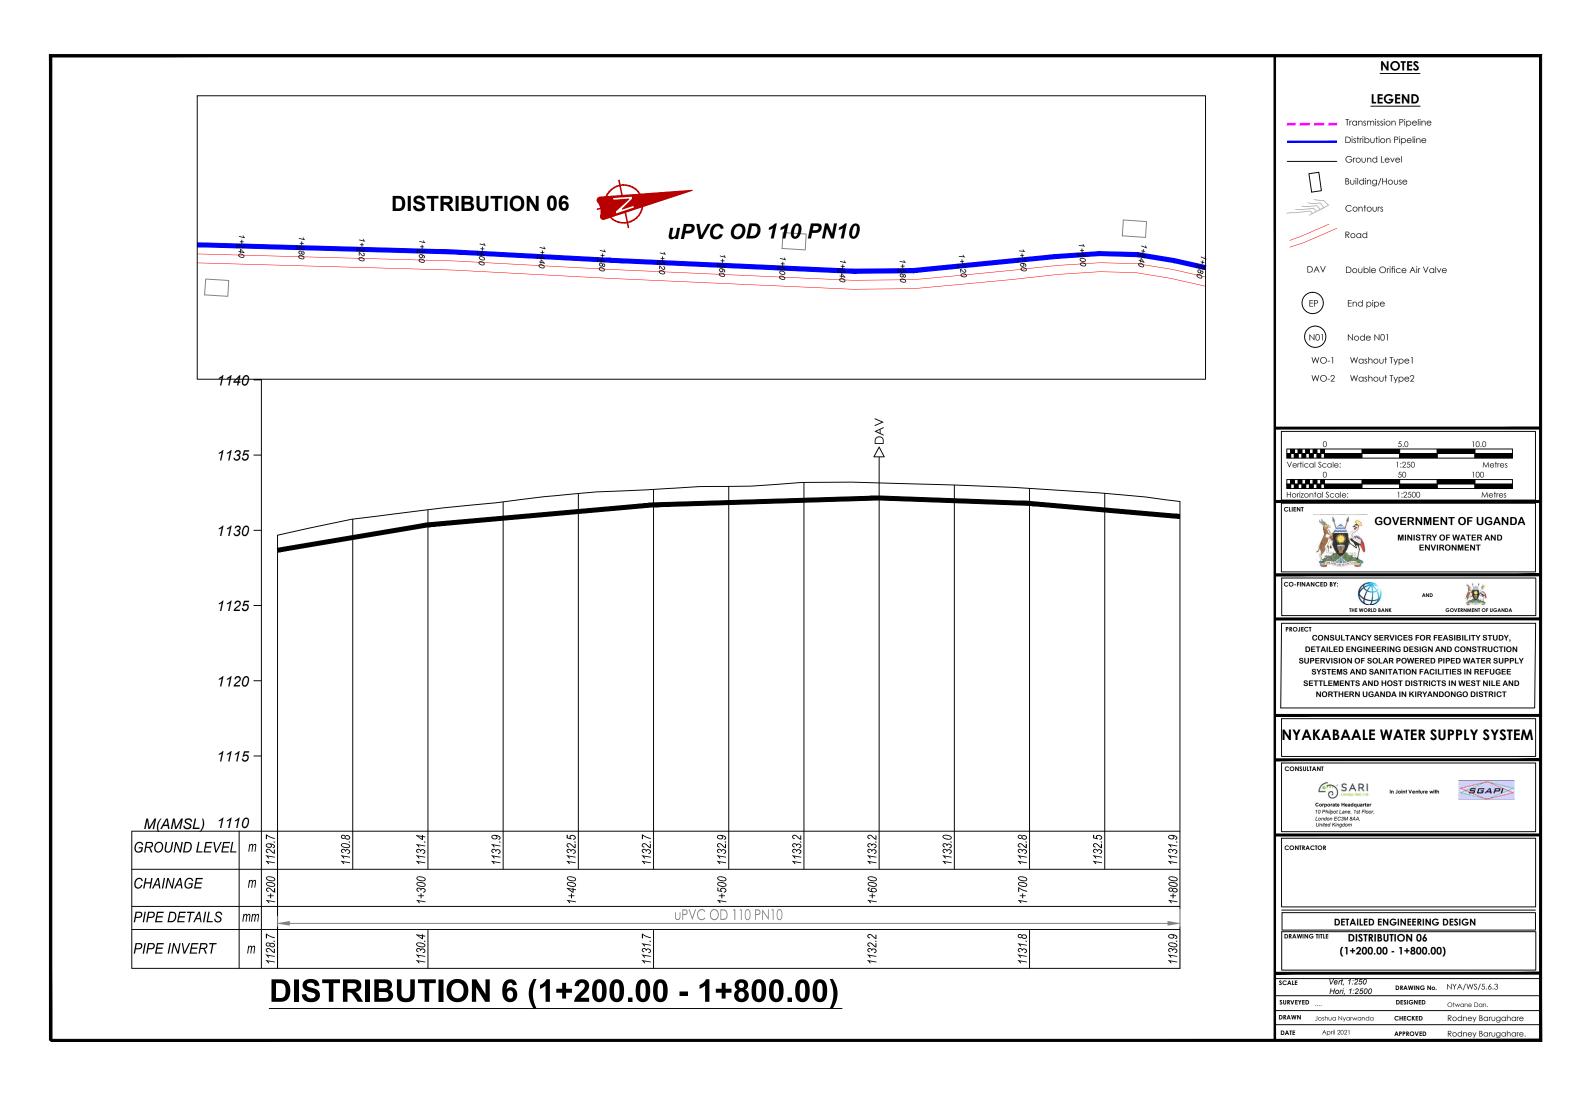


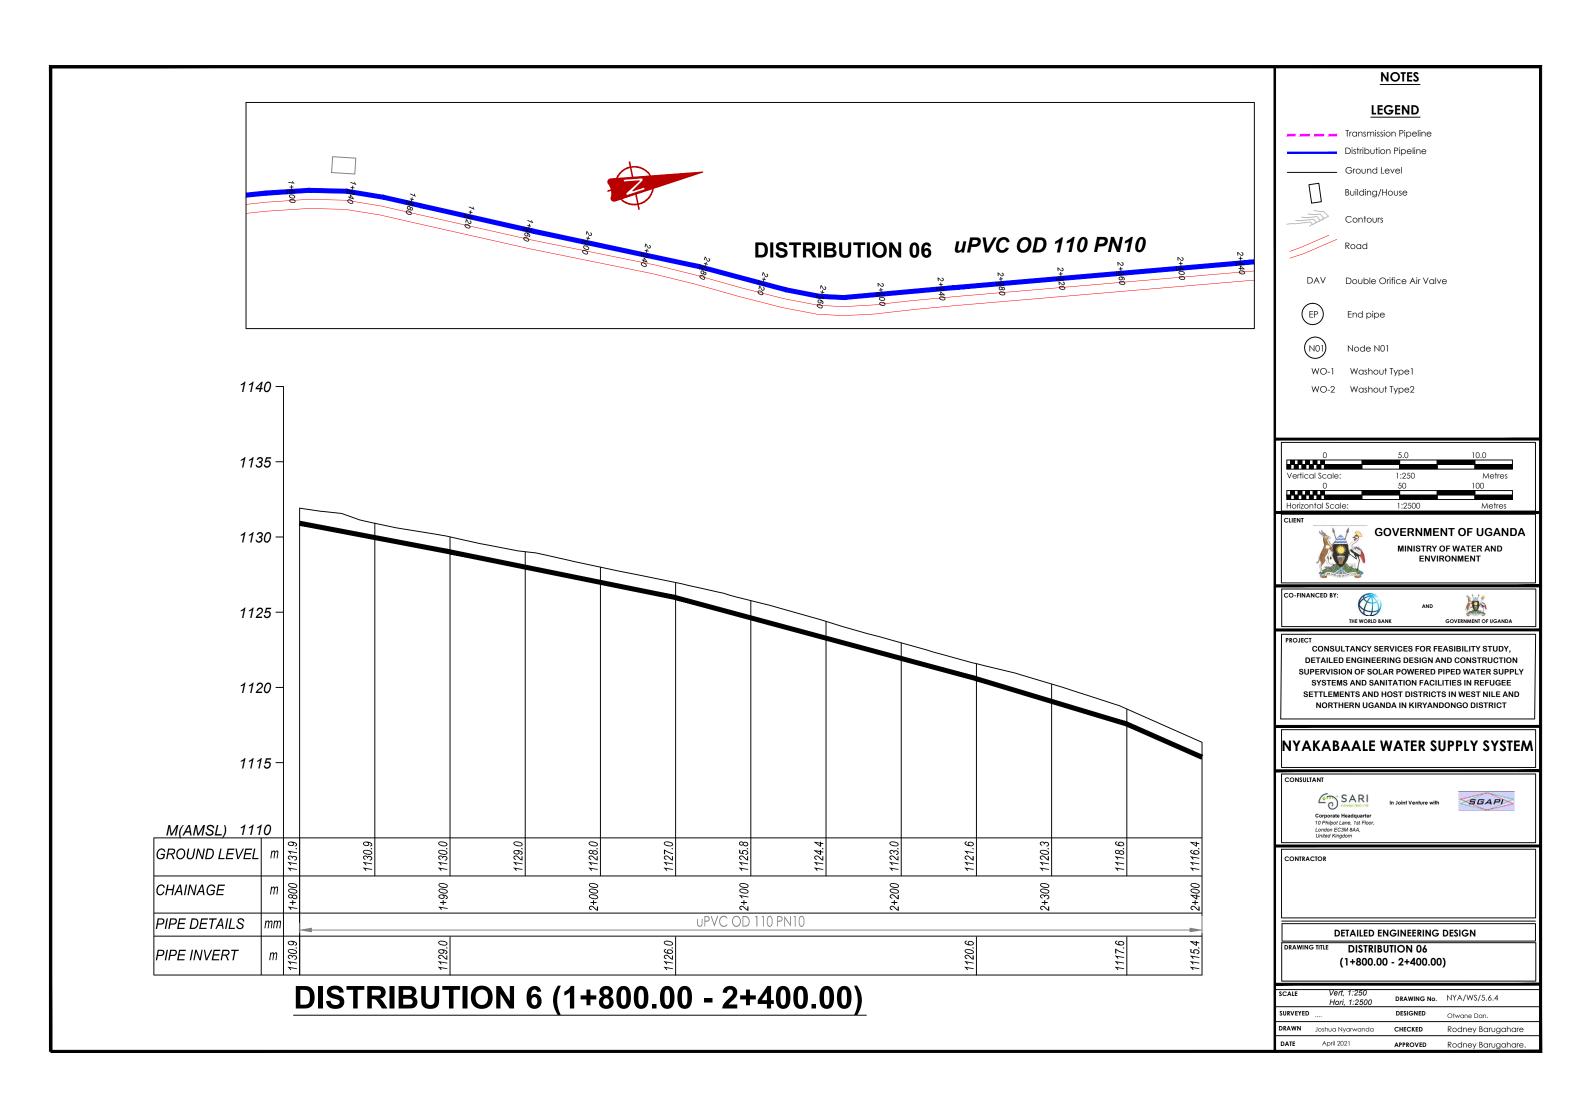


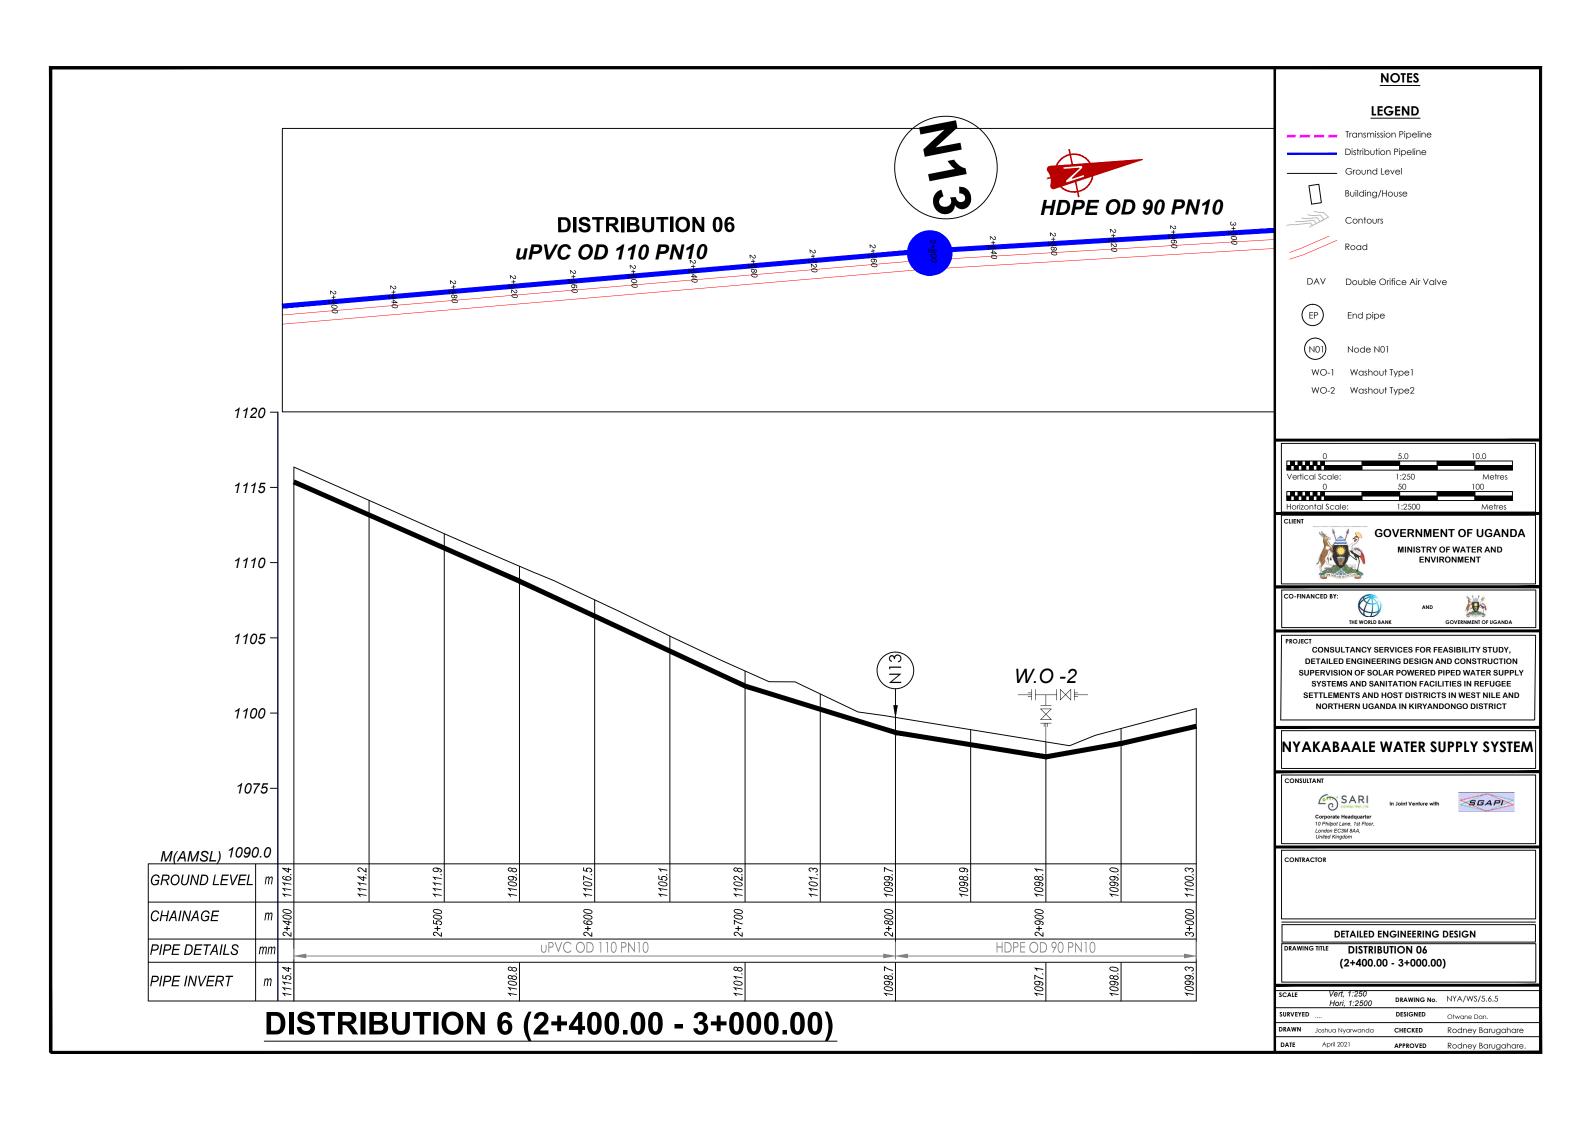


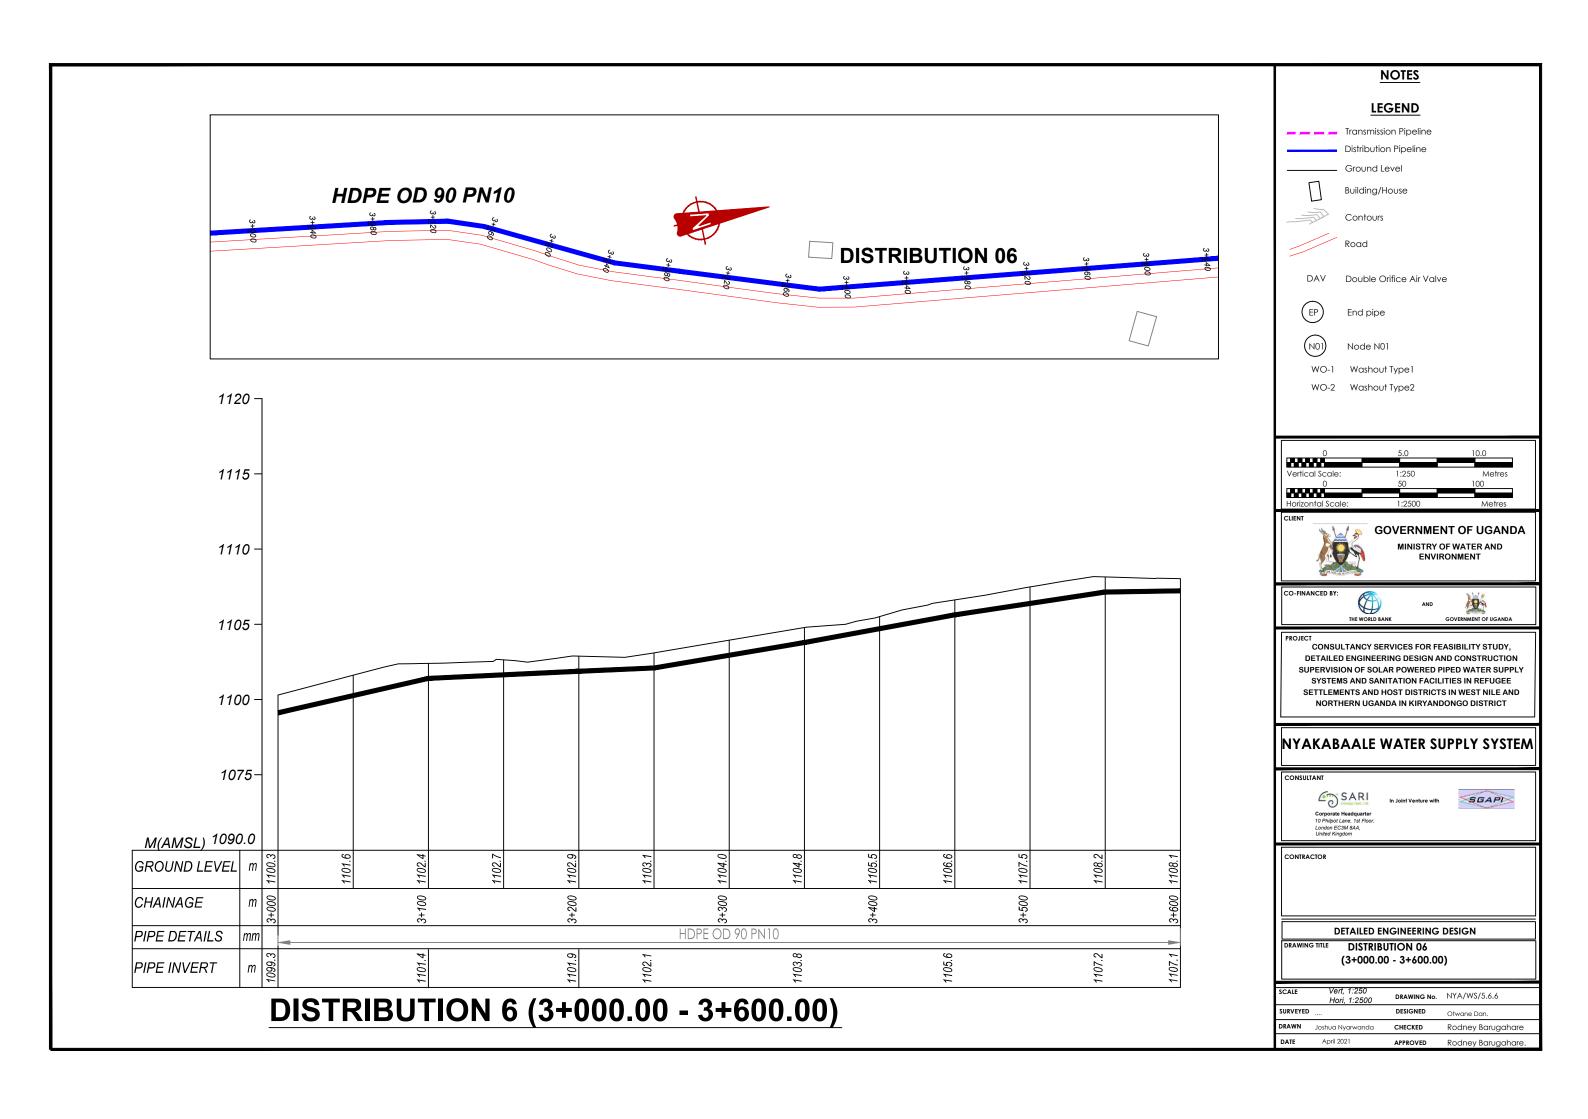

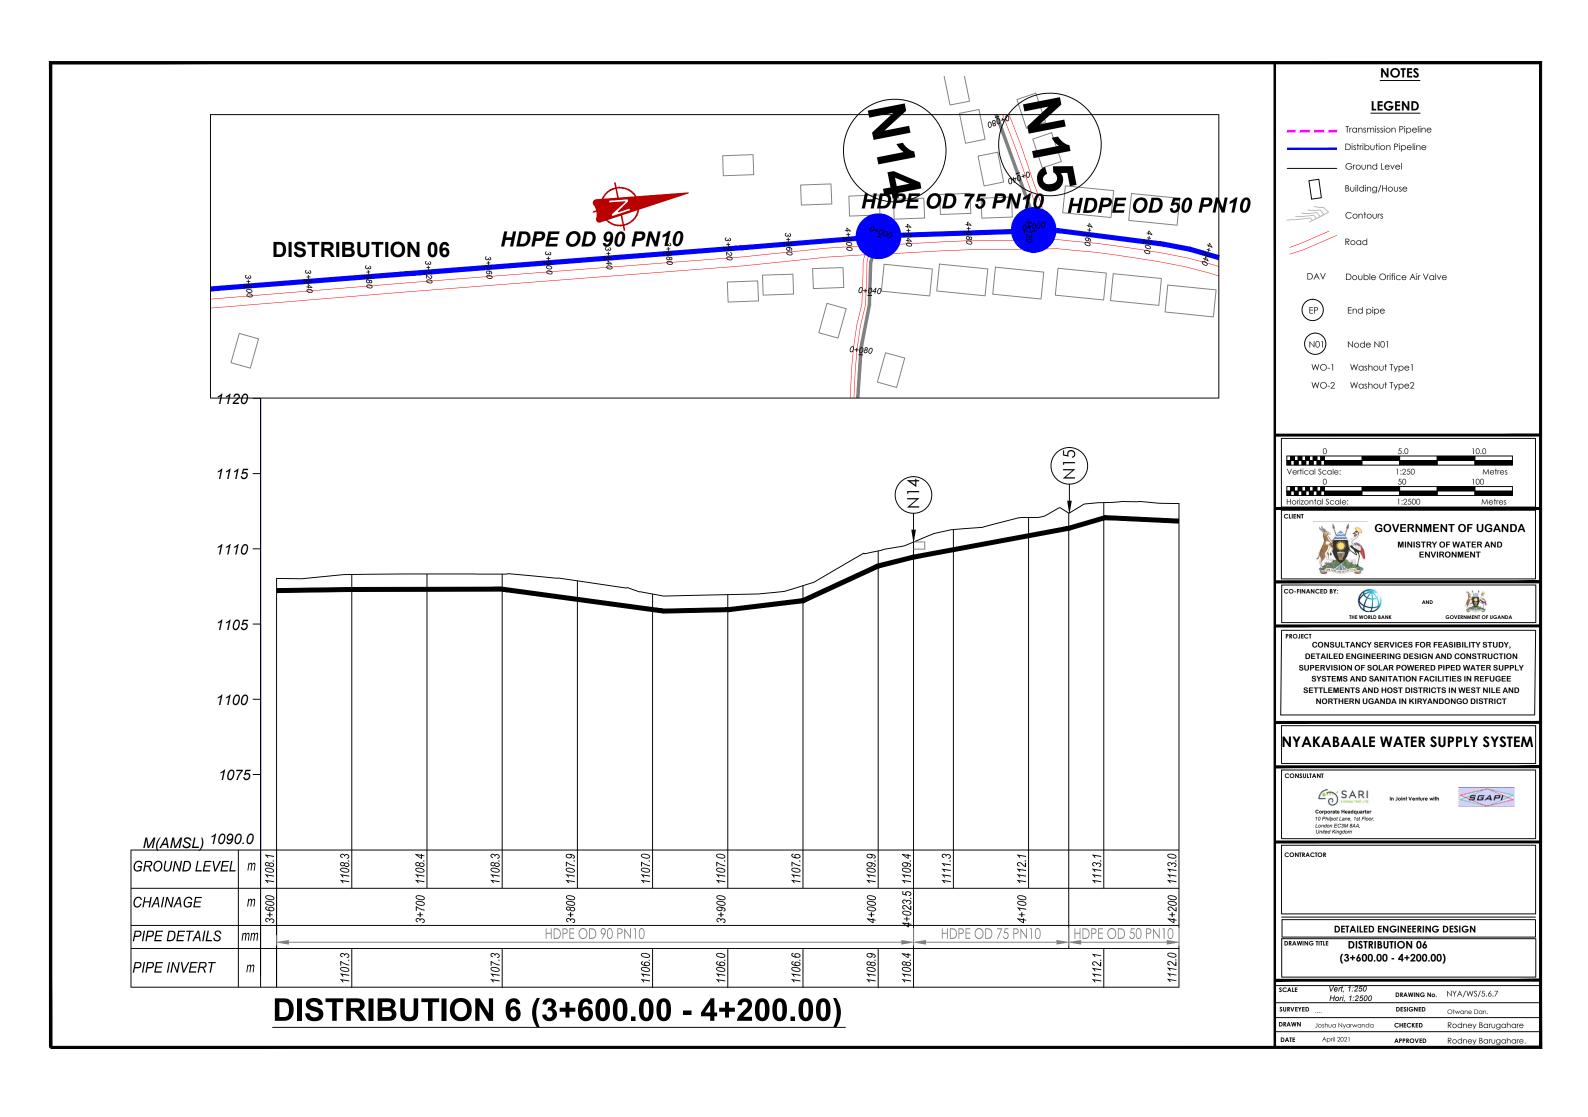


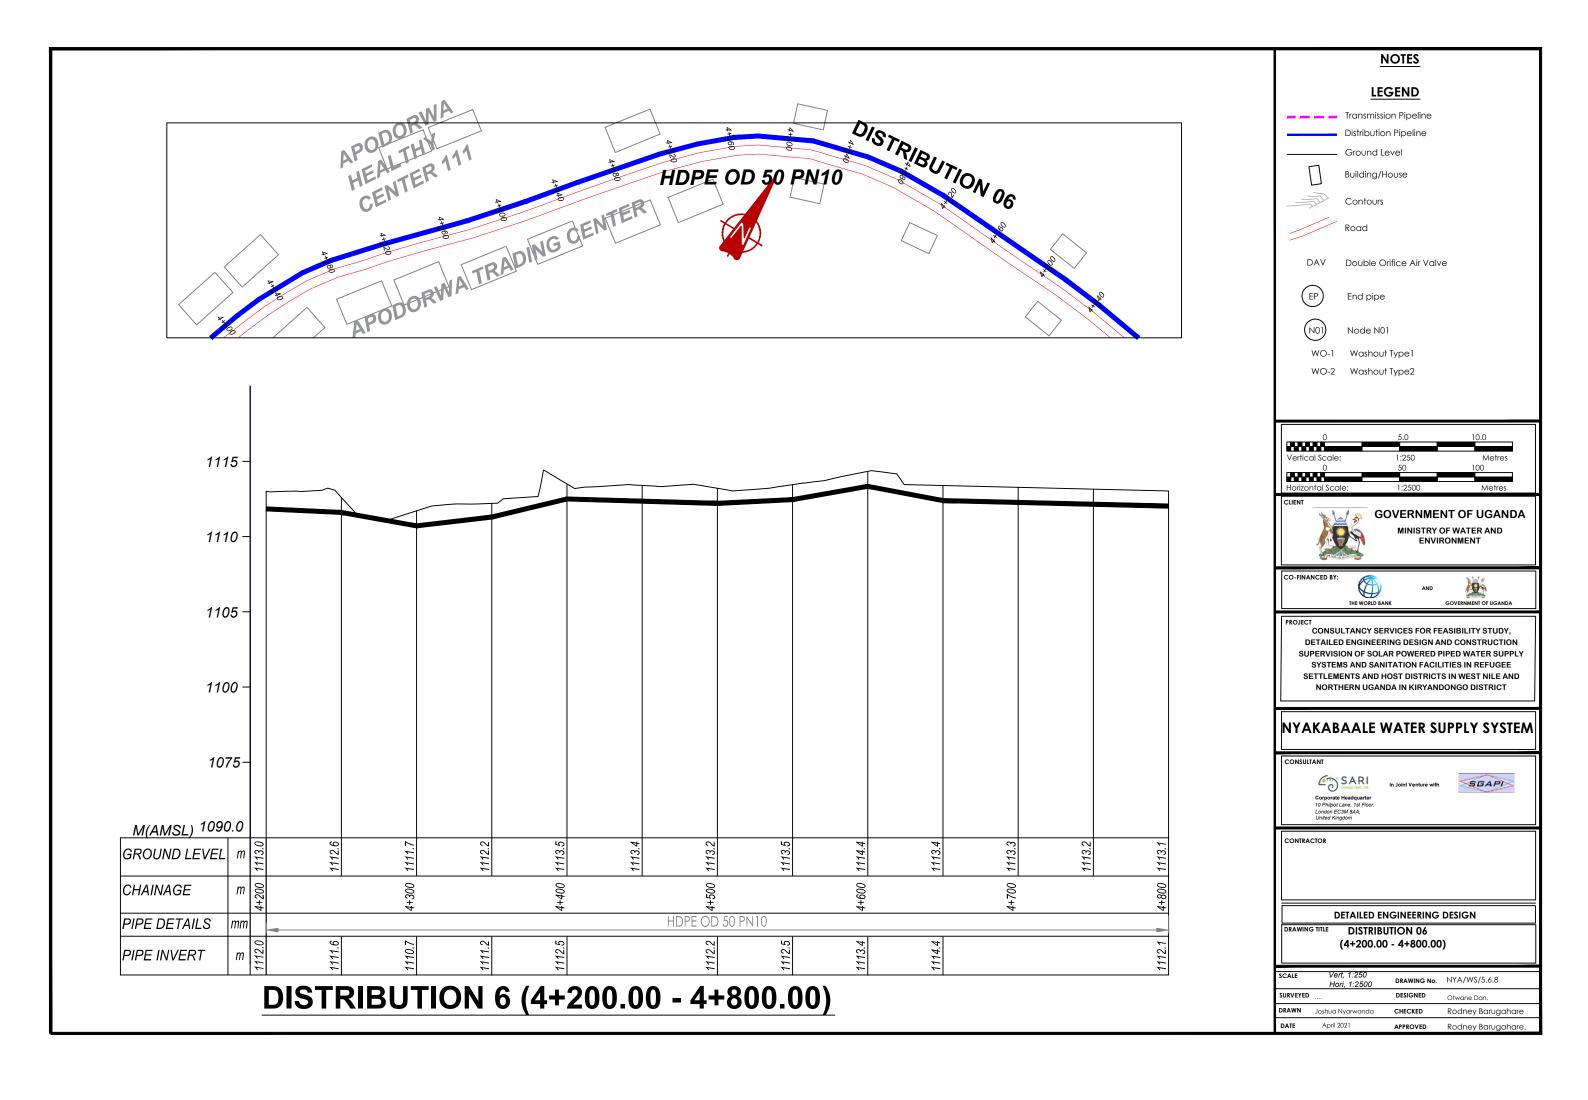

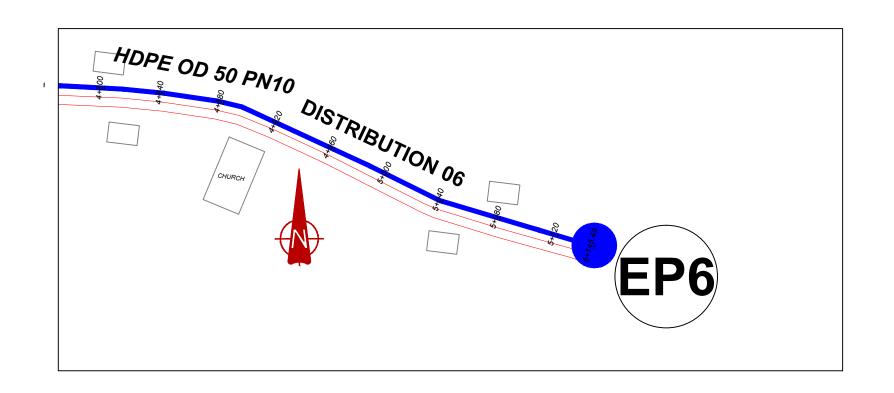

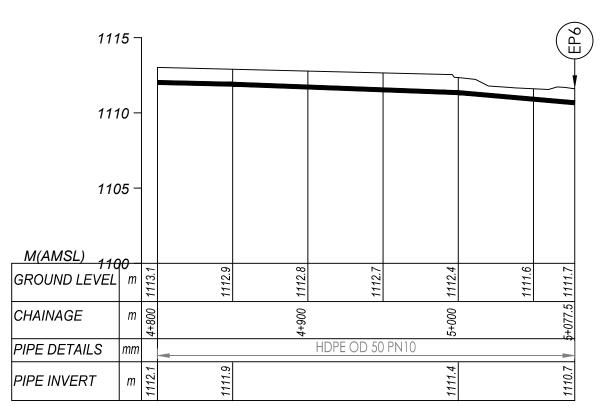


DISTRIBUTION 6 (4+800.00 - 5+077.50)

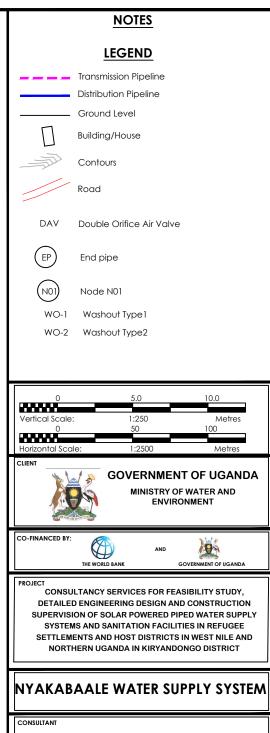





	DETAILED ENGINEERING DESIGN	
DRAWING TITLE	DISTRIBUTION 06	
	(4+800.00 - 5+077.50)	

SCALE	Vert, 1:250 Hori, 1:2500	DRAWING No.	NYA/WS/5.6.9
SURVEYED	·	DESIGNED	Otwane Dan.
DRAWN	Joshua Nyarwanda	CHECKED	Rodney Barugahare
DATE	April 2021	APPROVED	Rodney Barugahare.

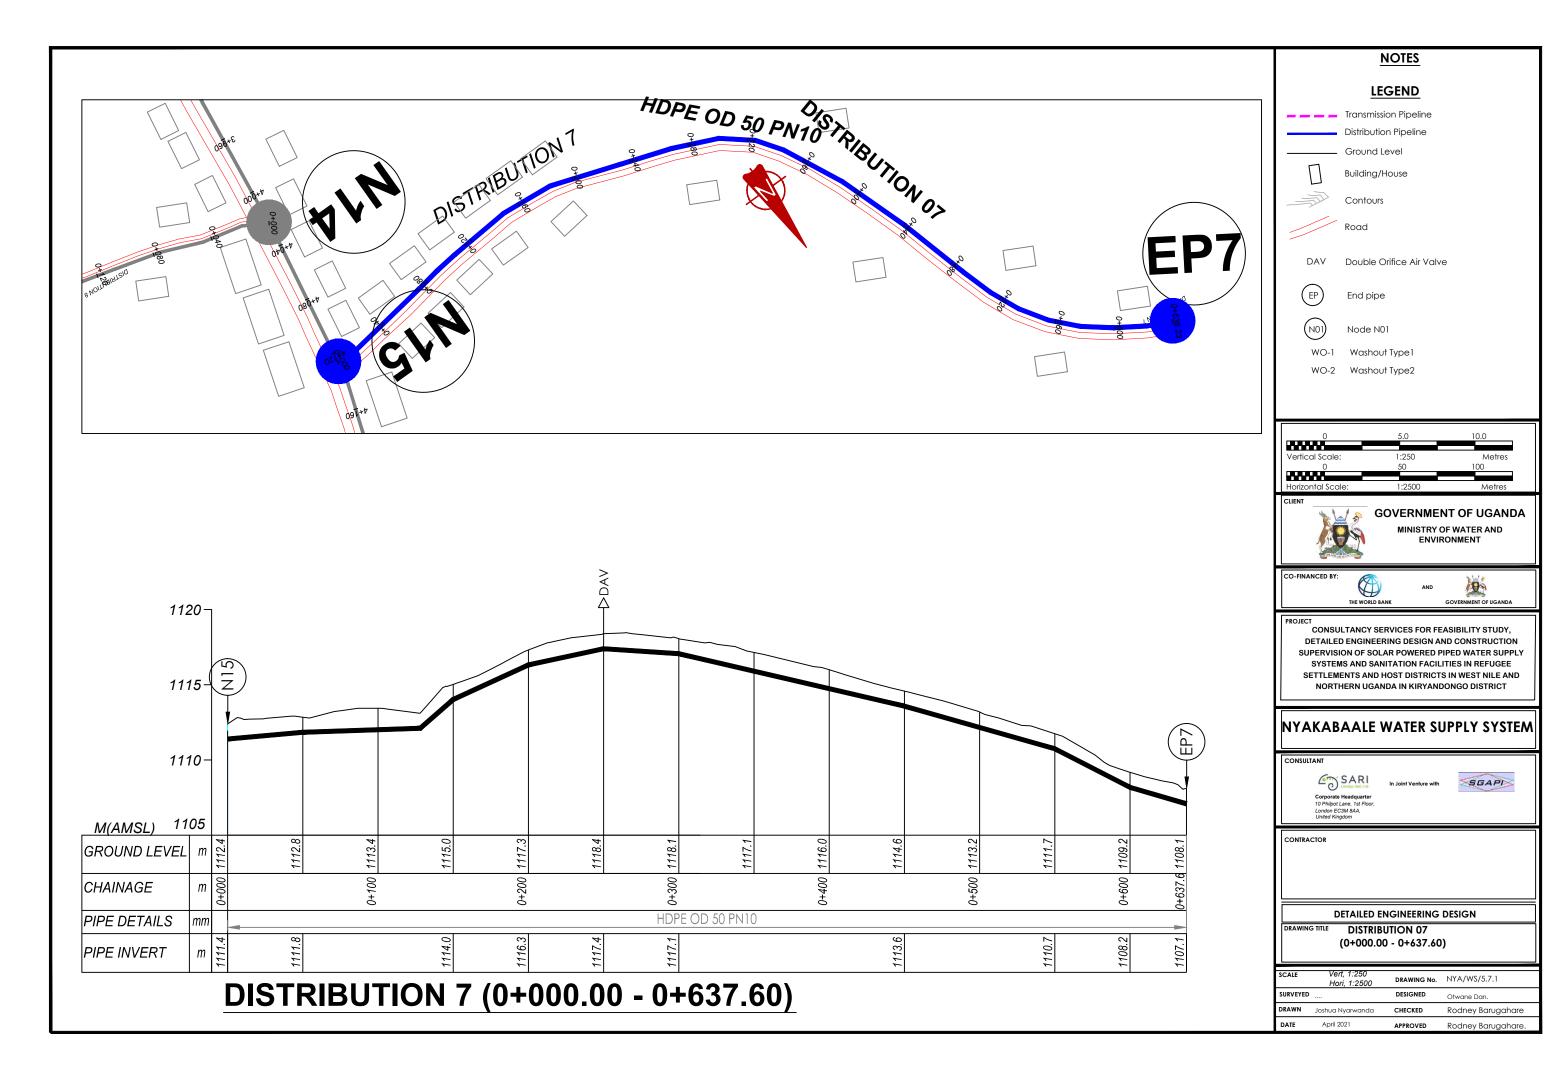

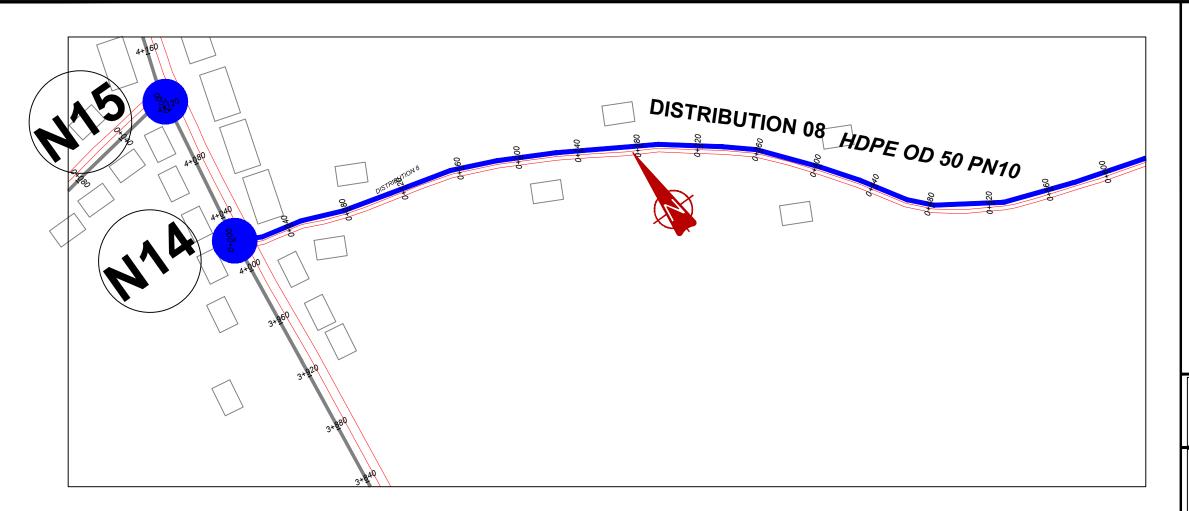

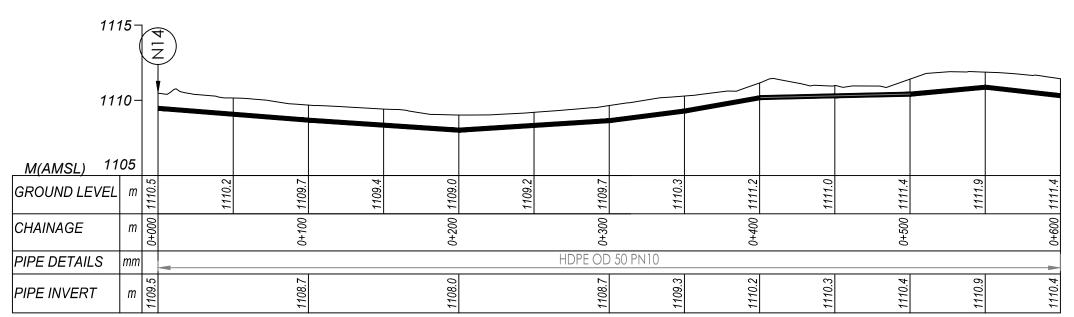

DISTRIBUTION 8 (0+000.00 - 0+600.00)


NOTES LEGEND Transmission Pipeline Distribution Pipeline Ground Level Building/House Contours Road DAV Double Orifice Air Valve End pipe Node N01 WO-1 Washout Type 1 WO-2 Washout Type2 **GOVERNMENT OF UGANDA** MINISTRY OF WATER AND ENVIRONMENT CONSULTANCY SERVICES FOR FEASIBILITY STUDY, DETAILED ENGINEERING DESIGN AND CONSTRUCTION SUPERVISION OF SOLAR POWERED PIPED WATER SUPPLY SYSTEMS AND SANITATION FACILITIES IN REFUGEE SETTLEMENTS AND HOST DISTRICTS IN WEST NILE AND NORTHERN UGANDA IN KIRYANDONGO DISTRICT


NYAKABAALE WATER SUPPLY SYSTEM



L	DETAILED ENGINEERING DESIGN					
ſ	RAWING TITLE	DISTRIBUTION 08				
		(0+000.00 - 0+600.00)				

Ì	SCALE	Vert, 1:250 Hori, 1:2500	DRAWING No.	NYA/WS/5.8.1
	SURVEYED		DESIGNED	Otwane Dan.
	DRAWN	Joshua Nyarwanda	CHECKED	Rodney Barugahare
	DATE	April 2021	APPROVED	Rodney Barugahare.

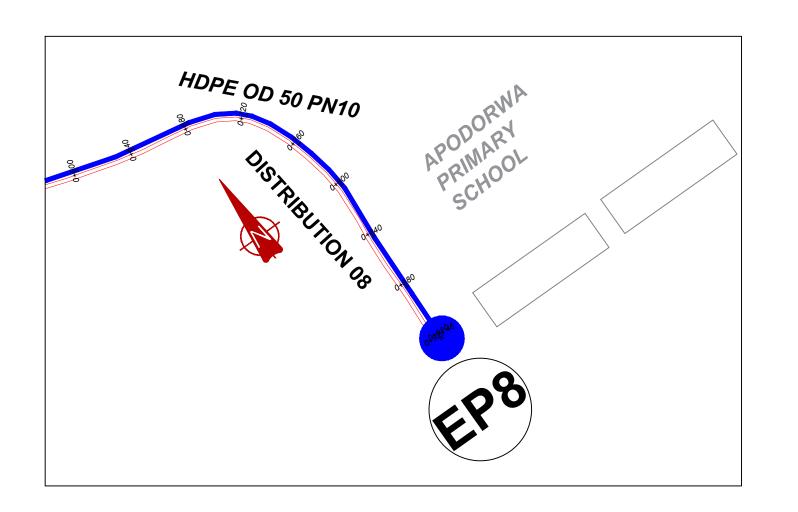

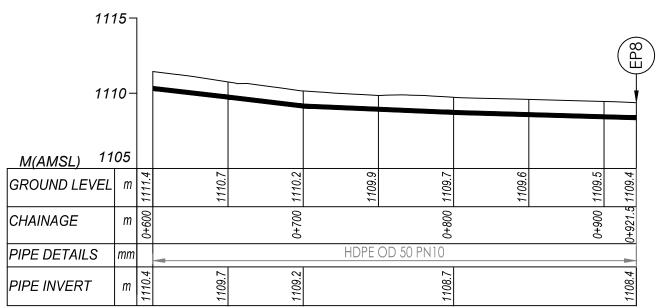

DISTRIBUTION 8 (0+600.00 - 0+921.50)

NOTES LEGEND Transmission Pipeline Distribution Pipeline Ground Level Building/House Contours Road DAV Double Orifice Air Valve End pipe Node N01 WO-1 Washout Type 1 WO-2 Washout Type2 **GOVERNMENT OF UGANDA** MINISTRY OF WATER AND ENVIRONMENT CONSULTANCY SERVICES FOR FEASIBILITY STUDY, DETAILED ENGINEERING DESIGN AND CONSTRUCTION SYSTEMS AND SANITATION FACILITIES IN REFUGEE SETTLEMENTS AND HOST DISTRICTS IN WEST NILE AND NORTHERN UGANDA IN KIRYANDONGO DISTRICT

SUPERVISION OF SOLAR POWERED PIPED WATER SUPPLY


NYAKABAALE WATER SUPPLY SYSTEM


SARI CONSULTING LTD SGAPI

DISTRIBUTION 08 (0+600.00 - 0+921.50)

SCALE	Vert, 1:250 Hori, 1:2500	DRAWING No.	NYA/WS/5.8.2
SURVEYED	·	DESIGNED	Otwane Dan.
DRAWN	Joshua Nyarwanda	CHECKED	Rodney Barugahare
DATE	April 2021	APPROVED	Rodney Barugahare.

DETAILED ENGINEERING DESIGN

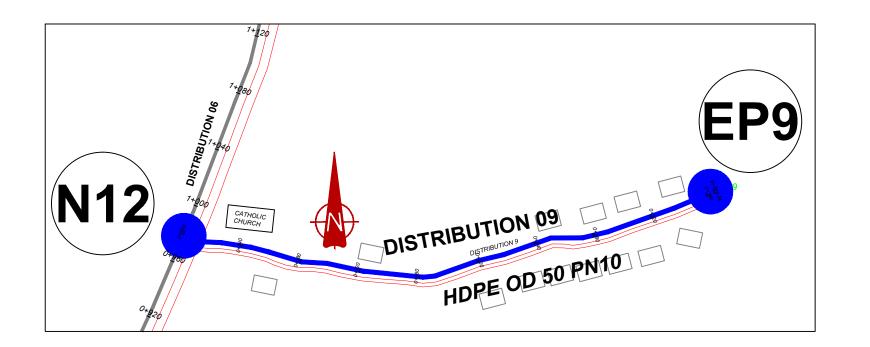

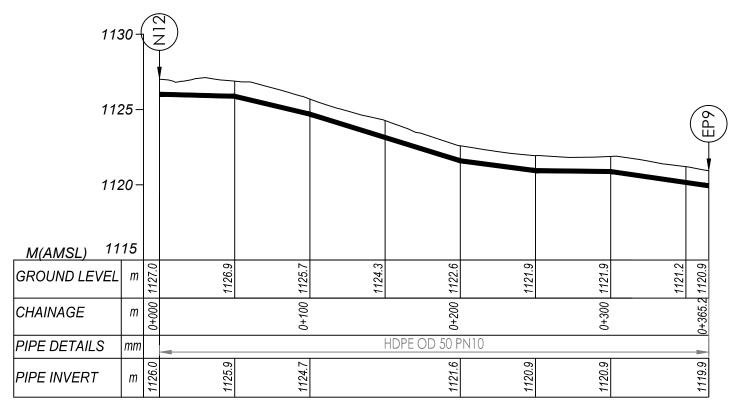

DISTRIBUTION 9 (0+000.00 - 0+365.20)

LEGEND Transmission Pipeline Distribution Pipeline Ground Level Building/House Contours Road DAV Double Orifice Air Valve EP End pipe NO) Node NO1 WO-1 Washout Type1 WO-2 Washout Type2 0 5.0 10.0 Vertical Scale: 1:250 Metres 0 50 100 Horizontal Scale: 1:2500 Metres CLIENT GOVERNMENT OF UGANDA



THE WORL

DIECT
CONSULTANCY SERVICES FOR FEASIBILITY STUDY,
DETAILED ENGINEERING DESIGN AND CONSTRUCTION
SUPERVISION OF SOLAR POWERED PIPED WATER SUPPLY
SYSTEMS AND SANITATION FACILITIES IN REFUGEE
SETTLEMENTS AND HOST DISTRICTS IN WEST NILE AND

MINISTRY OF WATER AND ENVIRONMENT

NYAKABAALE WATER SUPPLY SYSTEM

NORTHERN UGANDA IN KIRYANDONGO DISTRICT

SARI COMPANIENCE STR

In Joint Venture with



CONTRACTO


DETAILED ENGINEERING DESIGN
WING TITLE DISTRIBUTION 09
(0+600.00 - 0+921.50)


 SCALE
 Vert, 1:250 Hori, 1:2500
 DRAWING No.
 NYA/WS/5.9.1

 SURVEYED

 DESIGNED
 Otwane Dan.

 DRAWN
 Joshua Nyarwanda
 CHECKED
 Rodney Barugahare

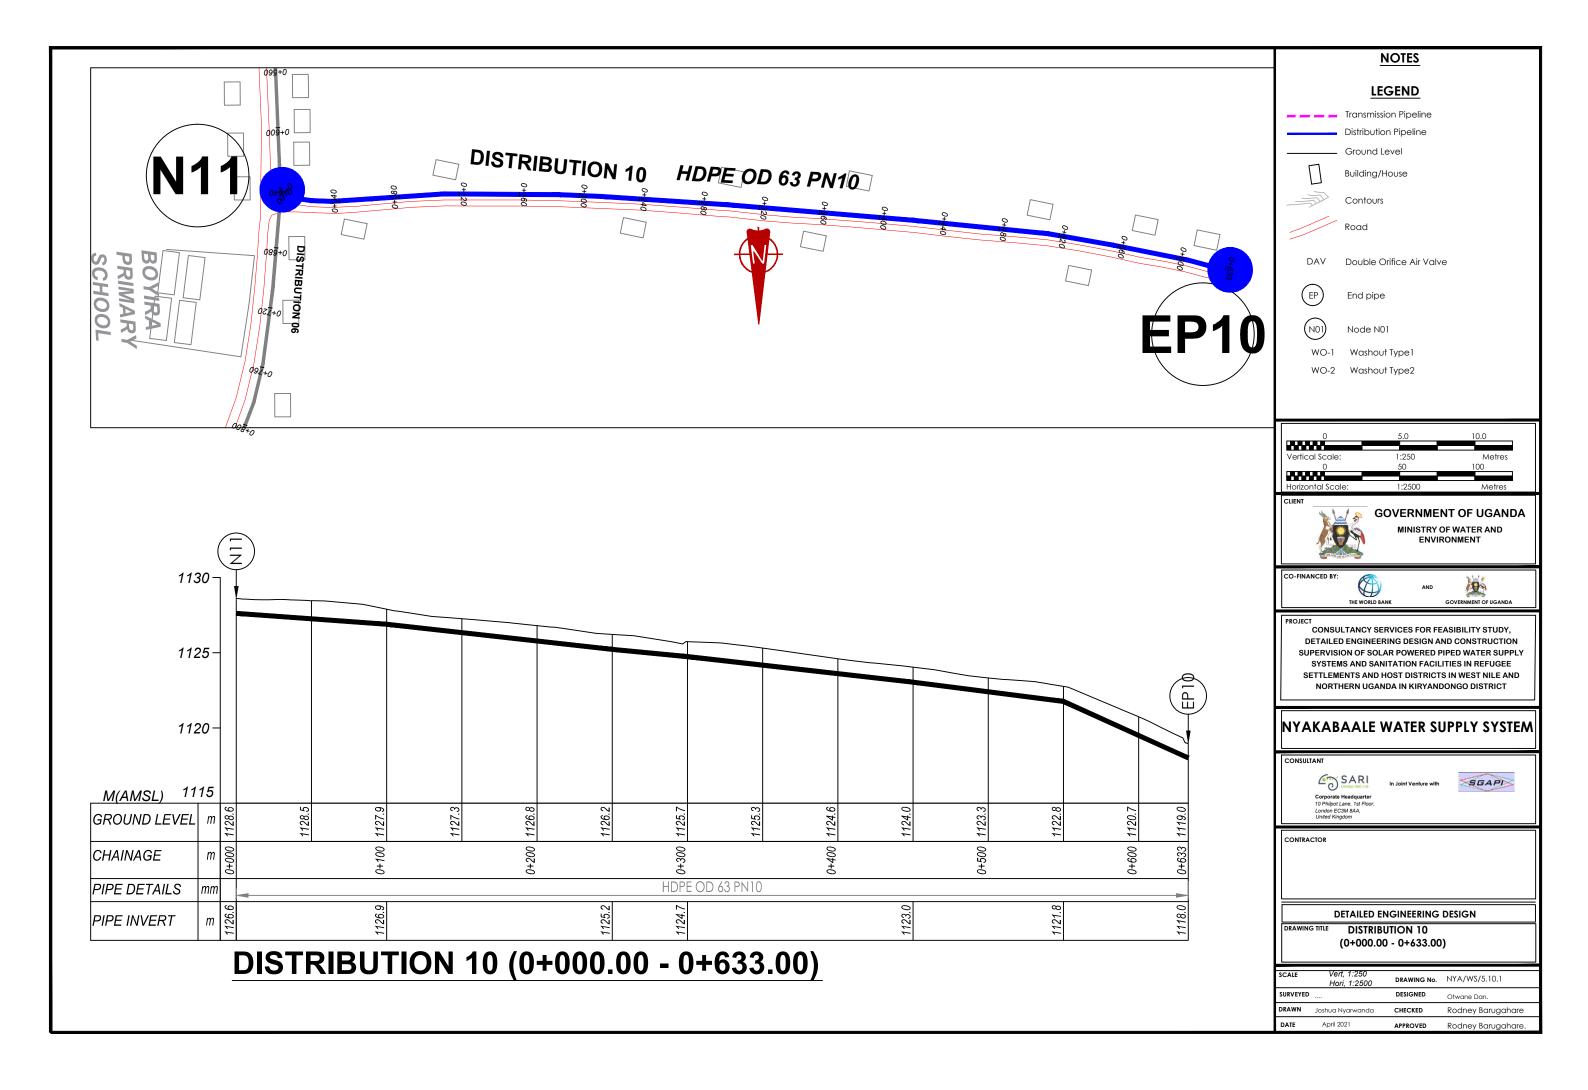

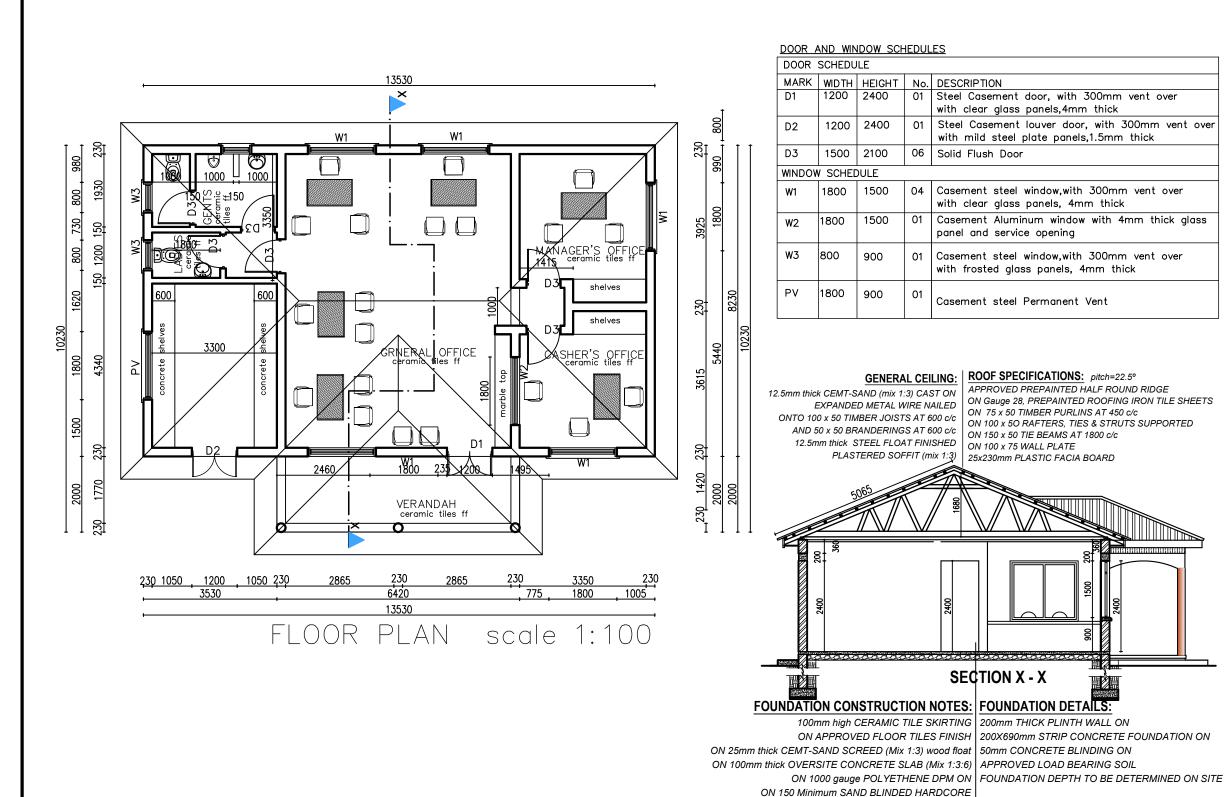

NOTES

- 1. All dimensions are in mm unless stated otherwise.
- 2. All levels are in metres above sea level.
- 3. For Site location see Dwg. GOD/0.0.0
- 4. Structural details are not included.
- 5. All structural concrete is Class 25/10.
- 6. All mass concrete is Class 15/10.



GOVERNMENT OF UGANDA MINISTRY OF WATER AND ENVIRONMENT





CONSULTANCY SERVICES FOR FEASIBILITY STUDY. DETAILED ENGINEERING DESIGN AND CONSTRUCTION SUPERVISION OF SOLAR POWERED PIPED WATER SUPPLY SYSTEMS AND SANITATION FACILITIES IN REFUGEE SETTLEMENTS AND HOST DISTRICTS IN WEST NILE AND

NYAKABAALE WATER SUPPLY SYSTEM

NORTHERN UGANDA IN KIRYANDONGO DISTRICT


SGAPI

DETAILED ENGINEERING DESIGN


ON COMPACTED EARTH / MURRAM

WATER OFFICE FLOOR PLAN & SECTION

SCALE	As Shown	DRAWING No.	NYA/WS/7.1
SURVEYED		DESIGNED	Otwane Dan.
DRAWN	Joshua Nyarwanda	CHECKED	Rodney Barugahare
DATE	OCT 2021	APPROVED	Rodney Barugahare.

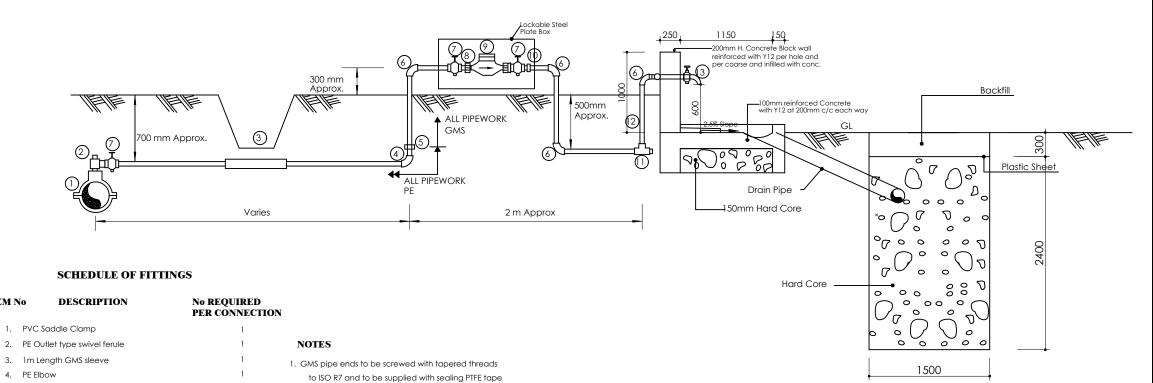

SECTION A-A

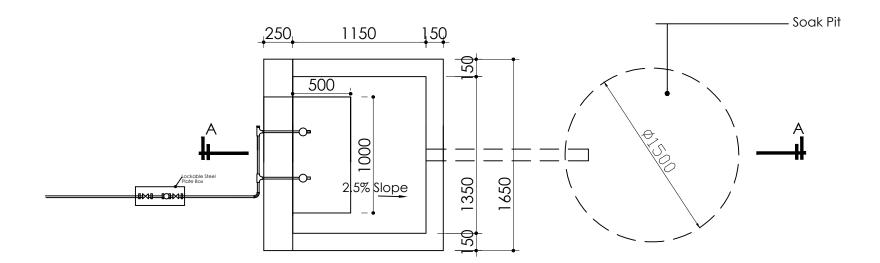

Standpost With 2 No. Faucets PLAN

2. GMS pipe fittings to be malleable cast iron to BS 143 and BS 1256 with female threaded ends

permit removal at the meter

5. Diameter of pipe varies

4. All PE connections shall be of the push fit type

The adjusting coupling shall be made of bronze or brass with a threaded female connection at the outlet end. It shall incorporate sufficient adjustment to

ITEM No

5. PE/GMS Adaptor

8. Male threaded connector

6. GMS Elbow

9. Water meter

10. Adjusting coupling 11. GMS equal tee 12. Plug 13. Tap

7. Stop tap

NOTES

- 1. For site location see dwg. NYA/WS/0.0.0
- 2. All levels in metres above mean sea level
- 3. Unless otherwise stated, all dimensions are in mm
- 4. Check all dimensions and elevations on site



GOVERNMENT OF UGANDA

MINISTRY OF WATER AND ENVIRONMENT





CONSULTANCY SERVICES FOR FEASIBILITY STUDY, DETAILED ENGINEERING DESIGN AND CONSTRUCTION SUPERVISION OF SOLAR POWERED PIPED WATER SUPPLY SYSTEMS AND SANITATION FACILITIES IN REFUGEE SETTLEMENTS AND HOST DISTRICTS IN WEST NILE AND NORTHERN UGANDA IN KIRYANDONGO DISTRICT

NYAKABAALE WATER SUPPLY SYSTEM






CONTRACTOR

DETAILED ENGINEERING DESIGN

PUBLIC STAND POST CONNECTION AND SOAK PIT DETAILS

SCALE		DRAWING No.	NYA/WS/8.1.1
SURVEYED		DESIGNED	Otwane Dan.
DRAWN	Joshua Nyarwanda	CHECKED	Rodney Barugahare
DATE	OCT 2021	APPROVED	Rodney Barugahare.

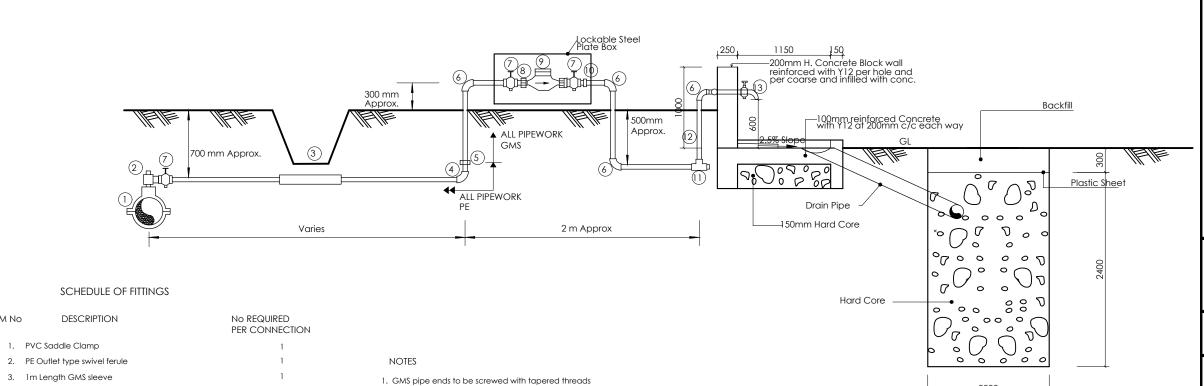

to ISO R7 and to be supplied with sealing PTFE tape

The adjusting coupling shall be made of bronze or brass with a threaded female connection at the outlet end. It shall incorporate sufficient adjustment to permit removal at the meter

2. GMS pipe fittings to be malleable cast iron to BS 143

and BS 1256 with female threaded ends

4. All PE connections shall be of the push fit type

5. Diameter of pipe varies

ITEM No

1. PVC Saddle Clamp

3. 1m Length GMS sleeve

8. Male threaded connector

10. Adjusting coupling 11. GMS equal tee 12. Plug

5. PE/GMS Adaptor

4. PE Elbow

6. GMS Elbow

Stop tap

13. Tap

NOTES

- 1. For site location see dwg. NYA/WS/0.0.0
- 2. All levels in metres above mean sea level
- 3. Unless otherwise stated, all dimensions are in mm
- 4. Check all dimensions and elevations on site

GOVERNMENT OF UGANDA

MINISTRY OF WATER AND ENVIRONMENT





2000

CONSULTANCY SERVICES FOR FEASIBILITY STUDY, DETAILED ENGINEERING DESIGN AND CONSTRUCTION SUPERVISION OF SOLAR POWERED PIPED WATER SUPPLY SYSTEMS AND SANITATION FACILITIES IN REFUGEE SETTLEMENTS AND HOST DISTRICTS IN WEST NILE AND NORTHERN UGANDA IN KIRYANDONGO DISTRICT

NYAKABAALE WATER SUPPLY SYSTEM







CONTRACTOR


DETAILED ENGINEERING DESIGN

TYPICAL YARD CONNECTION CONNECTION AND SOAK PIT DETAILS

SCALE	As Shown	DRAWING No.	NYA/W/8.1.2
SURVEYED		DESIGNED	Otwane Dan.
DRAWN	Joshua Nyarwanda	CHECKED	Rodney Barugahare
DATE	OCT 2021	APPROVED	Rodney Barugahare.

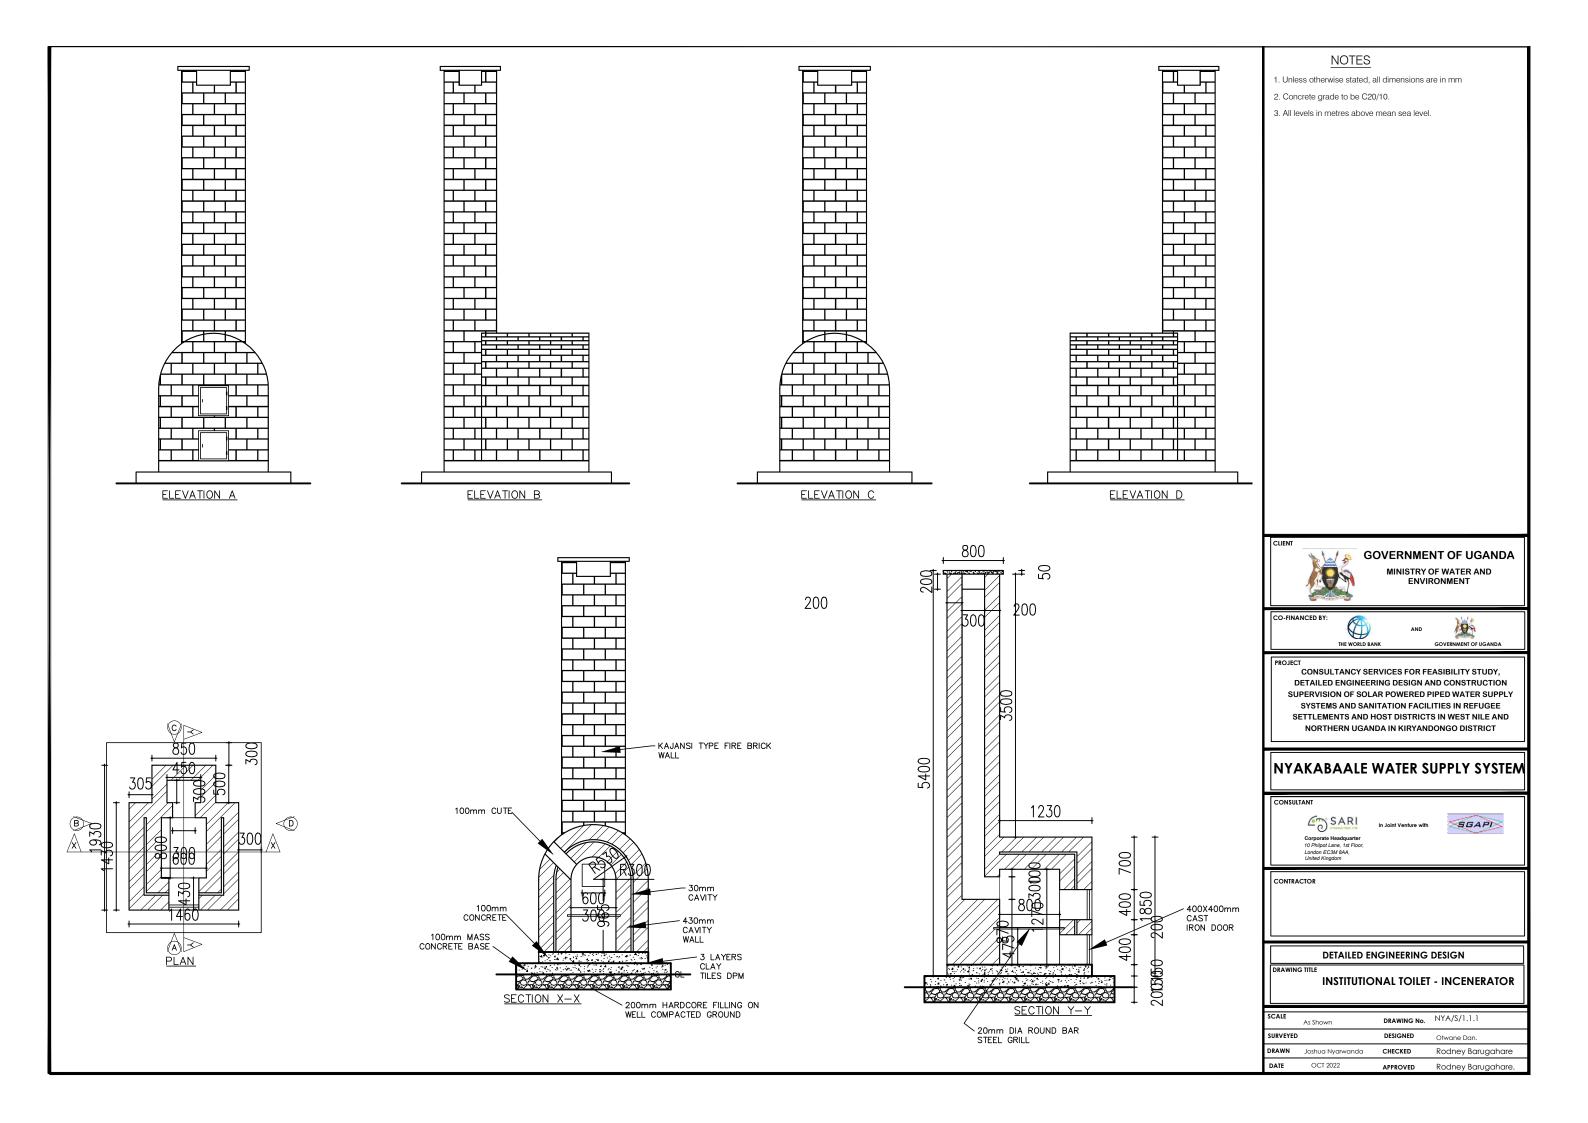

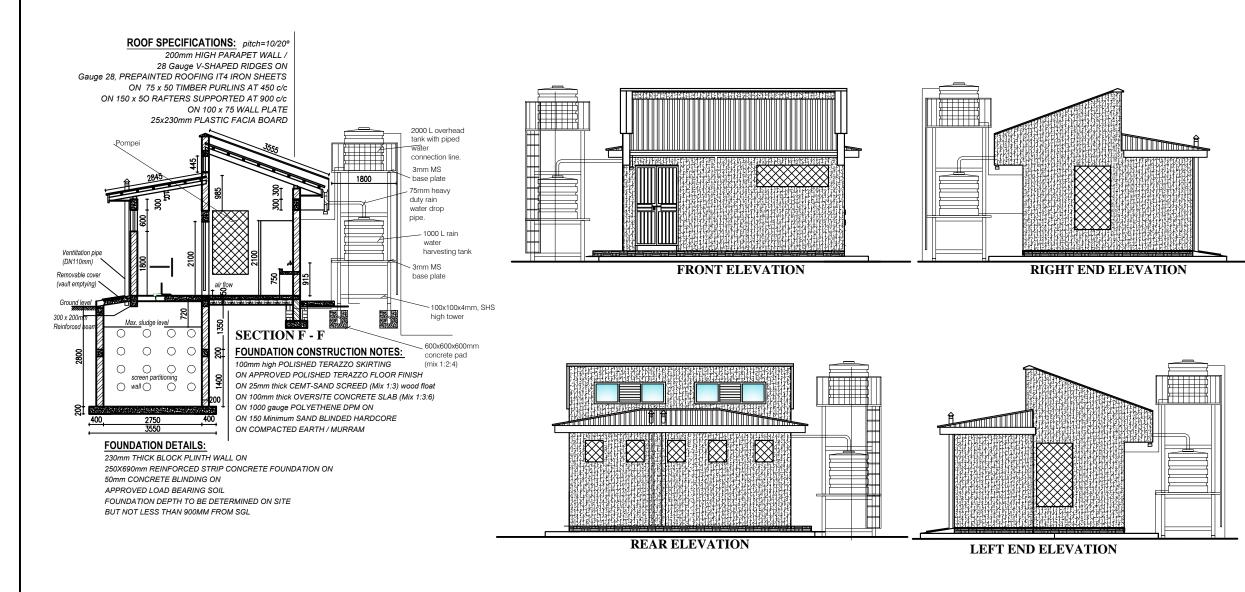

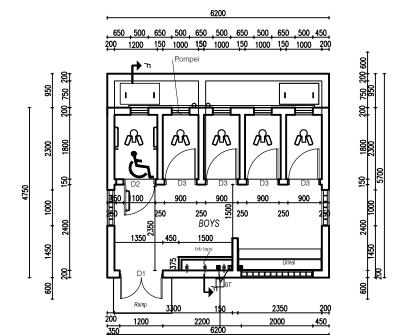

FLOOR PLAN



NOTES

- 1. Unless otherwise stated, all dimensions are in mm
- 2. Concrete grade to be C20/10.
- 3. All levels in metres above mean sea level.



GOVERNMENT OF UGANDA

MINISTRY OF WATER AND ENVIRONMENT

CO-FINANCED BY





CONSULTANCY SERVICES FOR FEASIBILITY STUDY,
DETAILED ENGINEERING DESIGN AND CONSTRUCTION
SUPERVISION OF SOLAR POWERED PIPED WATER SUPPLY
SYSTEMS AND SANITATION FACILITIES IN REFUGEE
SETTLEMENTS AND HOST DISTRICTS IN WEST NILE AND
NORTHERN UGANDA IN KIRYANDONGO DISTRICT

NYAKABAALE WATER SUPPLY SYSTEM

CONSULTANT

Corporate Headquarter
10 Philipot Lane, 1st Floor,
London ECSM 8AA,
United Kingdom

In Joint Venture with



ONTRACTOR

DETAILED ENGINEERING DESIGN


INSTITUTIONAL TOILET - BOYS


SCALE AS Shown DRAWING No. NYA/S/1.1.2

SURVEYED DESIGNED Otwane Dan.

DRAWN Joshua Nyarwanda CHECKED Rodney Barugahare


DATE OCT 2022 APPROVED Rodney Barugahare.

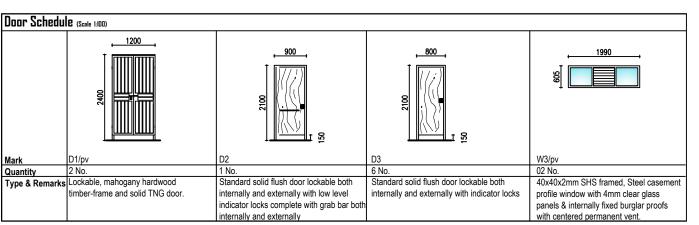

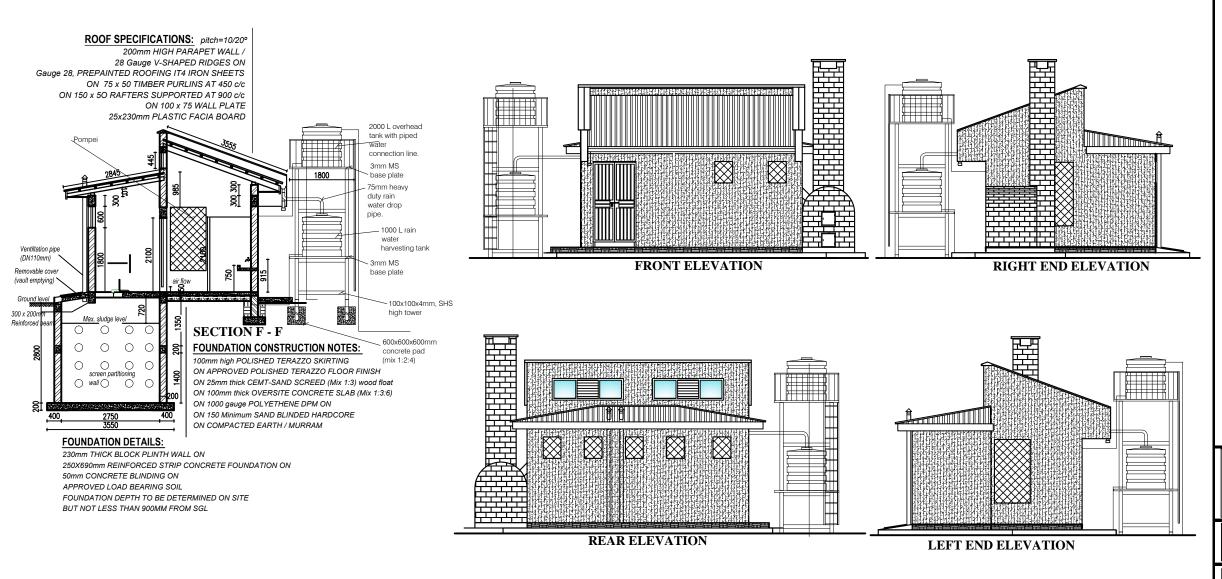

650 500 650 500 650 500 650 500 450 200 1200 150 1000 150 1000 150 1000 200 Pompei

FLOOR PLAN

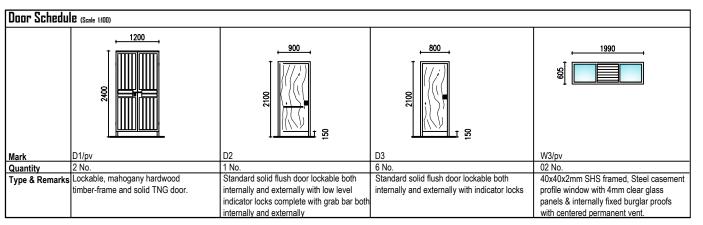

DOOR AND WINDOW SCHEDULE

NOTES

- 1. Unless otherwise stated, all dimensions are in mm
- 2. Concrete grade to be C20/10.
- 3. All levels in metres above mean sea level.



GOVERNMENT OF UGANDA

MINISTRY OF WATER AND ENVIRONMENT

CO-FINANCED BY



No.

BBO JECT

CONSULTANCY SERVICES FOR FEASIBILITY STUDY,
DETAILED ENGINEERING DESIGN AND CONSTRUCTION
SUPERVISION OF SOLAR POWERED PIPED WATER SUPPLY
SYSTEMS AND SANITATION FACILITIES IN REFUGEE
SETTLEMENTS AND HOST DISTRICTS IN WEST NILE AND
NORTHERN UGANDA IN KIRYANDONGO DISTRICT

NYAKABAALE WATER SUPPLY SYSTEM

CONSULTAN

Corporate Headquarter
10 Philipot Lane. 1st Floor

In Joint Venture with




CONTRACTOR


DETAILED ENGINEERING DESIGN


G TITLE

INSTITUTIONAL TOILET - GIRLS


SCALE	As Shown	DRAWING No.	NYA/S/1.1.3
SURVEYED		DESIGNED	Otwane Dan.
DRAWN	Joshua Nyarwanda	CHECKED	Rodney Barugahare
DATE	OCT 2022	APPROVED	Rodney Barugahare.

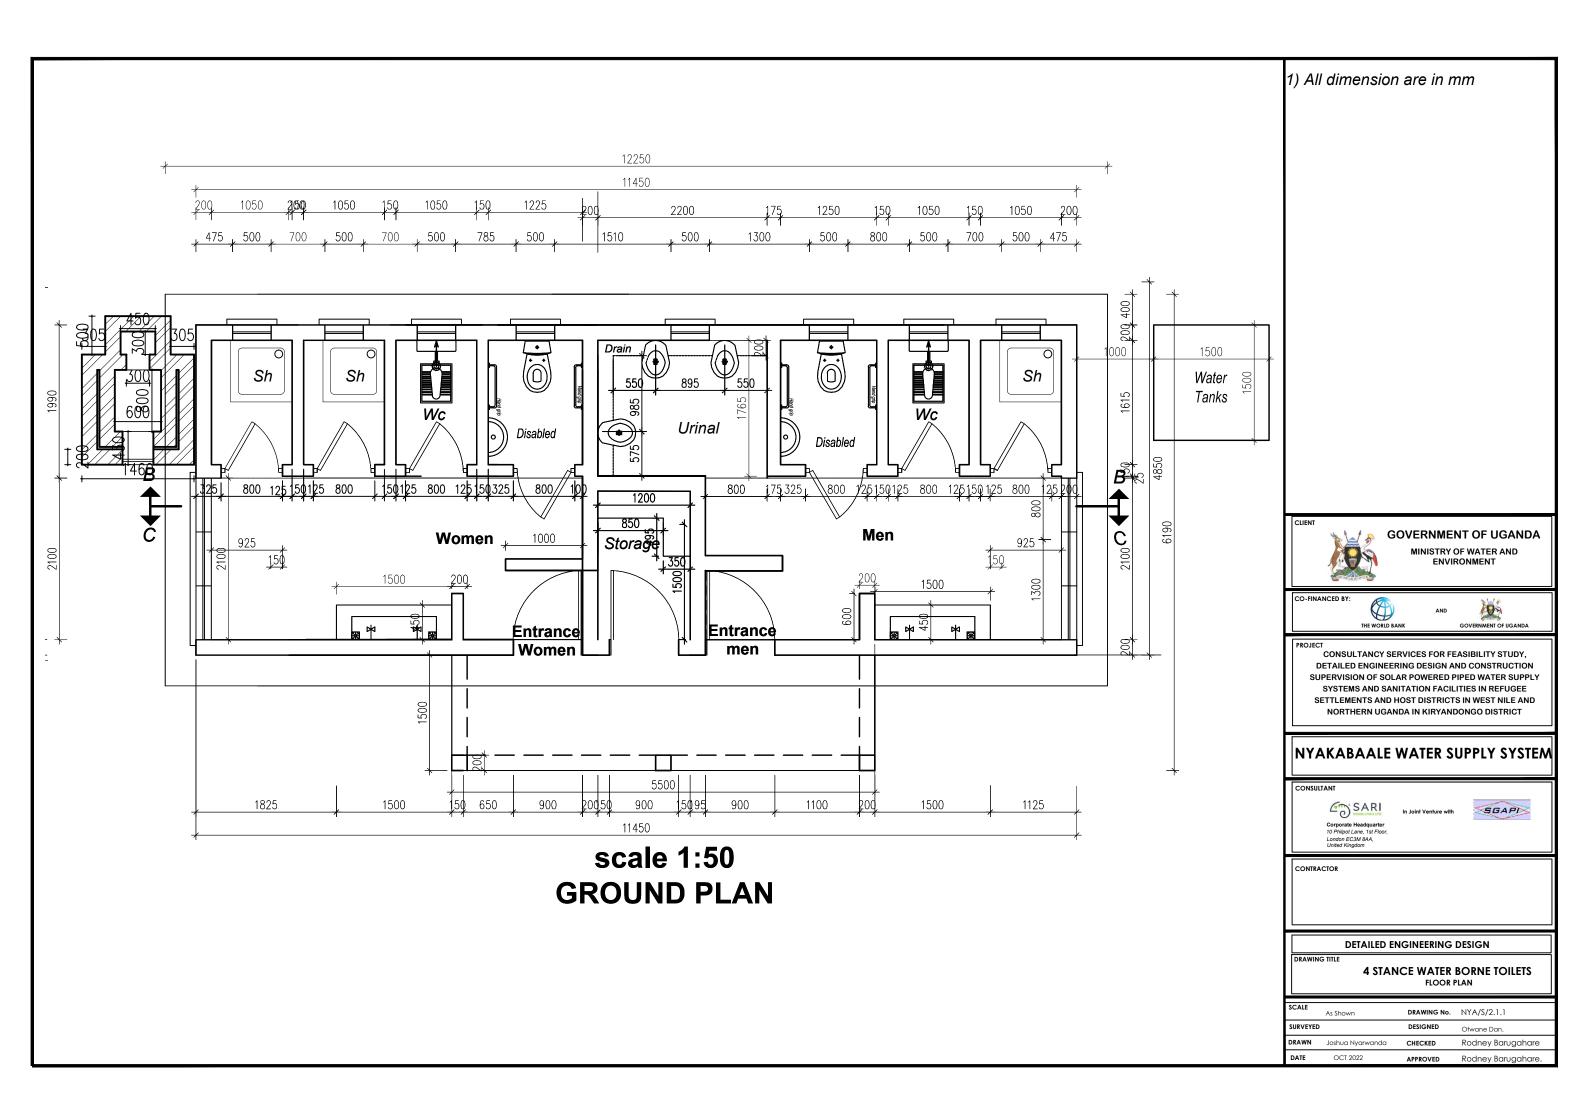

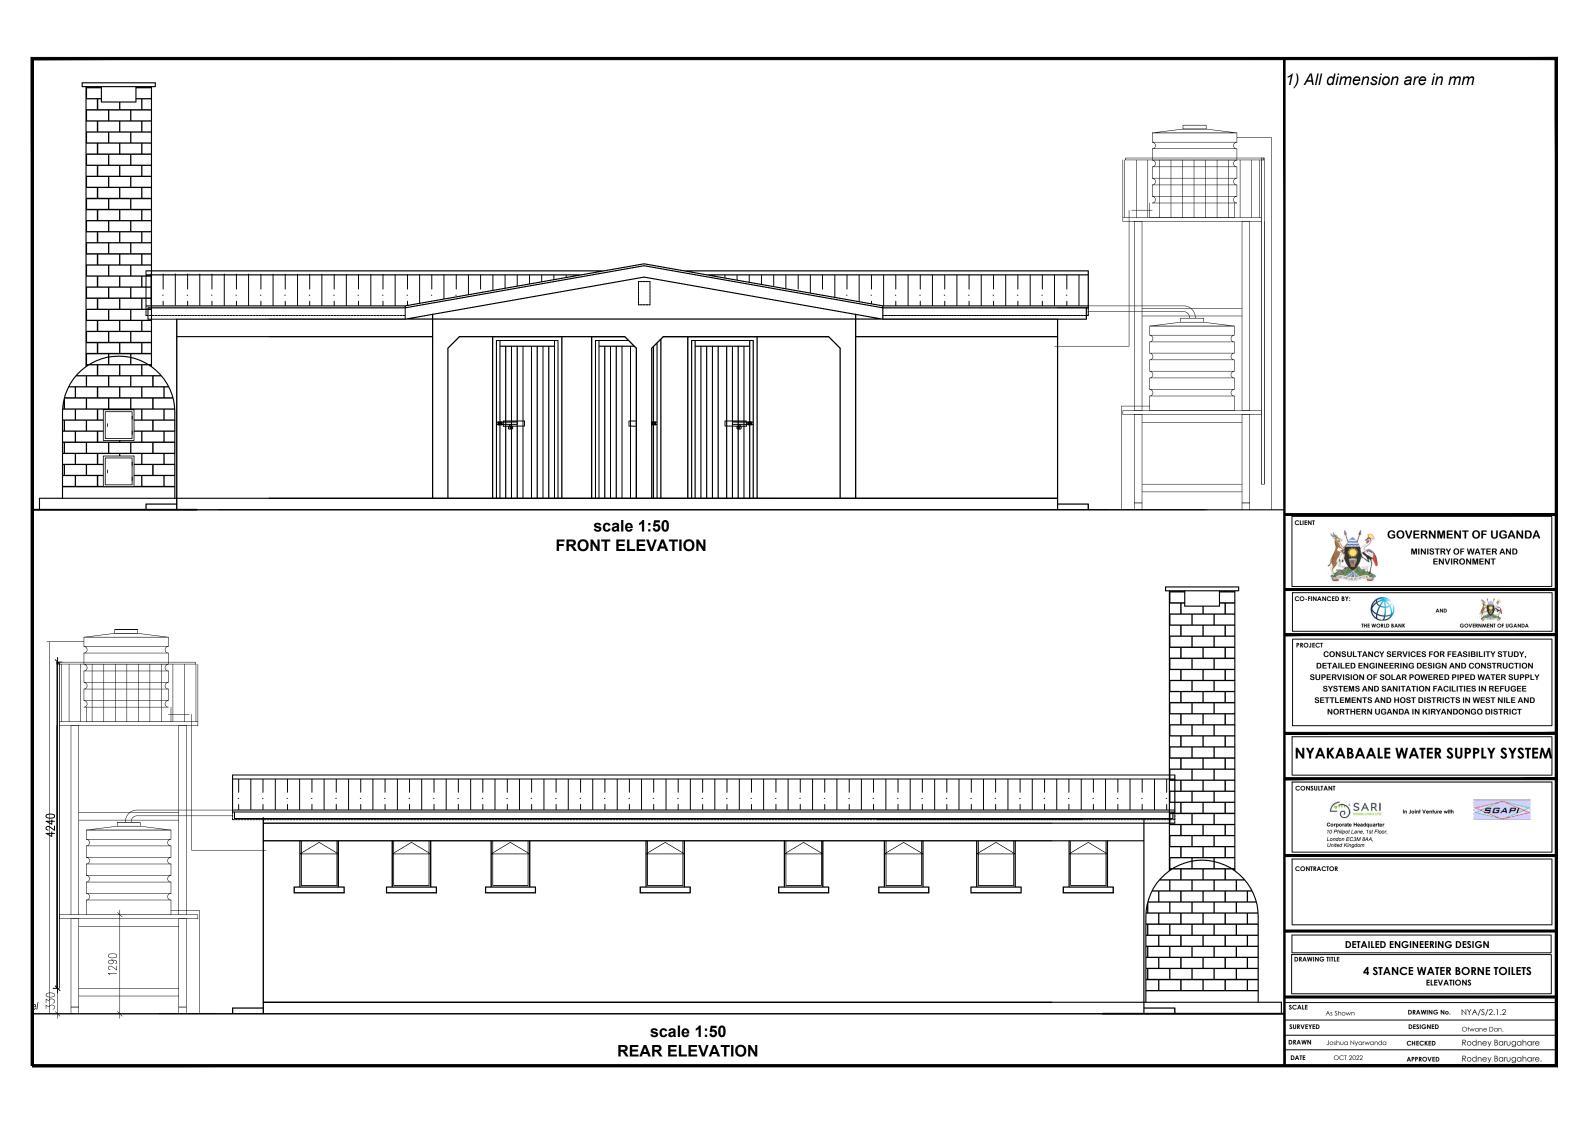

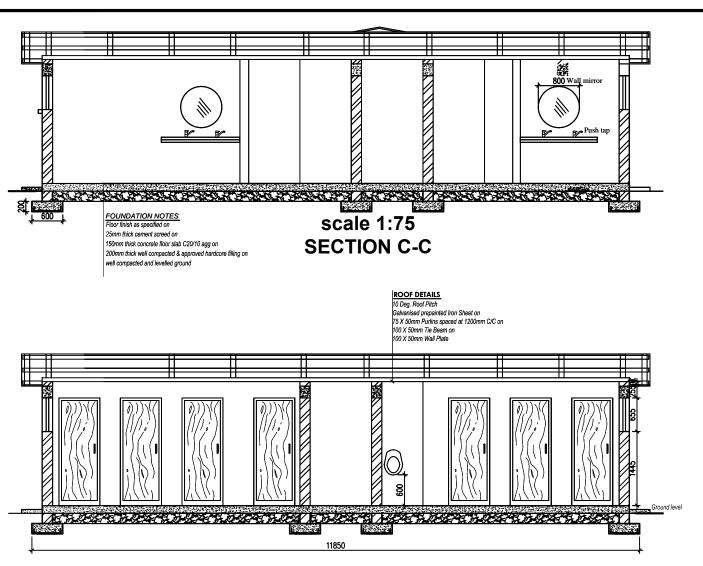

scale 1:75 SECTION B-B

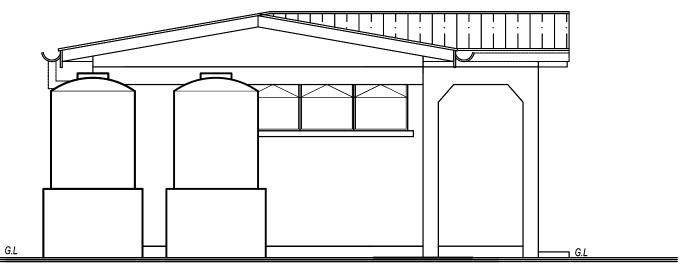

scale 1:50 SIDE VIEW

1) All dimension are in mm



GOVERNMENT OF UGANDA

MINISTRY OF WATER AND ENVIRONMENT

CO-FINANCED I



AND P

PROJECT

CONSULTANCY SERVICES FOR FEASIBILITY STUDY,
DETAILED ENGINEERING DESIGN AND CONSTRUCTION
SUPERVISION OF SOLAR POWERED PIPED WATER SUPPLY
SYSTEMS AND SANITATION FACILITIES IN REFUGEE
SETTLEMENTS AND HOST DISTRICTS IN WEST NILE AND
NORTHERN UGANDA IN KIRYANDONGO DISTRICT

NYAKABAALE WATER SUPPLY SYSTEM

CONSULTAN



Joint Venture with

SGAPI


CONTRACTOR

DETAILED ENGINEERING DESIGN


DRAWING

4 STANCE WATER BORNE TOILETS SECTIONS AND ELEVATIONS


SCALE	As Shown	DRAWING No.	NYA/S/2.1.3
SURVE	/ED	DESIGNED	Otwane Dan.
DRAWN	Joshua Nyarwanda	CHECKED	Rodney Barugahare
DATE	OCT 2022	APPROVED	Rodney Barugahare.

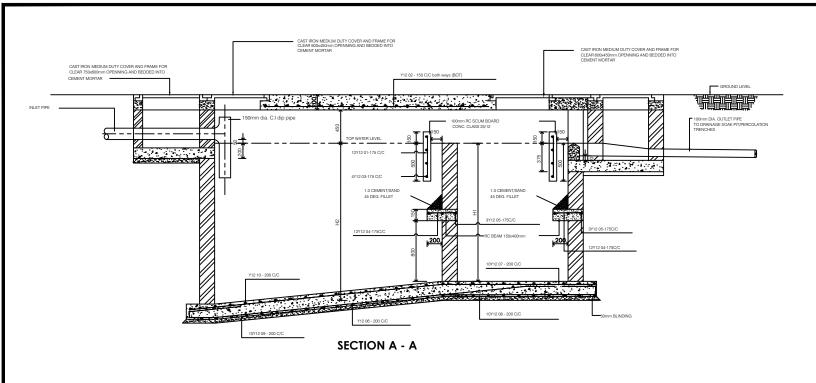



	INTERNAL DIMENSIONS					NO. OF USERS
L1	L2	H1	H2	В	Cu. M	
1540mm	760mm	1600mm	1750mm	760mm	3.2	10
1900mm	900mm	1800mm	2000mm	900mm	4.5	20
2000mm	1000mm	1800mm	2100mm	1100mm	5.9	30
2400mm	1100mm	1800mm	2100mm	1150mm	7.24	40
2500mm	1200mm	1800mm	2100mm	1300mm	8.6	50
2700mm	1300mm	1800mm	2100mm	1400mm	10	60
29000mm	1400mm	1800mm	2100mm	1450mm	11.3	70
3000mm	1500mm	1800mm	2100mm	1560mm	12.7	80
3200mm	1600mm	1800mm	2100mm	1600mm	14	90
3300mm	1700mm	1800mm	2100mm	1700mm	15.4	100
4000mm	2200mm	1800mm	2100mm	2190mm	24	150
4500mm	2700mm	1800mm	2100mm	2650mm	34.3	200

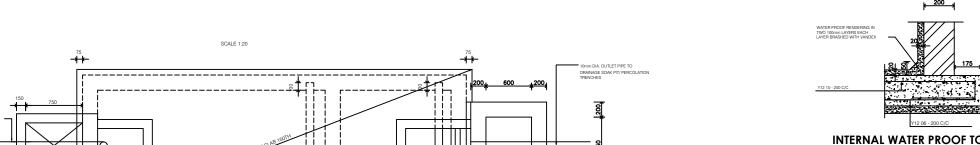


ROOF SLAB PLAN

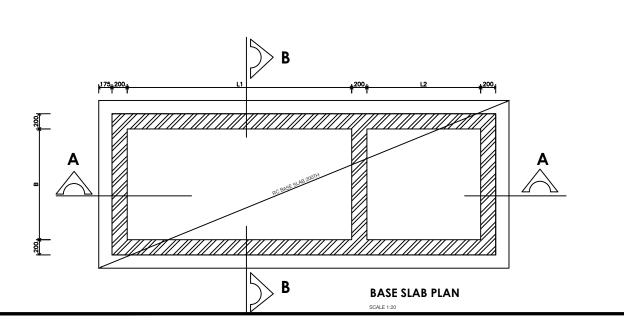

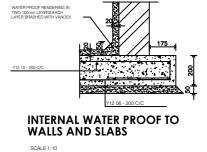

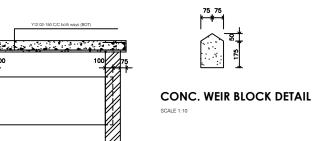

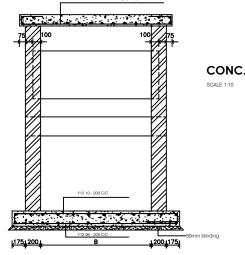

SECTION B - B

SCALE 1:20

1) All dimension are in mm



GOVERNMENT OF UGANDA

MINISTRY OF WATER AND ENVIRONMENT



CONSULTANCY SERVICES FOR FEASIBILITY STUDY, DETAILED ENGINEERING DESIGN AND CONSTRUCTION SUPERVISION OF SOLAR POWERED PIPED WATER SUPPLY SYSTEMS AND SANITATION FACILITIES IN REFUGEE SETTLEMENTS AND HOST DISTRICTS IN WEST NILE AND


NYAKABAALE WATER SUPPLY SYSTEM

SGAPI

DETAILED ENGINEERING DESIGN

WATER BORNE TOILETS
SEPTIC TANK DETAILS

SCALE	As Shown	DRAWING No.	NYA/S/2.1.4
SURVEYED		DESIGNED	Otwane Dan.
DRAWN	Joshua Nyarwanda	CHECKED	Rodney Barugahare
DATE	OCT 2022	APPROVED	Rodney Barugahare.

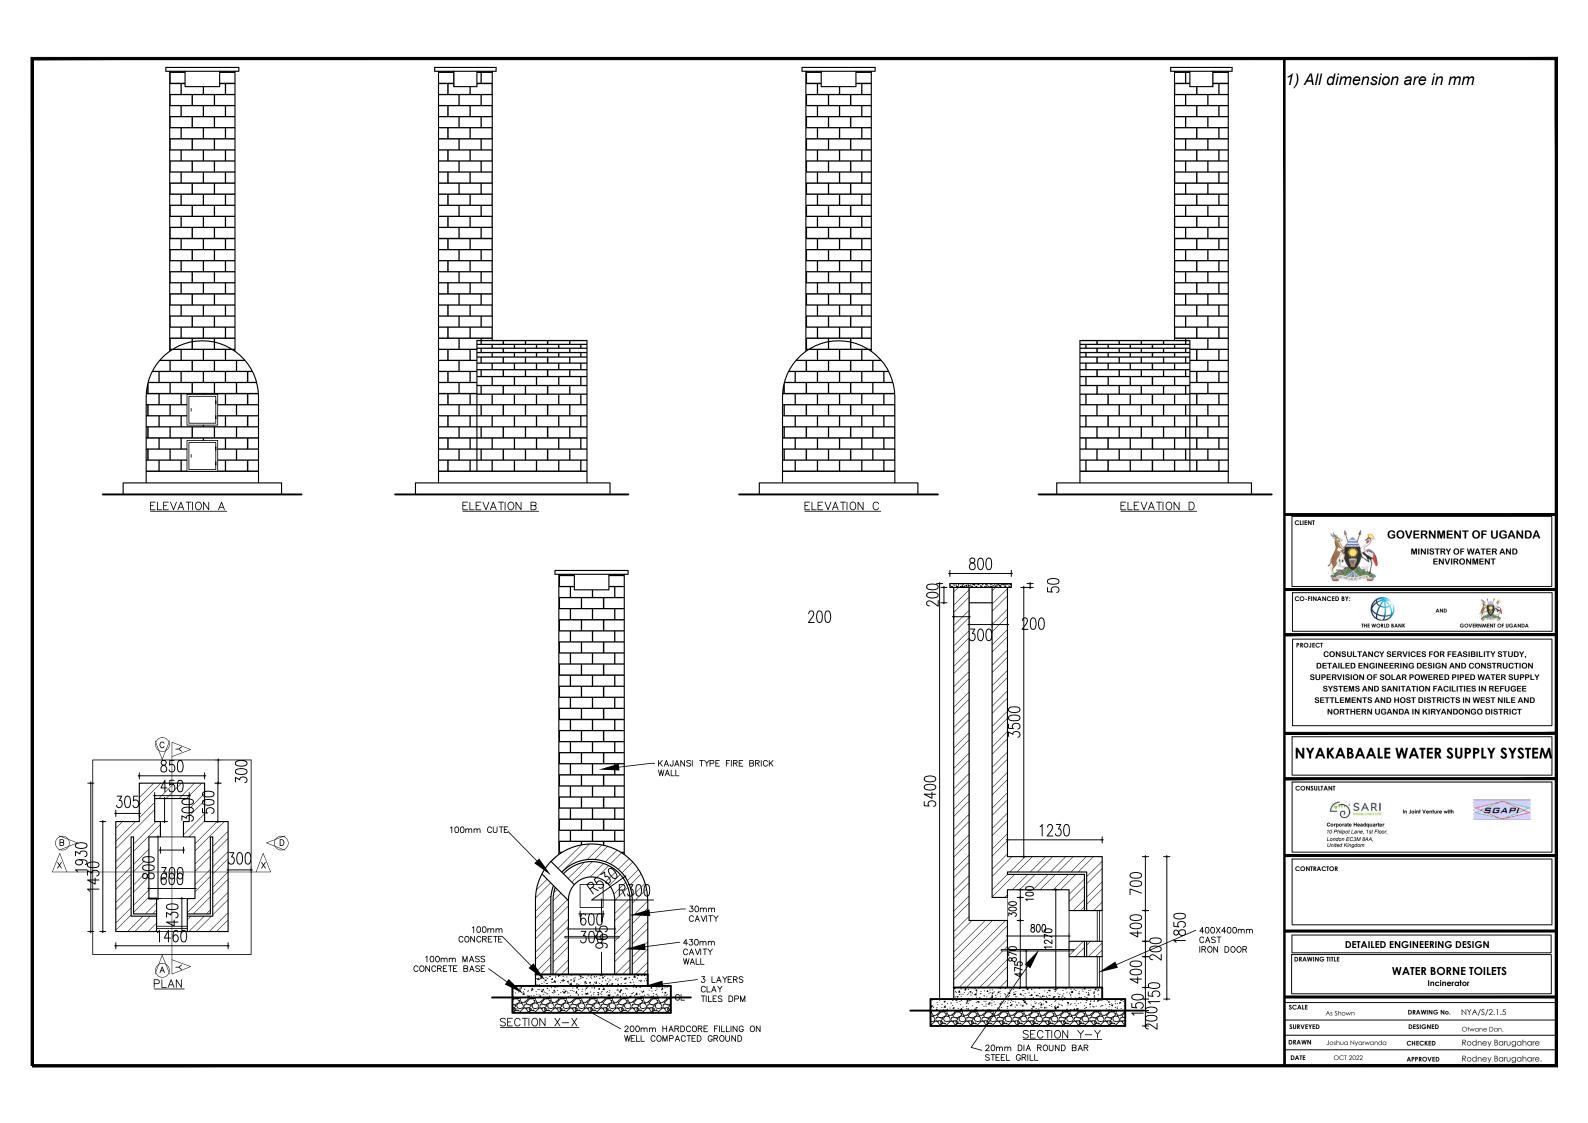

GENERAL NOTES FOR STANDARD DETAIL DRAWINGS

- 1) Unless flexibility is otherwise provided, where pipes enter or leave concrete structures, or anchor blocks, flexible joints are to be provided as shown in standard Detail Nr SD 137.
- 2) Anchor block designs are based on the following ground conditions.

Dry soil density: 1800 kg/m³
Submerged soil density: 1090 kg/m³

Angle of internal friction: 30° Passive resistance factor: 3

Where considerably better ground conditions, such as rock, are encountered, the dimensions of anchor blocks may be reduced. Supporting calculations for any reduced size anchor blocks must be submitted to the Project Manager 48 hours before construction of the particular anchor block commences and may be concreted only after his approval.

- 3) Bases and thrust faces of anchor blocks are to be cast against undisturbed ground, or against blinding cast against undisturbed ground.
- 4) Pipework joints as shown for the water supply details are diagrammatic only.
- 5) The following notes apply to reinforced concrete chambers.
 - a) Concrete in walls and base and cover slab

Characteristic strength (N/mm²): 30

Maximum aggregate size (mm): 20

Cement type: SR

Minimum cement content (kg/m³): 330

Maximum cement content (kg/m³): 400

Maximum free water/cement ratio: 0.47

b) Concrete in blinding

Characteristic strength (N/mm²): 1036

Maximum aggregate size (mm): 40

Cement type: SR

Minimum cement content (kg/m³): 230

c) Cover to reinforcement 40mm unless positioned centrally

- d) Minimum reinforcement lap 300 mm
- e) For details of step irons see Standard Detail Nr SD 136
-) Corners of rectangular openings to have T8 bars 500 mm long set diagonally
- All dimensions are in millimetres unless shown otherwise.
- 7) Do not scale dimensions from standard Detail drawings.



GOVERNMENT OF UGANDA

MINISTRY OF WATER AND ENVIRONMENT

CO-FINANCED BY:



GOVERNMENT OF U

PROJECT

CONSULTANCY SERVICES FOR FEASIBILITY STUDY,
DETAILED ENGINEERING DESIGN AND CONSTRUCTION
SUPERVISION OF SOLAR POWERED PIPED WATER SUPPLY
SYSTEMS AND SANITATION FACILITIES IN REFUGEE
SETTLEMENTS AND HOST DISTRICTS IN WEST NILE AND
NORTHERN UGANDA IN KIRYANDONGO DISTRICT

NYAKABAALE WATER SUPPLY SYSTEM

ONSULTANT



In Joint Venture with





CONTRACTOR


DETAILED ENGINEERING DESIGN

GENERAL NOTES FOR STANDARD DRAWINGS

SCALE	As Shown	DRAWING No.	SD100
SURVEYED)	DESIGNED	Otwane Dan.
DRAWN	Joshua Nyarwanda	CHECKED	Rodney Barugahare
DATE	OCT 2021	APPROVED	Rodney Barugahare.

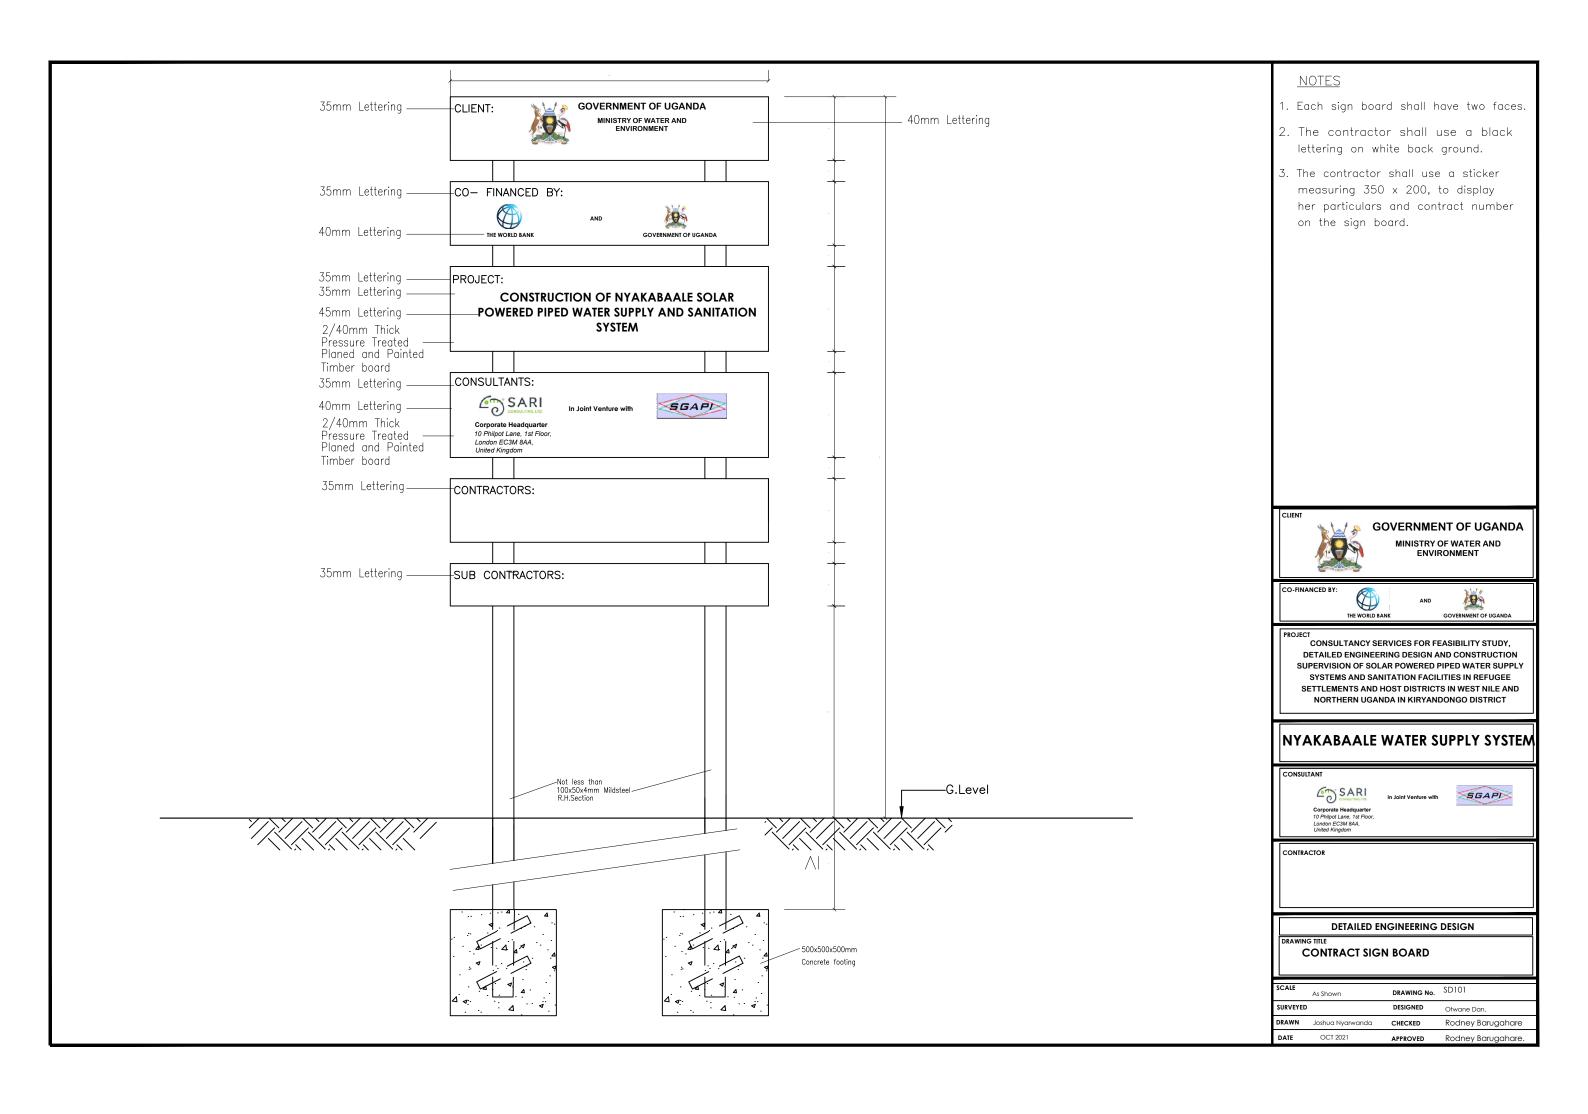

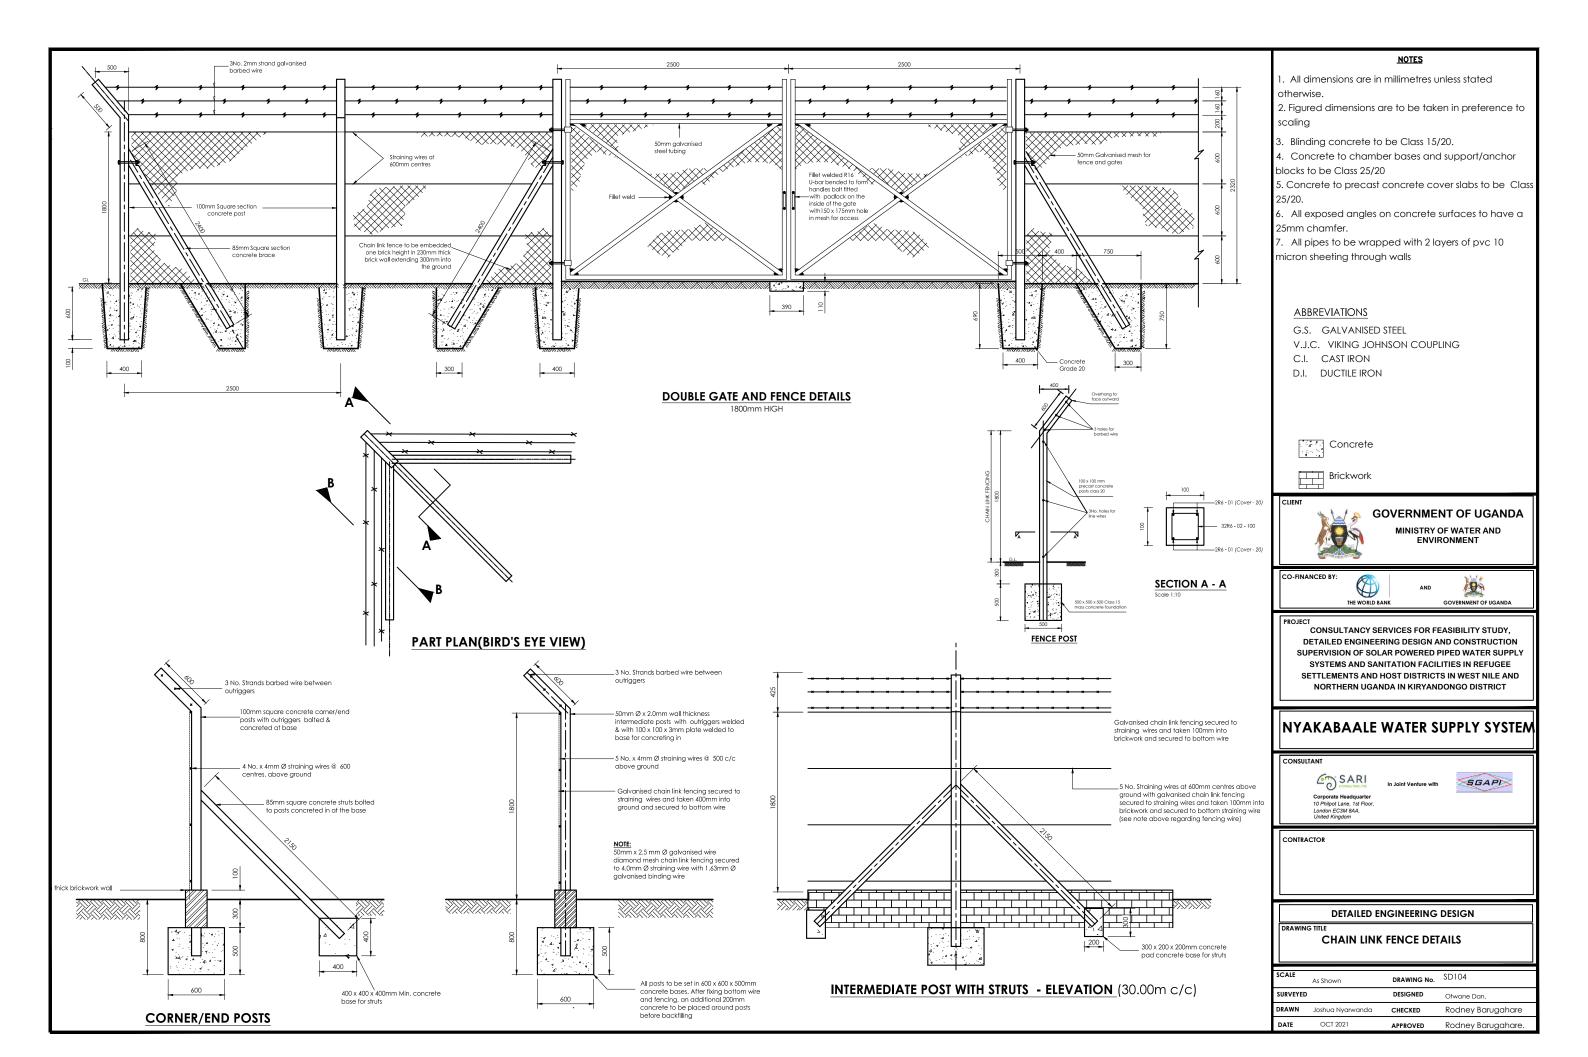

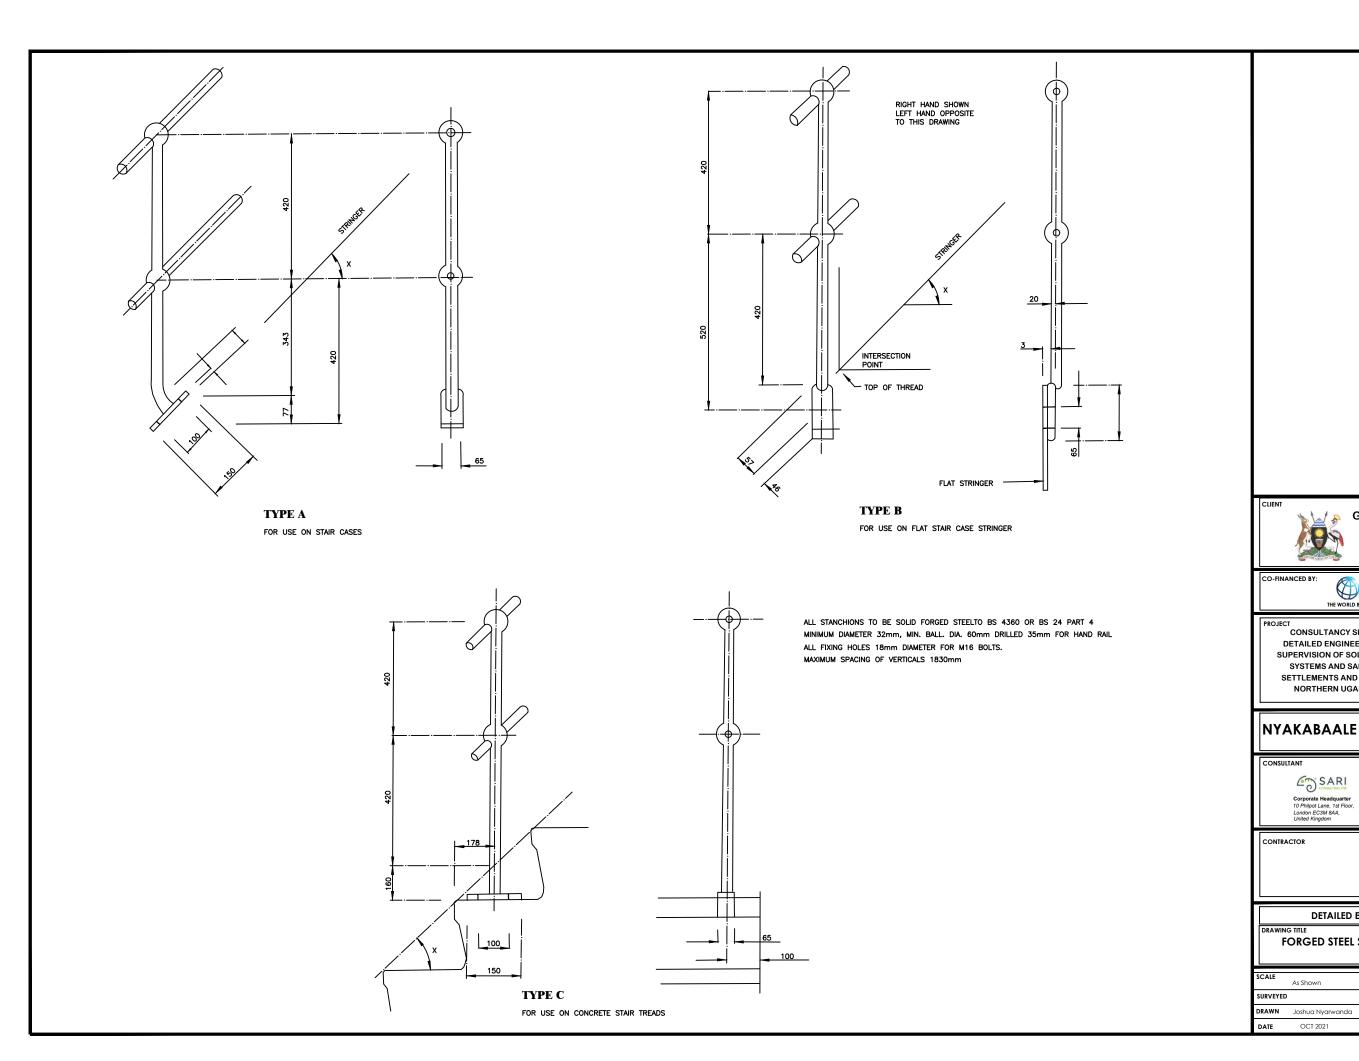

GOVERNMENT OF UGANDA

MINISTRY OF WATER AND ENVIRONMENT

SGAPI

Rodney Barugahare

CONSULTANCY SERVICES FOR FEASIBILITY STUDY,

DETAILED ENGINEERING DESIGN AND CONSTRUCTION

SUPERVISION OF SOLAR POWERED PIPED WATER SUPPLY

SYSTEMS AND SANITATION FACILITIES IN REFUGEE SETTLEMENTS AND HOST DISTRICTS IN WEST NILE AND NORTHERN UGANDA IN KIRYANDONGO DISTRICT

NYAKABAALE WATER SUPPLY SYSTEM

DETAILED ENGINEERING DESIGN

FORGED STEEL STANCHIONS FOR STAIRWAYS


DESIGNED

CHECKED

DRAWING No. SD106A

SARI COMSULTERS LTD

Corporate Headquarter 10 Philpot Lane, 1st Floor, London EC3M 8AA, United Kingdom

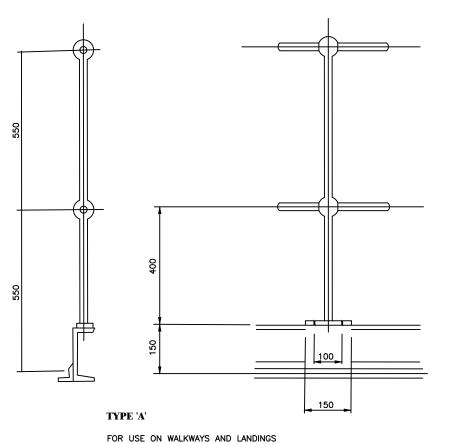


000 150

TYPE 'B'

FOR USE WITH 150 HIGH CONCRETE KERB

ALL STANCHIONS TO BE SOLID FORGED STEEL TO BS.4360 OR BS.24 PART 4, MIN DIA. 60mm, DRILLED 35mm DIA. FOR HANDRAIL. ALL FIXING HOLES 18mm DIA. FOR M16 BOLTS. MAXIMUM SPACING OF VERTICALS 1830mm.

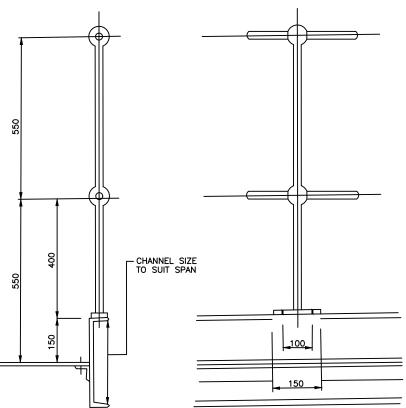

TYPE 'C'

FOR USE ON LONG SPAN WALKWAYS



GOVERNMENT OF UGANDA

MINISTRY OF WATER AND ENVIRONMENT

CO-FINANCED B



AND



PROJECT

CONSULTANCY SERVICES FOR FEASIBILITY STUDY,
DETAILED ENGINEERING DESIGN AND CONSTRUCTION
SUPERVISION OF SOLAR POWERED PIPED WATER SUPPLY
SYSTEMS AND SANITATION FACILITIES IN REFUGEE
SETTLEMENTS AND HOST DISTRICTS IN WEST NILE AND
NORTHERN UGANDA IN KIRYANDONGO DISTRICT

NYAKABAALE WATER SUPPLY SYSTEM

CONSULTANT



In Joint Venture with




CONTRACTOR


DETAILED ENGINEERING DESIGN

FORCED STEEL STANCHIONS
FOR PLATFORMS AND
WALKWAYS-1

SCALE	As Shown	DRAWING No.	SD106B
SURVEYED)	DESIGNED	Otwane Dan.
DRAWN	Joshua Nyarwanda	CHECKED	Rodney Barugahare
DATE	OCT 2021	APPROVED	Rodney Barugahare.

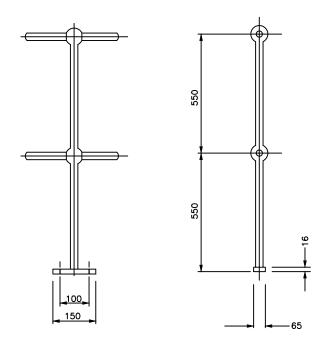


TYPE 'D' FOR USE ON FLAT SURFACES

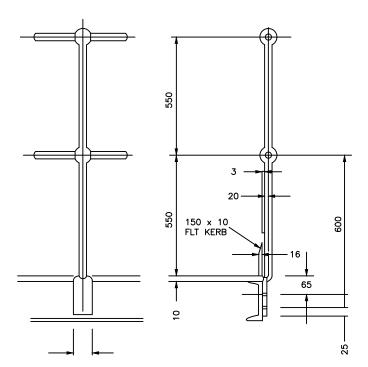


TYPE 'F'

FOR USE ON PLATFORMS HAVING 10 THK. CHEQUER PLATE DECKING

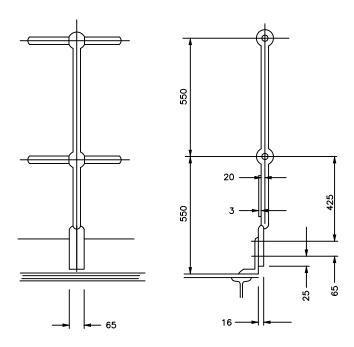

TYPE 'E' FOR USE ON KERB ANGLES

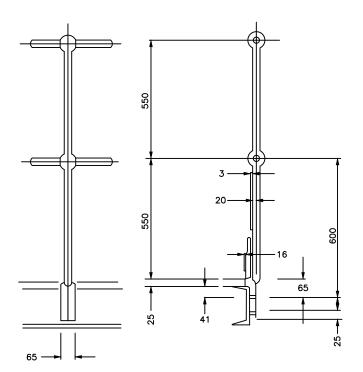

TYPE 'H'

FOR USE ON PLATFORMS HAVING 20 THK. OPEN GRILL DECKING

ALL STANCHIONS TO BE SOLID FORGED STEEL TO BSS. 4360 OR BS.24 PART 4 MIN DIA. 32mm MIN BALL DIA. 60mm. DRILLED 35mm DIA. FOR HANDRAIL ALL FIXING HOLES 18mm DIA. FOR M16 BOLTS. MAXIMUM SPACING OF VERTICALS 1830mm.



GOVERNMENT OF UGANDA

MINISTRY OF WATER AND ENVIRONMENT





CONSULTANCY SERVICES FOR FEASIBILITY STUDY, DETAILED ENGINEERING DESIGN AND CONSTRUCTION SUPERVISION OF SOLAR POWERED PIPED WATER SUPPLY SYSTEMS AND SANITATION FACILITIES IN REFUGEE SETTLEMENTS AND HOST DISTRICTS IN WEST NILE AND NORTHERN UGANDA IN KIRYANDONGO DISTRICT

NYAKABAALE WATER SUPPLY SYSTEM






CONTRACTOR

DETAILED ENGINEERING DESIGN

DRAWING TITLE FORCED STEEL STANCHIONS FOR PLATFORMS AND WALKWAYS-2

SCALE	As Shown	DRAWING No.	SD106C
SURVEYED		DESIGNED	Otwane Dan.
DRAWN	Joshua Nyarwanda	CHECKED	Rodney Barugahare
DATE	OCT 2021	APPROVED	Rodney Barugahare.

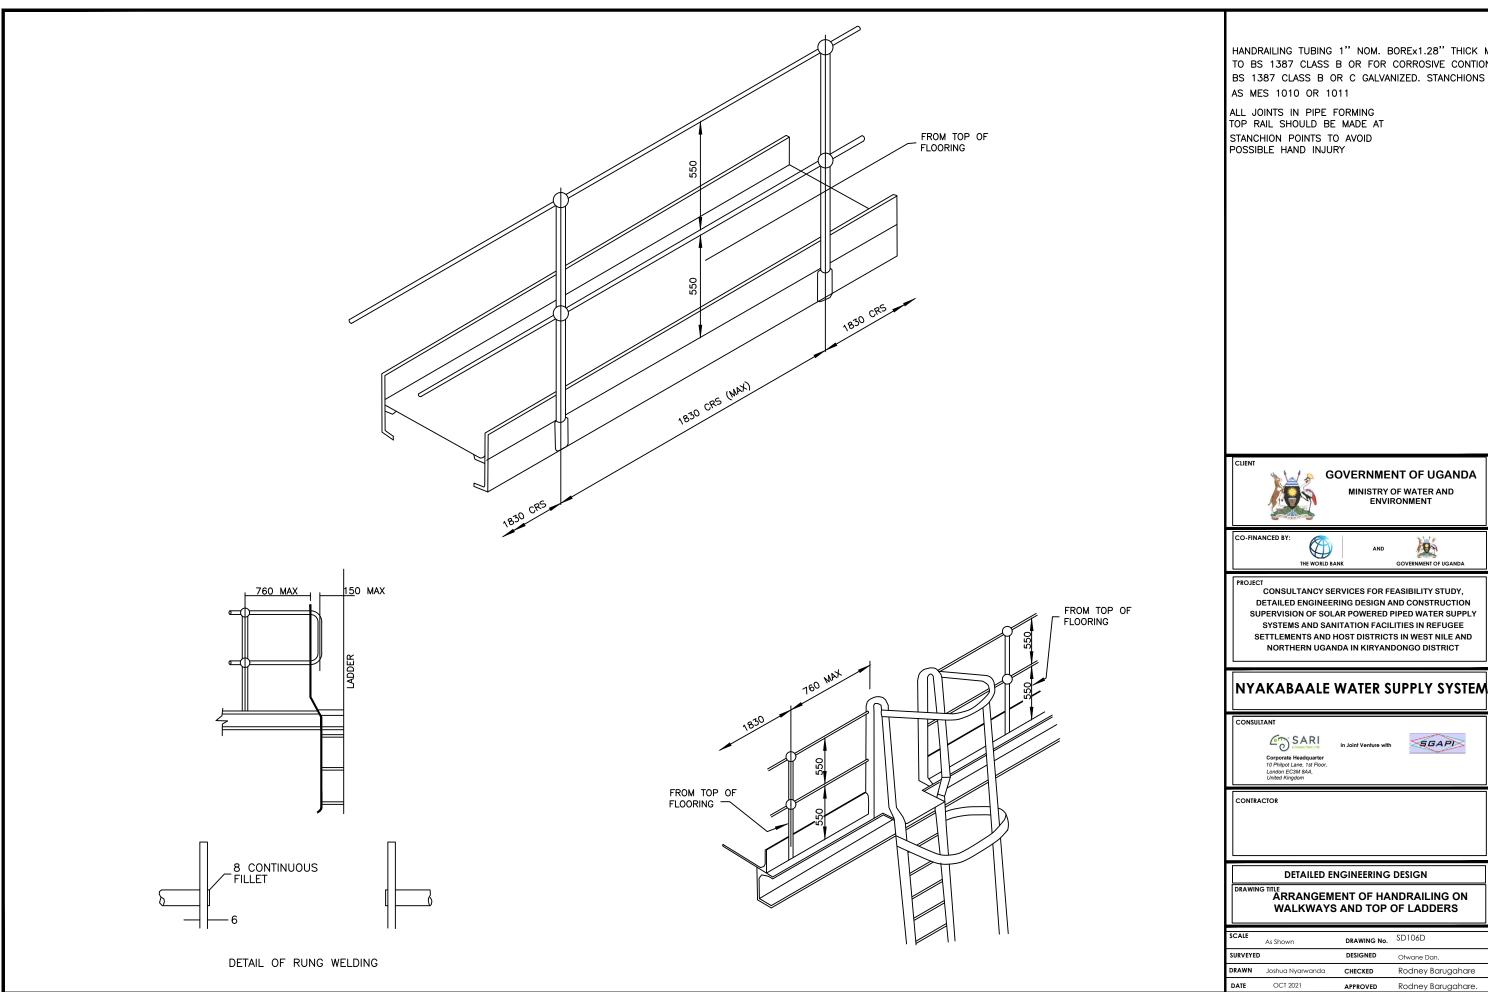

TO BS 1387 CLASS B OR FOR CORROSIVE CONTION BS 1387 CLASS B OR C GALVANIZED. STANCHIONS

GOVERNMENT OF UGANDA

MINISTRY OF WATER AND ENVIRONMENT




DETAILED ENGINEERING DESIGN AND CONSTRUCTION SUPERVISION OF SOLAR POWERED PIPED WATER SUPPLY SYSTEMS AND SANITATION FACILITIES IN REFUGEE SETTLEMENTS AND HOST DISTRICTS IN WEST NILE AND NORTHERN UGANDA IN KIRYANDONGO DISTRICT

NYAKABAALE WATER SUPPLY SYSTEM



ARRANGEMENT OF HANDRAILING ON WALKWAYS AND TOP OF LADDERS

SCALE	As Shown	DRAWING No.	SD106D
SURVEYED		DESIGNED	Otwane Dan.
DRAWN	Joshua Nyarwanda	CHECKED	Rodney Barugahare
DATE	OCT 2021	APPROVED	Rodney Barugahare.

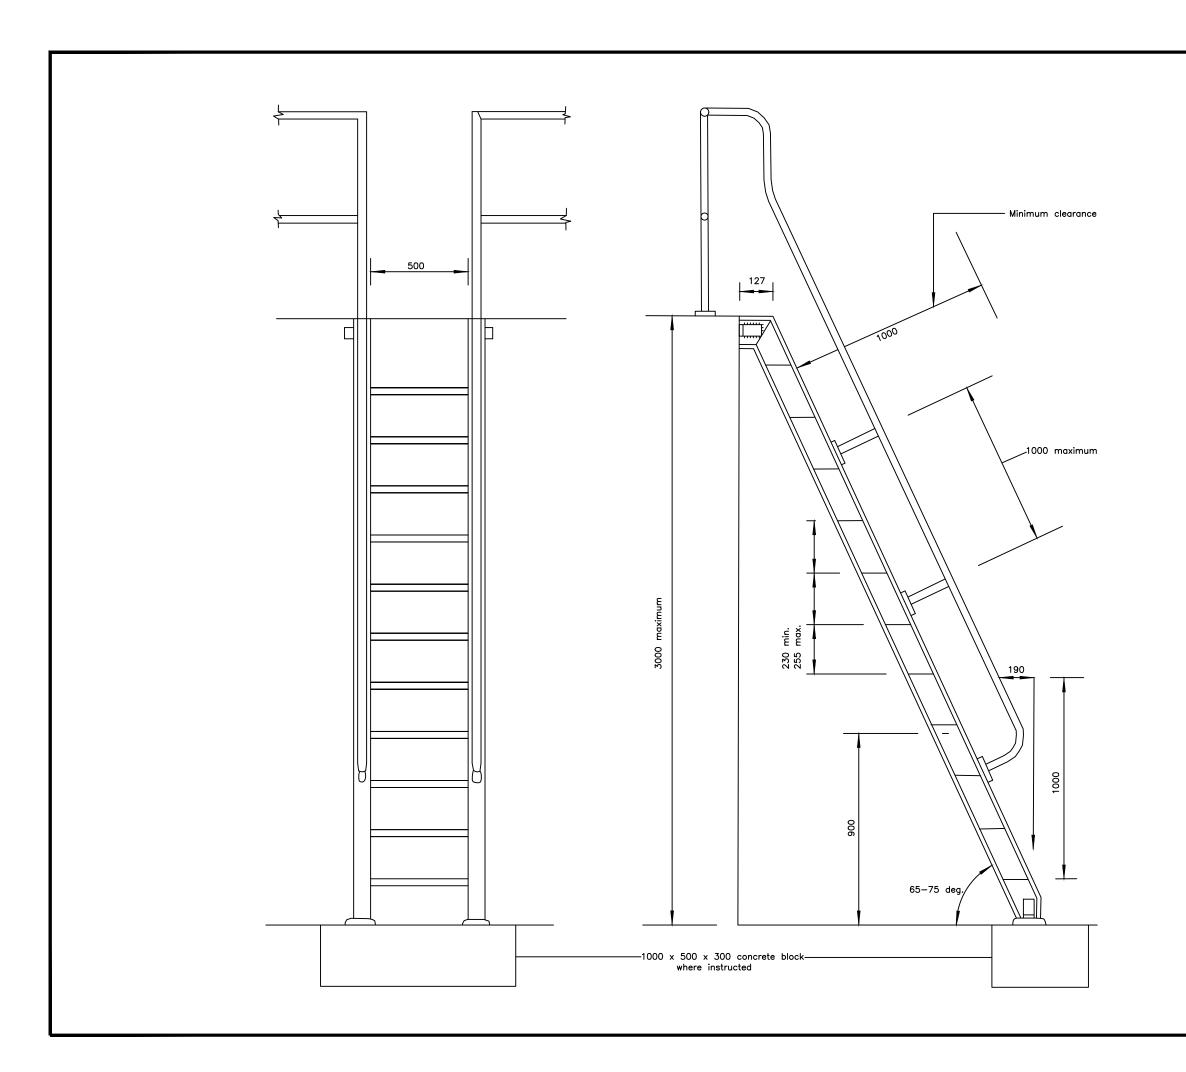

- 1. Stringers 127 x 64 x 14.9 kg/m rolled steel
- 2. Steps 8 mm thick chequer plate with nosed
- 3. Step supports 30 x 30 x 5 angle welded to fixed to stringers with 12 dia bolts and nuts.
- 4. All welds to be 8 mm fillet welds.
- 5. Cleats 90 x 90 x 10 angle.
- 6. Holding down bolts 20 dia.
- 7. Handrailing in accordance with the specificati
- 8. For details see SD107B.





GOVERNMENT OF UGANDA

MINISTRY OF WATER AND ENVIRONMENT

CO-FINANCED B



AND



PROJECT

CONSULTANCY SERVICES FOR FEASIBILITY STUDY,
DETAILED ENGINEERING DESIGN AND CONSTRUCTION
SUPERVISION OF SOLAR POWERED PIPED WATER SUPPLY
SYSTEMS AND SANITATION FACILITIES IN REFUGEE
SETTLEMENTS AND HOST DISTRICTS IN WEST NILE AND
NORTHERN UGANDA IN KIRYANDONGO DISTRICT

NYAKABAALE WATER SUPPLY SYSTEM

CONSULTANT



In Joint Venture with



CONTRACTOR

DETAILED ENGINEERING DESIGN


DRAWING TITLE

ARRANGEMENT OF HANDRAILING ON WALKWAYS AND TOP OF LADDERS

SCALE			SD107A
	As Shown	DRAWING No.	3510//(
SURVEYE	D	DESIGNED	Otwane Dan.
DRAWN	Joshua Nyarwanda	CHECKED	Rodney Barugahare
DATE	OCT 2021	APPROVED	Rodney Barugahare.

Platform level Top step flush with platform 127 x 64 stringer 127 x 64 stringer



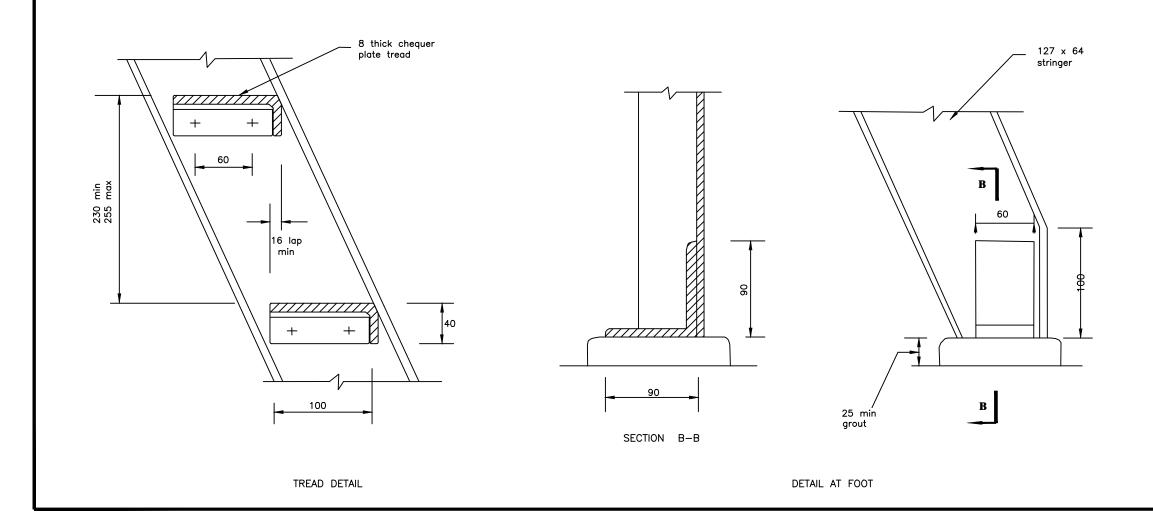

NOTES

- 1. All welds to be 81 then to welds
- 2. Holding down b20tsdia.



GOVERNMENT OF UGANDA

MINISTRY OF WATER AND ENVIRONMENT

CO-FINANCED BY



ND D

PROJECT

CONSULTANCY SERVICES FOR FEASIBILITY STUDY,
DETAILED ENGINEERING DESIGN AND CONSTRUCTION
SUPERVISION OF SOLAR POWERED PIPED WATER SUPPLY
SYSTEMS AND SANITATION FACILITIES IN REFUGEE
SETTLEMENTS AND HOST DISTRICTS IN WEST NILE AND
NORTHERN UGANDA IN KIRYANDONGO DISTRICT

NYAKABAALE WATER SUPPLY SYSTEM

CONSULTANT



In Joint Venture with




CONTRACTOR


DETAILED ENGINEERING DESIGN

DRAWING TITLE

MILD STEEL SHIPTYPE LADDER - DETAIL

SCALE	As Shown	DRAWING No.	SD107B
SURVEYED		DESIGNED	Otwane Dan.
DRAWN	Joshua Nyarwanda	CHECKED	Rodney Barugahare
DATE	OCT 2021	APPROVED	Rodney Barugahare.

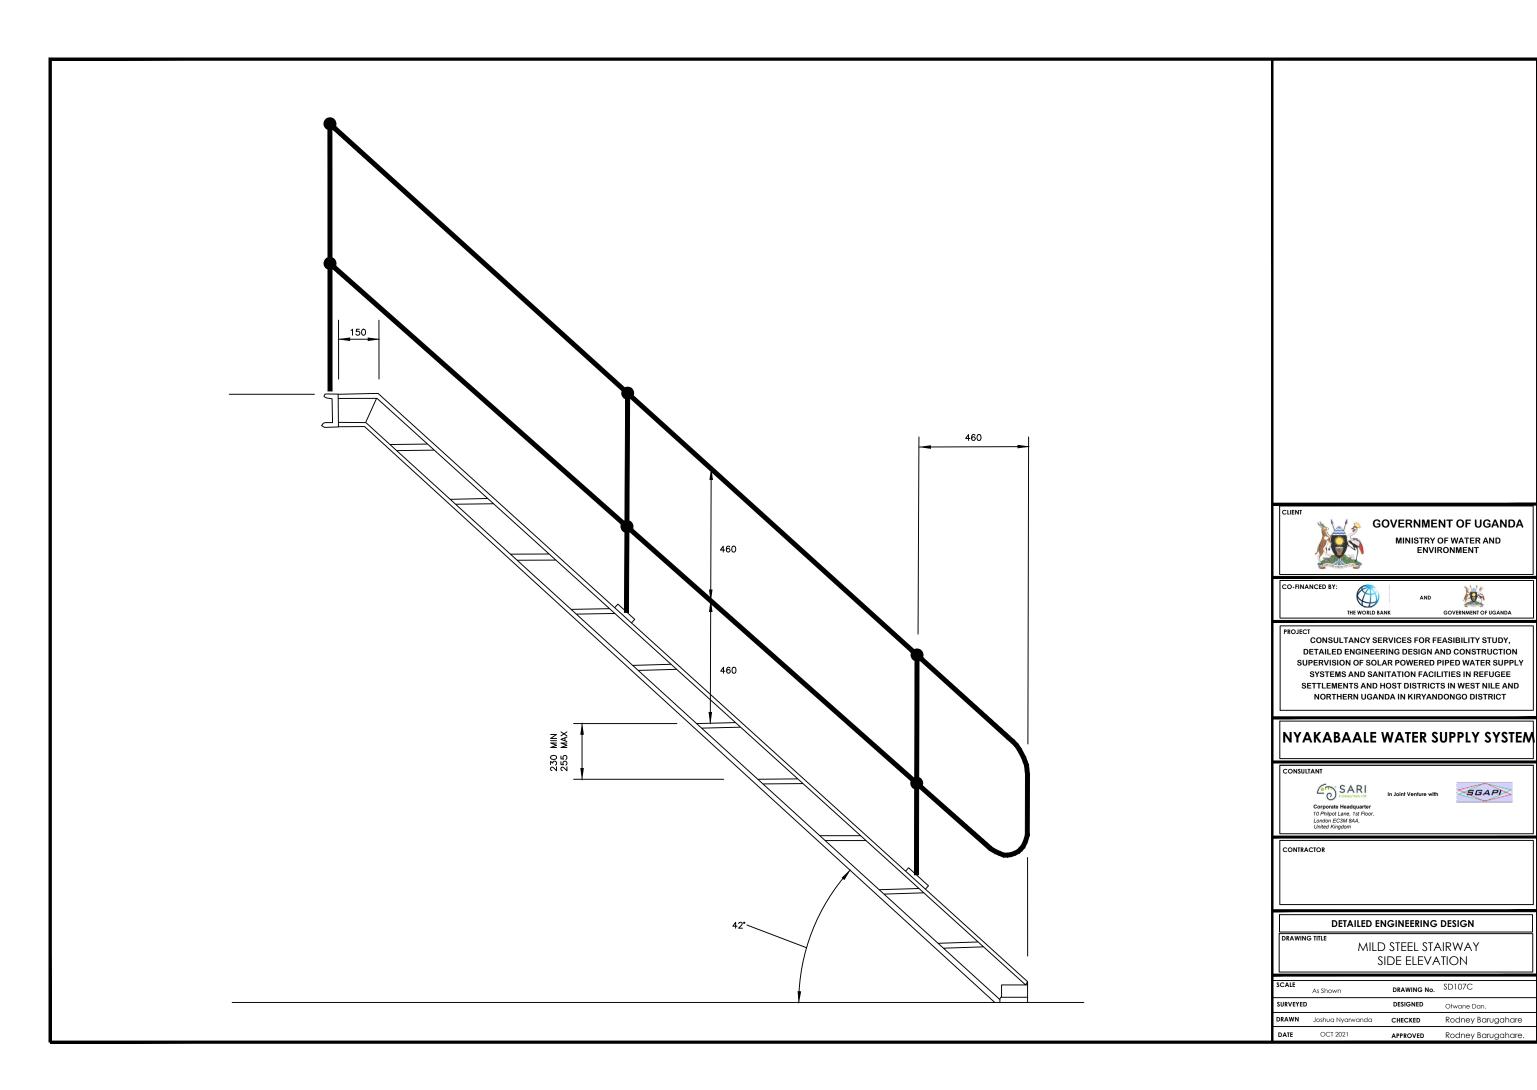

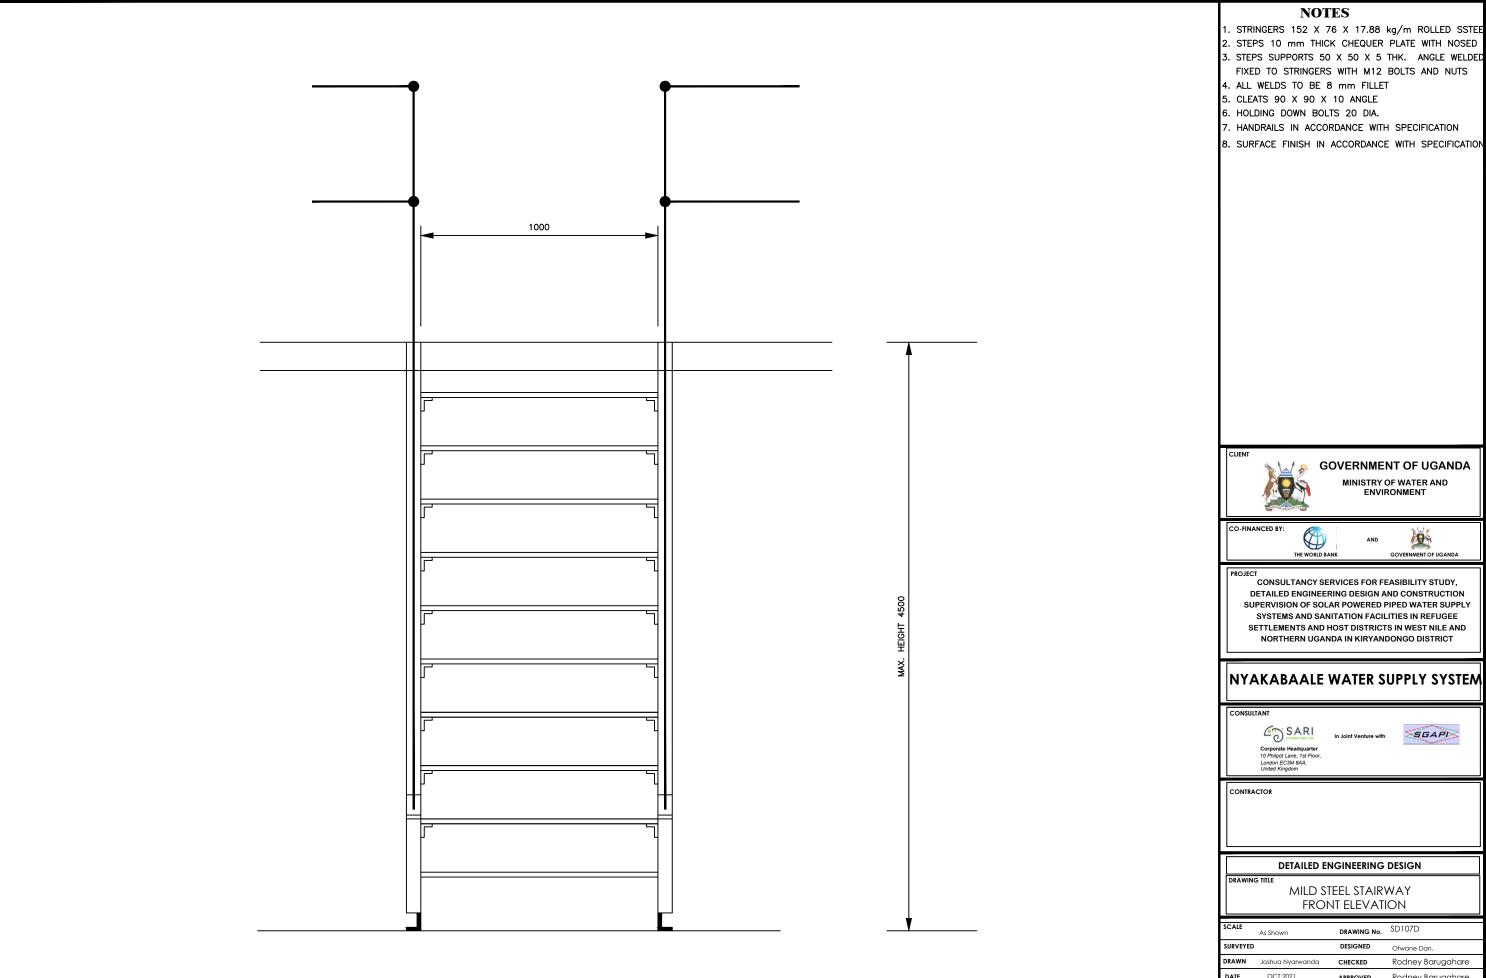

- FIXED TO STRINGERS WITH M12 BOLTS AND NUTS

GOVERNMENT OF UGANDA

MINISTRY OF WATER AND ENVIRONMENT




DETAILED ENGINEERING DESIGN AND CONSTRUCTION SUPERVISION OF SOLAR POWERED PIPED WATER SUPPLY SYSTEMS AND SANITATION FACILITIES IN REFUGEE SETTLEMENTS AND HOST DISTRICTS IN WEST NILE AND





DETAILED ENGINEERING DESIGN

FRONT ELEVATION

SCALE	As Shown	DRAWING No.	SD107D
SURVEYED		DESIGNED	Otwane Dan.
DRAWN	Joshua Nyarwanda	CHECKED	Rodney Barugahare
DATE	OCT 2021	APPROVED	Rodney Barugahare.

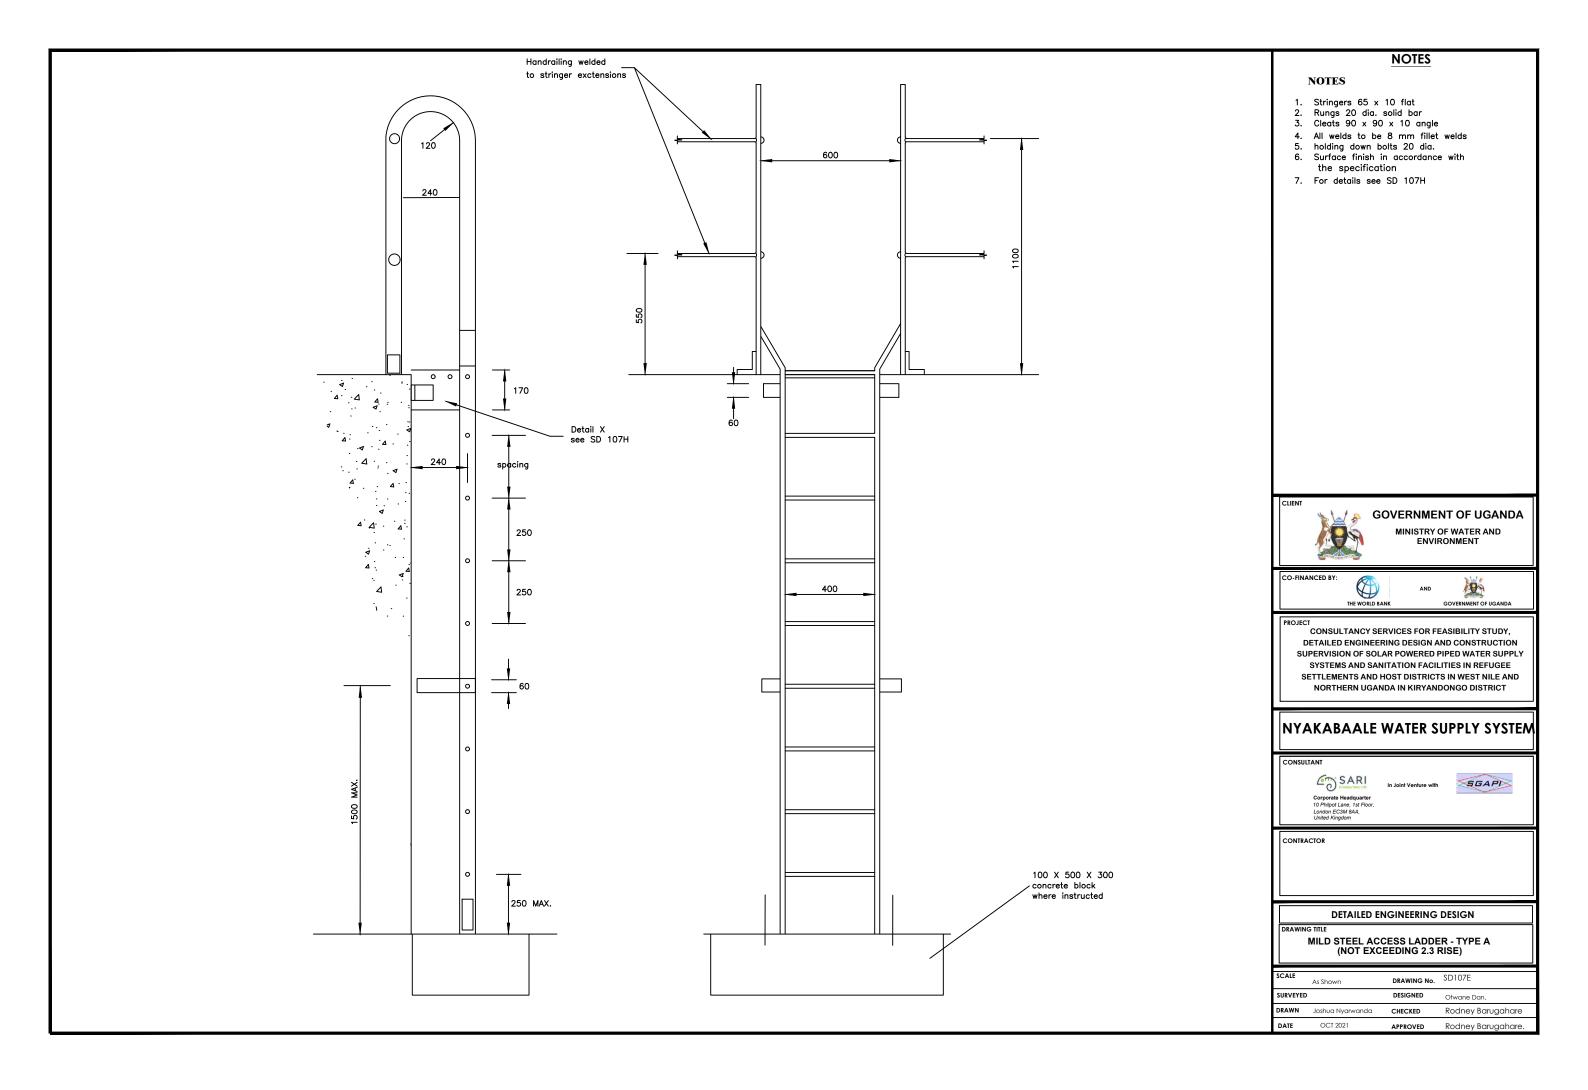

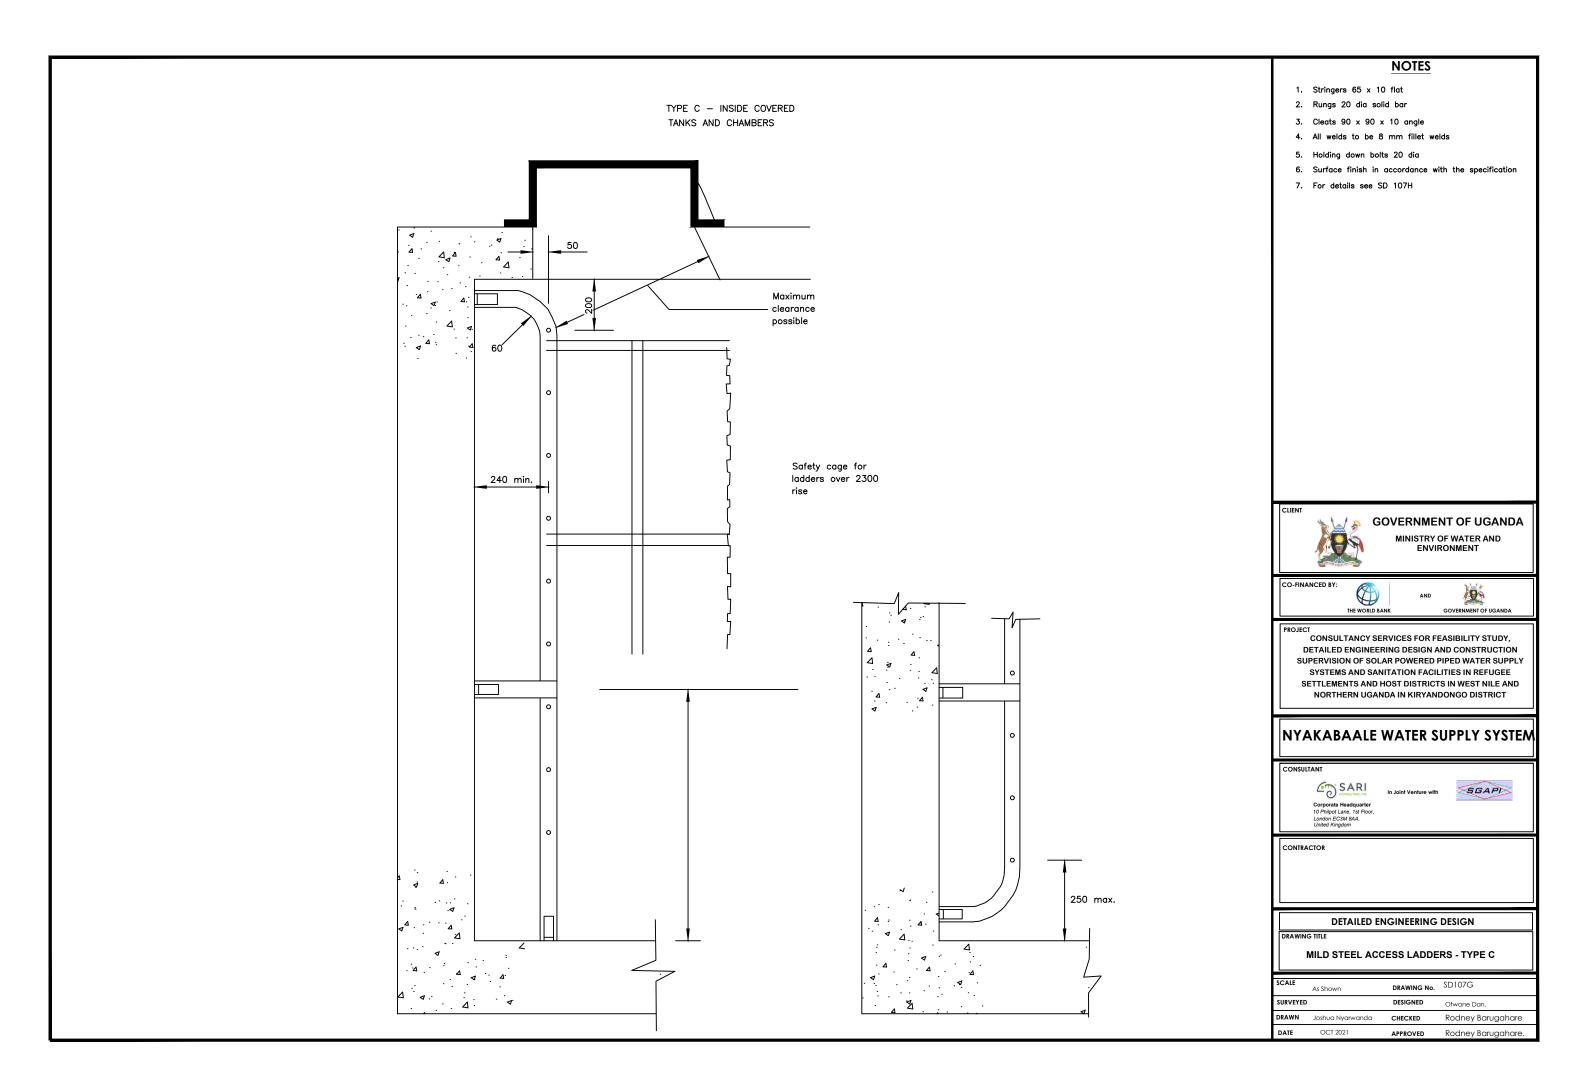

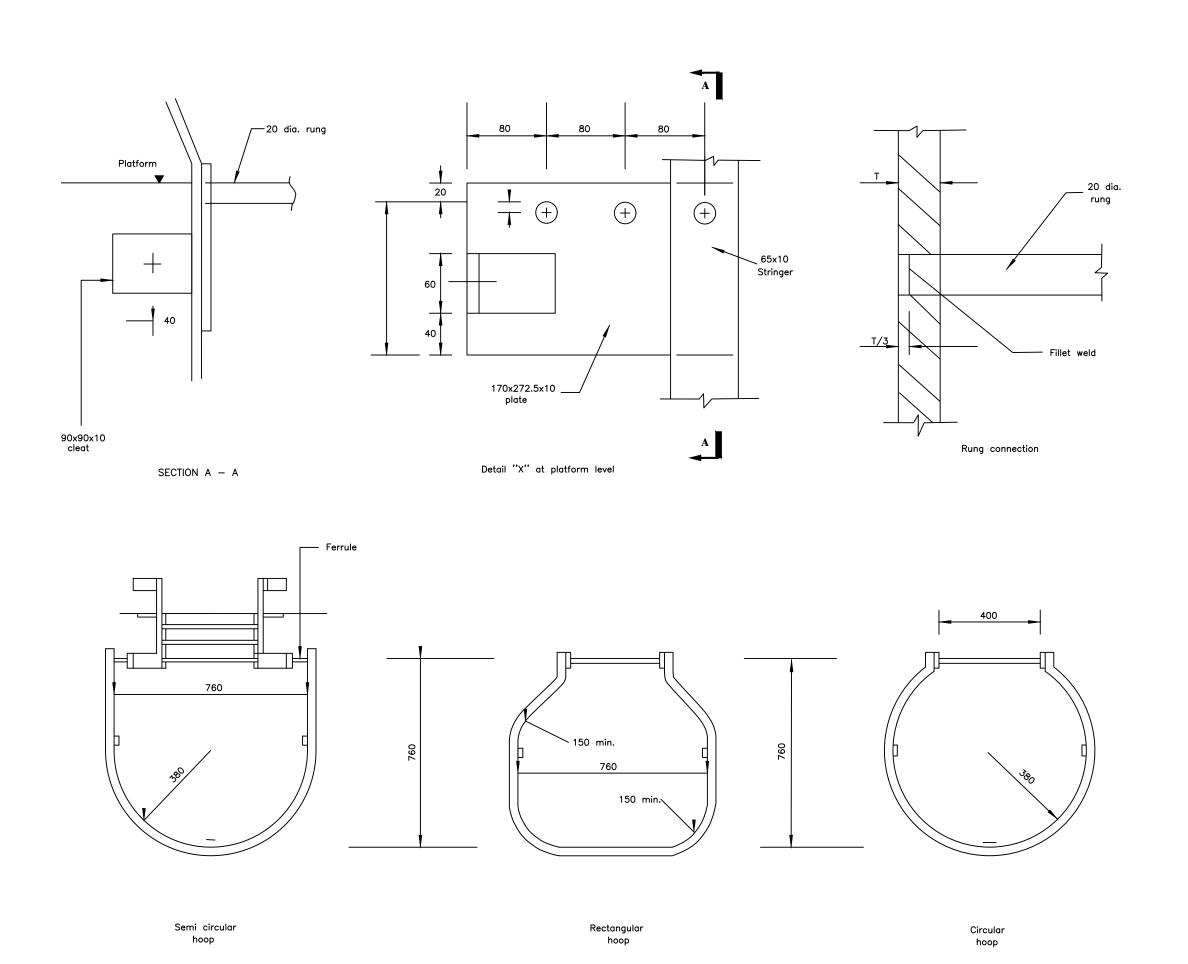

- 1. All welds to be 8 mm fillet welds
- Hoops and vertical cage members to be
 50x10 flat welded together or fixed with
 12 dia. bolts and nuts
- 3. Holding down bolts 20 dia.





GOVERNMENT OF UGANDA

MINISTRY OF WATER AND ENVIRONMENT

CO-FINANCED B



AND



PROJECT
CONSULTANCY SERVICES FOR FEASIBILITY STUDY,

DETAILED ENGINEERING DESIGN AND CONSTRUCTION
SUPERVISION OF SOLAR POWERED PIPED WATER SUPPLY
SYSTEMS AND SANITATION FACILITIES IN REFUGEE
SETTLEMENTS AND HOST DISTRICTS IN WEST NILE AND
NORTHERN UGANDA IN KIRYANDONGO DISTRICT

NYAKABAALE WATER SUPPLY SYSTEM

CONSULTAN



In Joint Venture with




CONTRACTOR

DETAILED ENGINEERING DESIGN

RAWING TITLE

MILD STEEL ACCESS LADDERS - DETAILS

SCALE	As Shown	DRAWING No.	SD107H
SURVEYED)	DESIGNED	Otwane Dan.
DRAWN	Joshua Nyarwanda	CHECKED	Rodney Barugahare
DATE	OCT 2021	APPROVED	Rodney Barugahare.

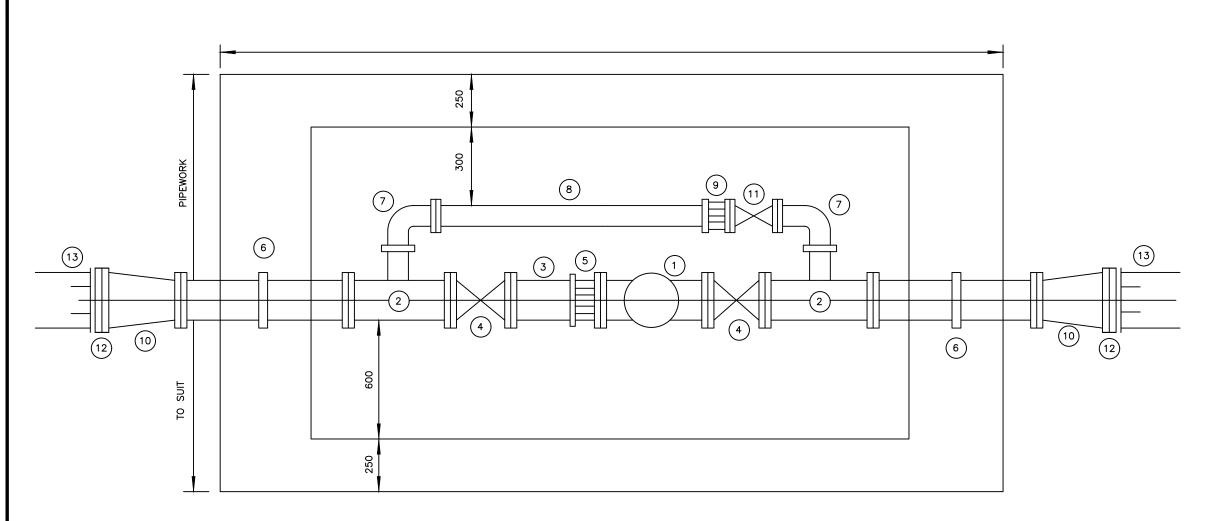

(SD 131 PRV CHAMBER)

MAIN SIZE (mm DIAMETER)	PRV SIZE (mm DIAMETER)
100	80
150	100
200	150
250	200
300	250
350	300

- 1 All dimensions in millimetres
- 2 For details of reinforced concrete chamber see SD 132
- ITEM
- 1 Pressure reducing valve
- 2 All flanged tee (DN100 branch)
- 3 Flanged spigot pipe
- 4 Flanged gate valve
- 5 Flange adaptor
- 6 Flange spigot pipe with puddle Flange
- 7 Flanged 90° bend DN100
- 8 Flanged spigot pipe cut to fit
- 9 Flanged adaptor DN100
- 10 Flanged taper
- 11 Gate valve DN100
- 12 Flange adaptor (Viking Johnson 'maxi' or similar approved)
- 13 Distribution main





GOVERNMENT OF UGANDA

MINISTRY OF WATER AND ENVIRONMENT





CONSULTANCY SERVICES FOR FEASIBILITY STUDY, DETAILED ENGINEERING DESIGN AND CONSTRUCTION SUPERVISION OF SOLAR POWERED PIPED WATER SUPPLY SYSTEMS AND SANITATION FACILITIES IN REFUGEE SETTLEMENTS AND HOST DISTRICTS IN WEST NILE AND NORTHERN UGANDA IN KIRYANDONGO DISTRICT

NYAKABAALE WATER SUPPLY SYSTEM






CONTRACTOR

DETAILED ENGINEERING DESIGN

PRESSURE REDUCING VALVE - PIPEWORK

-					
	SCALE	As Shown	DRAWING No.	SD109	
	SURVEYED		DESIGNED	Otwane Dan.	
	DRAWN	Joshua Nyarwanda	CHECKED	Rodney Barugahare	
	DATE	OCT 2021	APPROVED	Rodney Barugahare.	

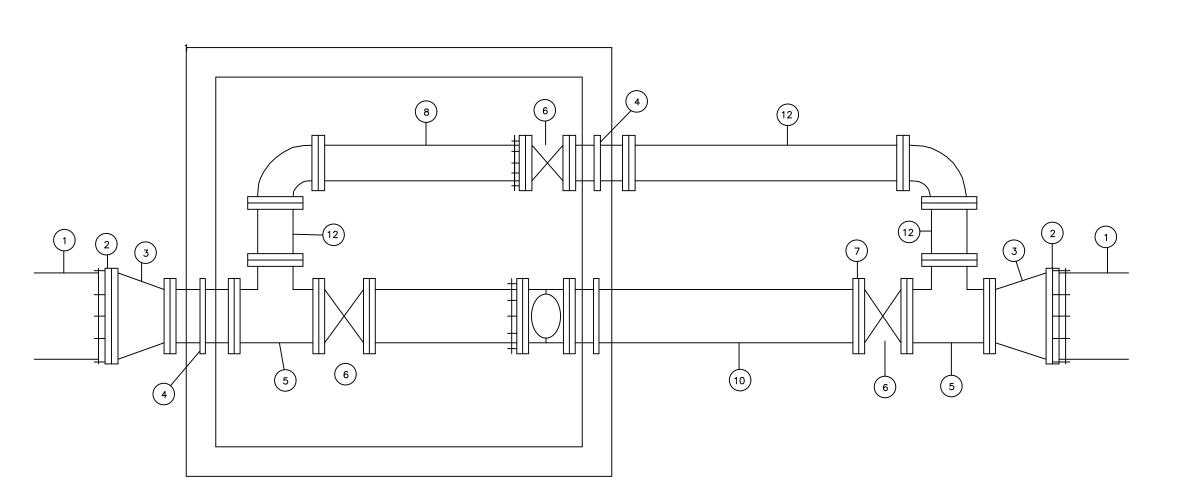

MAIN SIZE (mm DIAMETER)	FLOWMETER SIZE (mm DIAMETER)
100	80
150	100
200	150
250	200
300	250
350	300

- 1 All dimensions in millimetres
- 2 For details of reinforced concrete chamber see SD 132
- 2 Length of each item of pipework shall be specified by the Project Manager

ITEM

- 1 Distribution main
- 2 Flange adaptor (Viking Johnson 'maxi' or similar approved) 3 Flanged taper
- 4 All flanged piece with central thrust flange
- 5 All flanged equal tee
- 6 Flange gate valve 7 Flanged adaptor
- 8 Flanged spigot pipe
- 9 Water meter
 10 Flanged spigot with thrust flange 500mm from flanged end
 11 Flanged 90° bend
 12 Double flanged pipe





GOVERNMENT OF UGANDA

MINISTRY OF WATER AND ENVIRONMENT





CONSULTANCY SERVICES FOR FEASIBILITY STUDY, DETAILED ENGINEERING DESIGN AND CONSTRUCTION SUPERVISION OF SOLAR POWERED PIPED WATER SUPPLY SYSTEMS AND SANITATION FACILITIES IN REFUGEE SETTLEMENTS AND HOST DISTRICTS IN WEST NILE AND NORTHERN UGANDA IN KIRYANDONGO DISTRICT

NYAKABAALE WATER SUPPLY SYSTEM






CONTRACTOR


DETAILED ENGINEERING DESIGN

FLOWMETER - PIPEWORK

SCALE	As Shown	DRAWING No.	SD110	
SURVEYED		DESIGNED	Otwane Dan.	
DRAWN	Joshua Nyarwanda	CHECKED	Rodney Barugahare	
DATE	OCT 2021	APPROVED	Rodney Barugahare.	

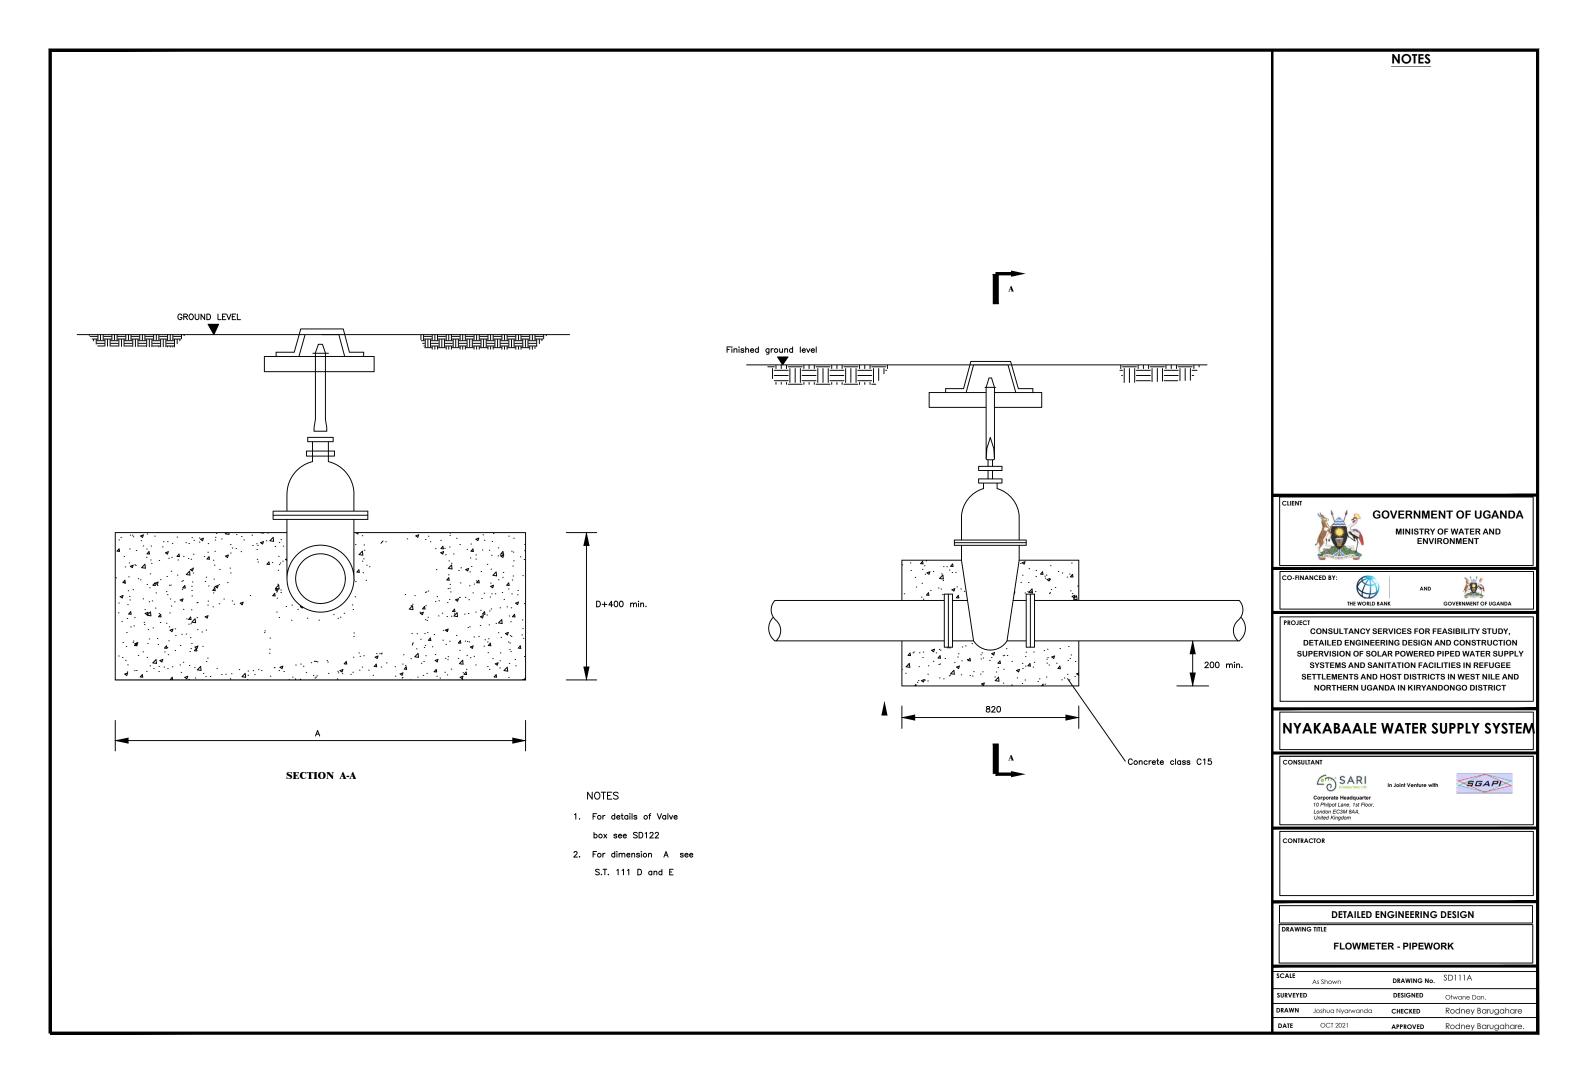

A/2 - Trench side 300 max. 300 max. A/2 Concrete to be cast against undisturbed ground 200 PLAN

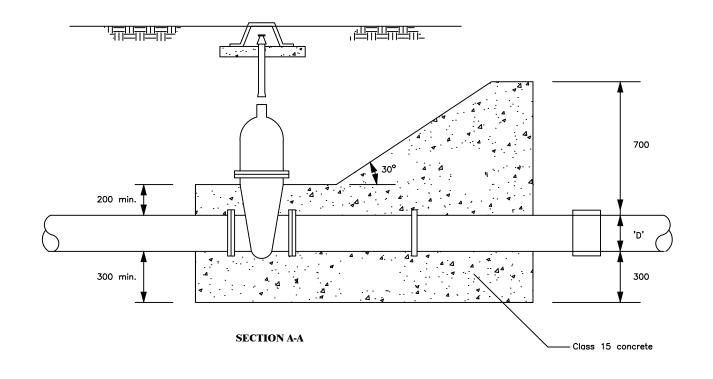

NOTES

- 1. For details of surface box see SD122
- 2. For dimension A see SD 111 D and E





GOVERNMENT OF UGANDA

MINISTRY OF WATER AND ENVIRONMENT





CONSULTANCY SERVICES FOR FEASIBILITY STUDY, DETAILED ENGINEERING DESIGN AND CONSTRUCTION SUPERVISION OF SOLAR POWERED PIPED WATER SUPPLY SYSTEMS AND SANITATION FACILITIES IN REFUGEE SETTLEMENTS AND HOST DISTRICTS IN WEST NILE AND NORTHERN UGANDA IN KIRYANDONGO DISTRICT

NYAKABAALE WATER SUPPLY SYSTEM






CONTRACTOR

DETAILED ENGINEERING DESIGN

GATE VALVE - TYPE 2

SCALE	As Shown	DRAWING No.	SD111B	
SURVEYED	SURVEYED DESIGNED		Otwane Dan.	
DRAWN	Joshua Nyarwanda	CHECKED	Rodney Barugahare	
DATE	OCT 2021	APPROVED	Rodney Barugahare.	

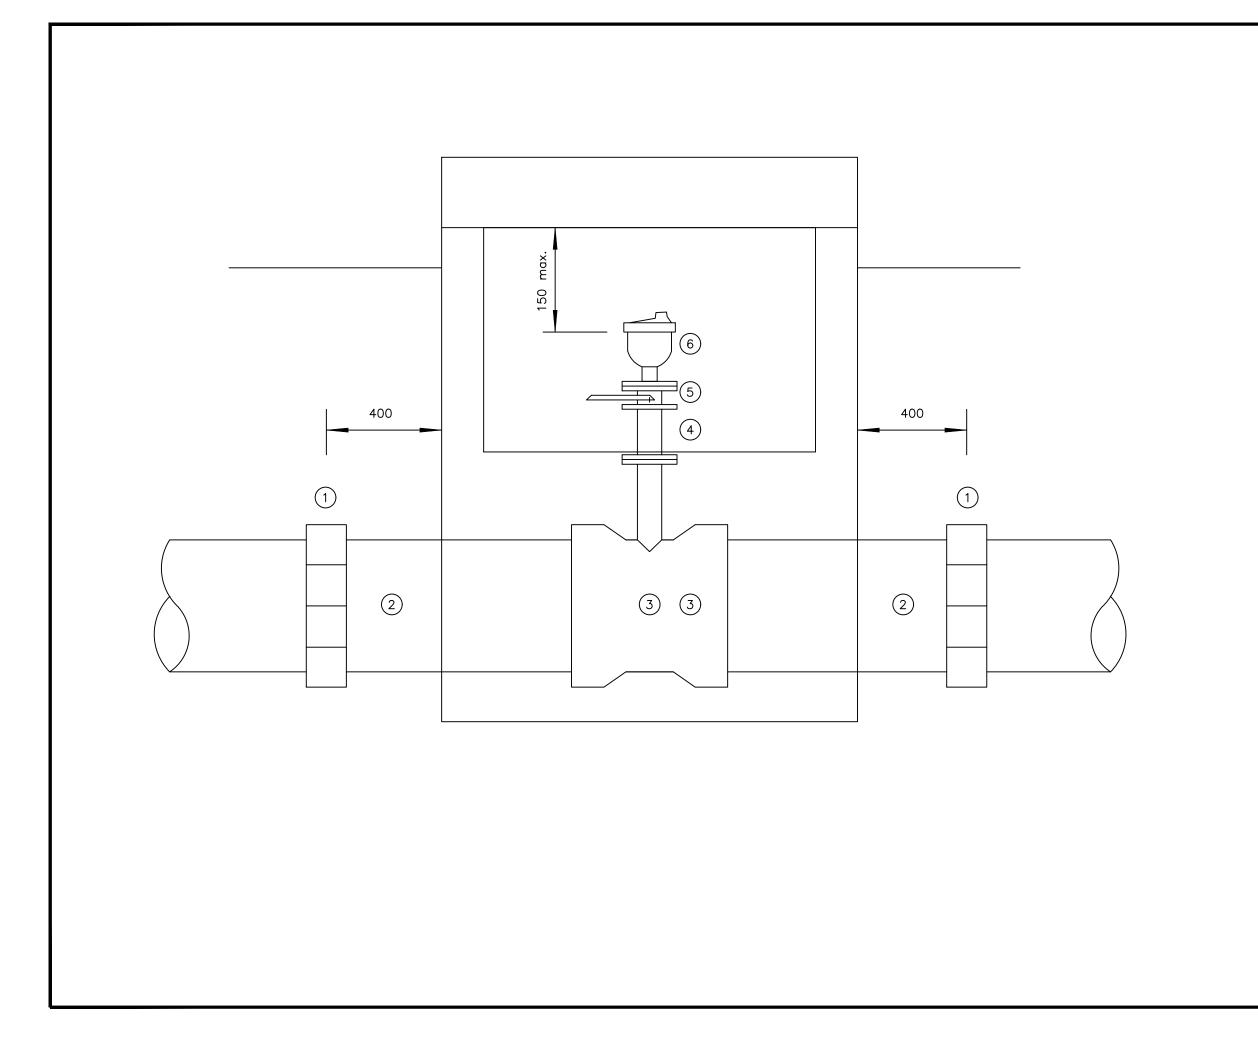

- 1 All dimensions are in millimetres
- 2 Flanged pipework to be ductile iron
- 3 Make up pipes to be ductile iron
- 4 Chamber to be 1200x900 internal dimensions

For details see standard drawing SD 112D

5 See General Notes

SCHEDULE

ITEM DESCRIPTION

- 1 Flexible adaptor if required
- 2 Make-up pipe
- 3 Socket tee flanged branch 80/50 dia as required
- 4 Flanged pipe 80/50 dia as required

main 100-300dia valve 50 dia

5 Isolating valve
6 Air valve

main 350-600dia valve 80dia



GOVERNMENT OF UGANDA

MINISTRY OF WATER AND ENVIRONMENT





PROJECT
CONSULTANCY SERVICES FOR FEASIBILITY STUDY, DETAILED ENGINEERING DESIGN AND CONSTRUCTION SUPERVISION OF SOLAR POWERED PIPED WATER SUPPLY SYSTEMS AND SANITATION FACILITIES IN REFUGEE SETTLEMENTS AND HOST DISTRICTS IN WEST NILE AND NORTHERN UGANDA IN KIRYANDONGO DISTRICT

NYAKABAALE WATER SUPPLY SYSTEM







CONTRACTOR


DETAILED ENGINEERING DESIGN

AIR VALVE PIPEWORK


SCALE	As Shown	DRAWING No.	SD112A
SURVEYED	١	DESIGNED	Otwane Dan.
DRAWN	Joshua Nyarwanda	CHECKED	Rodney Barugahare
DATE	OCT 2021	APPROVED	Rodney Barugahare.

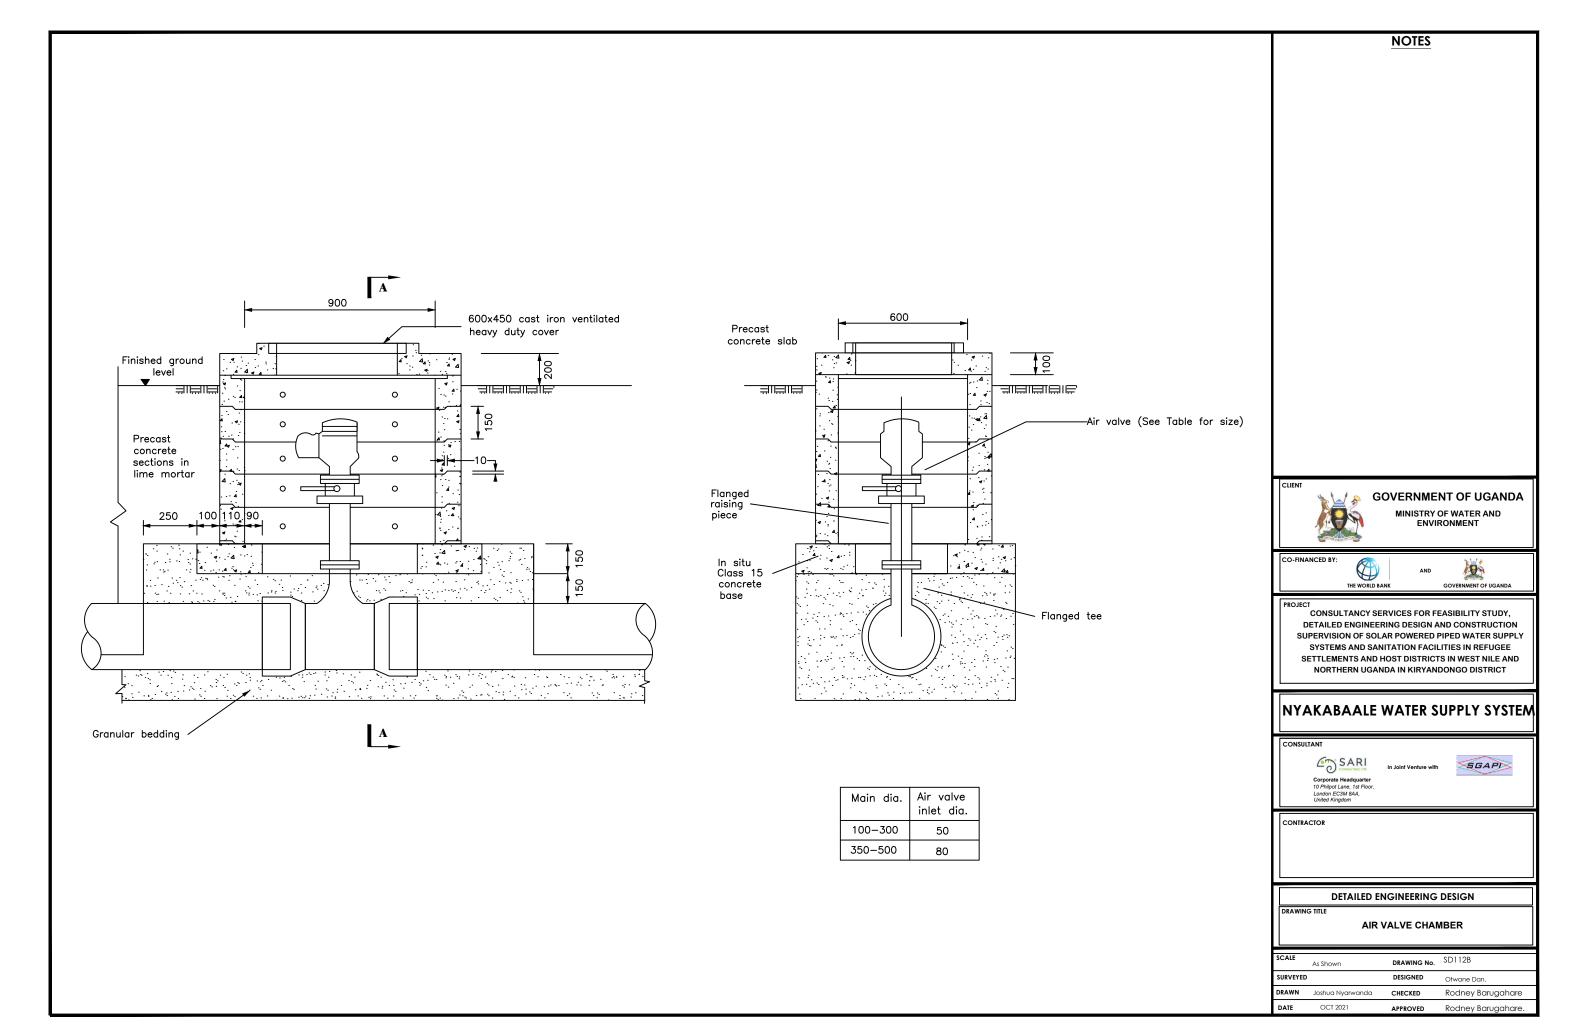

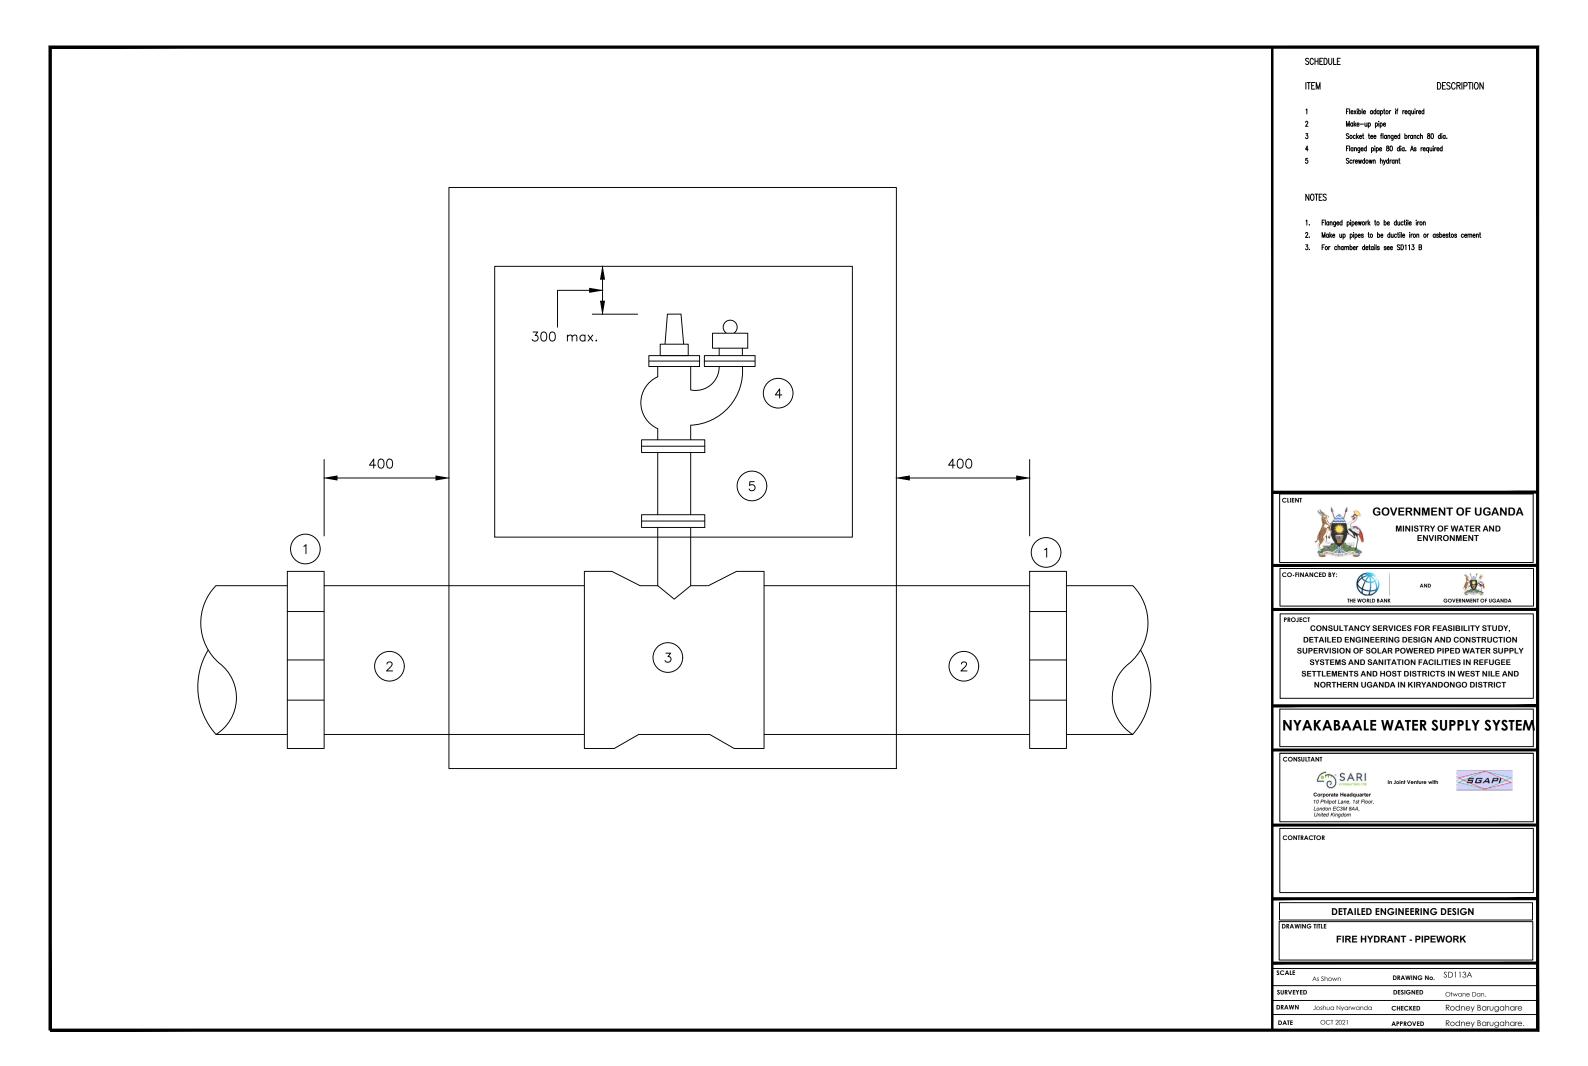

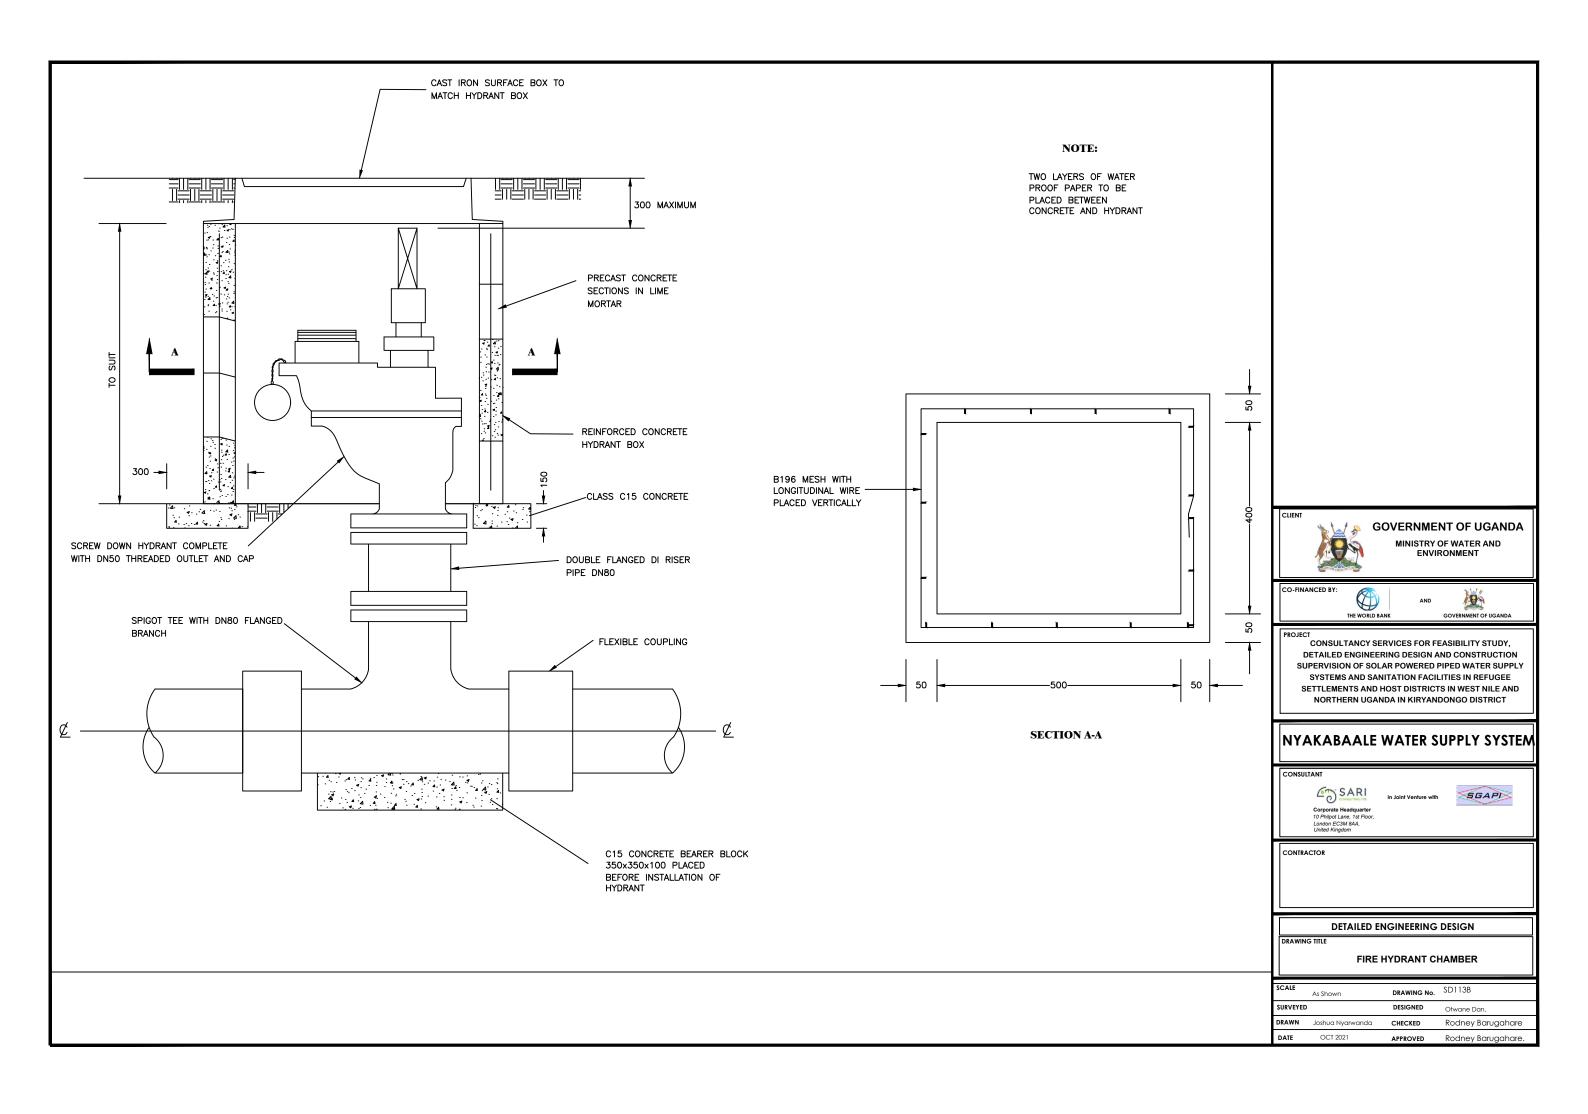


WO TYPE 1

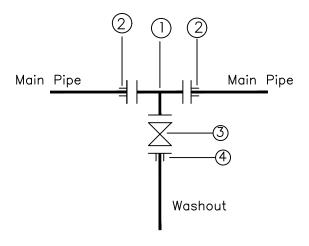

- 1 1No CI Flanged Tee DN A/B
- 2No DI Flange Adaptor, Maxi type or similar type DN A
- 3 1No CI Flanged Gate Valve DN A
- (4) 1No DI Flange Adaptor, Maxi type or similar DN B

WO TYPE 2

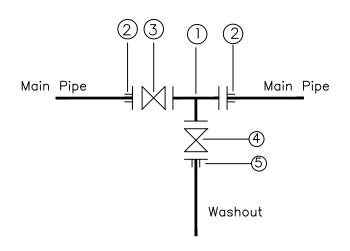

- 1 1No Cl Flanged Tee DN A/B
 2 2No Dl Flange Adaptor, Maxi type or similar type DN A
 1 1No Cl Flanged Gate Valve DN A
 1 1No Dl Flanged Gate Valve DN B

- (5) 1No DI Flange Adaptor, Maxi type or similar DN B

Pipe Diameter		Diameter
Washout	А	В
OD 50	DN 40	DN 40
OD 63	DN 50	OD 50
OD 63	DN 80	OD 50
OD 63	DN 100	OD 50
OD 63	DN 150	OD 50
OD 110	DN 200	OD 100
OD 110	DN 250	OD 100
OD 110	DN 300	OD 100
OD 110	DN 350	OD 100
OD 110	DN 400	OD 100
OD 110	DN 450	OD 100
	Washout OD 50 OD 63 OD 63 OD 63 OD 63 OD 110 OD 110 OD 110 OD 110 OD 110	Washout A OD 50 DN 40 OD 63 DN 50 OD 63 DN 80 OD 63 DN 100 OD 63 DN 150 OD 110 DN 200 OD 110 DN 250 OD 110 DN 350 OD 110 DN 350 OD 110 DN 400

NOTE: Pressure ratings of Washouts and Fittings shall be similar to those of the main pipe on which the washout is to be installed





CONSULTANCY SERVICES FOR FEASIBILITY STUDY, DETAILED ENGINEERING DESIGN AND CONSTRUCTION SUPERVISION OF SOLAR POWERED PIPED WATER SUPPLY SYSTEMS AND SANITATION FACILITIES IN REFUGEE SETTLEMENTS AND HOST DISTRICTS IN WEST NILE AND NORTHERN UGANDA IN KIRYANDONGO DISTRICT

NYAKABAALE WATER SUPPLY SYSTEM








DETAILED ENGINEERING DESIGN


WASHOUT DETAILS TYPE 1 & 2

SCALE	As Shown	DRAWING No.	SD114A
SURVEYED		DESIGNED	Otwane Dan.
DRAWN	Joshua Nyarwanda	CHECKED	Rodney Barugahare
DATE	OCT 2021	APPROVED	Rodney Barugahare.

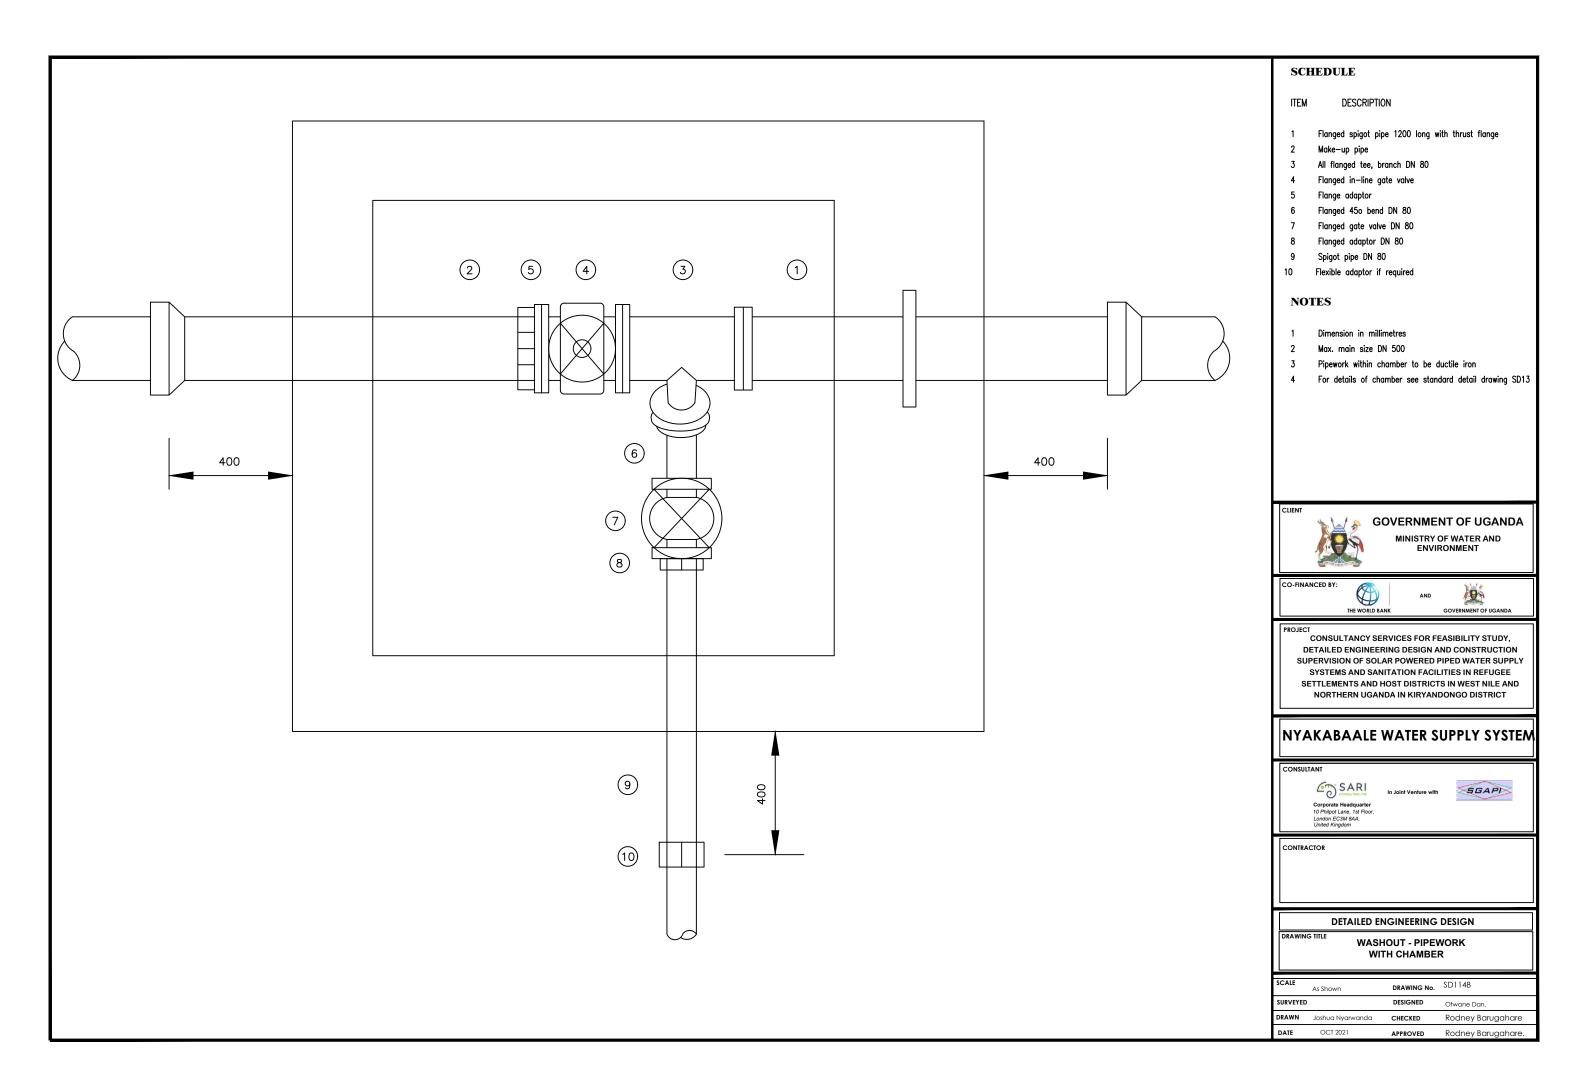


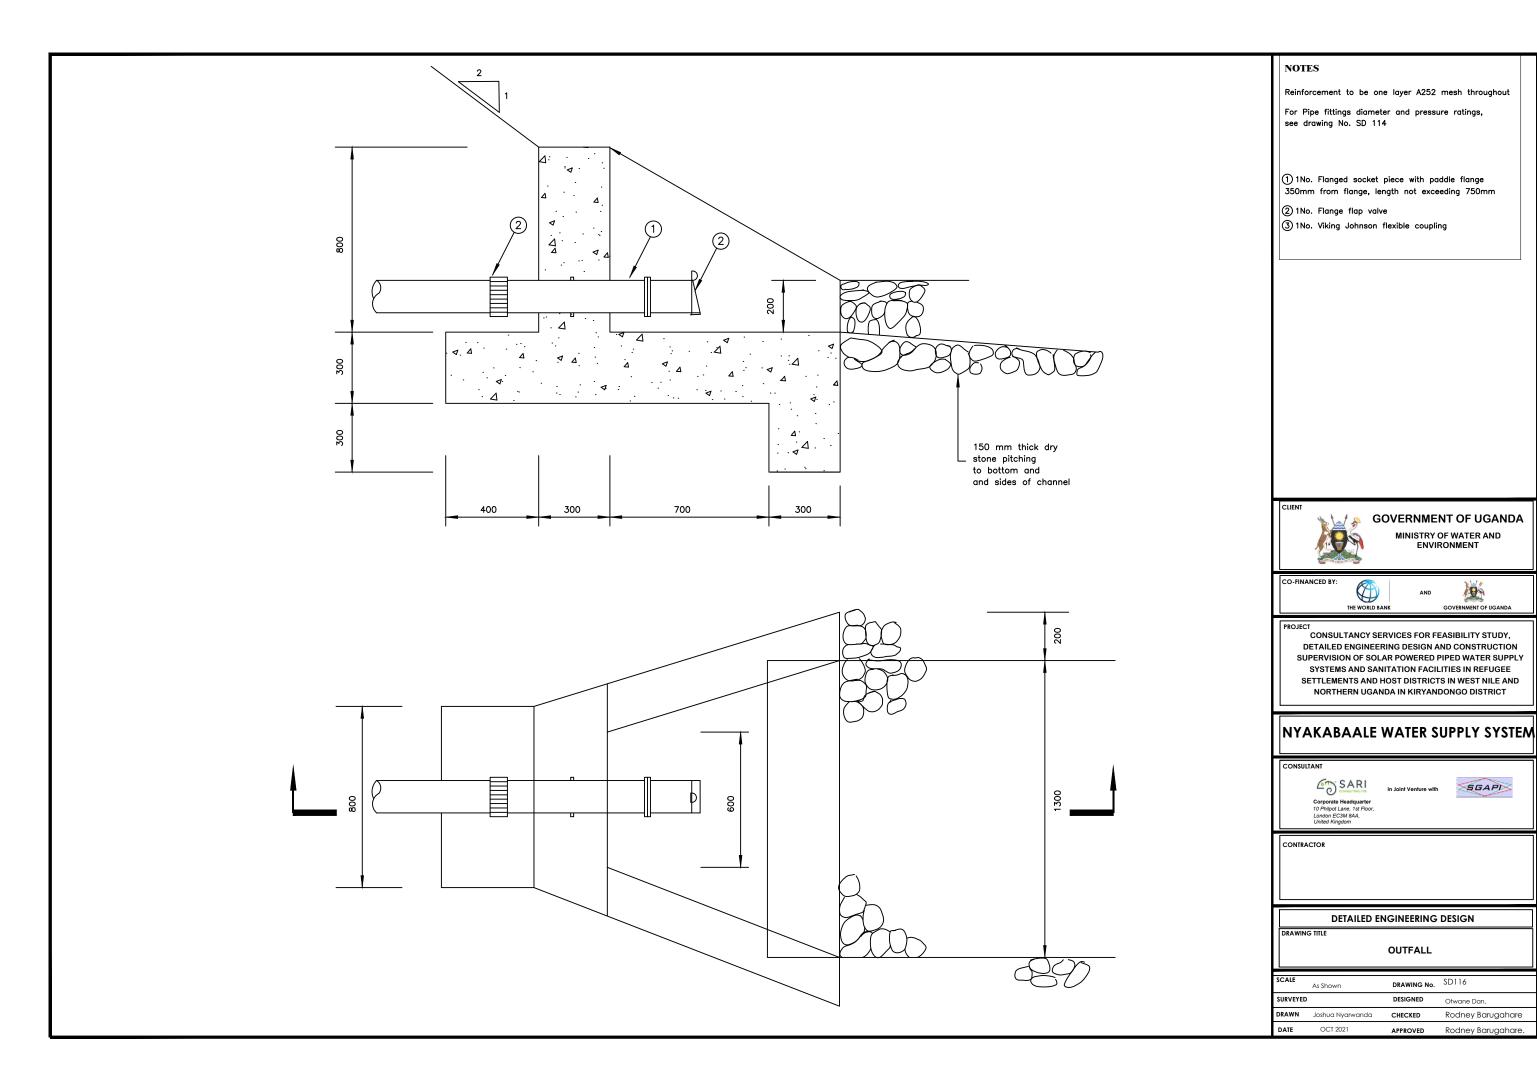

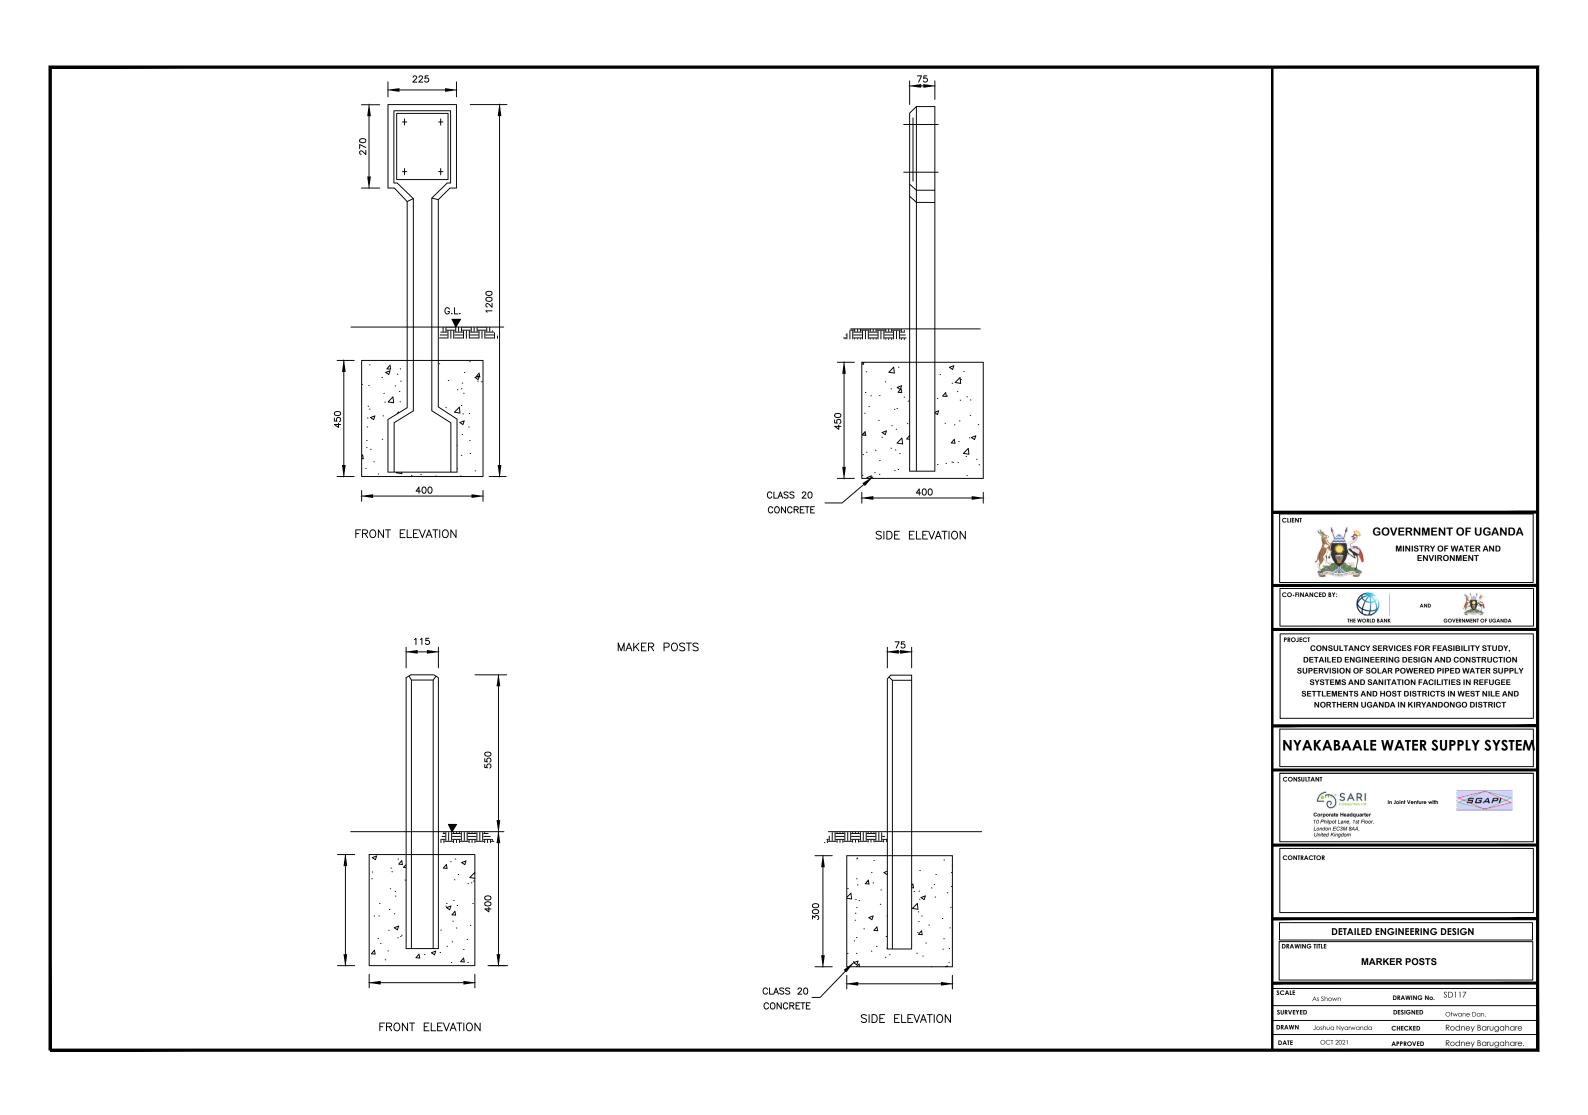

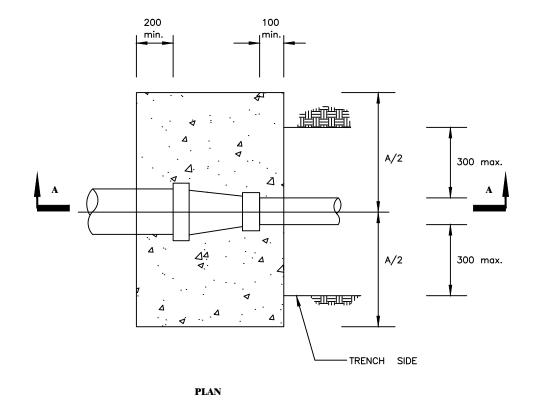



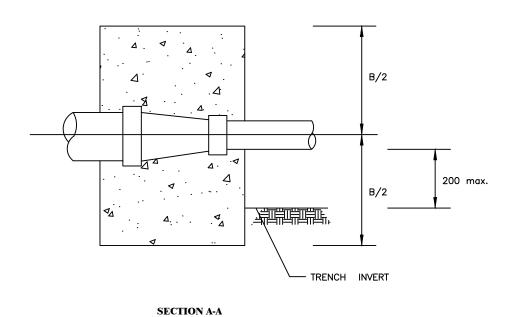

GROUND CONDITION		DRY	SUBMERGED
TEST PRESSURE (BAR)		15	15
80 - 50	A	850	850
	В	650	650
100 - 50	А	1020	1020
100 - 80	В	680	680
150 - 100	Α	1300	1300
	В	700	1000
200 - 100	А	1700	1900
	В	700	1000
200 - 150	A	1350	1350
	В	750	950
250 -100	А	2150	2250
	В	750	1250
250 - 150	А	1950	1950
	В	750	1250
250 - 200	A	1400	1400
	В	800	1200
300 - 200	А	2050	2050
	В	1000	1600
300 - 250	A	1450	1450
	В	850	1350
350 - 300	A	1250	1650
	В	1000	1200
500 - 400	A	2000	2300
	В	1400	1800



GOVERNMENT OF UGANDA

MINISTRY OF WATER AND ENVIRONMENT

CO-FINANCED B



ND D

PROJECT

CONSULTANCY SERVICES FOR FEASIBILITY STUDY,
DETAILED ENGINEERING DESIGN AND CONSTRUCTION
SUPERVISION OF SOLAR POWERED PIPED WATER SUPPLY
SYSTEMS AND SANITATION FACILITIES IN REFUGEE
SETTLEMENTS AND HOST DISTRICTS IN WEST NILE AND
NORTHERN UGANDA IN KIRYANDONGO DISTRICT

NYAKABAALE WATER SUPPLY SYSTEM

CONSULTAN



In Joint Venture with




CONTRACTOR

DETAILED ENGINEERING DESIGN


DRAWING TITLE

ANCHOR BLOCKS FOR TAPERS

SCALE	As Shown	DRAWING No.	SD118A
SURVEYED)	DESIGNED	Otwane Dan.
DRAWN	Joshua Nyarwanda	CHECKED	Rodney Barugahare
DATE	OCT 2021	APPROVED	Rodney Barugahare.

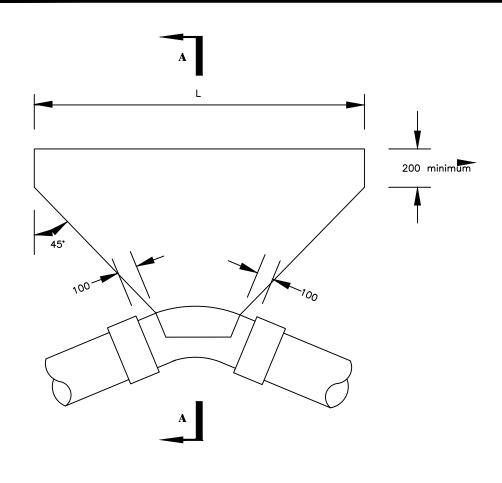

PLAN

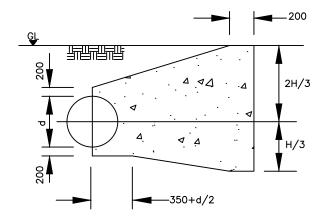

SECTION A-A

Ground Condition			DRY			
Test Pressure (Bar)			15			
Ber	nd Angle		111/4*	22½*	45°	90*
	80	H				
		Н	SEE SD 118C			
(80 < d < 150	L				
DIAMETER (mm)	150 < d < 300 300 < d < 400	Н				
~		L				
111		н			1600	1600
IAME		L			2450	4530
	450	Н			1650	1650
PIPE		L			2900	5330
-		Н	1000	1350	1800	1800
	500	L	1250	1950	3050	5650





GOVERNMENT OF UGANDA

MINISTRY OF WATER AND ENVIRONMENT





PROJECT
CONSULTANCY SERVICES FOR FEASIBILITY STUDY, DETAILED ENGINEERING DESIGN AND CONSTRUCTION SUPERVISION OF SOLAR POWERED PIPED WATER SUPPLY SYSTEMS AND SANITATION FACILITIES IN REFUGEE SETTLEMENTS AND HOST DISTRICTS IN WEST NILE AND NORTHERN UGANDA IN KIRYANDONGO DISTRICT

NYAKABAALE WATER SUPPLY SYSTEM






DETAILED ENGINEERING DESIGN

ANCHOR BLOCKS FOR BENDS - 1

SCALE	As Shown	DRAWING No.	SD118B
SURVEYED		DESIGNED	Otwane Dan.
DRAWN	Joshua Nyarwanda	CHECKED	Rodney Barugahare
DATE	OCT 2021	APPROVED	Rodney Barugahare.

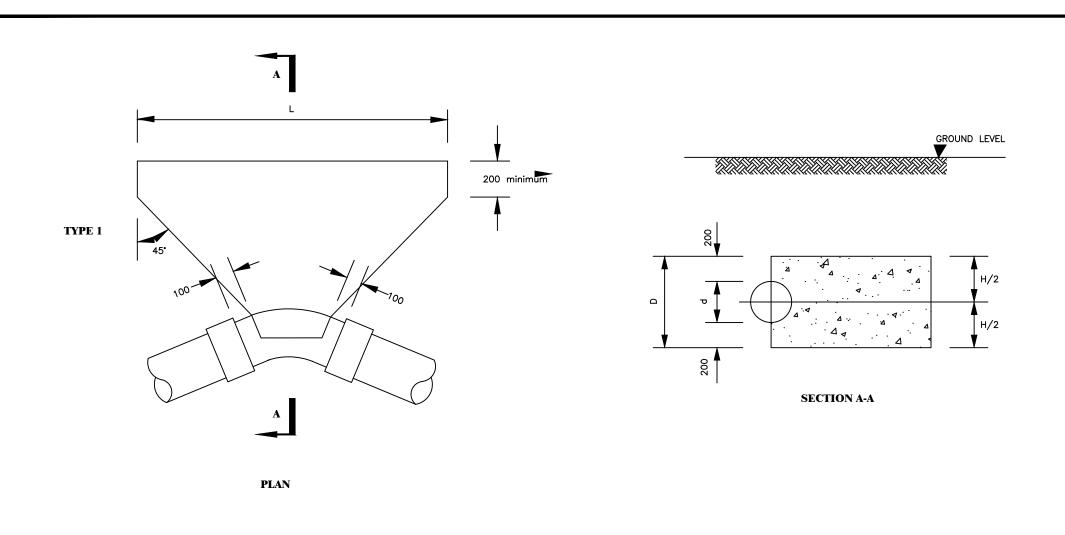

GRO	GROUND CONDITION			DRY			
TES	TEST PRESSURE(Bar)			15			
BEN	BEND ANGLE		11¼°	22½*	45°	90*	
	80	Н	480	460	480	460	
		L	200	300	350	700	
	80 < d < 150	Н	550	550	550	550	
		L	300	750	900	1700	
	150 < d < 3QQ	Н	700	700	700		
Ē		L	650	1250	2500		
٤	300 < d < 490	Н	800	800		_	
PIPE DIAMETER (mm)		L	900	1800			
	450	Н	900	900			
		L	2500	5000			
	500		SEE SD 118A				





GOVERNMENT OF UGANDA

MINISTRY OF WATER AND ENVIRONMENT



CONSULTANCY SERVICES FOR FEASIBILITY STUDY, DETAILED ENGINEERING DESIGN AND CONSTRUCTION SUPERVISION OF SOLAR POWERED PIPED WATER SUPPLY SYSTEMS AND SANITATION FACILITIES IN REFUGEE SETTLEMENTS AND HOST DISTRICTS IN WEST NILE AND NORTHERN UGANDA IN KIRYANDONGO DISTRICT

NYAKABAALE WATER SUPPLY SYSTEM






DETAILED ENGINEERING DESIGN

ANCHOR BLOCKS FOR BENDS - 2

SCALE				
SCALE	As Shown	DRAWING No.	SD118C	
SURVEYE	D	DESIGNED	Otwane Dan.	
DRAWN	Joshua Nyarwanda	CHECKED	Rodney Barugahare	
DATE	OCT 2021	APPROVED	Rodney Barugahare.	

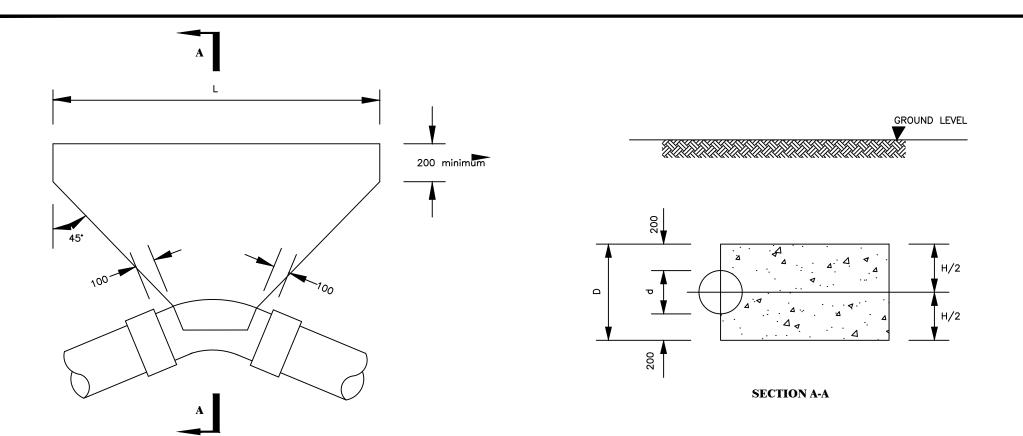

PLAN

GROUND CONDITION			SUBMERGED			
TEST PRESSURE (Bar)			15			
BEI	ND ANGLE		11¼°	22½*	45*	90°
	80	Н	450	480	480	480
		L	250	300	600	1100
(mm)	80 < d < 150	Н	550	550	550	
		L	400	750	1500	
	150 < d < 3QQ	Н	700	700		-
		L	1050	2050		
	300 < d < 4QQ	Н	800	800		
PIPE DIAMETER		L	1500	1500		
	450	Н	900		_	
		L	4200			
		Н	SEE SD 118E			
	500	L				

NOTE:

Two layers of water proof paper to be placed between concrete fitting



GOVERNMENT OF UGANDA

MINISTRY OF WATER AND ENVIRONMENT





SETTLEMENTS AND HOST DISTRICTS IN WEST NILE AND NORTHERN UGANDA IN KIRYANDONGO DISTRICT

CONSULTANCY SERVICES FOR FEASIBILITY STUDY, DETAILED ENGINEERING DESIGN AND CONSTRUCTION SUPERVISION OF SOLAR POWERED PIPED WATER SUPPLY SYSTEMS AND SANITATION FACILITIES IN REFUGEE

NYAKABAALE WATER SUPPLY SYSTEM







CONTRACTOR

DETAILED ENGINEERING DESIGN

ANCHOR BLOCKS FOR BENDS - 3

SCALE As Shown		DRAWING No.	SD118D	
SURVEYED		DESIGNED	Otwane Dan.	
DRAWN	Joshua Nyarwanda	CHECKED	Rodney Barugahare	
DATE	OCT 2021	APPROVED	Rodney Barugahare.	

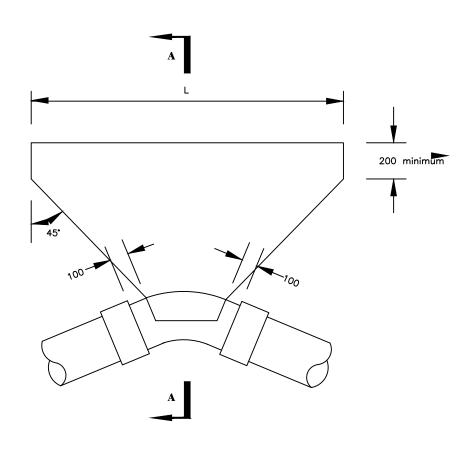

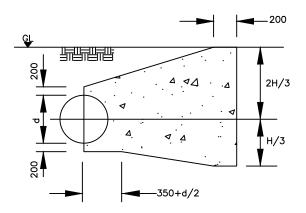

SECTION A-A

PLAN

Ground Condition Test Pressure (Bar)			SUBMERGED 15			
Ber	nd Angle		11¼*	22%*	45*	90°
	80	H				
	80 < d < 150	Н	-	SEE SD 118D 1350		
		L				1650
	150 < d < 300	Н			1500	1500
Ē		L			2650	4900
DIAMETER (mm)		Н			1600	1700
ÆTER	300 < d < 4QQ	L			4050	6650
		Н		1650	1650	1800
PIPE	450	L		2450	4750	6650
ш.		Н	1400	1800	1800	1800
	500	L	1650	2850	5450	10150

NOTE:

Two layers of water proof paper to be placed between concrete fitting



GOVERNMENT OF UGANDA

MINISTRY OF WATER AND ENVIRONMENT

CO-FINANCED B



ND D

PROJECT

CONSULTANCY SERVICES FOR FEASIBILITY STUDY,
DETAILED ENGINEERING DESIGN AND CONSTRUCTION
SUPERVISION OF SOLAR POWERED PIPED WATER SUPPLY
SYSTEMS AND SANITATION FACILITIES IN REFUGEE
SETTLEMENTS AND HOST DISTRICTS IN WEST NILE AND
NORTHERN UGANDA IN KIRYANDONGO DISTRICT

NYAKABAALE WATER SUPPLY SYSTEM

CONSULTANT




In Joint Venture with





CONTRACTOR

DETAILED ENGINEERING DESIGN

SCALE	As Shown	DRAWING No.	SD118E
SURVEYED		DESIGNED	Otwane Dan.
DRAWN	Joshua Nyarwanda	CHECKED	Rodney Barugahare
DATE	OCT 2021	APPROVED	Rodney Barugahare.

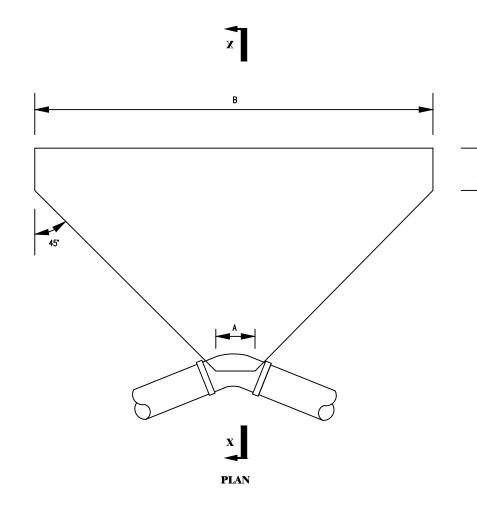

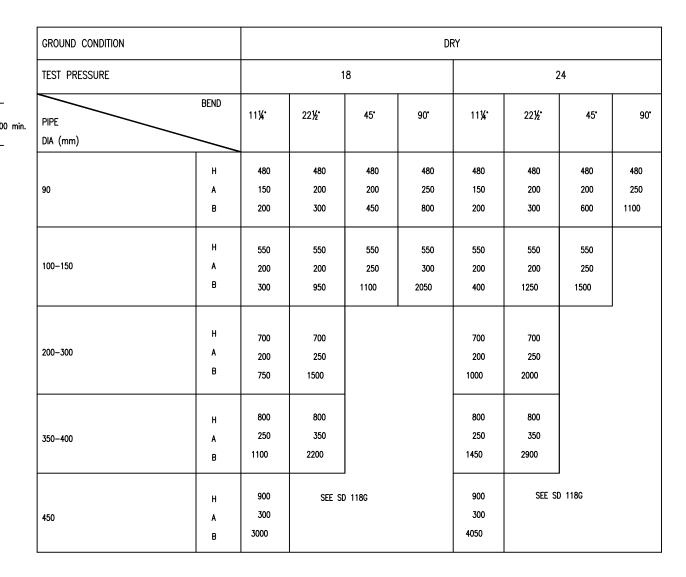

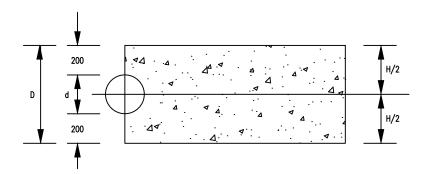

NOTE:

Two layers of water proof paper to be placed between concrete fitting

GOVERNMENT OF UGANDA

MINISTRY OF WATER AND ENVIRONMENT





CONSULTANCY SERVICES FOR FEASIBILITY STUDY, DETAILED ENGINEERING DESIGN AND CONSTRUCTION SUPERVISION OF SOLAR POWERED PIPED WATER SUPPLY SYSTEMS AND SANITATION FACILITIES IN REFUGEE SETTLEMENTS AND HOST DISTRICTS IN WEST NILE AND NORTHERN UGANDA IN KIRYANDONGO DISTRICT


NYAKABAALE WATER SUPPLY SYSTEM






DETAILED ENGINEERING DESIGN

SCALE	As Shown	DRAWING No.	SD118F
SURVEYE	:D	DESIGNED	Otwane Dan.
DRAWN	Joshua Nyarwanda	CHECKED	Rodney Barugahare
DATE	OCT 2021	APPROVED	Rodney Barugahare.

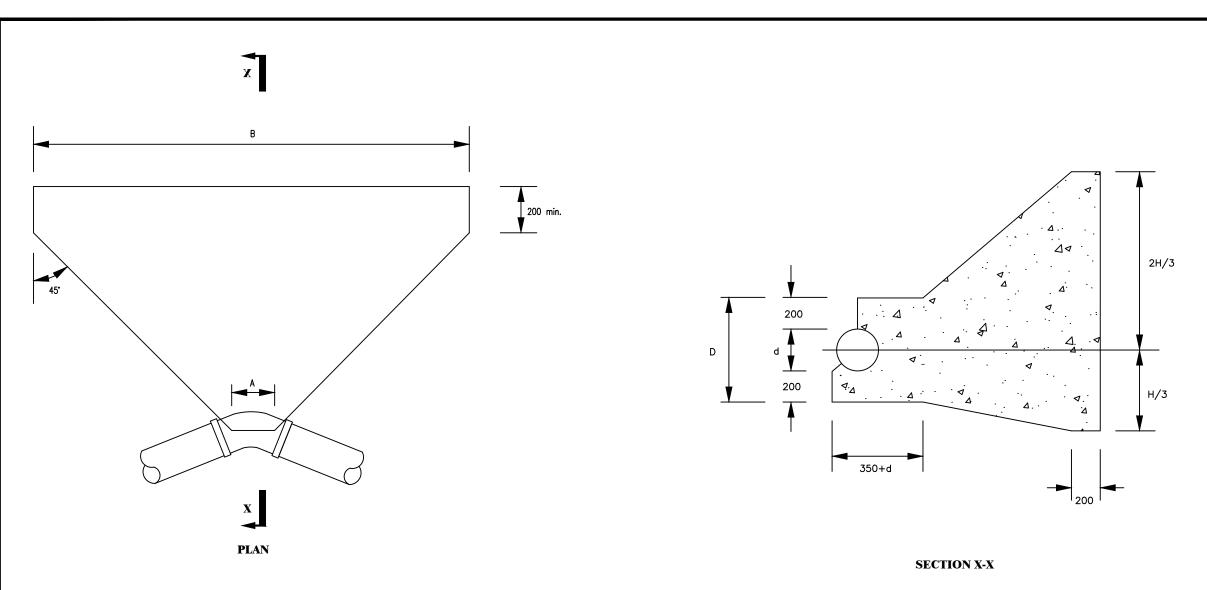

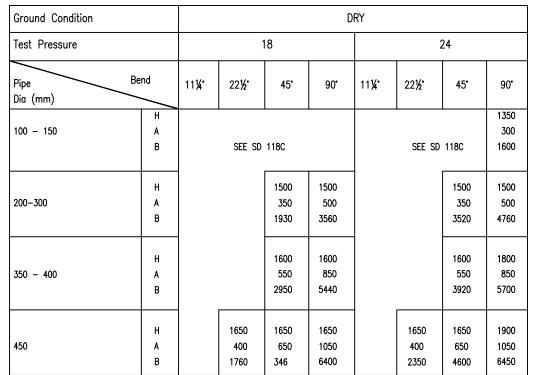



GOVERNMENT OF UGANDA

MINISTRY OF WATER AND ENVIRONMENT





CONSULTANCY SERVICES FOR FEASIBILITY STUDY, DETAILED ENGINEERING DESIGN AND CONSTRUCTION SUPERVISION OF SOLAR POWERED PIPED WATER SUPPLY SYSTEMS AND SANITATION FACILITIES IN REFUGEE SETTLEMENTS AND HOST DISTRICTS IN WEST NILE AND NORTHERN UGANDA IN KIRYANDONGO DISTRICT


NYAKABAALE WATER SUPPLY SYSTEM







DETAILED ENGINEERING DESIGN

SCALE	As Shown	DRAWING No.	SD118G
SURVEYED)	DESIGNED	Otwane Dan.
DRAWN	Joshua Nyarwanda	CHECKED	Rodney Barugahare
DATE	OCT 2021	APPROVED	Rodney Barugahare.

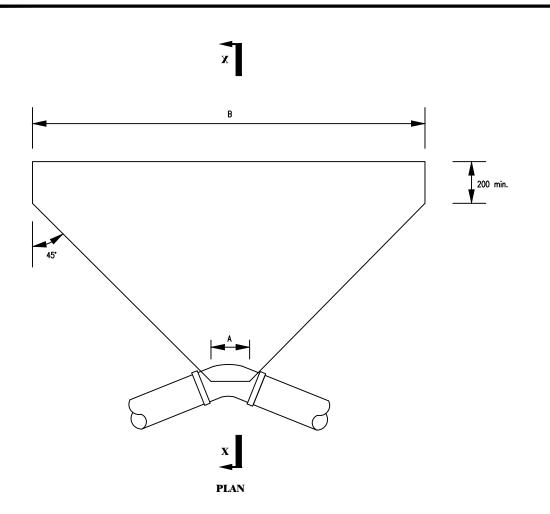

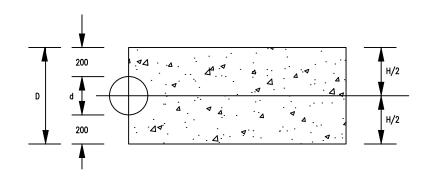

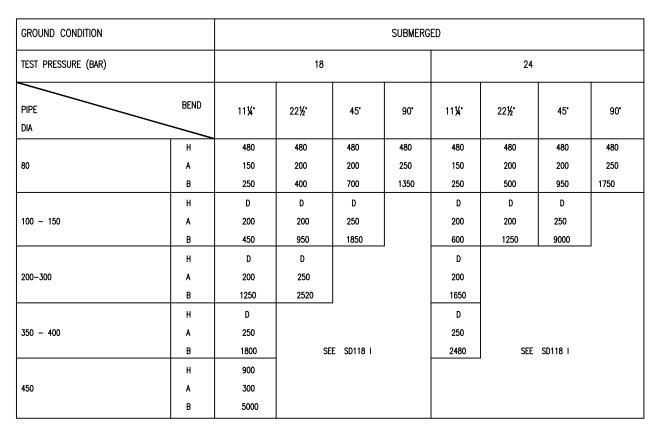





GOVERNMENT OF UGANDA

MINISTRY OF WATER AND ENVIRONMENT





CONSULTANCY SERVICES FOR FEASIBILITY STUDY, DETAILED ENGINEERING DESIGN AND CONSTRUCTION SUPERVISION OF SOLAR POWERED PIPED WATER SUPPLY SYSTEMS AND SANITATION FACILITIES IN REFUGEE SETTLEMENTS AND HOST DISTRICTS IN WEST NILE AND NORTHERN UGANDA IN KIRYANDONGO DISTRICT


NYAKABAALE WATER SUPPLY SYSTEM






DETAILED ENGINEERING DESIGN

SCALE	As Shown	DRAWING No.	SD118H
SURVEYED		DESIGNED	Otwane Dan.
DRAWN	Joshua Nyarwanda	CHECKED	Rodney Barugahare
DATE	OCT 2021	APPROVED	Rodney Barugahare.

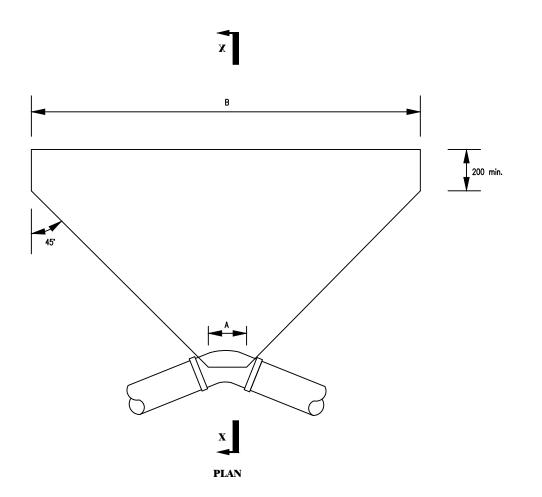

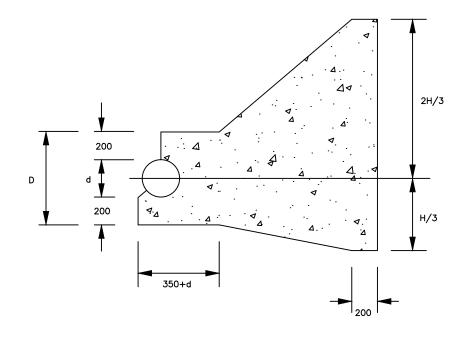

Ground Condition		SUBMERGED							
Test Pressure				18			:	24	
Pipe Dia (mm)	Bend	111/4*	22½*	45*	90*	111/4*	22½*	45*	90°
100 - 150	H A B		SEE SD	118D	1350 300 2000		SEE SD	118D	1350 300 2650
200-300	H A B			1500 350 3200	1500 500 5900		1500 250 2150	1500 350 4250	1500 500 7850
350 - 400	H A B		1600 350 2500	1600 550 4850	1800 850 7100		1600 350 3300	1600 550 6500	2000 850 7650
450	H A B		1650 400 2900	1650 650 5700	2000 1050 7200	1650 250 1950	1650 400 3900	1650 650 7600	2200 1050 7900



GOVERNMENT OF UGANDA

MINISTRY OF WATER AND ENVIRONMENT



CONSULTANCY SERVICES FOR FEASIBILITY STUDY, DETAILED ENGINEERING DESIGN AND CONSTRUCTION SUPERVISION OF SOLAR POWERED PIPED WATER SUPPLY SYSTEMS AND SANITATION FACILITIES IN REFUGEE SETTLEMENTS AND HOST DISTRICTS IN WEST NILE AND NORTHERN UGANDA IN KIRYANDONGO DISTRICT


NYAKABAALE WATER SUPPLY SYSTEM






DETAILED ENGINEERING DESIGN

SCALE	As Shown	DRAWING No.	SD118I
SURVEYE	D	DESIGNED	Otwane Dan.
DRAWN	Joshua Nyarwanda	CHECKED	Rodney Barugahare
DATE	OCT 2021	APPROVED	Rodney Barugahare.

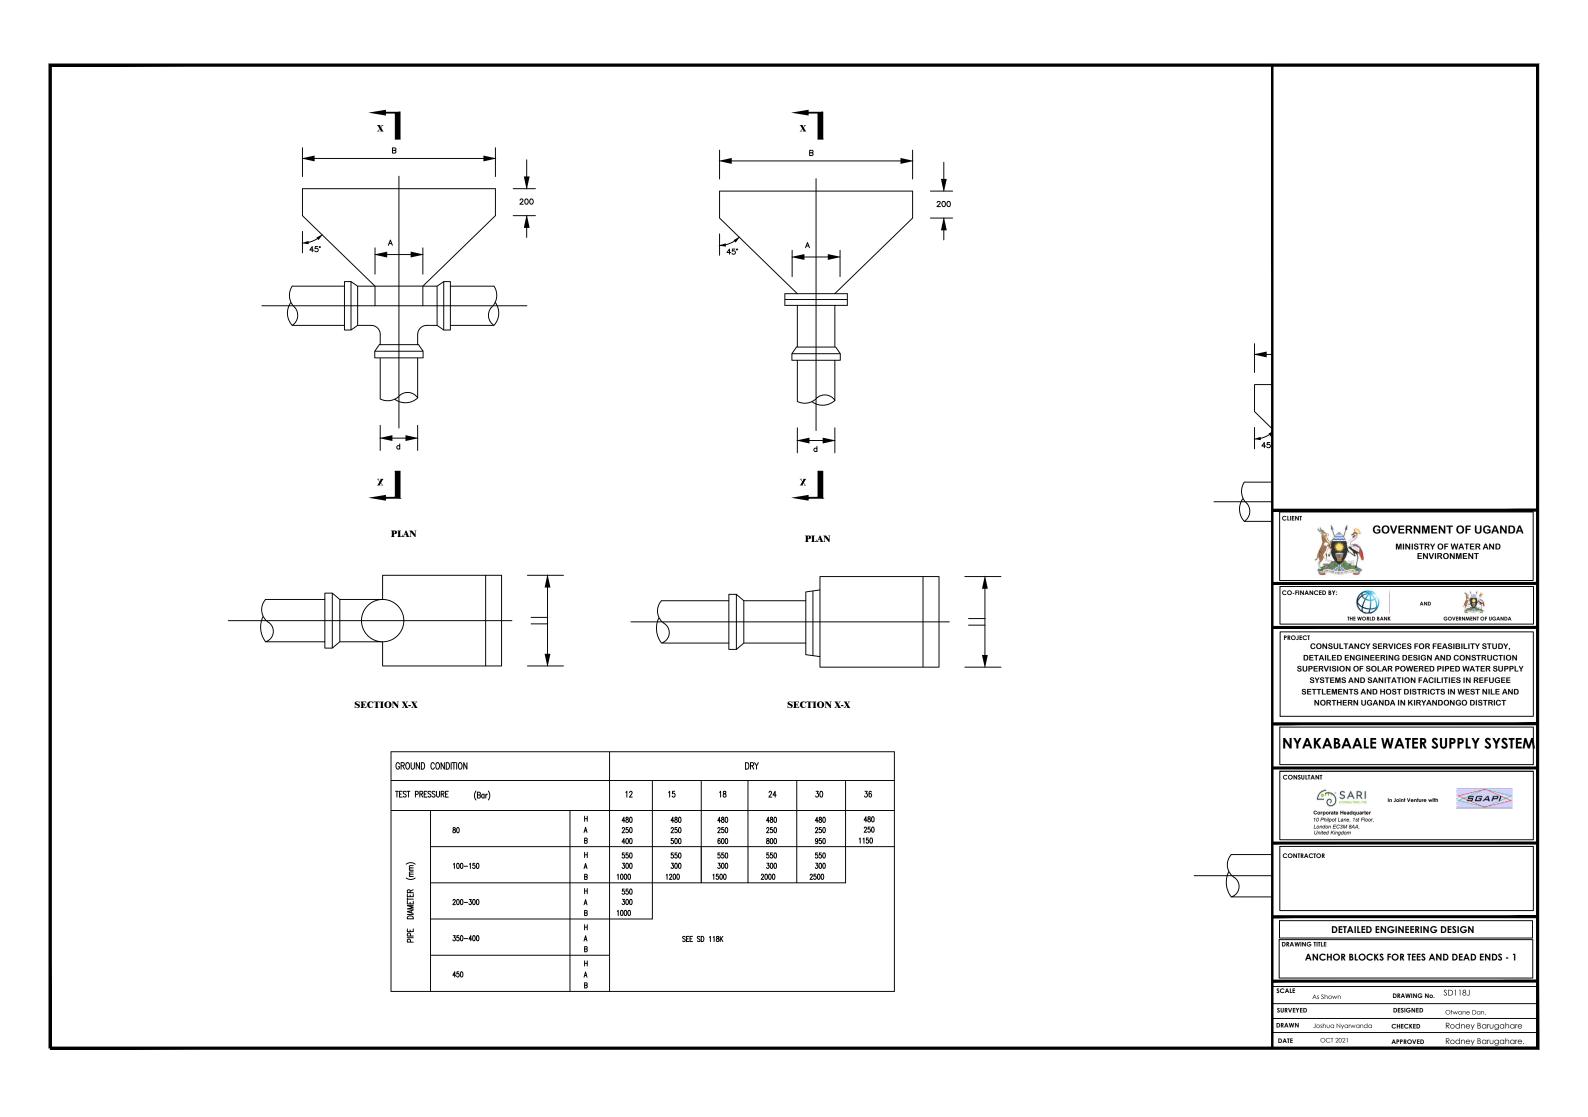

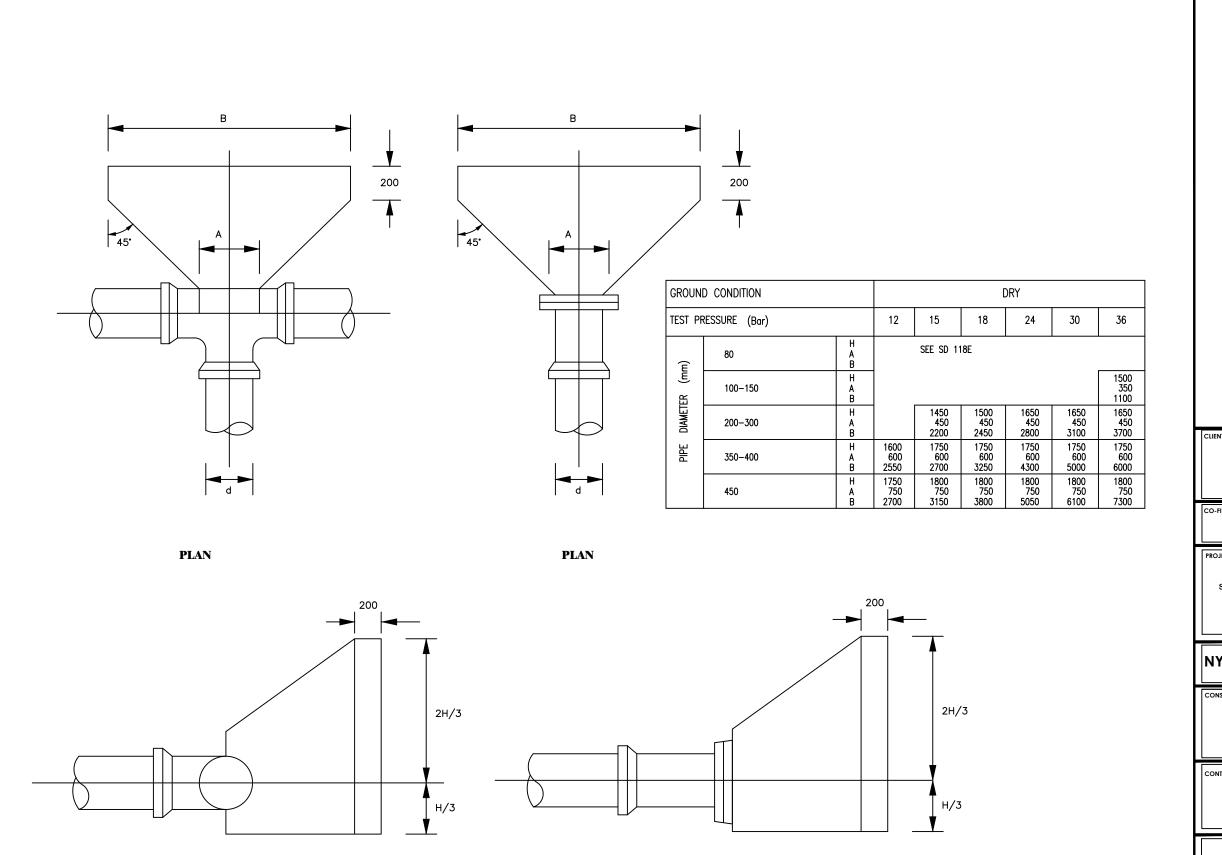

SECTION X-X



GOVERNMENT OF UGANDA

MINISTRY OF WATER AND ENVIRONMENT





CONSULTANCY SERVICES FOR FEASIBILITY STUDY, DETAILED ENGINEERING DESIGN AND CONSTRUCTION SUPERVISION OF SOLAR POWERED PIPED WATER SUPPLY SYSTEMS AND SANITATION FACILITIES IN REFUGEE SETTLEMENTS AND HOST DISTRICTS IN WEST NILE AND NORTHERN UGANDA IN KIRYANDONGO DISTRICT

NYAKABAALE WATER SUPPLY SYSTEM








DETAILED ENGINEERING DESIGN


ANCHOR BLOCKS FOR TEES AND DEAD ENDS - 2


SCALE	As Shown	DRAWING No.	SD118K
SURVEYE	D	DESIGNED	Otwane Dan.
DRAWN	Joshua Nyarwanda	CHECKED	Rodney Barugahare
DATE	OCT 2021	APPROVED	Rodney Barugahare.

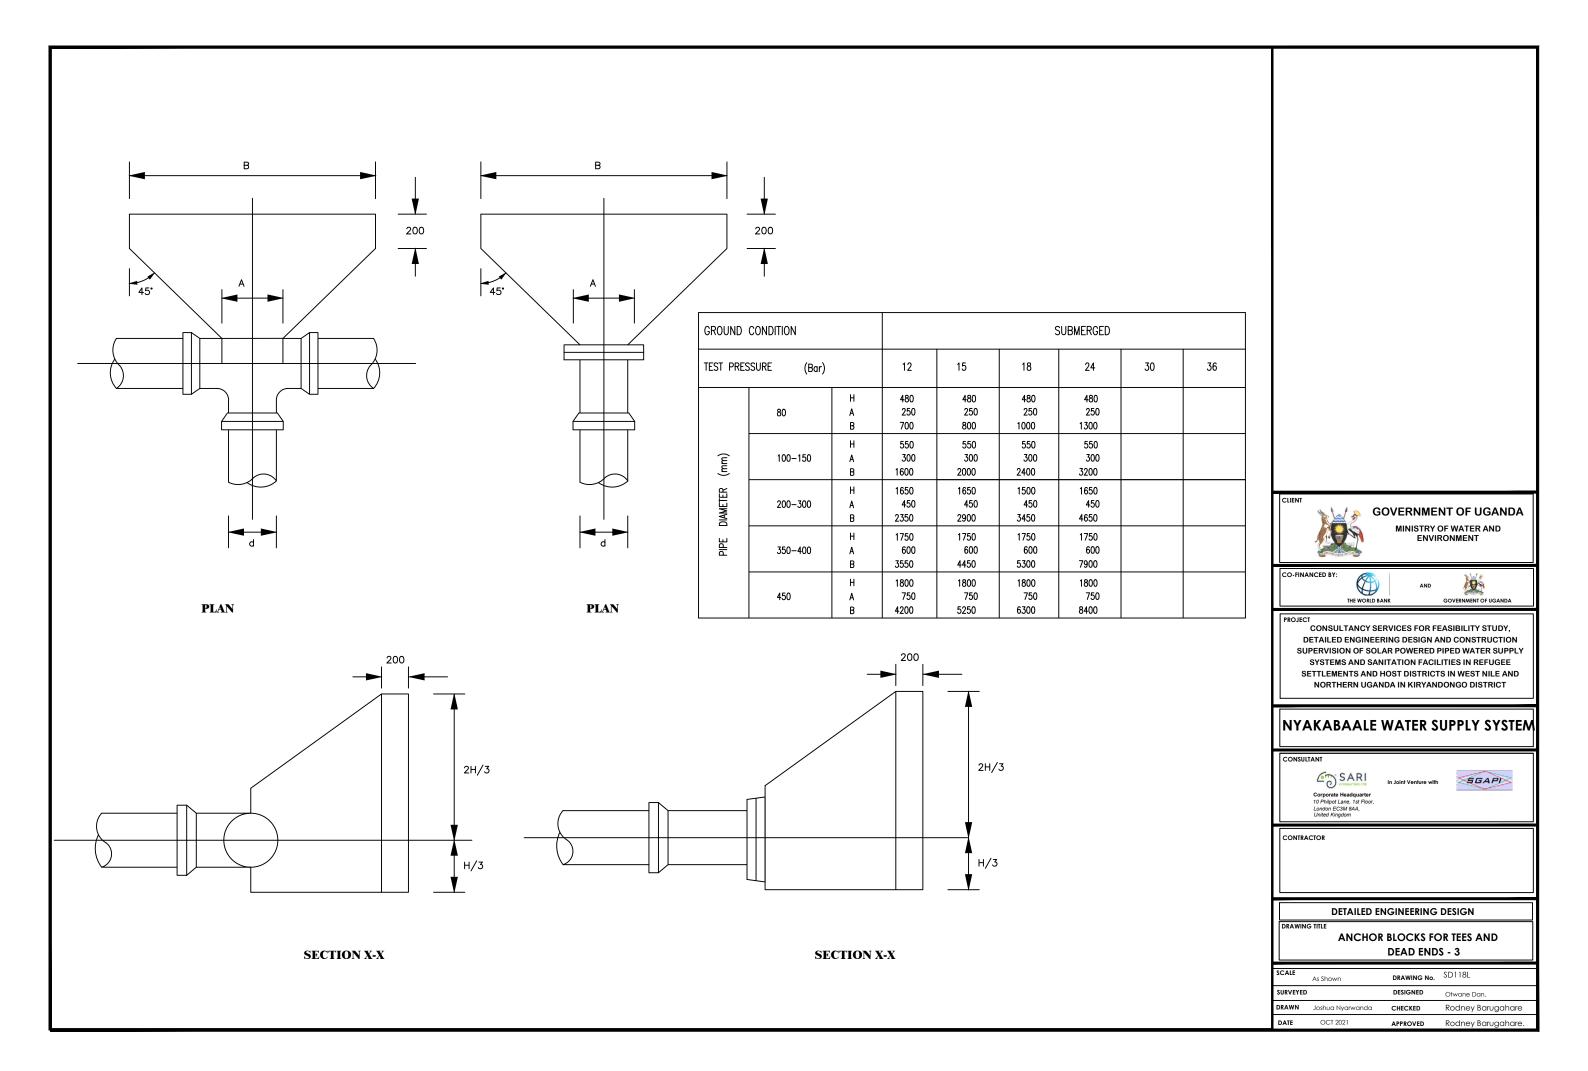


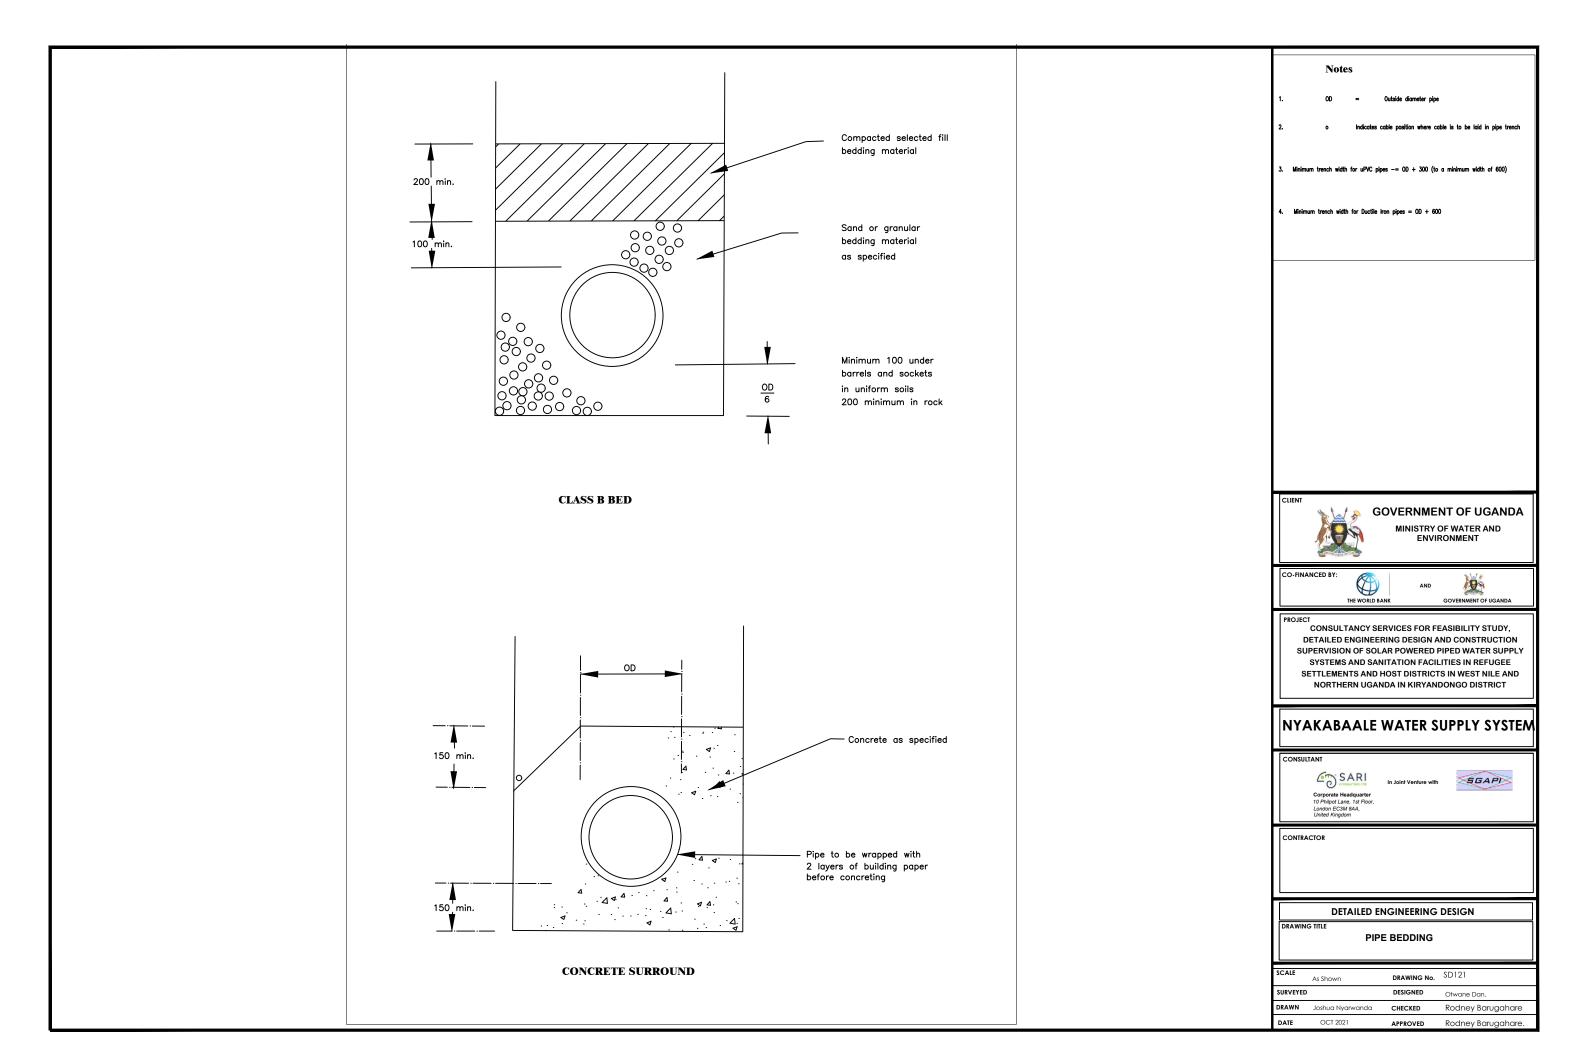


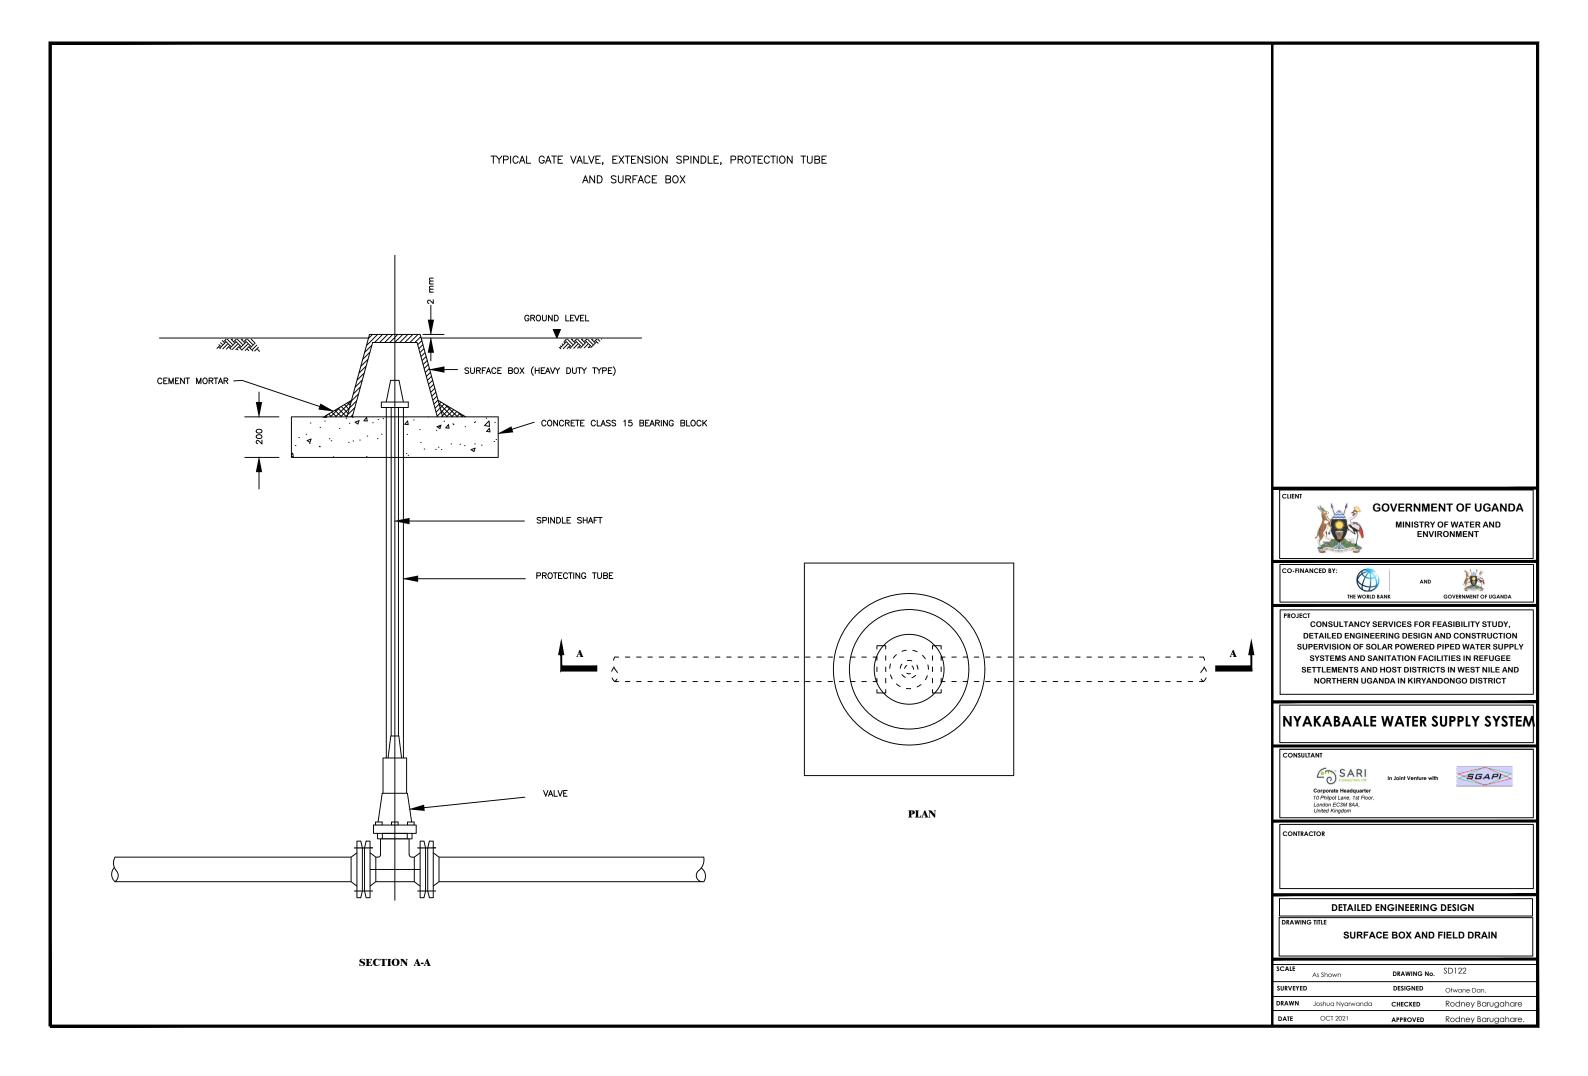


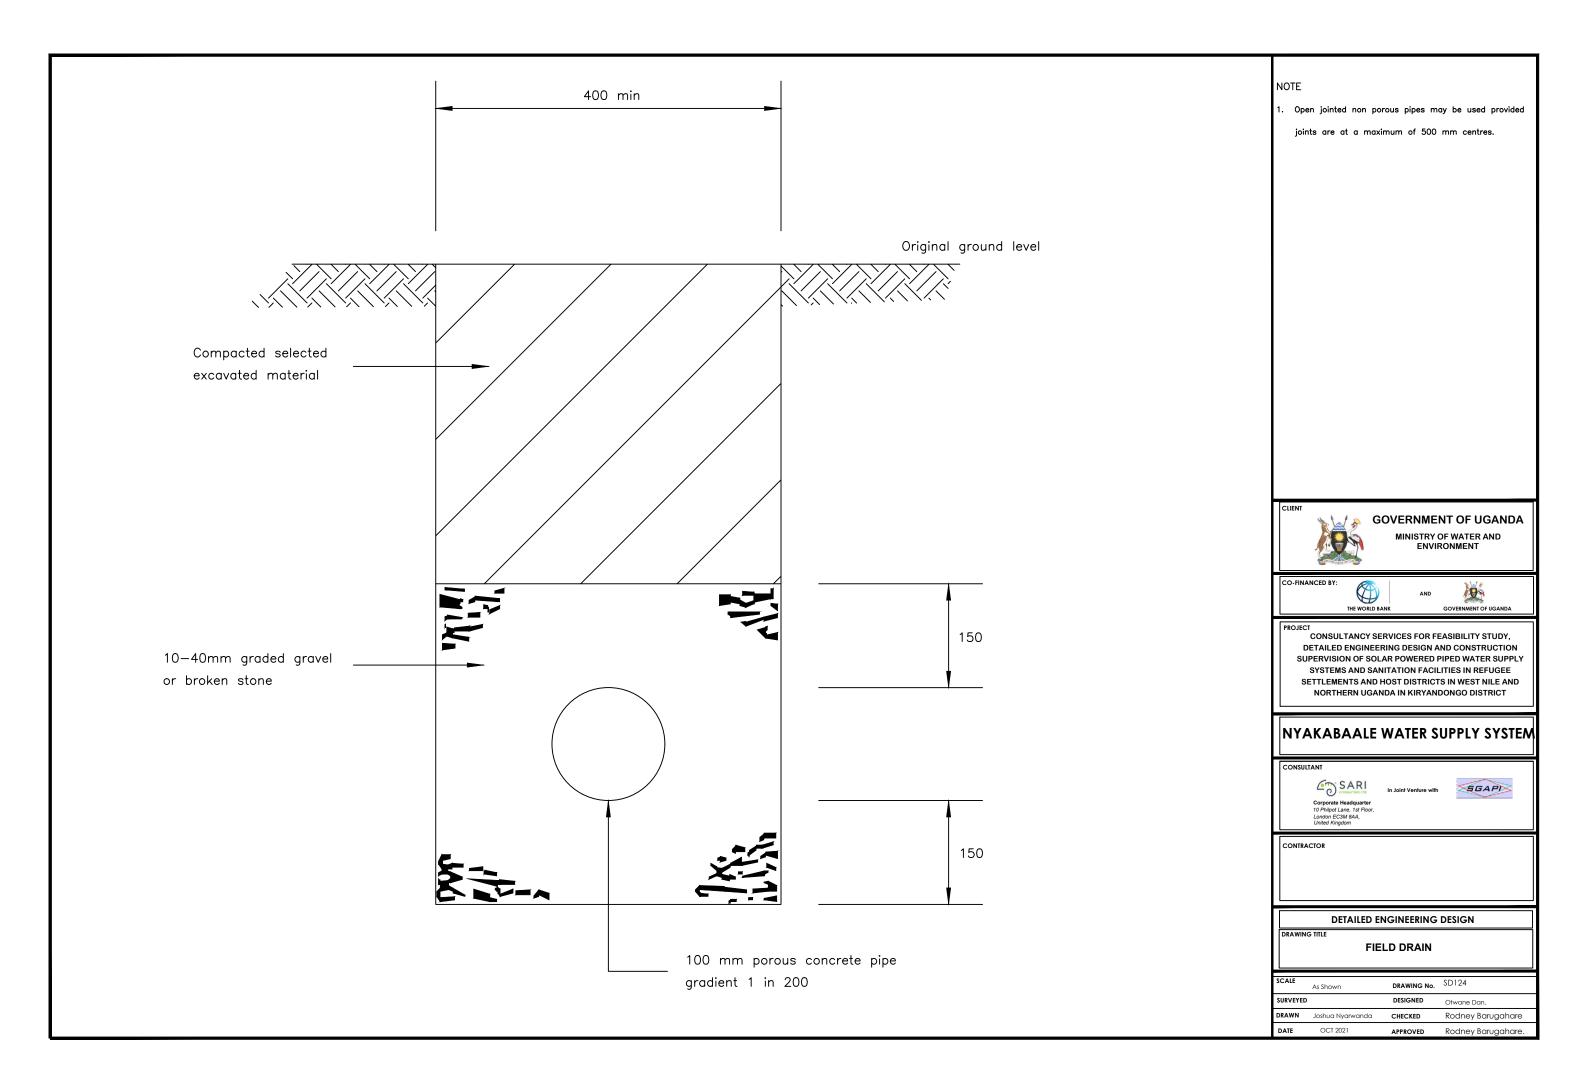

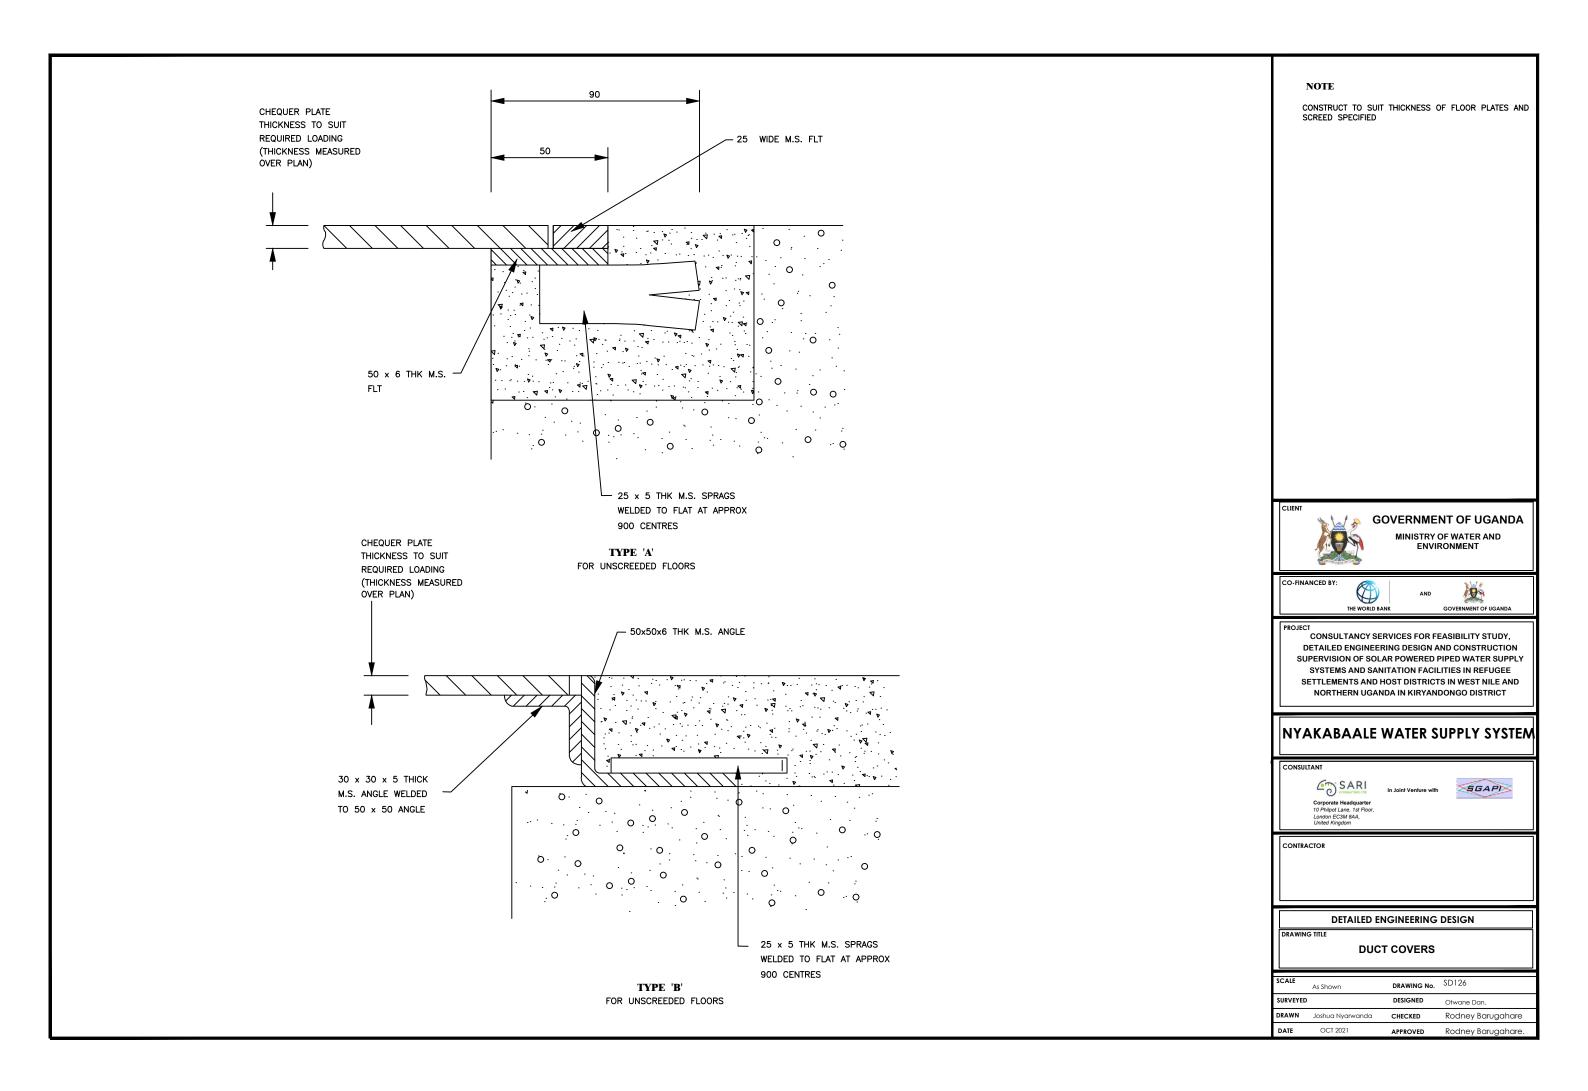

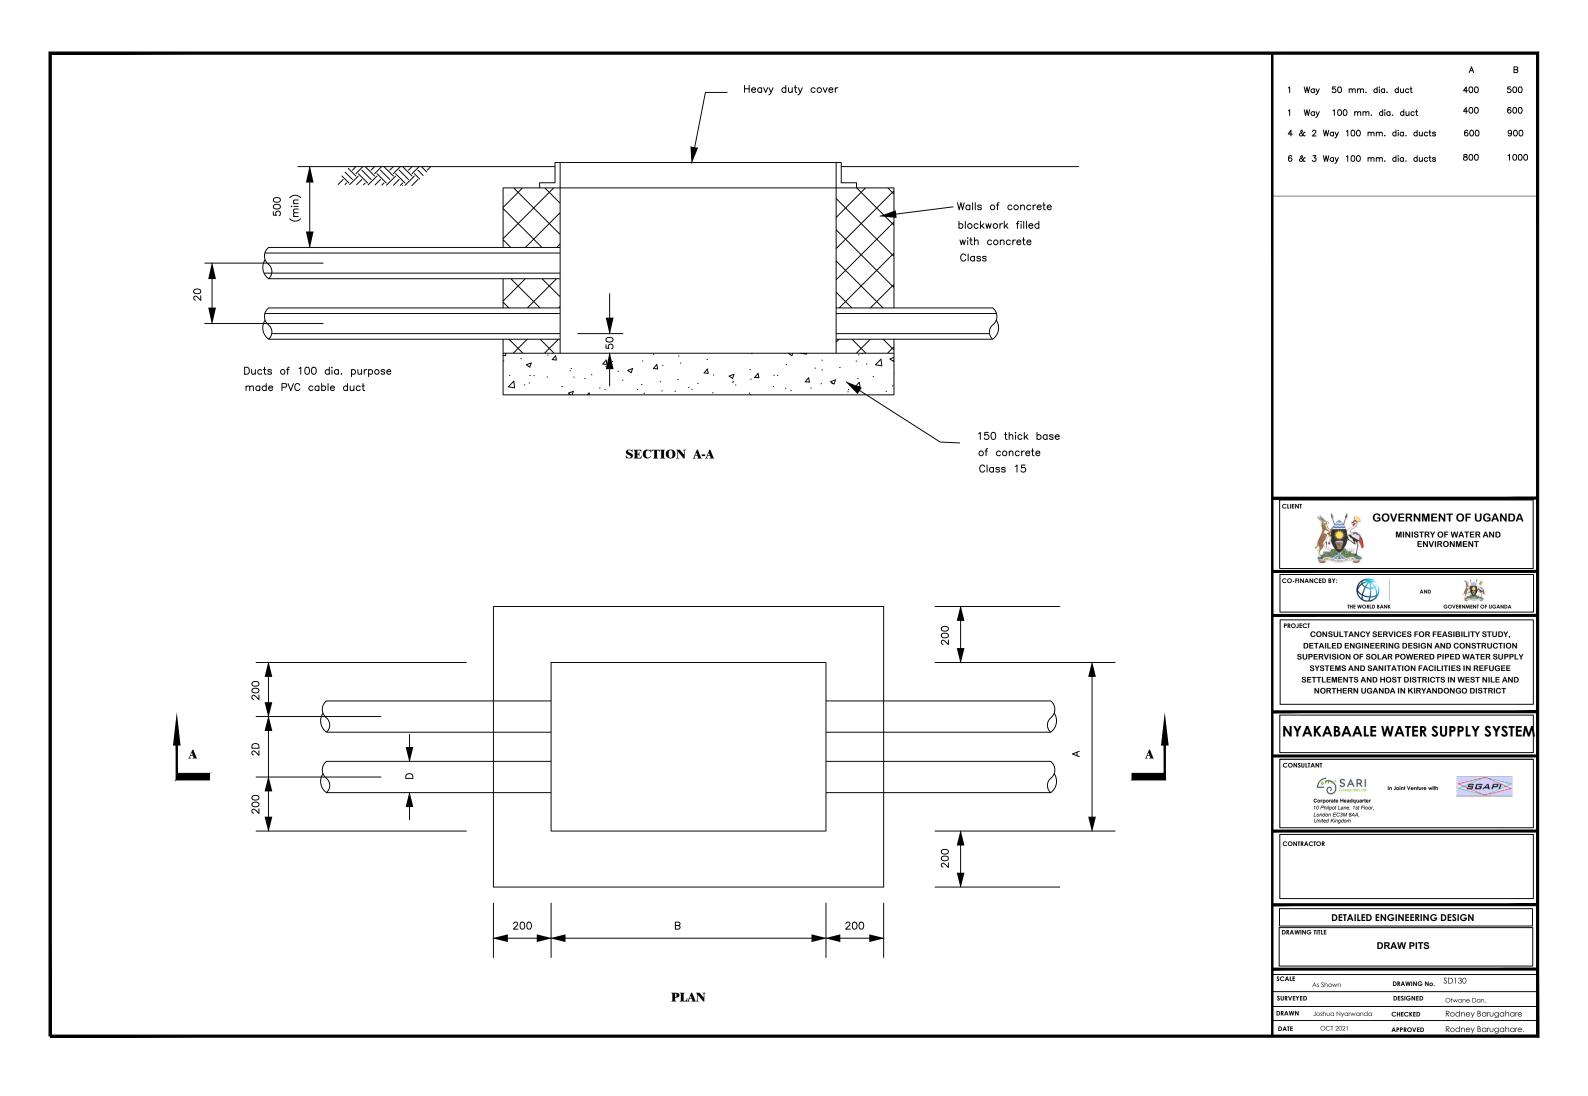

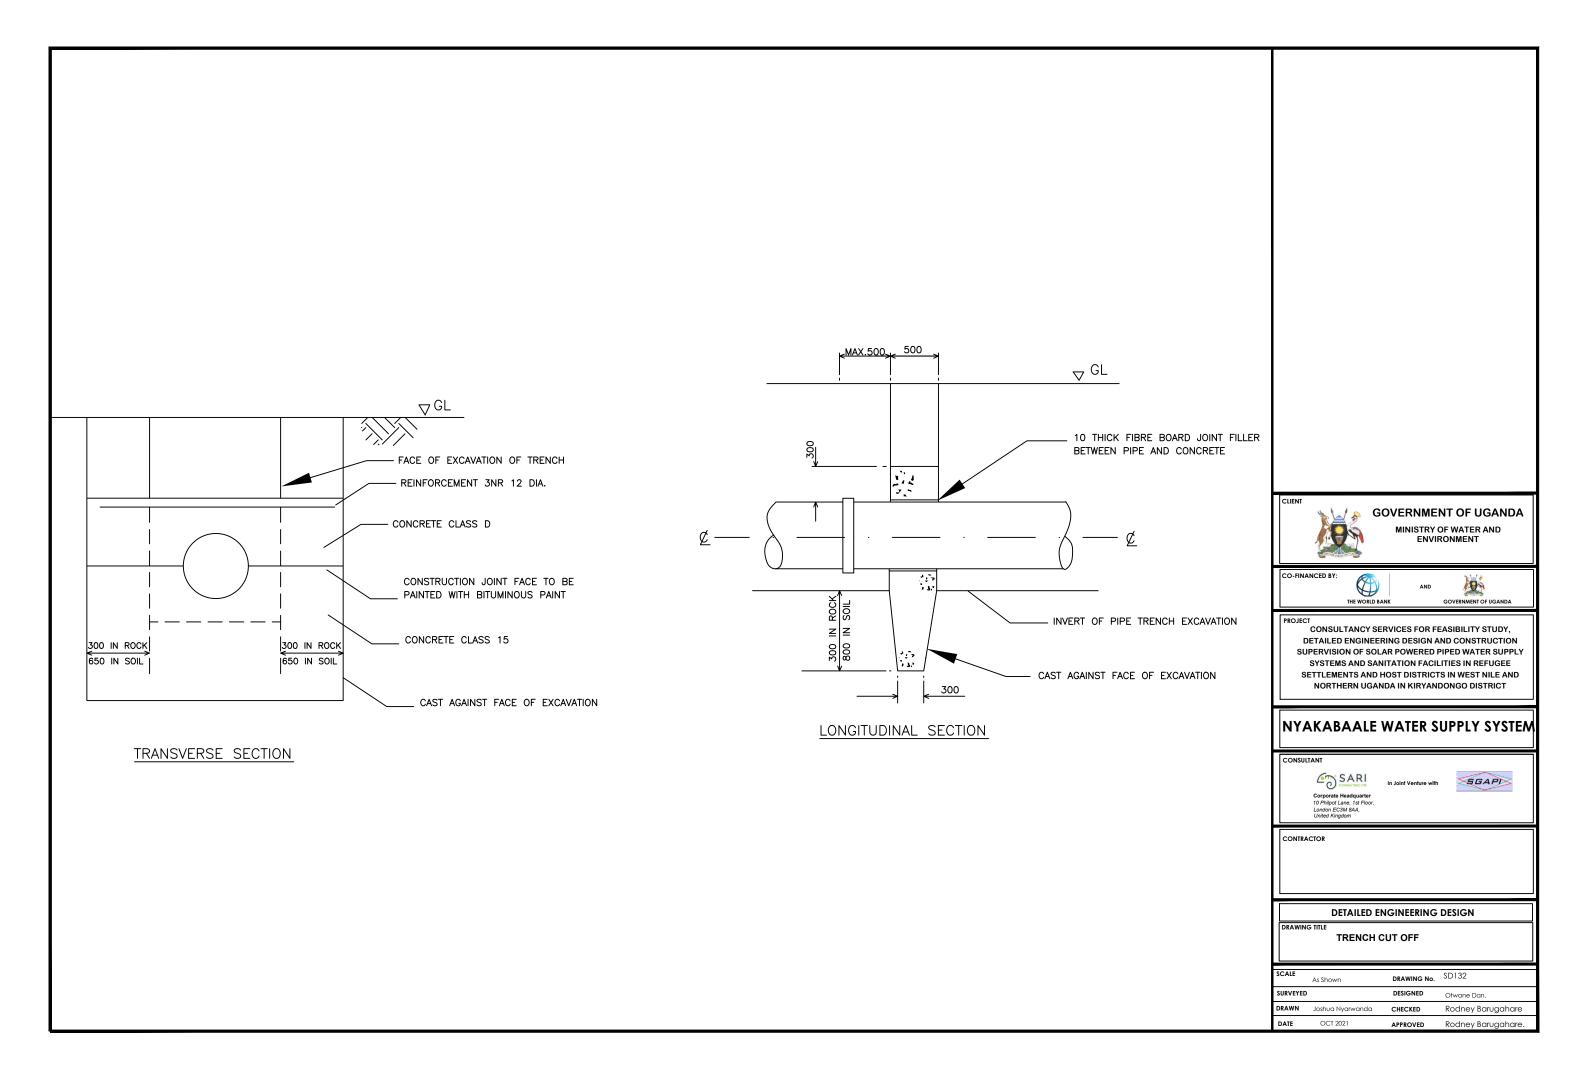

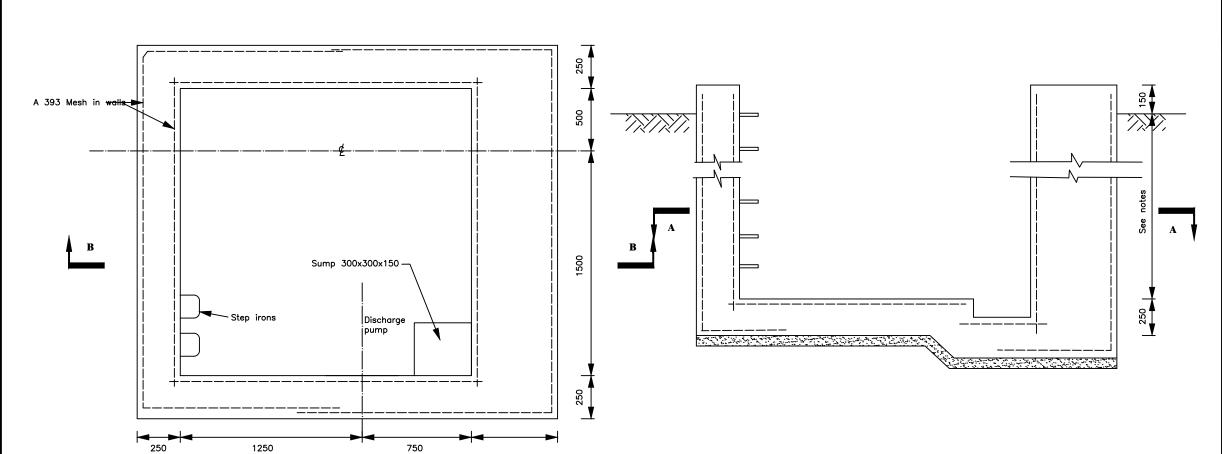

SECTION B-B

NOTES

SECTION A-A

- Floor of chamber to be 250 below pipe IL ? min depth 1700 below ground level.
- 2. Fore details of cover slab see Drawing SD 135C
- 3. See General notes.
- 4. Use SD 135b if additional thrust block is required



GOVERNMENT OF UGANDA

MINISTRY OF WATER AND ENVIRONMENT

CO-FINANCED



QA

PROJECT

CONSULTANCY SERVICES FOR FEASIBILITY STUDY,
DETAILED ENGINEERING DESIGN AND CONSTRUCTION
SUPERVISION OF SOLAR POWERED PIPED WATER SUPPLY
SYSTEMS AND SANITATION FACILITIES IN REFUGEE
SETTLEMENTS AND HOST DISTRICTS IN WEST NILE AND
NORTHERN UGANDA IN KIRYANDONGO DISTRICT

NYAKABAALE WATER SUPPLY SYSTEM

CONSULTANT



In Joint Venture with




NTRACTOR


DETAILED ENGINEERING DESIGN

DRAWING TITLE

WASHOUT/GATE VALVE CHAMBER-R.C. DETAILS

SCALE	As Shown	DRAWING No.	SD135A
SURVEYED		DESIGNED	Otwane Dan.
DRAWN	Joshua Nyarwanda	CHECKED	Rodney Barugahare
DATE	OCT 2021	APPROVED	Rodney Barugahare.

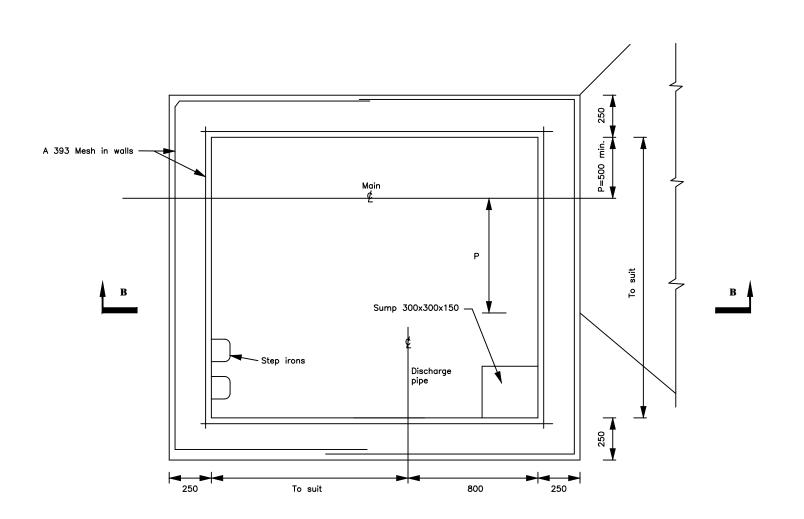

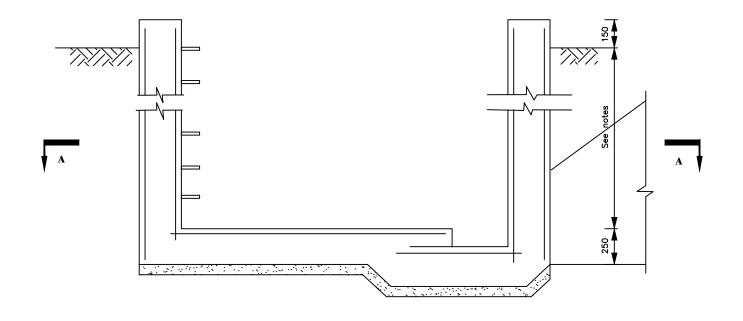

SECTION B-B

- 1. Floor of chamber to be 250 below pipe IL ? min depth 1700 below



GOVERNMENT OF UGANDA

MINISTRY OF WATER AND ENVIRONMENT





CONSULTANCY SERVICES FOR FEASIBILITY STUDY, DETAILED ENGINEERING DESIGN AND CONSTRUCTION SUPERVISION OF SOLAR POWERED PIPED WATER SUPPLY SYSTEMS AND SANITATION FACILITIES IN REFUGEE SETTLEMENTS AND HOST DISTRICTS IN WEST NILE AND NORTHERN UGANDA IN KIRYANDONGO DISTRICT

NYAKABAALE WATER SUPPLY SYSTEM








DETAILED ENGINEERING DESIGN

DRAWING TITLE
WASHOUT/GATE VALVE CHAMBER WITH THRUST BLOCK - R.C. DETAILS

SCALE	As Shown	DRAWING No.	SD135B
SURVEYED		DESIGNED	Otwane Dan.
DRAWN	Joshua Nyarwanda	CHECKED	Rodney Barugahare
DATE	OCT 2021	APPROVED	Rodney Barugahare.

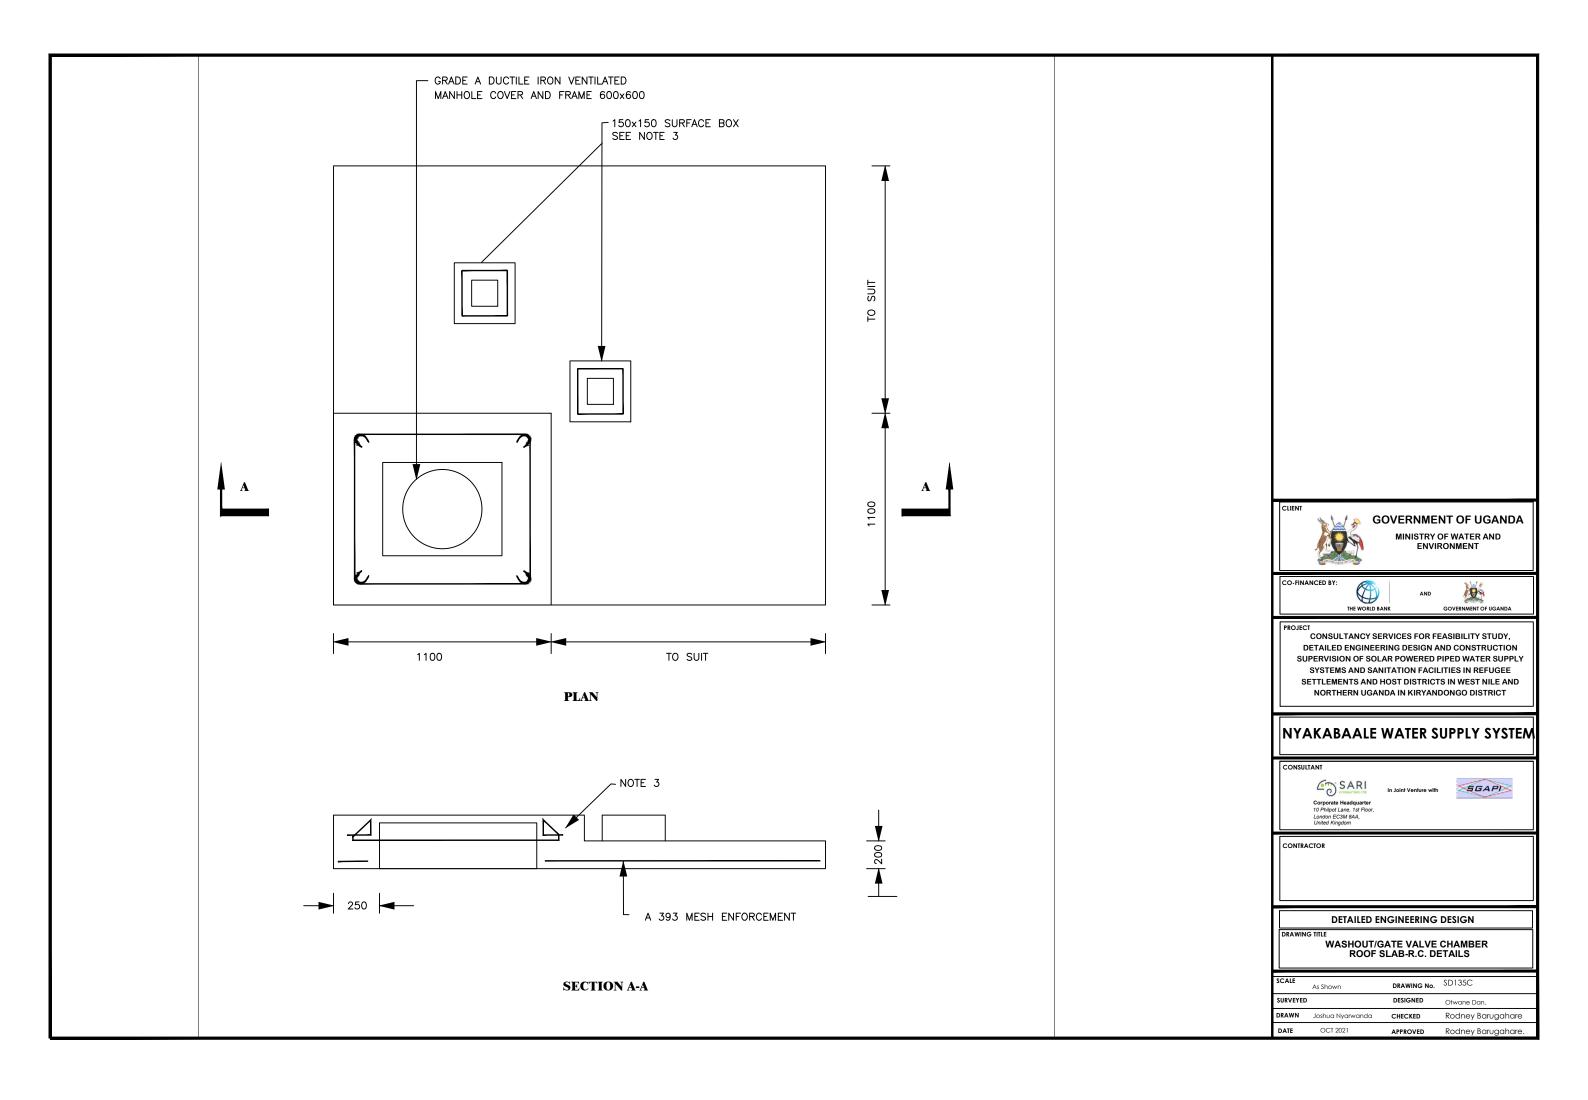

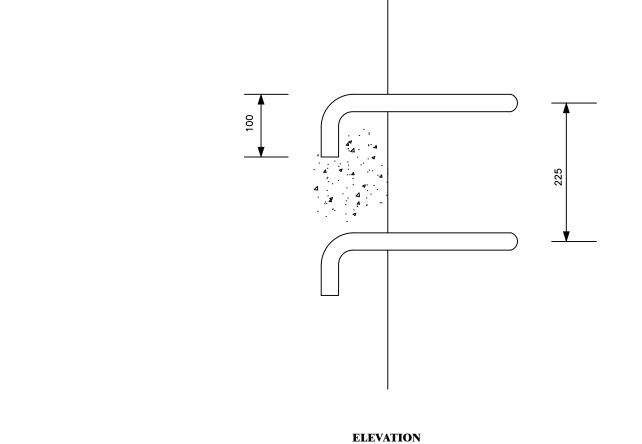

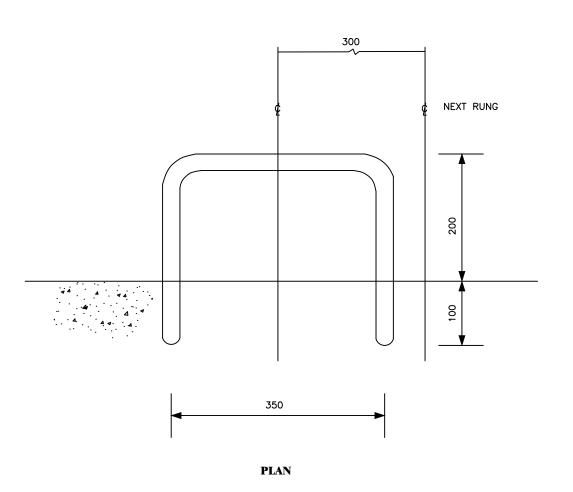

Step irons are to be to B1247, or made from 25 dia. reinforcing bars bent as sh

Bars should be placed at 225 centres vertically and at alternate centres 300 vertical



GOVERNMENT OF UGANDA

MINISTRY OF WATER AND ENVIRONMENT



PROJECT
CONSULTANCY SERVICES FOR FEASIBILITY STUDY, DETAILED ENGINEERING DESIGN AND CONSTRUCTION SUPERVISION OF SOLAR POWERED PIPED WATER SUPPLY SYSTEMS AND SANITATION FACILITIES IN REFUGEE SETTLEMENTS AND HOST DISTRICTS IN WEST NILE AND NORTHERN UGANDA IN KIRYANDONGO DISTRICT

NYAKABAALE WATER SUPPLY SYSTEM







DETAILED ENGINEERING DESIGN

STEP IRON DETAIL


SCALE	As Shown	DRAWING No.	SD136
SURVEYED		DESIGNED	Otwane Dan.
DRAWN	Joshua Nyarwanda	CHECKED	Rodney Barugahare
DATE	OCT 2021	APPROVED	Rodney Barugahare.

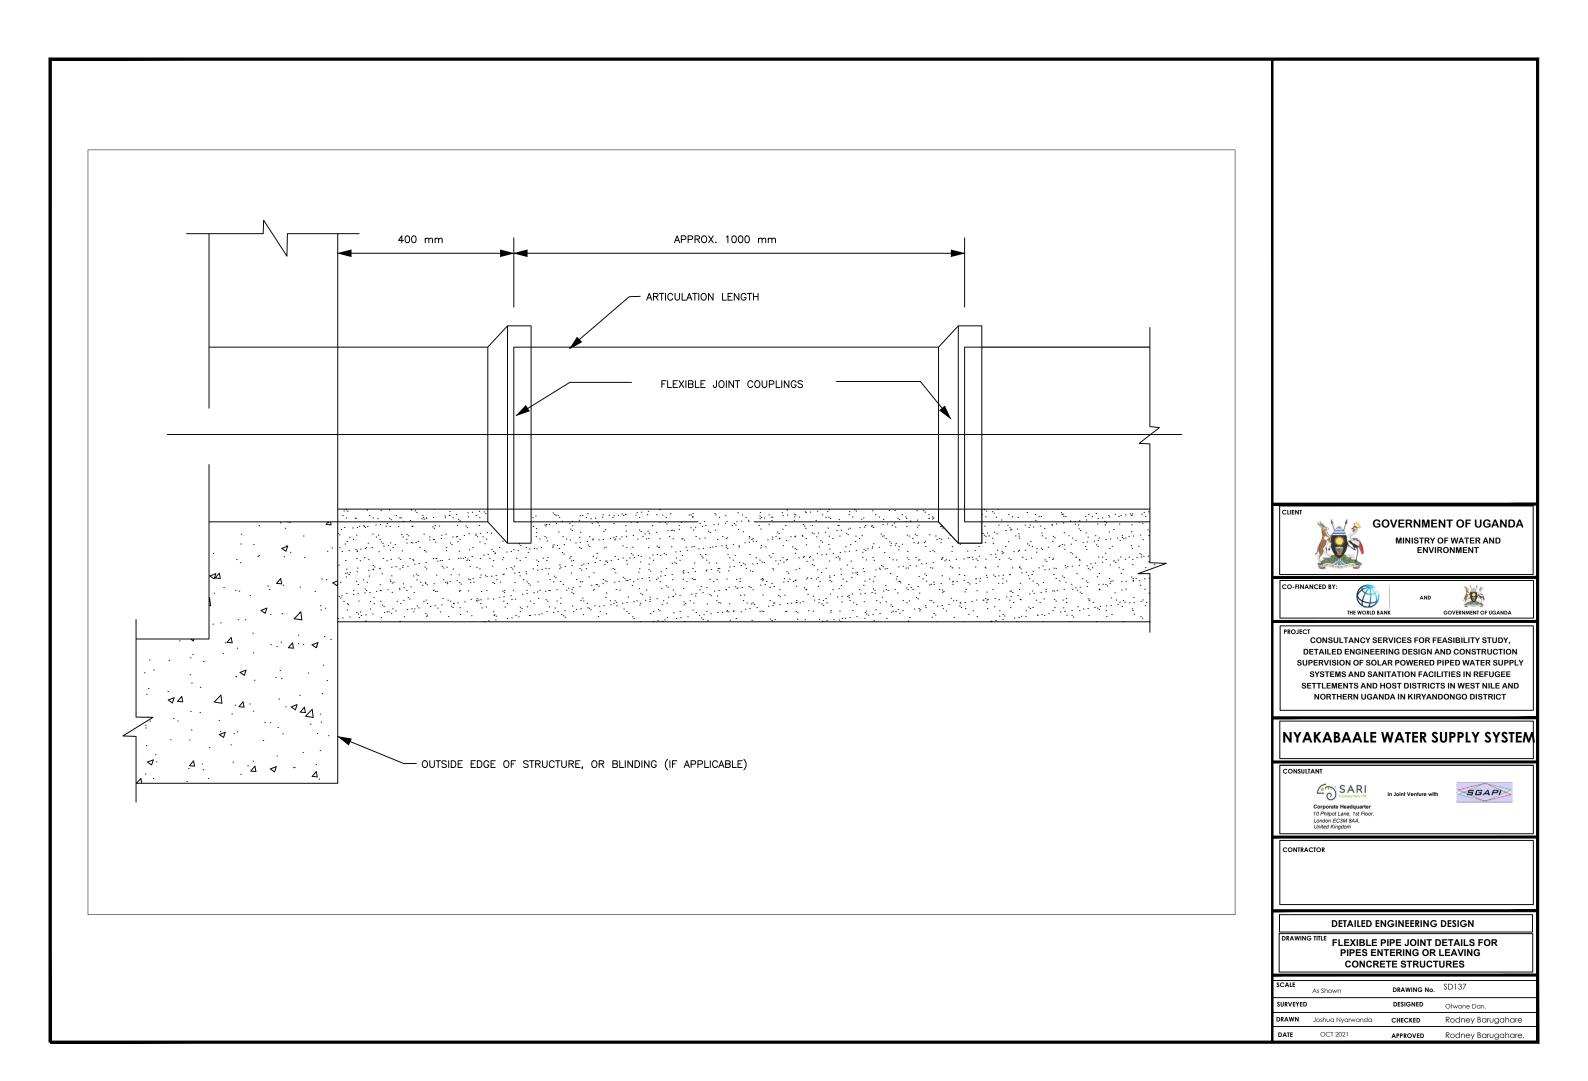

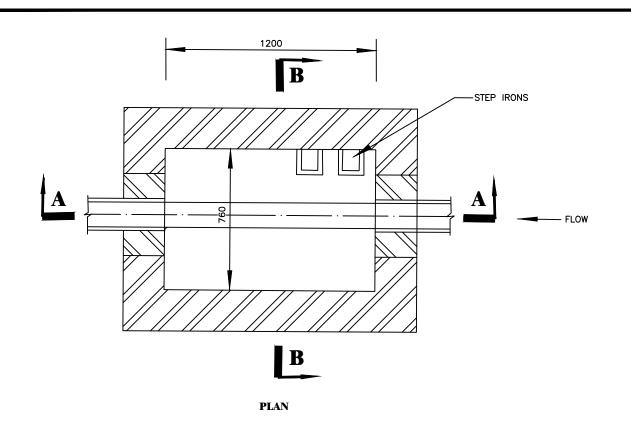


NOTES:

- 1. MANHOLES FOR SEWER SIZES UP TO AND INCLUDING900 DIA DEPTH TOSOFFIT EXCEEDING 1000 BUT NOT EXCEEDING 1350
- 2. MANHOLE FRAMES AND MULTIPLE COVERS WITH A MINIMUM CLEAR OPENING OF 1200x675 SHALL OTHERWISE COMPLY BWITH BS497 PART 1 GRADE A.
- 3. CHAMBERS WITH OUTGOING PIPES GREATER THAN 700 DIA. SHALL BE FITTED WITH REMOVABLE SAFETY CHAIN AT DOWD STREAM END.
- 4. PIPES ENTERING MANHOLES SHALL HAVE A FLEXIBLE JOINT WITHIN 600 OF THE INSIDE FACE OF THE MANHOLE FOR PIPES UP TO 450 AND WITHIN 1000 OF THE INSIDEFACE OF THE MANHOLE FOR PIPES UPTO 1000. THIS SHALL BE FOLLOWED BY A SHORT ROCKER PIPE.
- 5. INTERNAL DIMENSIONS OF CHAMBER NORMALLY 1200x675 (AS CLEAR OPENING IN FRAME) BUT CHAMBER WIDTH SHOULD BE INCREASED FOR PIPES LARGER THAN 225 DIA. TO GIVE 225 BENCHING EACH SIDE WITH THE BRICKWORK CRBELLED DOWN TO 675.
- 6. ALL DIMENSIONS ARE IN MILLIMETRES.

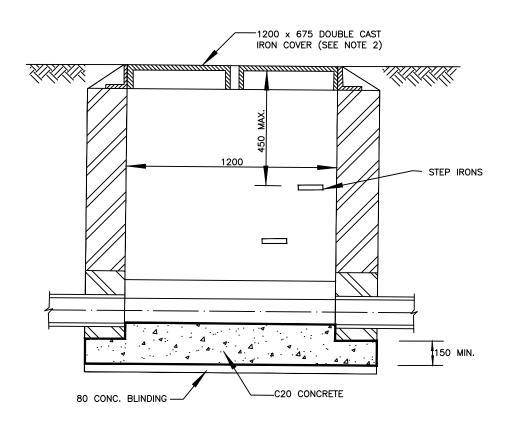

SECTION A-A

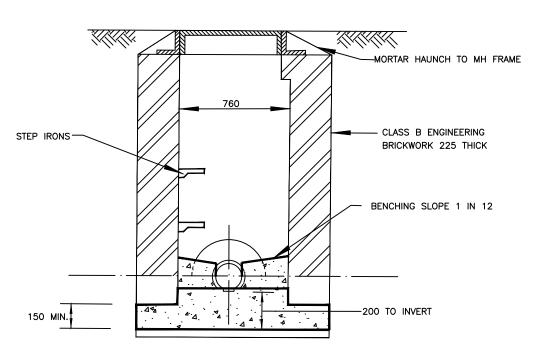

SECTION B-B

GOVERNMENT OF UGANDA

MINISTRY OF WATER AND ENVIRONMENT





CONSULTANCY SERVICES FOR FEASIBILITY STUDY, DETAILED ENGINEERING DESIGN AND CONSTRUCTION SUPERVISION OF SOLAR POWERED PIPED WATER SUPPLY SYSTEMS AND SANITATION FACILITIES IN REFUGEE SETTLEMENTS AND HOST DISTRICTS IN WEST NILE AND NORTHERN UGANDA IN KIRYANDONGO DISTRICT

NYAKABAALE WATER SUPPLY SYSTEM






CONTRACTOR


DETAILED ENGINEERING DESIGN

MANHOLE - TYPE C


ı				
	SCALE	As Shown	DRAWING No.	SD202
	SURVEYED		DESIGNED	Otwane Dan.
	DRAWN	Joshua Nyarwanda	CHECKED	Rodney Barugahare
	DATE	OCT 2021	APPROVED	Rodney Barugahare.

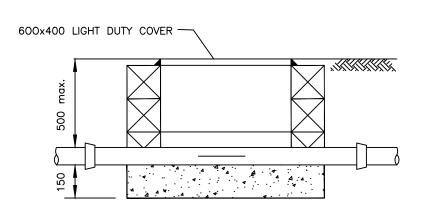

SECTION (TYPE 1)

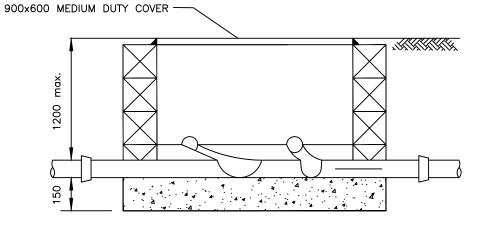

SECTION (TYPE 2)

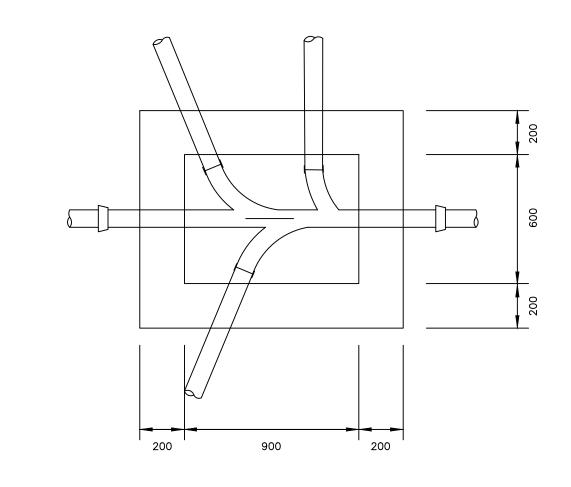

200 600

PLAN (TYPE 1)

PLAN (TYPE 2)

NOTES

- 1. ALL DIMENSIONS ARE IN MILLIMETRES
- 2. CONSTRUCTION OF BASE SLAB TO BE CLASS 30/40S CONCRETE AND WALLS TO BE EITHER CLASS 30/40S CONCRETE OR CONCRETE BLOCKWORK WITH 20 THICK CEMENT MORTAR RENDER TO BOTH INTERNAL AND EXTERNAL FACES.
- 3. BENCHING TO BE CLASS 30/20S CONCRETE WITH 20 THICK CEMENT MORTAR TO SURFACE.



GOVERNMENT OF UGANDA

MINISTRY OF WATER AND ENVIRONMENT





CONSULTANCY SERVICES FOR FEASIBILITY STUDY, DETAILED ENGINEERING DESIGN AND CONSTRUCTION SUPERVISION OF SOLAR POWERED PIPED WATER SUPPLY SYSTEMS AND SANITATION FACILITIES IN REFUGEE SETTLEMENTS AND HOST DISTRICTS IN WEST NILE AND NORTHERN UGANDA IN KIRYANDONGO DISTRICT

NYAKABAALE WATER SUPPLY SYSTEM







DETAILED ENGINEERING DESIGN

INSPECTION CHAMBERS- TYPES 1 AND 2

SCALE	As Shown	DRAWING No.	SD206	
SURVEYED		DESIGNED	Otwane Dan.	
DRAWN	Joshua Nyarwanda	CHECKED	Rodney Barugahare	
DATE	OCT 2021	APPROVED	Rodney Barugahare.	

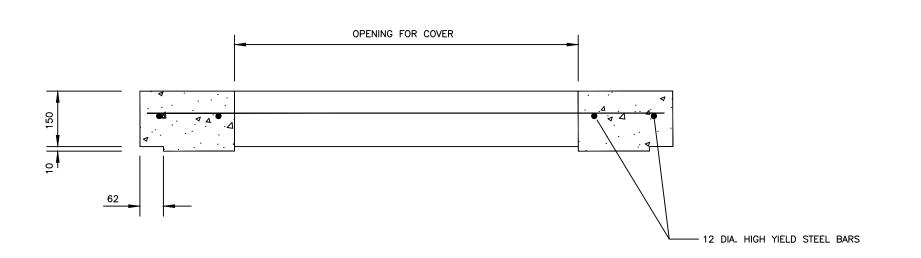

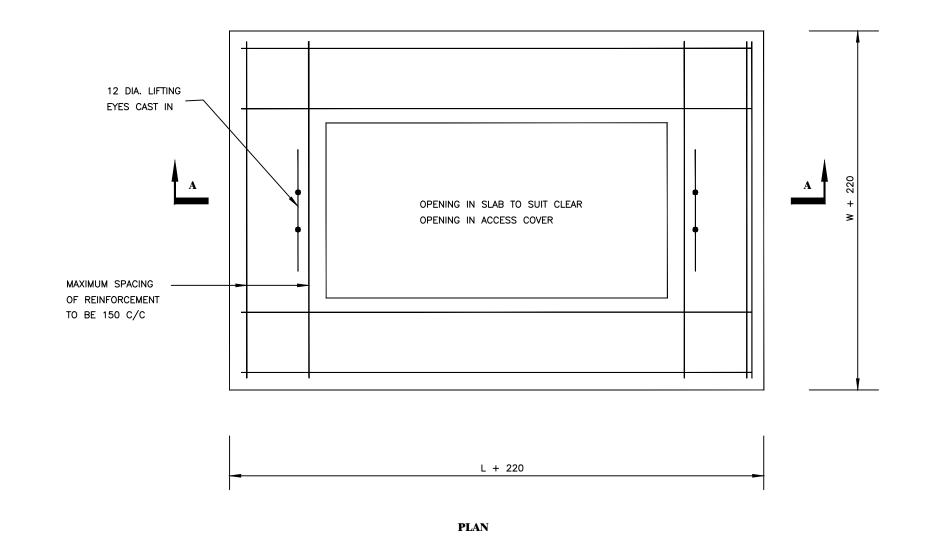

NOTES

- 1. ALL DIMENSIONS ARE IN MILLIMETRES
- 2. FOR GENERAL NOTES SEE STANDARD DETAIL No. V/G/NOTE/01.
- 3. FRAME TO BE SET IN CONCRETE UPSTAND MINIMUM DEPTH 150 DOWELLED TO SLAB WITH 6 No. T18 BARS 200 LONG.
- 4. L AND W ARE INTERNAL CHAMBER DIMENSIONS. SEE STANDARD DETAIL No. SD 214.



GOVERNMENT OF UGANDA

MINISTRY OF WATER AND ENVIRONMENT



CONSULTANCY SERVICES FOR FEASIBILITY STUDY, DETAILED ENGINEERING DESIGN AND CONSTRUCTION SUPERVISION OF SOLAR POWERED PIPED WATER SUPPLY SYSTEMS AND SANITATION FACILITIES IN REFUGEE SETTLEMENTS AND HOST DISTRICTS IN WEST NILE AND NORTHERN UGANDA IN KIRYANDONGO DISTRICT

NYAKABAALE WATER SUPPLY SYSTEM






DETAILED ENGINEERING DESIGN

PRECAST CONCRETE COVER SLAB OPEN AREAS

SCALE	As Shown	DRAWING No.	SD211
SURVEYED		DESIGNED	Otwane Dan.
DRAWN	Joshua Nyarwanda	CHECKED	Rodney Barugahare
DATE	OCT 2021	APPROVED	Rodney Barugahare.

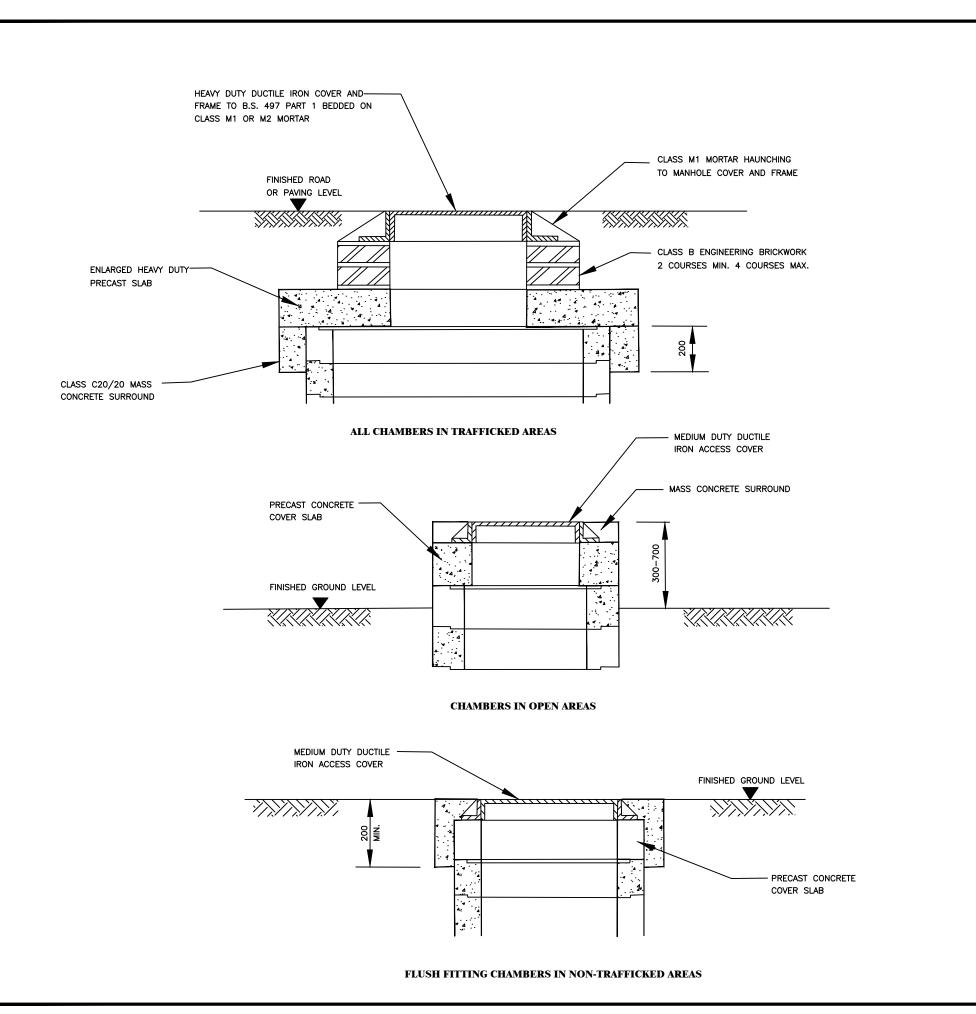

NOTES:

1. ALL DIMENSIONS ARE IN MILLIMETRES.



GOVERNMENT OF UGANDA

MINISTRY OF WATER AND ENVIRONMENT





CONSULTANCY SERVICES FOR FEASIBILITY STUDY, DETAILED ENGINEERING DESIGN AND CONSTRUCTION SUPERVISION OF SOLAR POWERED PIPED WATER SUPPLY SYSTEMS AND SANITATION FACILITIES IN REFUGEE SETTLEMENTS AND HOST DISTRICTS IN WEST NILE AND NORTHERN UGANDA IN KIRYANDONGO DISTRICT

NYAKABAALE WATER SUPPLY SYSTEM







CONTRACTOR

DETAILED ENGINEERING DESIGN

PRECAST CHAMBER COVER SLAB INSTALLATION

SCALE	As Shown	DRAWING No.	SD213	
SURVEYED)	DESIGNED	Otwane Dan.	
DRAWN	Joshua Nyarwanda	CHECKED	Rodney Barugahare	
DATE	OCT 2021	APPROVED	Rodney Barugahare.	

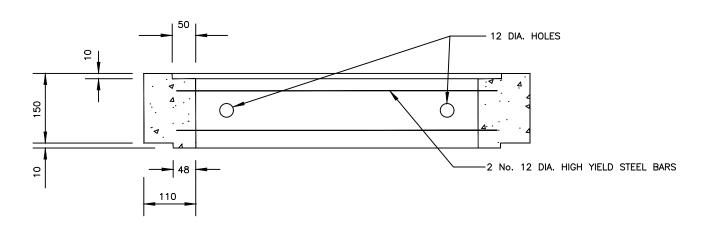

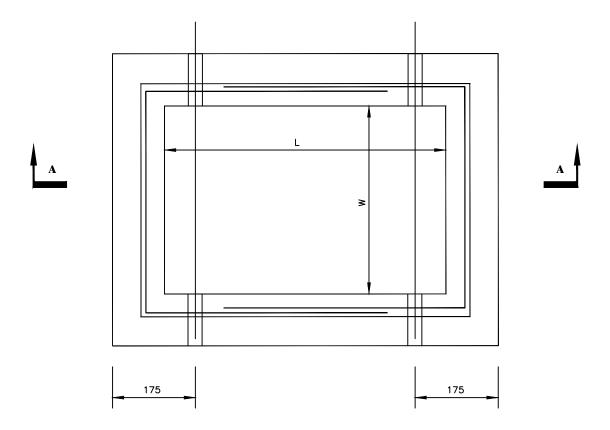

PLAN

TYPE	L	W
A B C D E F	430 600 750 900 1200	280 450 600 600 600 900

NOTES

- 1. ALL DIMENSIONS ARE IN MILLIMETRES
- 2. CONCRETE TO BE CLASS 30/20.
- 3. COVER TO REINFORCEMENT TO BE 40mm.
- 4. DIMENSIONS L AND W FROM TABLE SHOWN.
- 5. FOR GENERAL NOTES SEE STANDARD DRAWING No. SD100.





GOVERNMENT OF UGANDA

MINISTRY OF WATER AND ENVIRONMENT





CONSULTANCY SERVICES FOR FEASIBILITY STUDY, DETAILED ENGINEERING DESIGN AND CONSTRUCTION SUPERVISION OF SOLAR POWERED PIPED WATER SUPPLY SYSTEMS AND SANITATION FACILITIES IN REFUGEE SETTLEMENTS AND HOST DISTRICTS IN WEST NILE AND NORTHERN UGANDA IN KIRYANDONGO DISTRICT

NYAKABAALE WATER SUPPLY SYSTEM






DETAILED ENGINEERING DESIGN

PRECAST CONCRETE CHAMBER SECTIONS

SCALE	As Shown	DRAWING No.	SD214	
SURVEYED	ı	DESIGNED	Otwane Dan.	
DRAWN	Joshua Nyarwanda	CHECKED	Rodney Barugahare	
DATE	OCT 2021	APPROVED	Rodney Barugahare.	

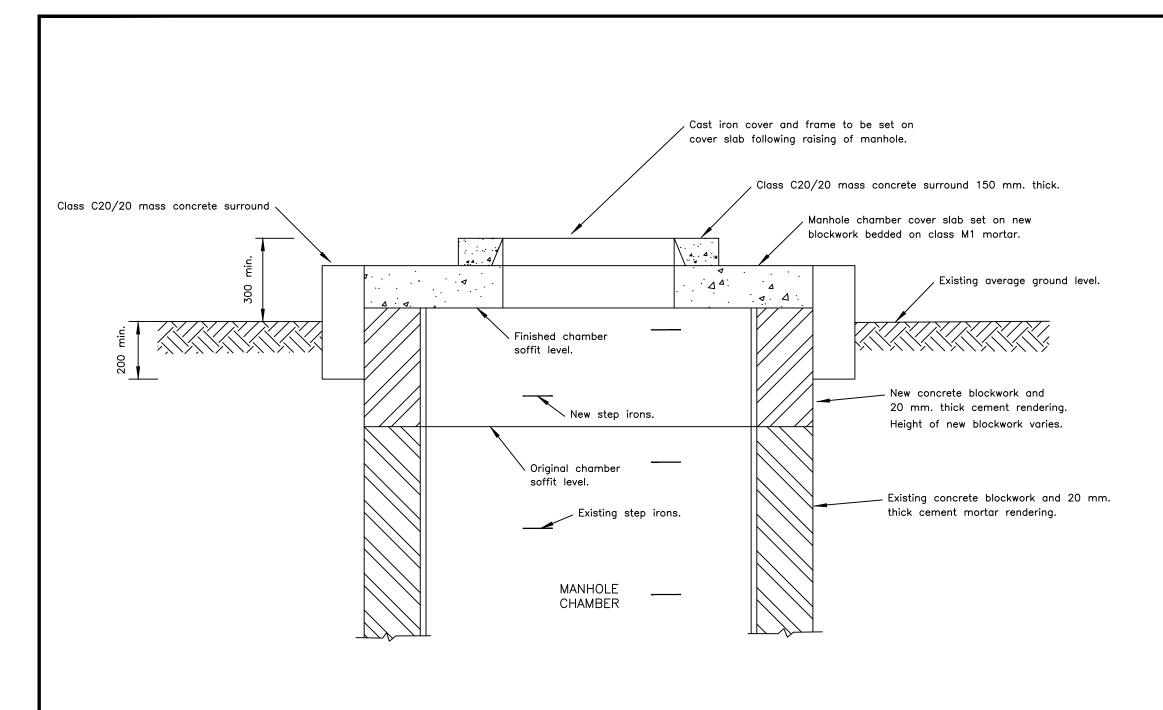

NOTES

- 1. The existing manhole chamber cover slab shall be re—used where possible. If existing slab is damaged it shall be replaced by a new slab as per standard detail SD 211.
- 2. Manhole chambers are generally square in plan with 1200×1200 internal dimensions. Dimensions to be confirmed by the contractor prior to casting new manhole chamber cover slab
- 3. The existing cast iron cover and frame shall be re—used where possible. If the cover or frame is damaged, it shall be replaced by a medium duty cover and frame supplied by the Employer.
- 4. Width of the new concrete blocks shall be the same as existing chamber walls.
- 5. The final cove level shall be agreed with the Engineer prior to placing mass concrete sorrounds.
- 6. New step irons as per SD 206.



GOVERNMENT OF UGANDA

MINISTRY OF WATER AND ENVIRONMENT

CO-FINANCED



ND 🙀

PROJECT

CONSULTANCY SERVICES FOR FEASIBILITY STUDY,
DETAILED ENGINEERING DESIGN AND CONSTRUCTION
SUPERVISION OF SOLAR POWERED PIPED WATER SUPPLY
SYSTEMS AND SANITATION FACILITIES IN REFUGEE
SETTLEMENTS AND HOST DISTRICTS IN WEST NILE AND
NORTHERN UGANDA IN KIRYANDONGO DISTRICT

NYAKABAALE WATER SUPPLY SYSTEM

CONSULTANT



In Joint Venture with




CONTRACTOR


DETAILED ENGINEERING DESIGN


RAWING TITLE

ALTERATIONS TO CHAMBERS IN OPEN AREAS

SCALE	As Shown	DRAWING No.	SD215	
SURVEYED		DESIGNED	Otwane Dan.	
DRAWN	Joshua Nyarwanda	CHECKED	Rodney Barugahare	
DATE	OCT 2021	APPROVED	Rodney Barugahare.	

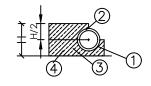

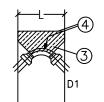

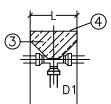



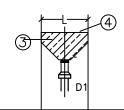


TABLE I

	С	В	A1	A2	А3	A4	A5	A6
D1	F F	F -)\(\frac{1}{2}(-	(-D1	D1 160°	X (D1	¥(D1	- X -D1	D1
	→ 101 101		´l 90°		45°	30°	22*	11*
mm	mm ²	mm ²	mm ²	mm ²	mm ²	mm ²	mm ²	mm ²
65	0.05	0.05	0.07	0.05	0.04	0.03	0.02	0.01
80	0.08	0.08	0.11	0.08	0.06	0.04	0.03	0.02
1.00	0.11	0.11	0.16	0.11	0.08	0.06	0.04	0.02
1.50	0.25	0.25	0.35	0.25	0.19	0.13	0.10	0.05
2.00	0.40	0.40	0.56	0.40	0.31	0.21	0.16	0.08
2.50	0.66	0.66	0.93	0.66	0.51	0.34	0.25	0.13
3.00	0.94	0.94	1.33	0.94	0.72	0.49	0.37	0.19
4.00	1.66	1.66	2.34	1.66	1.29	0.36	0.65	0.33
5.00	2.50	2.50	3.53	2.5	1.93	1.30	0.98	0.50
6.00	3.61	3.61	5.09	3.51	2.78	1.88	1.41	0.72
7.00	4.90	4.90	5.91	4.9	3.77	2.55	1.91	0.98
8.00	6.39	6.39	9.01	6.39	4.92	3.32	2.49	1.29
9.00	8.10	8.10	11.42	8.10	6.24	4.21	3.16	1.62



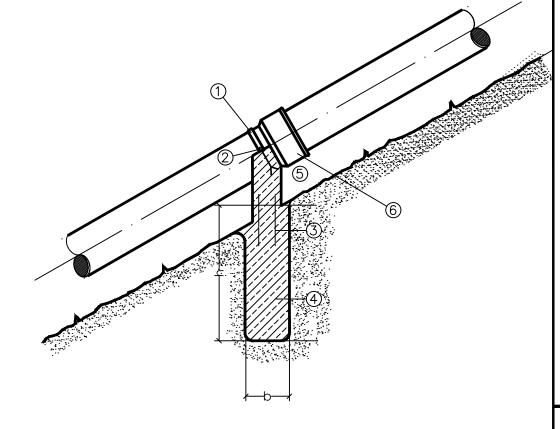

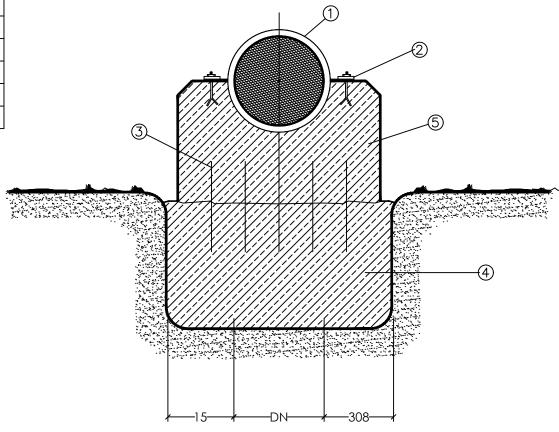

GOVERNMENT OF UGANDA

MINISTRY OF WATER AND ENVIRONMENT





CONSULTANCY SERVICES FOR FEASIBILITY STUDY, DETAILED ENGINEERING DESIGN AND CONSTRUCTION SUPERVISION OF SOLAR POWERED PIPED WATER SUPPLY SYSTEMS AND SANITATION FACILITIES IN REFUGEE SETTLEMENTS AND HOST DISTRICTS IN WEST NILE AND NORTHERN UGANDA IN KIRYANDONGO DISTRICT

NYAKABAALE WATER SUPPLY SYSTEM






CONTRACTOR

DETAILED ENGINEERING DESIGN

THRUST BLOCK

SCALE	As Shown	DRAWING No.	SD216	
SURVEYED		DESIGNED	Otwane Dan.	
DRAWN	Joshua Nyarwanda	CHECKED	Rodney Barugahare	
DATE	OCT 2021	APPROVED	Rodney Barugahare.	

TABLE II							
P1(bar) P2(bar)	10	15	20	25	30		
2.0	0.5	0.75	10	1.25	1.5		
1.5	0.67	1.0	1.33	1.57	2.0		
1.0	1.0	1.5	2.0	2.5	3.0		
0.5	2.0	3.0	4.0	5.0	6.0		

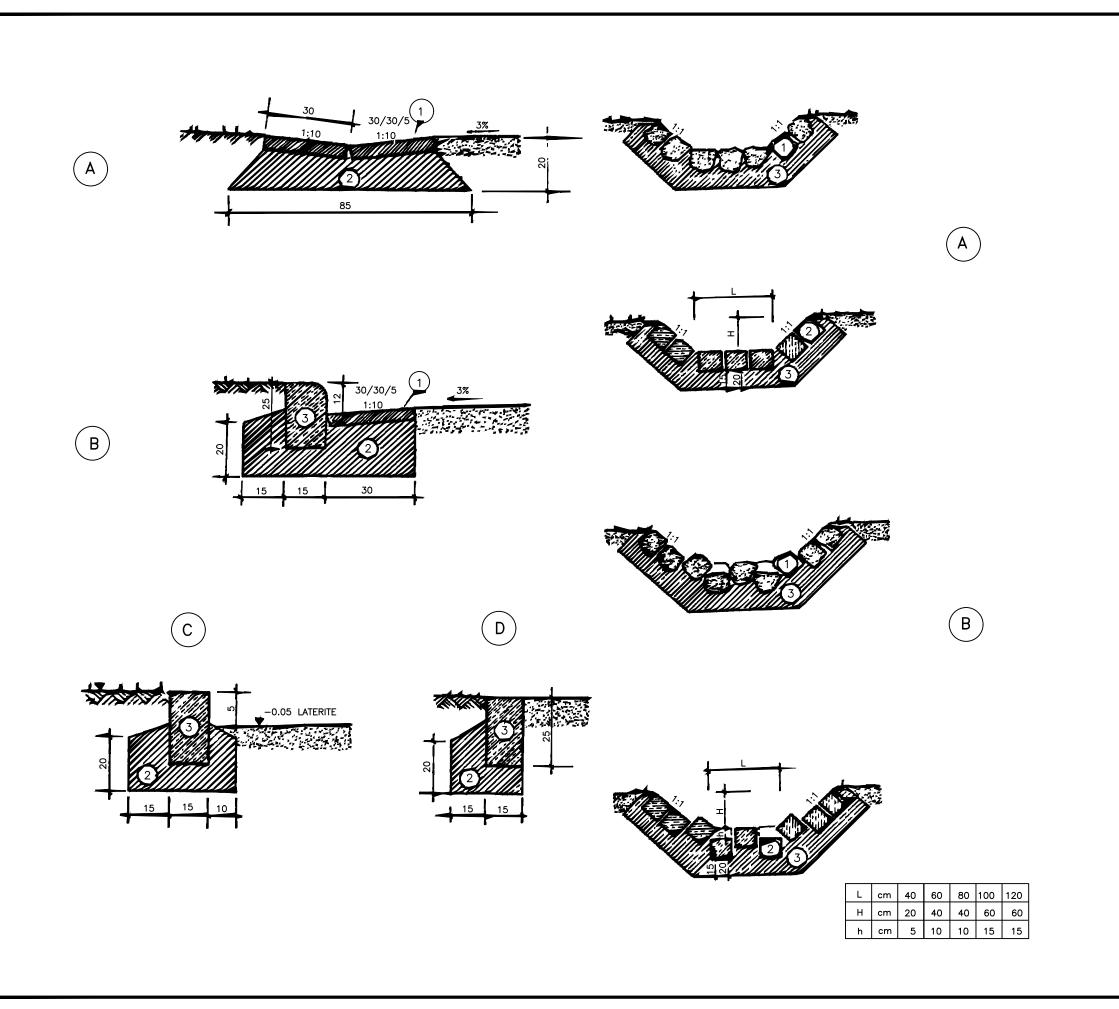

KERB & DRAIN

- A. Open drain
- B. Concrete slab half drain
- C. Kerb
- D. Embedded Kerb
- 1. Prefabricated concrete slabs of class as specified
- 2. Concrete foundation class as specified
- 3. Prefabricated concrete kerbs class as specified The excavation and other works are specified Kerbs at road junctions and bends with R < 10 m have to be rounded off. In that case the length of the kerbstone depth must be doubled.

OPEN DRAINAGE CHANNEL

- Open drain channel
- B. Open drain channel with obstacles
- 1. Stones
- Cement blocks
- Concrete class as specified
- The lining & works include
 - -excavation class as specified
 - -concrete class as specified

 - Rock or cement blocks
 Planting of a 50 cm ~ grass a strip on either side of the channel



GOVERNMENT OF UGANDA

MINISTRY OF WATER AND ENVIRONMENT





CONSULTANCY SERVICES FOR FEASIBILITY STUDY, DETAILED ENGINEERING DESIGN AND CONSTRUCTION SUPERVISION OF SOLAR POWERED PIPED WATER SUPPLY SYSTEMS AND SANITATION FACILITIES IN REFUGEE SETTLEMENTS AND HOST DISTRICTS IN WEST NILE AND NORTHERN UGANDA IN KIRYANDONGO DISTRICT

NYAKABAALE WATER SUPPLY SYSTEM







CONTRACTOR

DETAILED ENGINEERING DESIGN

OPEN DRAINAGE CHANNEL AND KERB

SCALE	As Shown	DRAWING No.	SD218	
SURVEYED		DESIGNED	Otwane Dan.	
DRAWN	Joshua Nyarwanda	CHECKED	Rodney Barugahare	
DATE	OCT 2021	APPROVED	Rodney Barugahare.	

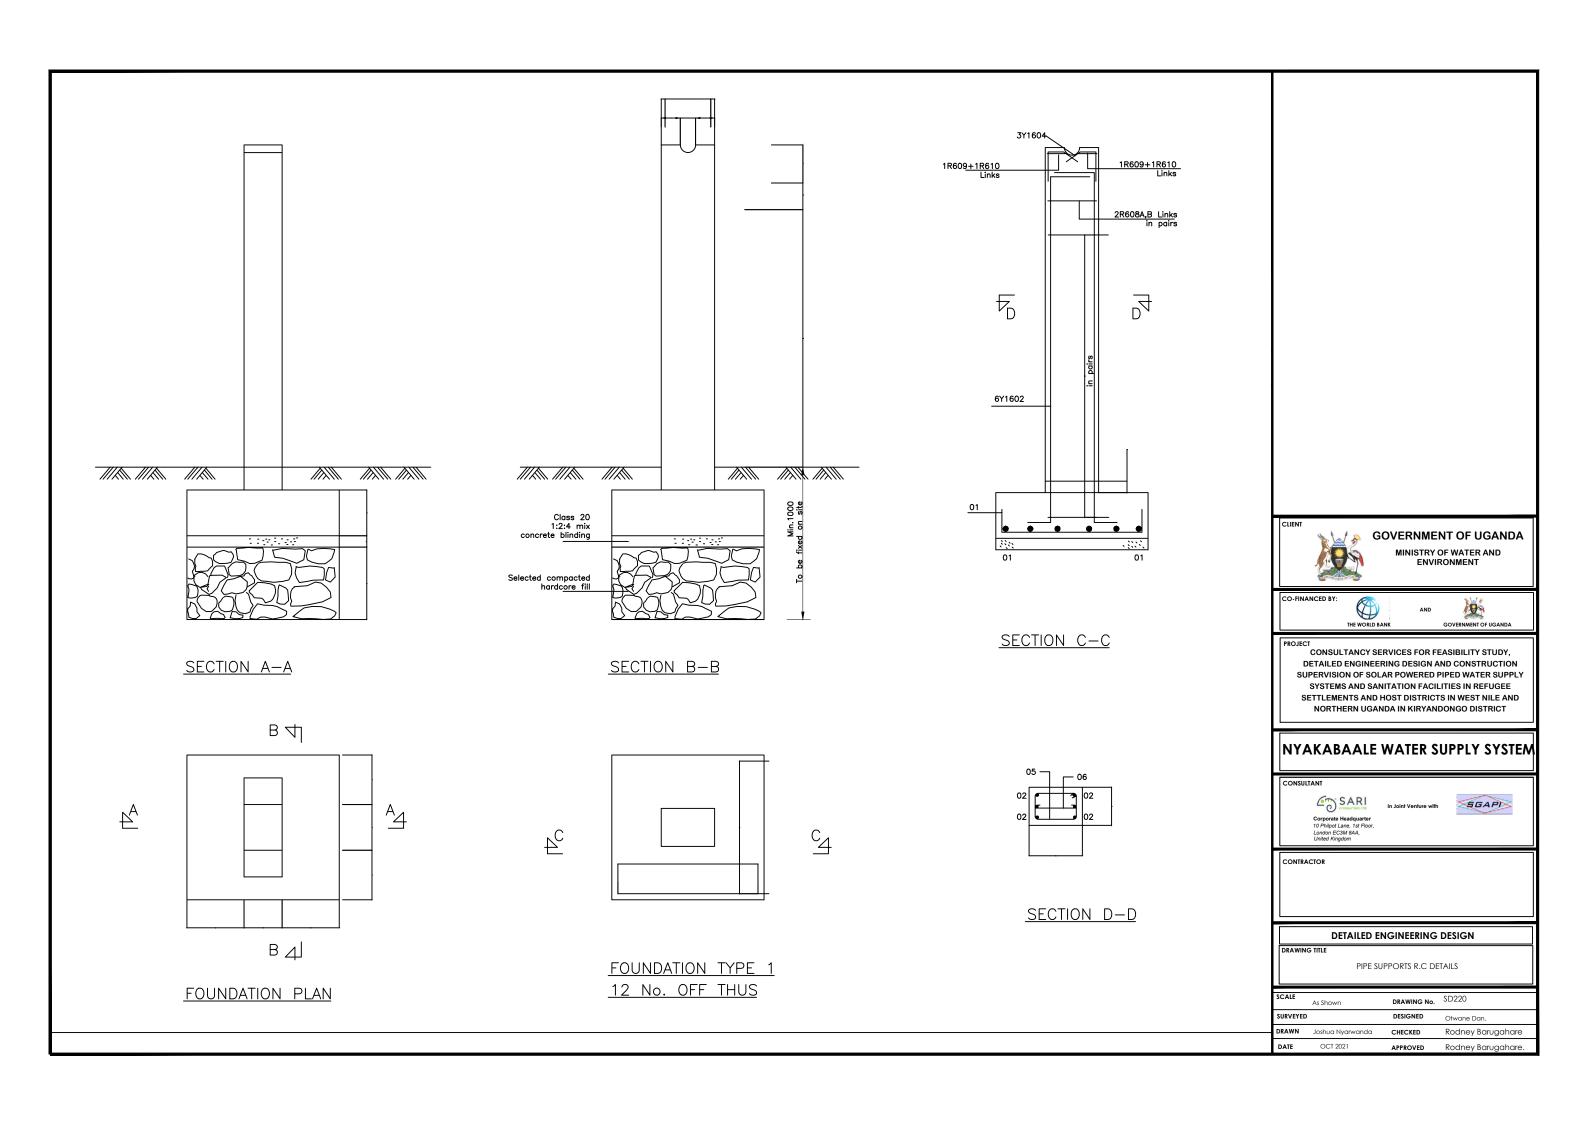


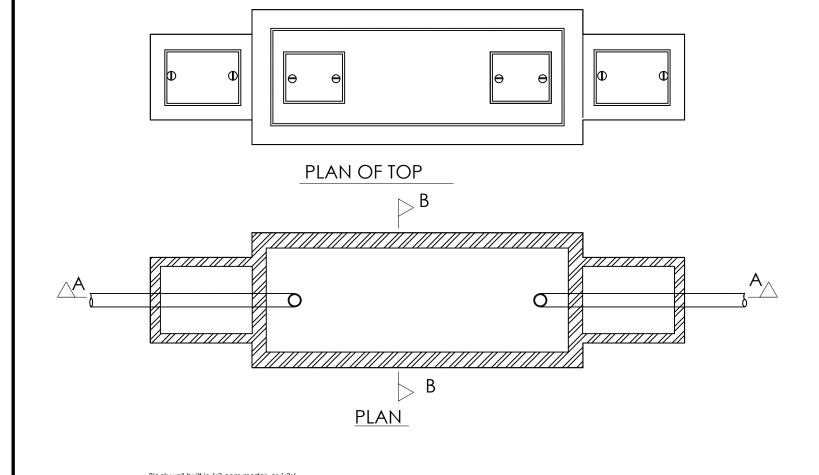

SIZES OF INSPECTION CHAMBER							
DEPTH TO INVERTS		INTERNAL DIMENSIONS	WALL THICKNESS	FOUNDATION THICKNESS			
UP TO	450	450x450	100	150			
475	900	450x600	100	150			
925	1500	750x1050	225	225			
OVER	1500	750x1050	225	225			

BRICKWORK TO BE BUILT IN CEMENT MORTAR 1:6 AND RENDERED INTERNALLY IN 1:3 CEMENT PLASTER 13mm THICK FOUNDATION TO BE 1:3:6 CONCRETE MIX OF CEMENT

	DIMENSIONS OF SEPTIC TANK							
No. of Users	L	В	D	Capacity Liters				
6	1800	625	900	1137				
10	2250	625	900	1435				
15	2475	625	900	1707				
20	2860	625	900	1820				
25	3300	625	900	2117				
30	2400	900	1050	2388				
35	2550	900	1050	2530				
40	3000	900	1050	2980				
45	3300	900	1050	3276				
50	3750	900	1050	3727				
60	3150	925	1200	4460				
70	3750	925	1200	5312				
80	4200	925	1200	5890				
90	4850	925	1200	6597				
100	4950	1125	1200	7462				
150	5250	1350	1500	10533				
200	6450	1350	1500	12697				
250	7050	1350	1650	16513				
300	7500	1350	1800	18155				

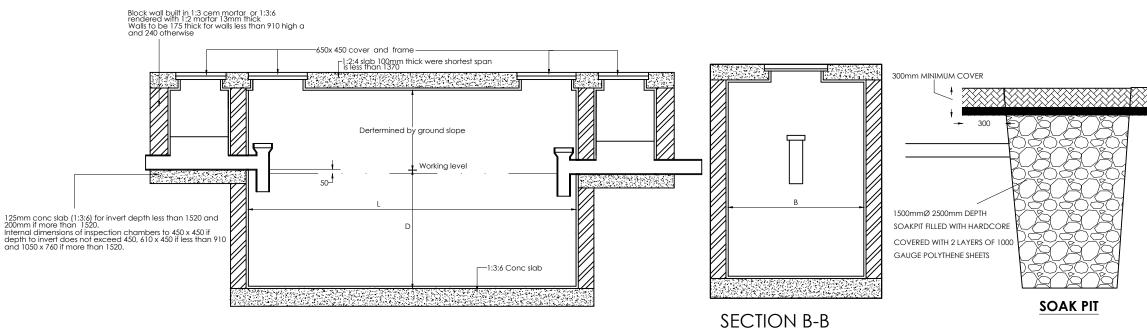



GOVERNMENT OF UGANDA

MINISTRY OF WATER AND ENVIRONMENT





CONSULTANCY SERVICES FOR FEASIBILITY STUDY, DETAILED ENGINEERING DESIGN AND CONSTRUCTION SUPERVISION OF SOLAR POWERED PIPED WATER SUPPLY SYSTEMS AND SANITATION FACILITIES IN REFUGEE SETTLEMENTS AND HOST DISTRICTS IN WEST NILE AND NORTHERN UGANDA IN KIRYANDONGO DISTRICT

NYAKABAALE WATER SUPPLY SYSTEM





CONTRACTOR

DETAILED ENGINEERING DESIGN

SEPTIC TANK DETAIL

SCALE	As Shown	DRAWING No.	SD221
SURVEYED)	DESIGNED	Otwane Dan.
DRAWN	Joshua Nyarwanda	CHECKED	Rodney Barugahare
DATE	OCT 2021	APPROVED	Rodney Barugahare.